



- SITE PLAN AND SITE ANALYSIS PLAN

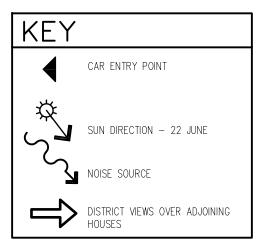

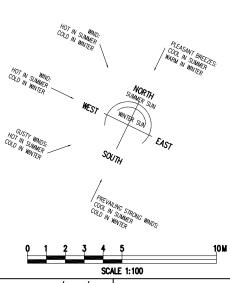

GENERAL NOTES:

- Builder to check and confirm all necessary dimensions on site prior to construction. Do not scale the drawing
- 2 All dimensions that relate to site boundaries and easments are subjuct to verification by site survey.
- A All timber construction to be in accordance with the "TIMBER FRAMING" code.
- 5 Any detailing in addition to what is supplied shall be resolved between the owner and the builder to the owner's approval, except for any structual details or design which is to be supplied by Structual Engineer.
- 6 Roof water & sub-soil drainage to be disposed of in the approved manner or as directed by local council inspectors.
 7 All electrical power & light outlets to be determined by owner.
 8 Make good and repair all existing finishes damaged by new work. Reuse existing material where possible.
- 3
 AMENDED ISSUED FOR CC
 17/05/21

 2
 ISSUED FOR CC
 22/02/21

 1
 ISSUED FOR DA
 09/09/20

 No.
 AMENDMENT
 DATE


DESIGN BY: MICHAL KORECKY

21 NALYA ROAD, NARRAWEENA NSW 2099 ABN: 79 393 130 294

Email: koreckym@gmail.com www.plansdesign.com.au Phone: 99813332, Mob: 0438 148 944

PROJECT:
PROPOSED GRANNY FLAT
No 16 GRANDVIEW DRIVE
NEWPORT, LOT 93 IN D.P.16029
CLIENT:
MR. & MRS. MILES

50/	NLE 1:100	
DATE: 17/05/21	SCALE:	AS NOTED
DRAWN: MK	ISSUE:	3
DRAWING Nr : 20064	SHEET:	1

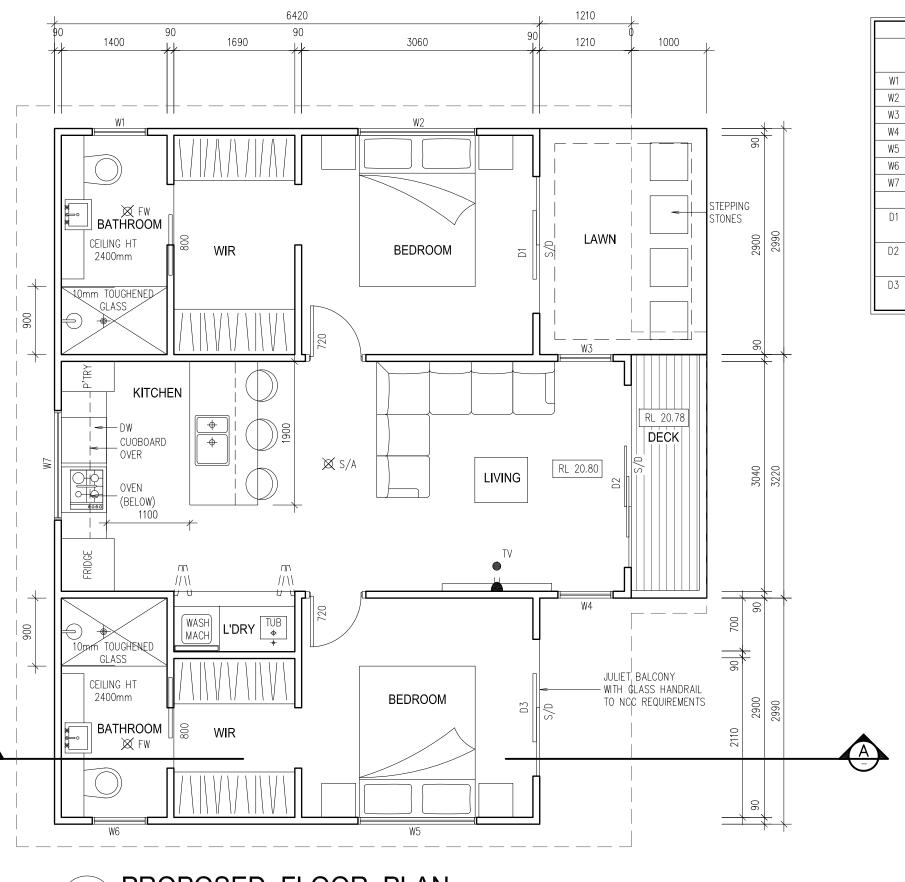

			WINDO	OWS AND DOO	OR SCHEDULE (FOR BASIX PURPOSES ONLY)	
	ORIENT.	-	ZE	AREA (m2)	SHADING DEVICE	FRAME AND GLASS TYPE
		W	Н	` ′		MIN. REQUIREMENTS
W1	S/W	730	900	0.66	external louvre/vertical blind (fixed)	aluminium, single clear
W2	S/W	1570	600	0.94	external louvre/vertical blind (fixed)	aluminium, single clear
W3	S/W	730	1500	1.10	external louvre/vertical blind (fixed)	aluminium, single clear
W4	N/E	730	1500	1.10	external louvre/vertical blind (fixed)	aluminium, single clear
W5	N/E	1570	600	0.94	external louvre/vertical blind (fixed)	aluminium, single clear
W6	N/E	730	900	0.66	external louvre/vertical blind (fixed)	aluminium, single clear
W7	S/E	1450	500	0.73	external louvre/vertical blind (fixed)	aluminium, single clear
D1	N/W	1810	2100	3.80	PERGOLA (FIXED BATTENS) 400mm, 200mm ABOVE HEAD OF WINDOW	U-value 5.6, SHGC: 0.369-0.451
D2	N/W	2410	2100	5.06	PERGOLA (FIXED BATTENS) 400mm, 200mm ABOVE HEAD OF WINDOW	U-value 5.6, SHGC: 0.369-0.451
D3	N/W	1810	2100	3.80	PERGOLA (FIXED BATTENS) 400mm, 200mm ABOVE HEAD OF WNDOW	U-value 5.6, SHGC: 0.369-0.451


EXTERNAL FINISHES

<u>CLADDING:</u>

THE CLADDING TO BE DARK EARTHY TONES

ROOF COLOUR:

WOODLAND GREY

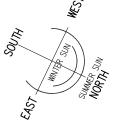



PROPOSED FLOOR PLAN

X S∕A - HARD WIRED SMOKE ALARM

GENERAL NOTES:

- Builder to check and confirm all necessary dimensions on site prior to construction. Do not scale the drawing.

 2 All dimensions that relate to site boundaries and easments are subjuct to verification by site survey.

 3 All work to be in accordance with BUILDING CODE of AUSTRAIA & to the satisfaction of local council requirements &

 4 All timber construction to be in accordance with the "TIMBER FRAMING" code.

 5 Any detailing in addition to what is supplied shall be resolved between the owner and the builder to the owner's appropriate that the supplied by Structual Engineer.
- 6 Roof water & sub-soil drainage to be disposed of in the opproved manner or as directed by local council ins 7 All electrical power & light outlets to be determined by owner. 8 Make good and repair all existing finishes damaged by new work. Reuse existing material where possible.
- 17/05/21 22/02/21 09/09/20 DATE AMENDED ISSUED FOR CC ISSUED FOR CC ISSUED FOR DA AMENDMENT No.

DESIGN BY:

MICHAL KORECKY


21 NALYA ROAD, NARRAWEENA NSW 2099 ABN: 79 393 130 294

Email: koreckym@gmail.com Phone: 99813332, Mob: 0438 148 944

PROJECT: PROPOSED GRANNY FLAT No 16 GRANDVIEW DRIVE NEWPORT, LOT 93 IN D.P.16029

MR. & MRS. MILES

5(JALE 1	:50		
	DATE:	17/05/21	SCALE:	AS NOTED
	DRAWN:	MK	ISSUE:	3
	DRAWING 2	Nr : 0064	SHEET:	2

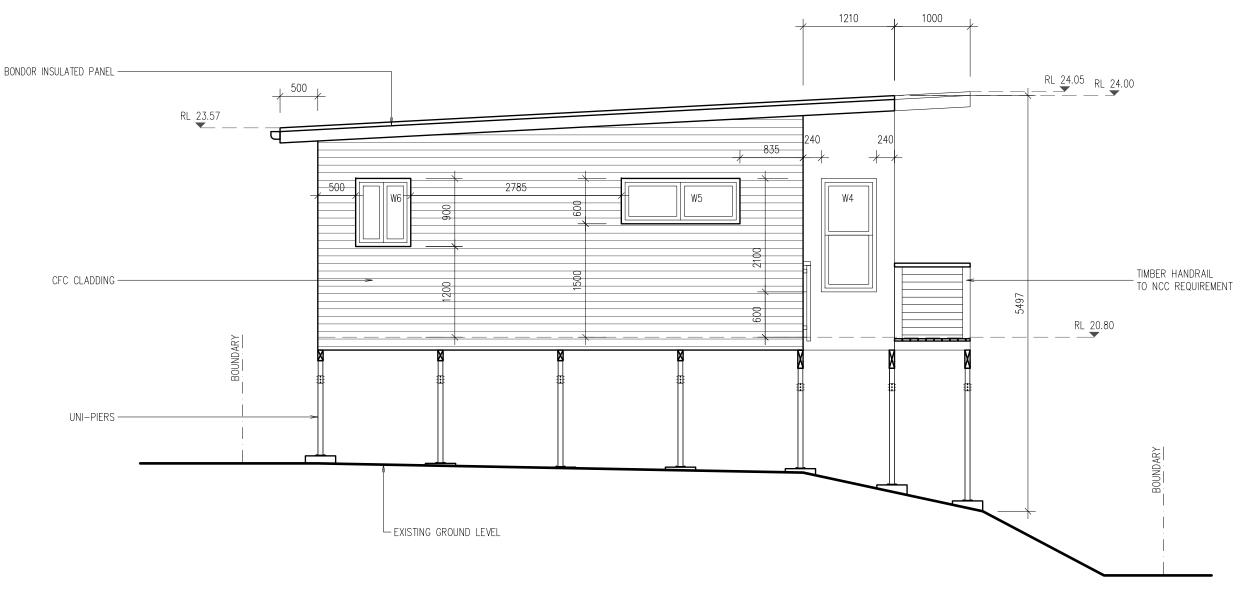

PROPOSED EAST ELEVATION FOR TIMBER FRAME

CLADDING:

THE CLADDING TO BE DARK EARTHY TONES

ROOF COLOUR:


WOODLAND GREY

<u>WINDOW DIMENSIONS:</u>

ALL DIMENSIONS OF WINDOW ARE FRAMING SIZES, NOT WINDOW SIZES

GENERAL NOTES:

- 1 Builder to check and confirm all necessary dimensions on site prior to construction. Do not scale the drawing, 2 All dimensions that relate to site boundaries and easments are subjuct to verification by site survey. 3 All work to be in accordance with BUILDING CODE of AUSTRAIA & to the satisfaction of local council requirements & 4 All timber construction to be in accordance with the "IMBEER FRAMING" code. 5 Any detailing in addition to what is supplied shall be resolved between the owner and the builder to the owner's approximately supplied which is to be supplied by Structual Engineer.
- 6 Roof water & sub-soil drainage to be disposed of in the approved manner or as directed by local council insp 7 All electrical power & light outlets to be determined by owner. 8 Make good and repair all existing finishes damaged by new work. Reuse existing material where possible.

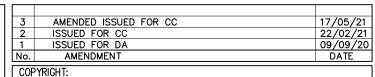

MICHAL KORECKY

21 NALYA ROAD, NARRAWEENA NSW 2099 ABN: 79 393 130 294

Email: koreckym@gmail.com www.plansdesign.com.au Phone: 99813332, Mob: 0438 148 944

		•
	SCALE 1:50	
PROJECT:	DATE: 17/05/21 SCALE: AS NOTE	D
PROPOSED GRANNY FLAT No 16 GRANDVIEW DRIVE	DRAWN: MK ISSUE: 3	
NEWPORT, LOT 93 IN D.P.16029	DRAWING Nr: SHEET: 3	
MR. & MRS. MILES	20004 3	



EXTERNAL FINISHES

CLADDING:

THE CLADDING TO BE DARK EARTHY TONES

ROOF COLOUR:

WOODLAND GREY

WINDOW DIMENSIONS:

ALL DIMENSIONS OF WINDOW ARE FRAMING SIZES, NOT WINDOW SIZES

GENERAL NOTES:

- 1 Builder to check and confirm all necessary dimensions on site prior to construction. Do not scale the drawing.
 2 All dimensions that relate to site boundaries and easments are subjuct to verification by site survey.
 3 All work to be in accordance with BUILDING CODE of AUSTRAIA & to the satisfaction of local council requirements & other authoriti
 4 All timber construction to be in accordance with the "IMBER FRAMING" code.
 5 Any detailing in addition to what is supplied shall be resolved between the owner and the builder to the owner's approval, except for any structual details or design which is to be supplied by Structual Engineer.
- 6 Roof water & sub-soil droinage to be disposed of in the approved manner or as directed by local council inspectors 7 All electrical power & light outlets to be determined by owner. 8 Make good and repair all existing finishes damaged by new work. Reuse existing material where possible.
- 17/05/21 22/02/21 09/09/20 DATE 3 AMENDED ISSUED FOR CC 2 ISSUED FOR CC 1 ISSUED FOR DA ISSUED FOR CC ISSUED FOR DA No. AMENDMENT


DESIGN BY: MICHAL KORECKY

21 NALYA ROAD, NARRAWEENA NSW 2099 ABN: 79 393 130 294

Email: koreckym@gmail.com Phone: 99813332, Mob: 0438 148 944

PROJECT: PROPOSED GRANNY FLAT No 16 GRANDVIEW DRIVE NEWPORT, LOT 93 IN D.P.16029 MR. & MRS. MILES

SCALE 1:50 DATE: 17/05/21 SCALE: AS NOTED DRAWN: MK ISSUE: SHEET: 20064

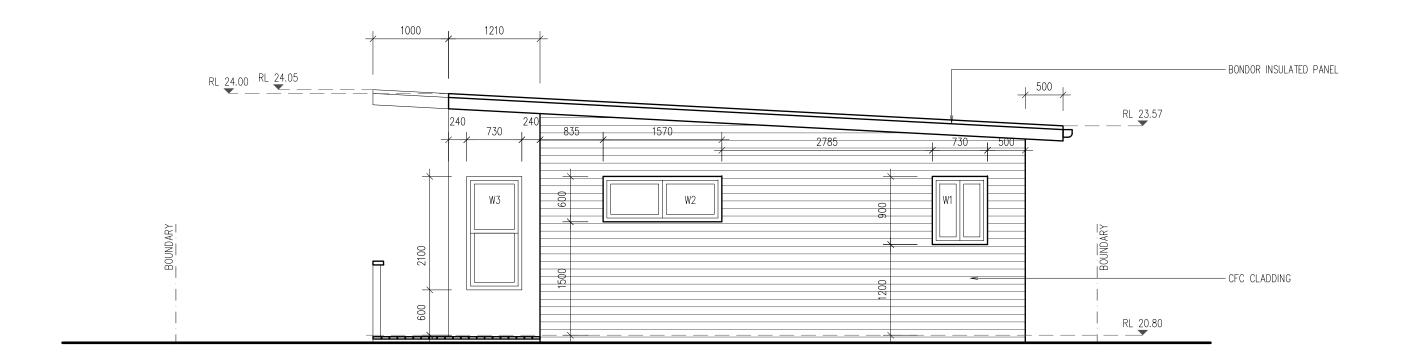

PROPOSED WEST ELEVATION FOR TIMBER FRAME

NOTE:

EXTERNAL FINISHES

CLADDING:

THE CLADDING TO BE DARK EARTHY TONES

ROOF COLOUR:


WOODLAND GREY

<u>WINDOW DIMENSIONS:</u>

ALL DIMENSIONS OF WINDOW ARE FRAMING SIZES, NOT WINDOW SIZES

GENERAL NOTES:

- 1 Builder to check and confirm all necessary dimensions on site prior to construction. Do not scale the drawing.
 2 All dimensions that relate to site boundaries and easments are subjuct to verification by site survey.
 3 All work to be in accordance with BUILDING CODE of AUSTRAIA & to the satisfaction of local council requirements & other authoriti
 4 All timber construction to be in accordance with the "IMBER FRAMING" code.
 5 Any detailing in addition to what is supplied shall be resolved between the owner and the builder to the owner's approval, except for any structual details or design which is to be supplied by Structual Engineer.
- 6 Roof water & sub-soil drainage to be disposed of in the approved manner or as directed by local council inspectors.
 7 All electrical power & light outlets to be determined by owner.
 8 Make good and repair all existing finishes damaged by new work. Reuse existing material where possible.

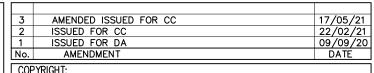


DESIGN BY: MICHAL KORECKY

21 NALYA ROAD, NARRAWEENA NSW 2099 ABN: 79 393 130 294

Email: koreckym@gmail.com www.plansdesign.com.au Phone: 99813332, Mob: 0438 148 944 MR. & MRS. MILES

PROPOSED GRANNY FLA	Ţ
PROJECT: PROPOSED GRANNY FLA No 16 GRANDVIEW DRIVE NEWPORT, LOT 93 IN D. CLIENT:	P.16029

SCALE 1:50 DATE: 17/05/21 SCALE: AS NOTED DRAWN: MK ISSUE: SHEET: 20064

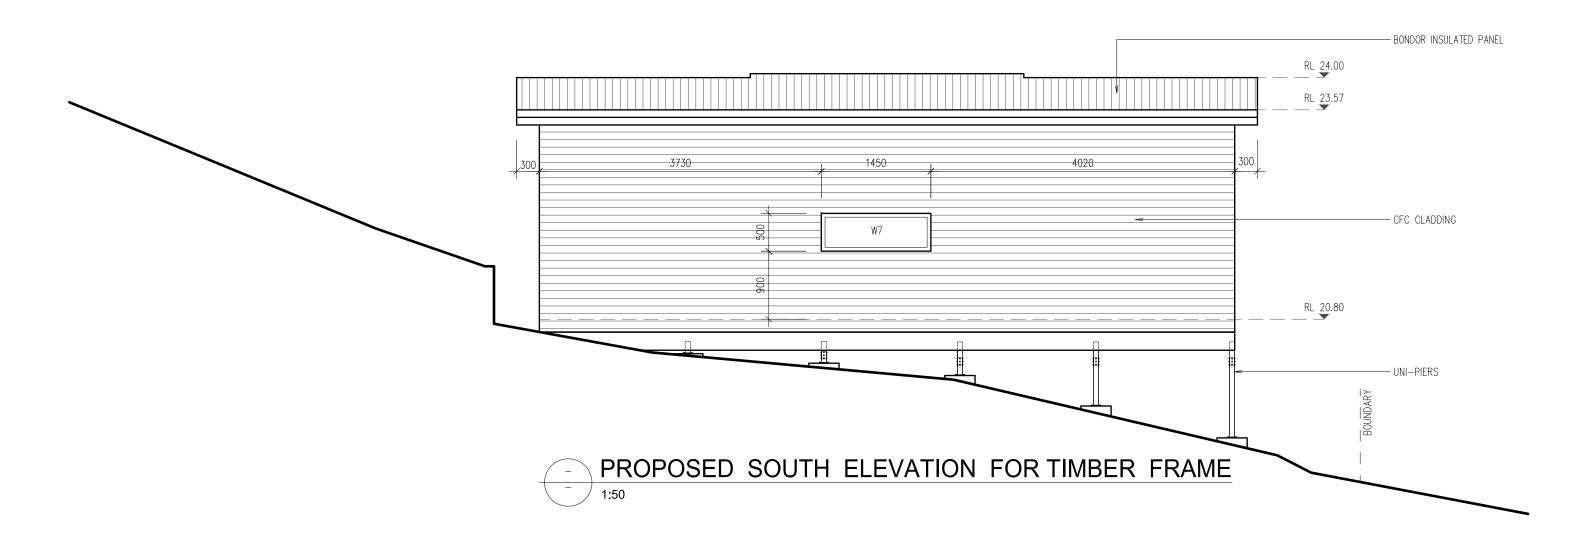

EXTERNAL FINISHES

CLADDING:

THE CLADDING TO BE DARK EARTHY TONES

ROOF COLOUR:

WOODLAND GREY

WINDOW DIMENSIONS:

ALL DIMENSIONS OF WINDOW ARE FRAMING SIZES, NOT WINDOW SIZES

GENERAL NOTES:

- 1 Builder to check and confirm all necessary dimensions on site prior to construction. Do not scale the drawing.
 2 All dimensions that relate to site boundaries and easments are subjuct to verification by site survey.
 3 All work to be in accordance with BUILDING CODE of AUSTRAIA & to the satisfaction of local council requirements &
 4 All timber construction to be in accordance with the "TIMBER FRAMING" code.
 5 Any detailing in addition to what is supplied shall be resolved between the owner and the builder to the owner's appropriate to the supplied by Structual Engineer. 6 Roof water & sub-soil drainage to be disposed of in the approved manner or as directed by local council insp 7 All electrical power & light outlets to be determined by owner. 8 Make good and repair all existing finishes damaged by new work. Reuse existing material where possible.
- 17/05/21 22/02/21 09/09/20 DATE 3 AMENDED ISSUED FOR CC 2 ISSUED FOR CC 1 ISSUED FOR DA AMENDMENT No.


DESIGN BY: MICHAL KORECKY 21 NALYA ROAD, NARRAWEENA NSW 2099

ABN: 79 393 130 294

Email: koreckym@gmail.com Phone: 99813332, Mob: 0438 148 944

PROJECT: PROPOSED GRANNY FLAT No 16 GRANDVIEW DRIVE NEWPORT, LOT 93 IN D.P.16029 MR. & MRS. MILES

SCALE 1:50 DATE: 17/05/21 SCALE: AS NOTED DRAWN: MK ISSUE: SHEET: 20064 0

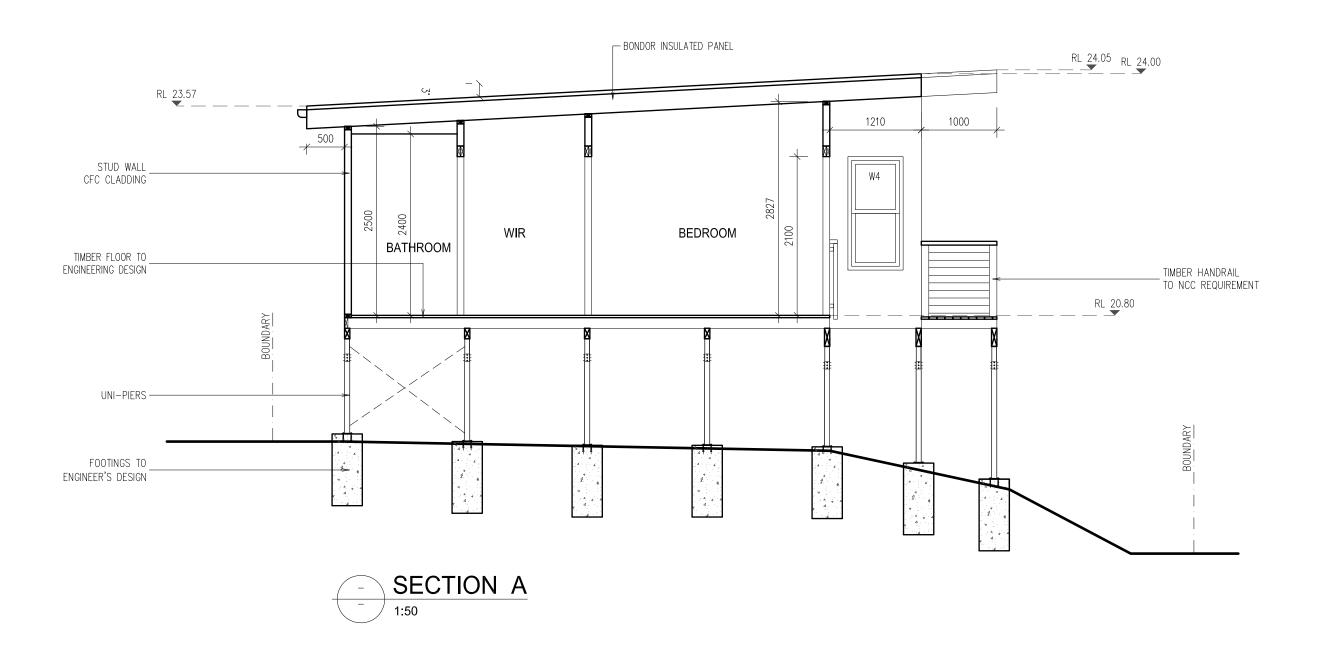

EXTERNAL FINISHES

CLADDING:

THE CLADDING TO BE DARK EARTHY TONES

ROOF COLOUR:


WOODLAND GREY

WINDOW DIMENSIONS:

ALL DIMENSIONS OF WINDOW ARE FRAMING SIZES, NOT WINDOW SIZES

GENERAL NOTES:

- 1 Builder to check and confirm all necessary dimensions on site prior to construction. Do not scale the drawing.
 2 All dimensions that relate to site boundaries and easments are subject to verification by site survey.
 3 All work to be in accordance with BUILDING CODE of AUSTRAILA & to the satisfaction of local council requirements & other authorities.
 4 All timber construction to be in accordance with the "IMBER FRAMING" code.
 5 Any detailing in addition to what is supplied shall be resolved between the owner and the builder to the owner's approval, except for any structual details or design which is to be supplied by Structual Engineer.
- 6 Roof water & sub-soil drainage to be disposed of in the approved manner or as directed by local council inspectors.
 7 All electrical power & light outlets to be determined by owner.
 8 Make good and repair all existing finishes damaged by new work. Reuse existing material where possible.

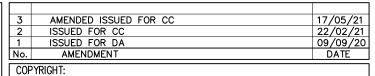

All plans and drawings are subject of copyright and any attempt or actual infringement by using, reproducting or copying same, wholly or in part, without prior written permission will result in legal proceedings.

DESIGN BY: MICHAL KORECKY

21 NALYA ROAD, NARRAWEENA NSW 2099 ABN: 79 393 130 294

Email: koreckym@gmail.com www.plansdesign.com.au Phone: 99813332, Mob: 0438 148 944 MR. & MRS. MILES

PROJECT:
DDODOCED CDANNY ELAT
PROPOSED GRANNY FLAT
No 16 GRANDVIEW DRIVE
NEWPORT, LOT 93 IN D.P.16029
NEWPORT, LOT 95 IN D.P.10029
CLIENT:

5	6	CALE 1	:50		
		DATE:	17/05/21	SCALE:	AS NOTED
		DRAWN:	MK	ISSUE:	3
		DRAWING 2	0064	SHEET:	7






Certificate Prepared by	
Name / Company Name: Michal Korecky	
ABN (if applicable): 79393130294	

BASIX Planning, Inhinity & Environment www.binit.mw.gov.mi Version 3.0 / DARWMMA_3_12_7 Certificate No. 11377015 Monday, 21 September 2020


Then	mal Comfort Commitments			now on A plans	Show on CC/CDC plans & specs	Certifier check
Gene	eral features			-		
The di	welling must not have more than 2 storeys.		~	~	~	
The co	onditioned floor area of the dwelling must not exceed		-	~	~	
The di	welling must not contain open mezzanine area excee		-	~	~	
The di	welling must not contain third level habitable attic root		-	~	~	
Floor	r, walls and ceiling/roof		- 100			
The ap		roof of the dwelling in accordance with the specifications listed in the	able	V	~	~
Const	truction	Additional insulation required (R-Value) O	ther specifi	cations		
floor -	suspended floor above open subfloor, framed	0.8 (or 1.5 including construction) (down)				
extern clad)	al wall - framed (weatherboard, fibre cement, metal	2.00 (or 2.40 including construction)				
ceiling	and roof - flat ceiling / flat roof, framed	ceiling: 4 (up), roof: foll/sarking fr	med; medi	um (solar	absorptance 0.475 0.70))
Note	Insulation specified in this Certificate must be inst	alled in accordance with Part 3.12.1.1 of the Building Code of Australi	ð			
Note	In some climate zones, insulation should be insta	fled with due consideration of condensation and associated interaction	with adjoin	ing builde	ng materials.	



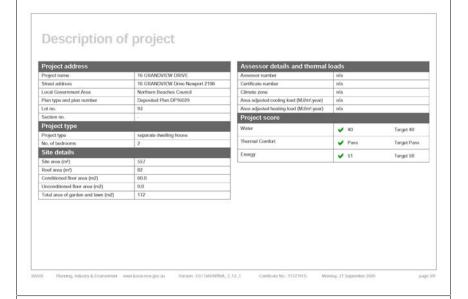

					DA plans	plans & specs	Certifier
lindows, glazed door	s and skyligh	ts					
he applicant must install the secifications listed in the tab	windows, glazed ble. Relevant over	doors and shading do shadowing specification	wices described in the table belo ons must be satisfied for each win	w, in accordance with the idow and glazed door.	~	~	~
The dwelling may have 1 skylight (<0.7 square metres) which is not listed in the table.						~	~
The following requirements must also be satisfied in relation to each window and glazed door:					~	~	~
For the following glass an	d frame types, the	e certifier check can be	e performed by visual inspection.				-
- Aluminium single clea	r						
- Aluminium double (air) clear						
- Timber/uPVC/fibreglar	ss single clear						
- Timber/uPVC/fibregle	ss double (air) cle	or					
 For other glass or farme types, each window and glazed door must be accompanied with certification showing a U value no greater than that Intel and a Soler I leaf Gain Coefficient (I SHCQ within the range of those listed. Total system U values and SHCQ reacts be calculated in accordance with National Fenestration Rating Council (NFRC) conditions. Frame and glass types shown in the table below are for reference only. 							~
			rust have a shading coefficient of			~	~
closed.				are situated when fully drawn or		~	~
 Unless they have adjusta situated, unless the per- the battens. 	ble shading, perg gola also shades	olas must have fixed b a perpendicular windo	atters parallel to the window or g w. The spacing between battens	plazed door above which they are must not exceed the height of		~	~
Overshadowing buildings door, as specified in the			stance from the centre and the b	ase of the window and glazed	~	~	~
indowiglazed door no.	Maximum height (mm)	Maximum width (mm)	Туре	Shading Device (Dimensi 10%)	ion within	Overshadowing	
orth-East facing							
4	1500	730	aluminium, single, clear	external louvre/vertical blir	d (fixed)	not overshadowed	

Energy Commitments	Show on DA plans	Show on CC/CDC plans & specs	Certifier
at least 1 of the living / dining rooms; dedicated		~	_
the kitcher; dedicated		~	-
all bathrooms/toilets; dedicated			
the laundry; dedicated			
all hallways; dedicated		_	
Natural lighting	100		
The applicant must install a window and/or skylight in 2 bathroom(s)/hollet(s) in the development for natural lighting.	~	~	~
Alternative energy			
The applicant must install a photovoltaic system with the capacity to generate at least 1.1 peak killowards of electricity as port of the development. The applicant must connect this system to the development's electrical system.	~	~	~
Other			
The applicant must construct each refrigerator space in the development so that it is "well vertilated", as defined in the BASIX definitions.		~	
The applicant must install a fixed outdoor clothes drying line as part of the dovelopment.		~	
Reerang, Industry & Environment - www.bankurnw.gov.au - Varigon 3.0/DARWMA_3.12_T - Combitate No. 11377015		ptomber 2000	

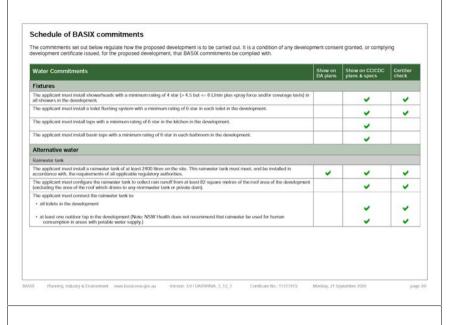

Windowlglazed door no.	Maximum height (mm)	Maximum width (mm)	Туре	Shading Device (Dimension within 10%)	Overshadowing
W5	600	1570	aluminium, single, clear	external louwre/vertical blind (fixed)	not overshadowed
W6	900	730	aluminium, single, clear	external louwe/vertical blind (fixed)	not overshadowed
South-East facing					
W7	500	1450	aluminium, single, clear	external louwe/vertical blind (fixed)	not overshadowed
South-West facing					
W1	900	730	aluminium, single, clear	external louwre/vertical blind (fixed)	>4 m high, 8-12 m away
W2	600	1570	aluminium, single, clear	external louwe/vertical blind (fixed)	>4 m high, 8-12 m away
W3	1500	730	aluminium, single, clear	external louwe/vertical blind (fixed)	>4 m high, 8-12 m away
North-West facing					
D1	2100	1810	U-value: 5.6, SHGC: 0.369 - 0.451 (aluminium, single, Lo-Tsol Low-e)	pergola (fixed battens) 400 mm, 200 mm above head of window or glazed door	not overshadowed
D2	2100	2410	U-value: 5.6, SHGC: 0.369 - 0.451 (aluminium, single, Lo-Tsol Low-e)	pergola (fixed battens) 400 mm, 200 mm above head of window or glazed door	not overshadowed
D3	2100	1810	U-value: 5.6, SHGC: 0.369 - 0.451 (aluminium, single, Lo-Tsol Low-e)	pergola (fixed battens) 400 mm, 200 mm above head of window or glazed door	not overshadowed



BASIX REQUIREMENTS

6 Roof water & sub-soil drainage to be disposed of in the approved manner or as directed by local council inspectors.
7 All electrical power & light outlets to be determined by owner.
8 Make good and repair all existing finishes damaged by new work. Reuse existing material where possible.

3	AMENDED ISSUED FOR CC	17/05/21
2	ISSUED FOR CC	22/02/21
1	ISSUED FOR DA	09/09/20
No.	AMENDMENT	DATE

DESIGN BY: MICHAL KORECKY

21 NALYA ROAD, NARRAWEENA NSW 2099 ABN: 79 393 130 294

Email: koreckym@gmail.com www.plansdesign.com.au Phone: 99813332, Mob: 0438 148 944


PROJECT: PROPOSED GRANNY FLAT No 16 GRANDVIEW DRIVE NEWPORT, LOT 93 IN D.P.16029 MR. & MRS. MILES

DATE: 17/05/21	SCALE: AS NOTED
DRAWN: MK	ISSUE: 3
DRAWING Nr : 20064	SHEET: 8


GENERAL NOTES:

1 Builder to check and confirm all necessary dimensions on site prior to construction. Do not scale the drawing.
2 All dimensions that relate to site boundaries and easments are subjuct to verification by site survey.
3 All work to be in accordance with BUILDING CODE of AUSTRALIA & to the satisfaction of local council requirements & other authorities.
4 All timber construction to be in accordance with the "TIMBER FRAMING" code.
5 Any detailing in addition to what is supplied shall be resolved between the owner and the builder to the owner's approval, except for any structual details or design which is to be supplied by Structual Engineer.

COPYRIGHT: All plans and drawings are subject of copyright and any attempt or actual infringement by using, reproducting or copying same, wholly or in part, without prior written permission will result in legal proceedings.

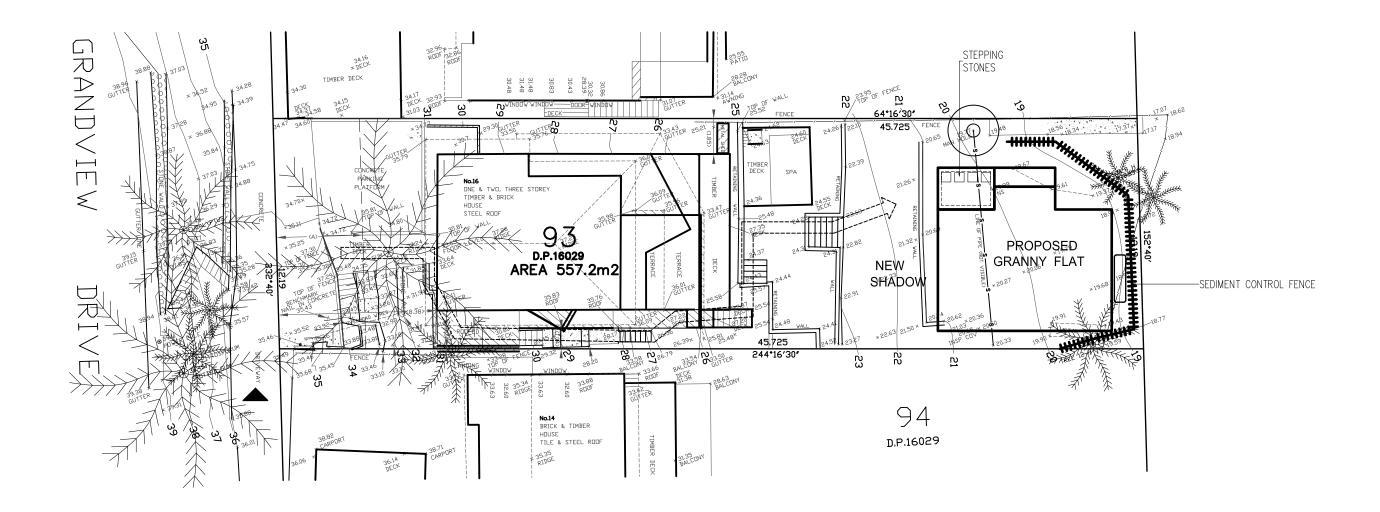

EROSION AND SEDIMENT MANAGEMENT PLAN 1:200

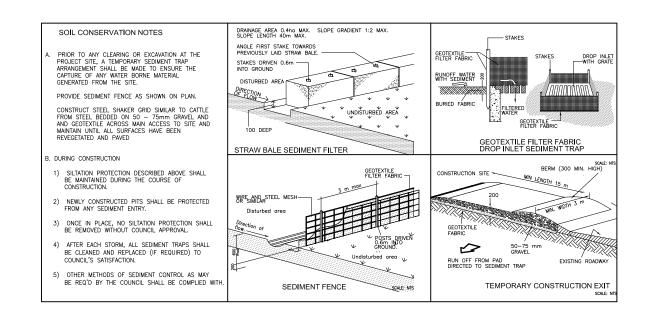

A3 SHEET SIZE



GENERAL NOTES:

- Builder to check and confirm all necessary dimensions on site prior to construction. Do not scale the drawing
- 2 All dimensions that relate to site boundaries and easments are subjuct to verification by site survey.

 All work to be in accordance with BUILDING CODE of AUSTRALIA & to the satisfaction of local council requirements & other authorities.

 All timber construction to be in accordance with the "Miller FRAMING" code.
- Any detailing in addition to what is supplied shall be resolved between the owner and the builder to the owner's approval, except for any structual details or design which is to be supplied by Structual Engineer.
- 6 Roof water & sub-soil drainage to be disposed of in the approved manner or as directed by local council inspectors.
 7 All electrical power & light outlets to be determined by owner.
 8 Make good and report all existing finishes damaged by new work. Reuse existing material where possible.
- AMENDED ISSUED FOR CC 17/05/21 ISSUED FOR CC 22/02/21 09/09/20 DATE ISSUED FOR DA No. AMENDMENT COPYRIGHT:

All plans and drawings are subject of copyright and any attempt or actual infringement by using, reproducting or copying same, wholly or in part, without prior written permission will result in legal proceedings.

MICHAL KORECKY


21 NALYA ROAD, NARRAWEENA NSW 2099 ABN: 79 393 130 294


DESIGN BY:

Email: koreckym@gmail.com www.plansdesign.com.au Phone: 99813332, Mob: 0438 148 944

PROJECT: PROPOSED GRANNY FLAT No 16 GRANDVIEW DRIVE NEWPORT, LOT 93 IN D.P.16029 MR. & MRS. MILES

DATE: 17/05/21	SCALE: AS NOTED
DRAWN: MK	ISSUE: 3
DRAWING Nr : 20064	SHEET: 9

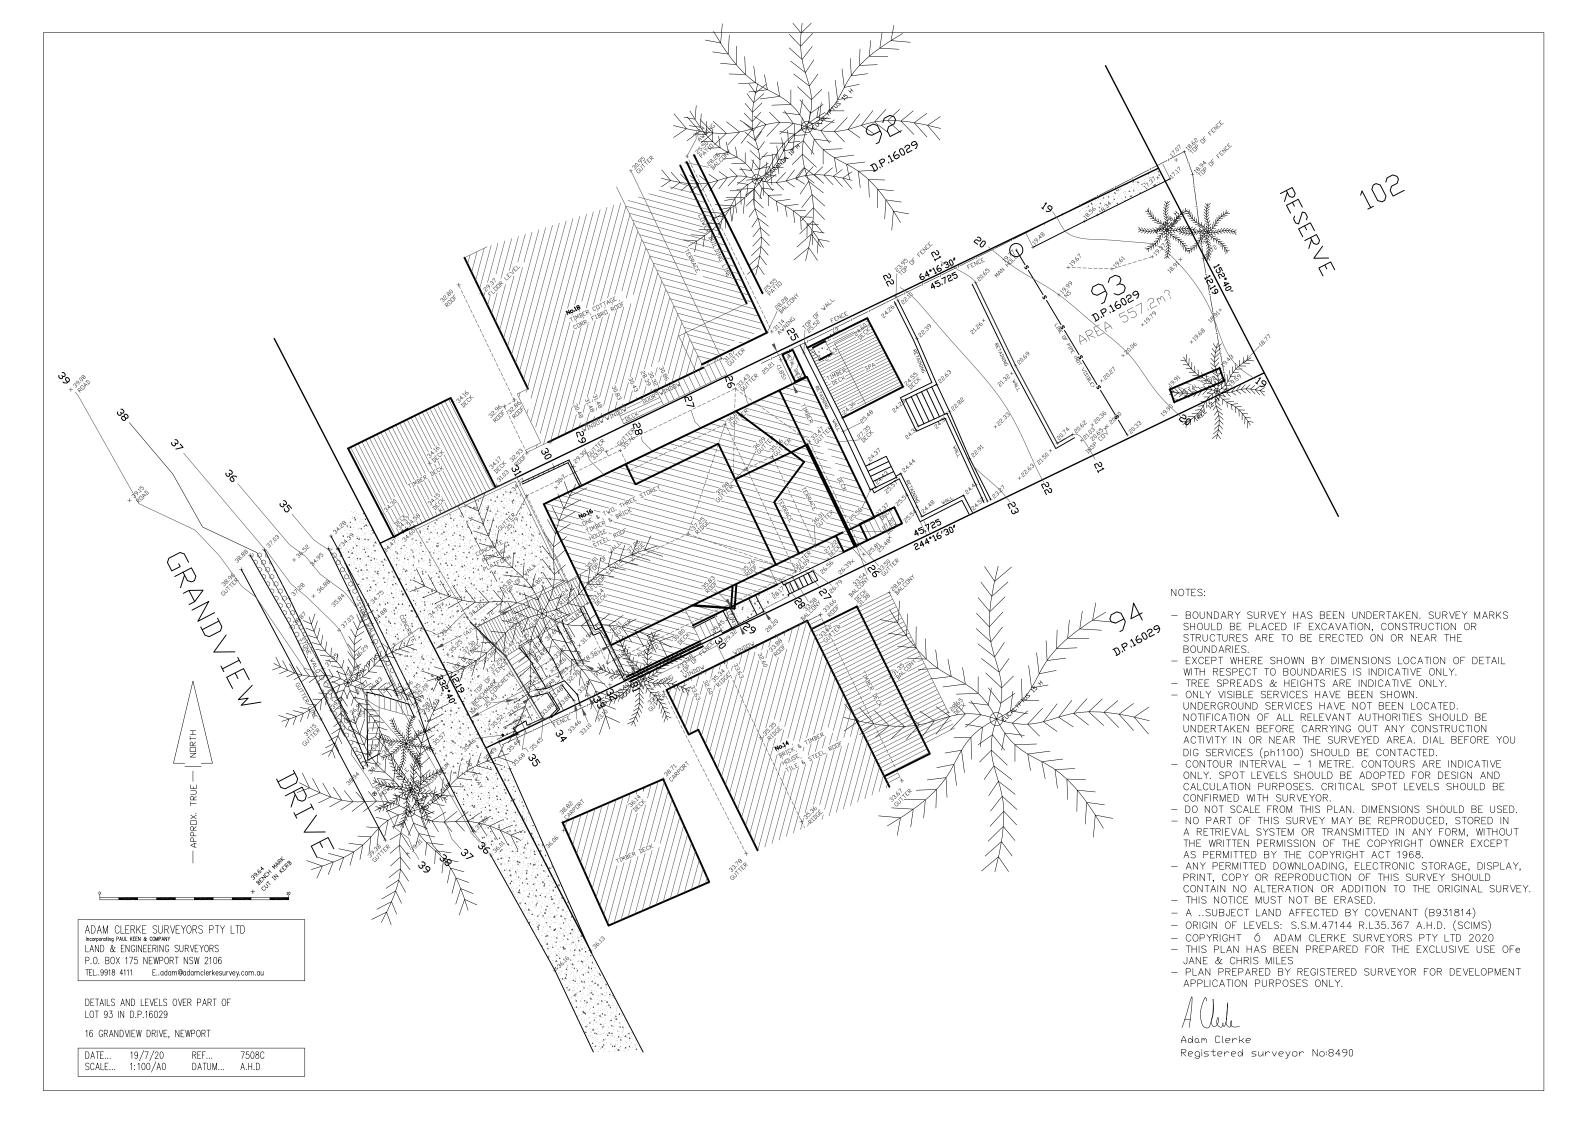

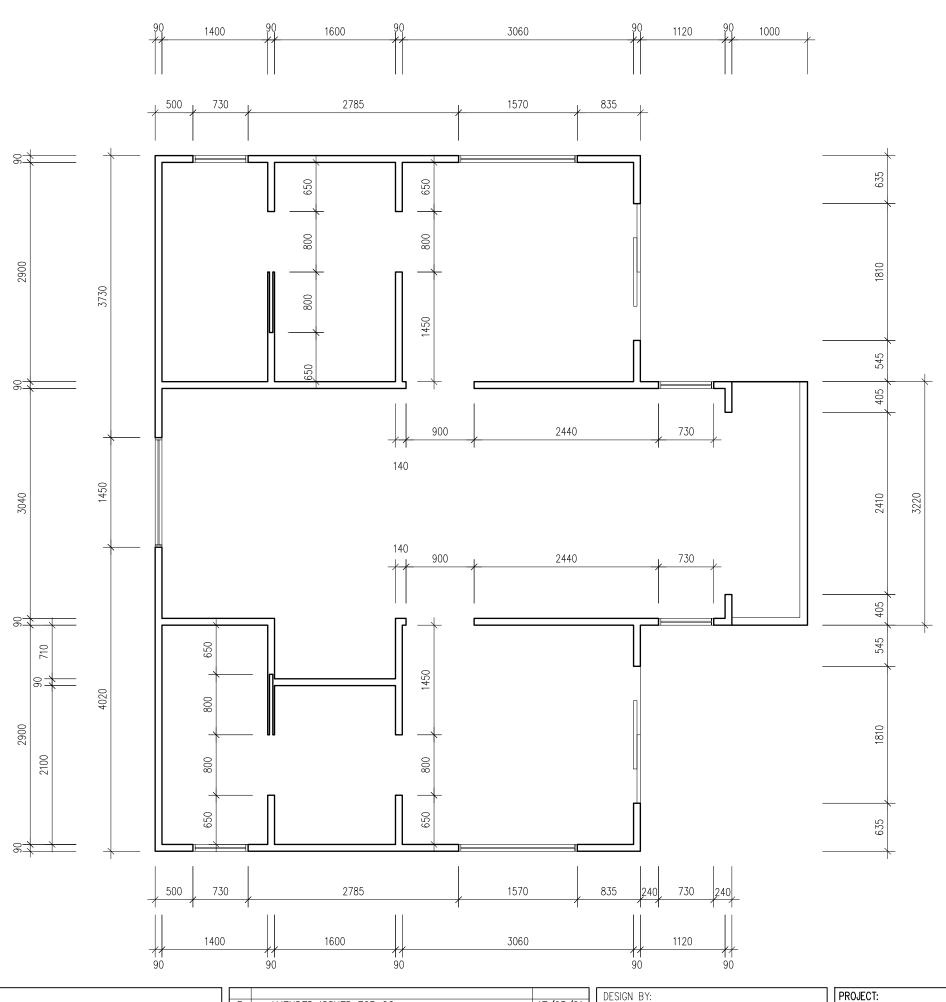

GENERAL NOTES:

- 1 Builder to check and confirm all necessary dimensions on site prior to construction. Do not scale the drawing.

 2 All dimensions that relate to site boundaries and easments are subjuct to verification by site survey.

 3 All work to be in accordance with BUILDING CODE of AUSTRALIA & to the satisfaction of local council requirements & other authorities.

 4 All timber construction to be in accordance with the "TIMBER FRAMING" code.

 5 Any detailing in addition to what is supplied shall be resolved between the owner and the builder to the owner's approval, except for any structual details or design which is to be supplied by Structual Engineer.

 6 Roof water & sub-soil drainage to be disposed of in the approved manner or as directed by local council inspectors.

 7 All electrical power & light outlets to be determined by owner.

 8 Make good and repair all existing finishes damaged by new work. Reuse existing material where possible.

- 17/05/21 22/02/21 09/09/20 DATE 3 AMENDED ISSUED FOR CC
 2 ISSUED FOR CC
 1 ISSUED FOR DA No. AMENDMENT

COPYRIGHT:

All plans and drawings are subject of copyright and any attempt or actual infringement by using, reproducting or copying same, wholly or in part, without prior written permission will result in legal proceedings.

MICHAL KORECKY

21 NALYA ROAD, NARRAWEENA NSW 2099 ABN: 79 393 130 294

Email: koreckym@gmail.com www.plansdesign.com.au Phone: 99813332, Mob: 0438 148 944

PROJECT: PROPOSED GRANNY FLAT No 16 GRANDVIEW DRIVE NEWPORT, LOT 93 IN D.P.16029 CLIENT: MR. & MRS. MILES

DATE: 17/05/21	SCALE:	AS NOTED
DRAWN: MK	ISSUE:	3
DRAWING Nr : 20064	SHEET:	10