

TRUE NORTH:

LOT

SITE AREA

GARAGE

DP

2

PRINCIPAL DWELLING

SECONDARY DWELLING

30329

AREA CALCULATIONS


- specifications.


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	Α	15.05.20	WINDOW & SKYLIGHT CHANGE
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01	С	17.06.20	ADJUST MAX. BUILDING HEIGHT
	D	23.06.20	TREE REMOVED
- 1			

PROJECT DETAILS: PROPOSED SECONDARY DWELLING 2 GEORGINA AVE, ELANORA HEIGHTS 2101	DATE: APRIL/20	DRAWN BY: AHB	SCALE: 1:200 @ A3
DRAWING TITLE: SITE ANALYSIS PLAN	JOB No: 794/20	CHECKED BY:	DRAWING No: DA.01





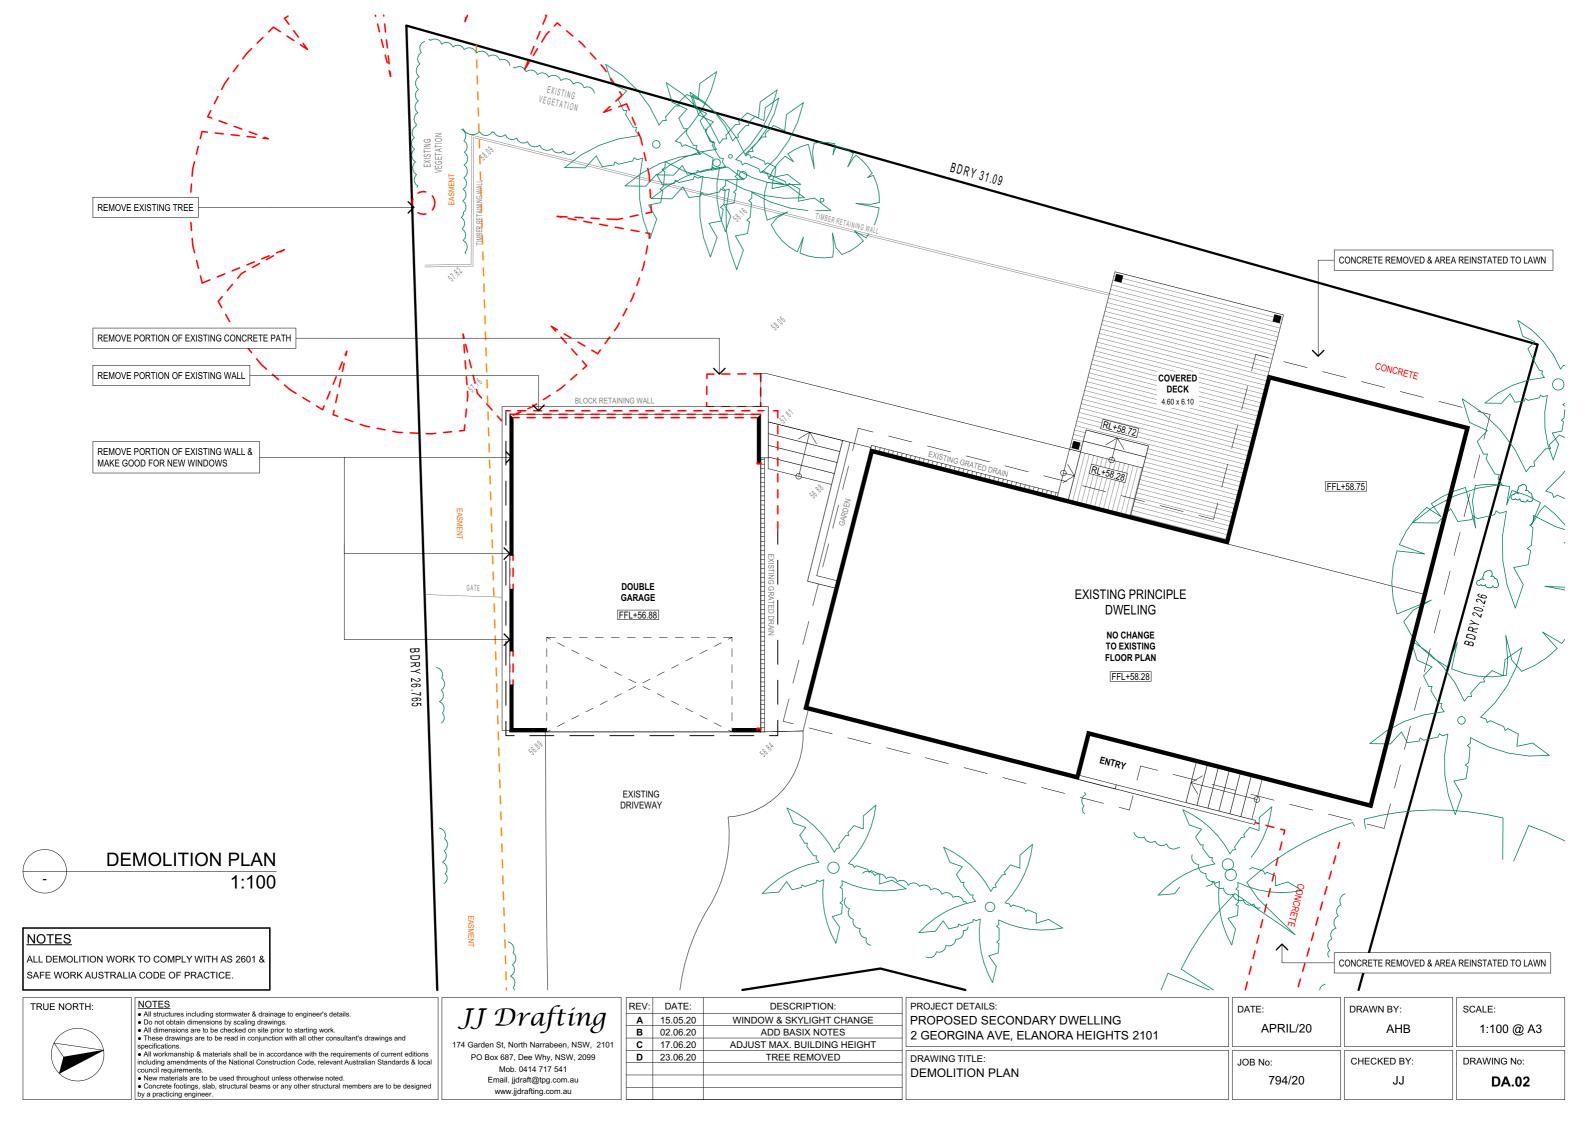
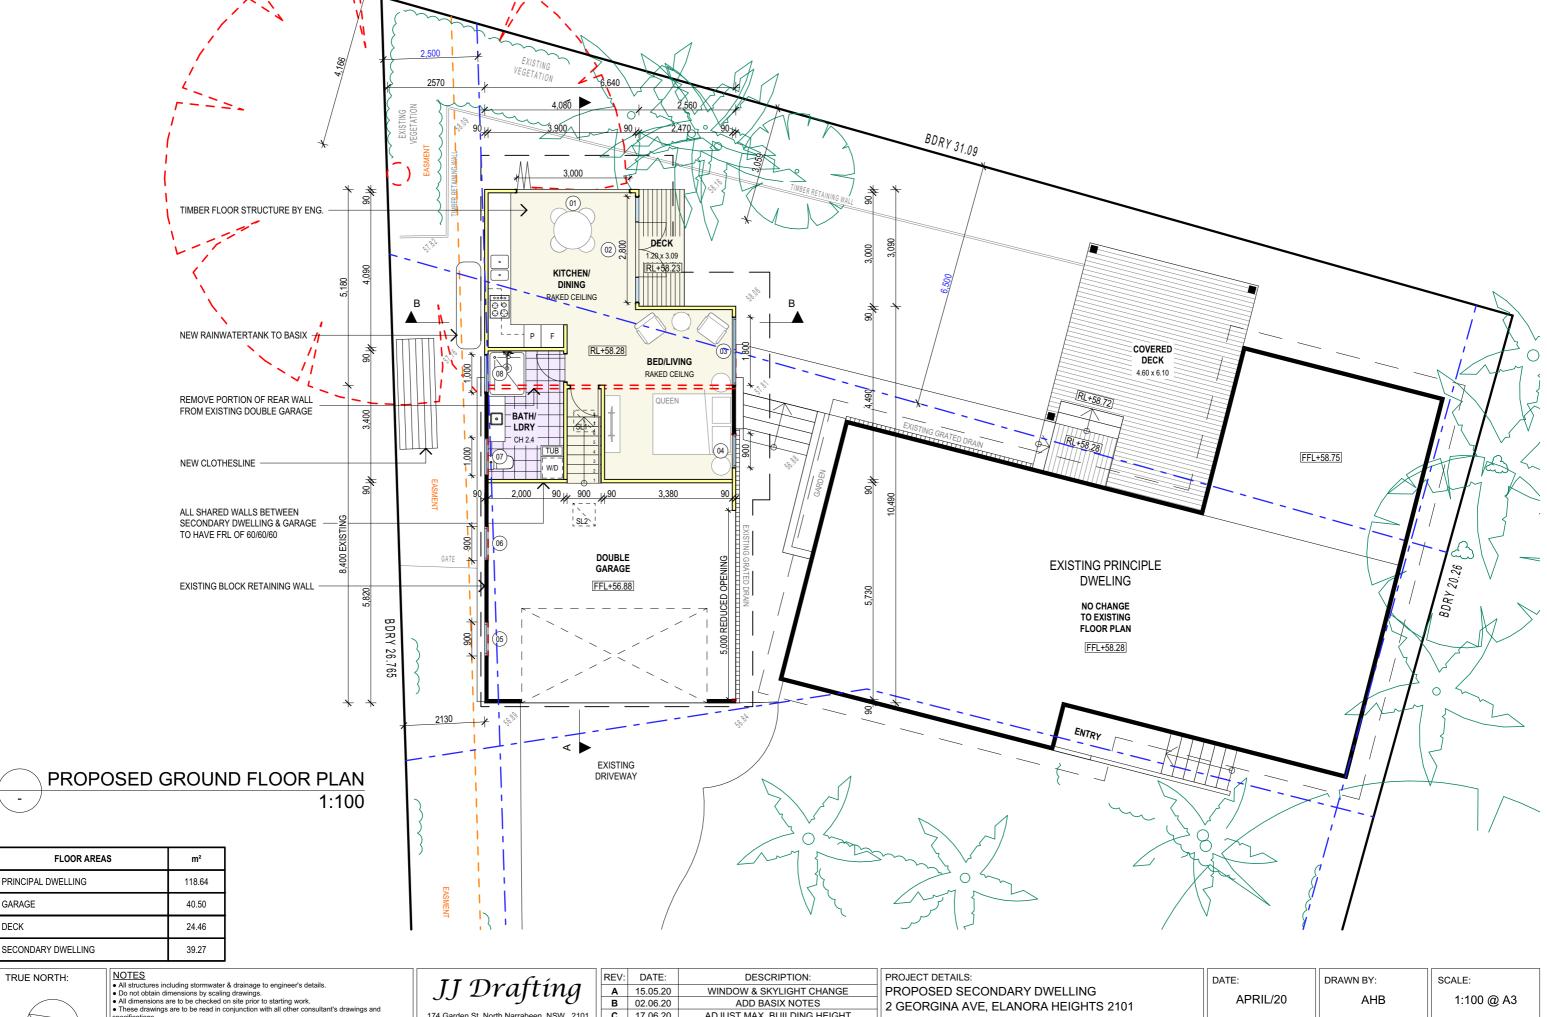
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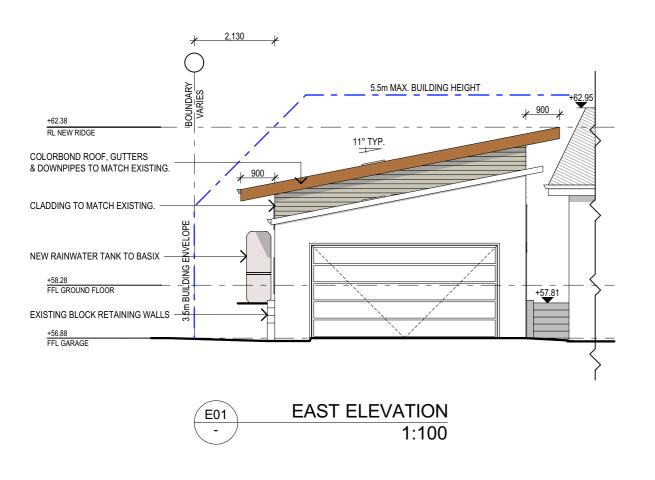
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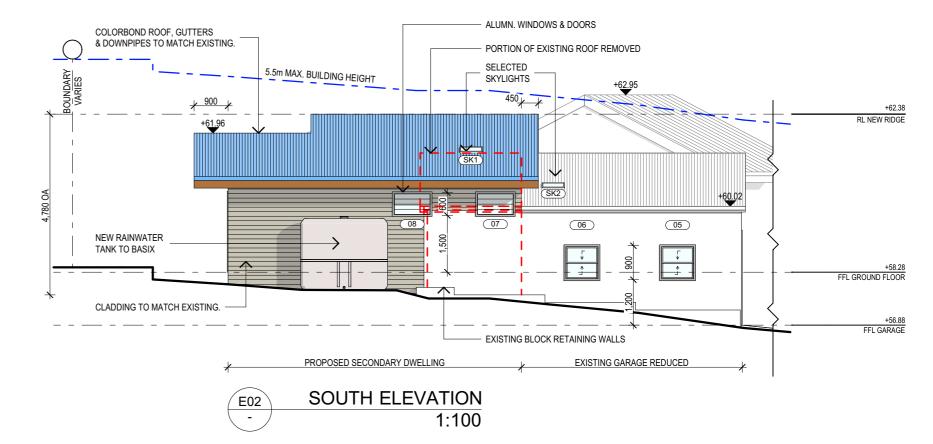
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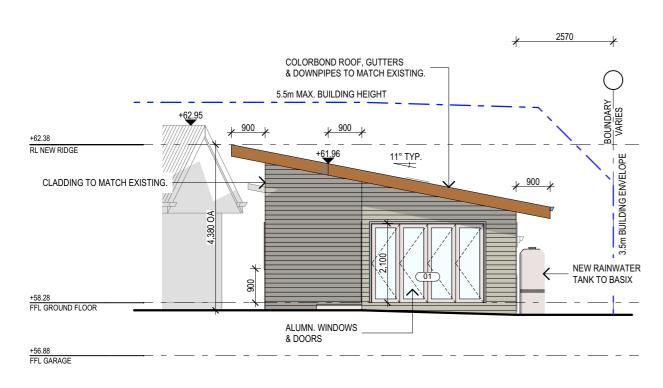
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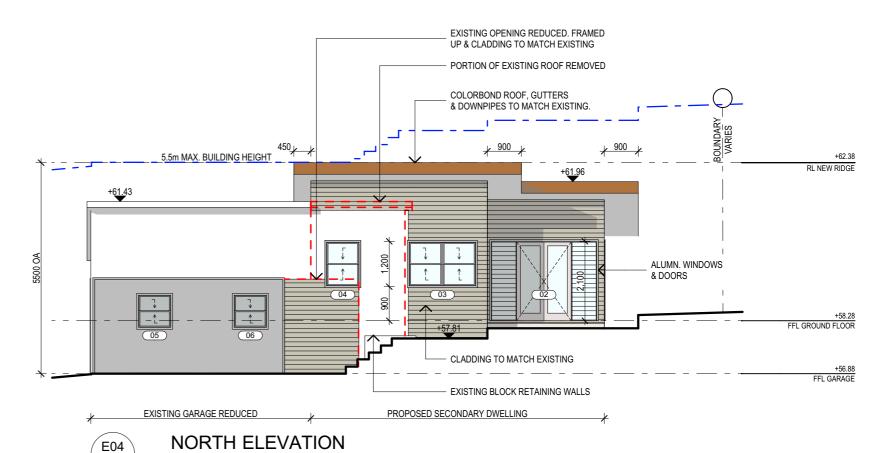
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╛	PROJECT DETAILS: PROPOSED SECONDARY DWELLING 2 GEORGINA AVE, ELANORA HEIGHTS 2101	DATE: APRIL/20	DRAWN BY:	SCALE: 1:100 @ A3
	DRAWING TITLE: FLOOR PLAN	JOB No: 794/20	CHECKED BY:	DRAWING No: DA.03









1:100

**WEST ELEVATION** E03 1:100

NOTES

All structures including stormwater & drainage to engineer's details.

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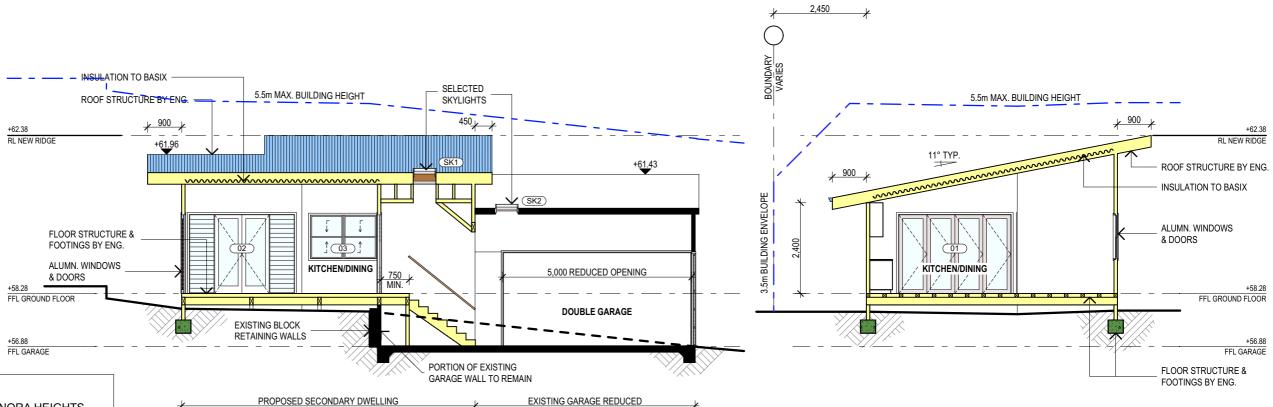
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# **BASIX REQUIREMENT:**

BASIX INCLUSIONS FOR 2 GEORGINA AVE, ELANORA HEIGHTS

# **External Walls**

Plasterboard on studs no insulation to the remainder walls

# Glazing Doors/Windows

Single glazing to remainder windows

Group A - awning + bifold + casement windows + hinged glazed doors U-value: 6.70 (equal to or lower than) SHGC: 0.57 (±10%)

Group B - sliding doors/windows + fixed glazing + louvred windows U-value: 6.70 (equal to or lower than) SHGC: 0.70 (±10%)

Given values are AFRC total window system values (glass and frame

Metal roof with foil backed blanket (R<sub>u</sub>1.3 and R<sub>d</sub>1.3)

External Colour

Medium ( SA > 0.7)

Plasterboard ceiling with R3.0 insulation (insulation only value) where roof above Ceiling Penetrations

Assumed sealed LED downlights, one every 2.5m<sup>2</sup>

## Floor coverings

Tiles to wet areas and timber to remainder of the house

BASIX Water 60m2 Native Planting 2KL Rain Water Tank

# **BASIX Energy**

Outdoor and Indoor clothes line

Slab on ground no insulation required Suspended timber floor no insulation required

Lightweight cladding with R2.5 insulation + sarking (Total system R value 3.34)

Medium (SA >0.475 <0.7) Walls within dwellings

Plasterboard on study R2.5 insulation between garage and habitable rooms Plasterboard on studs R2.5 insulation between WC and habitable rooms

Double Performance glazing to windows adjacent to kitchen and dining Group A - awning + bifold + casement windows + hinged glazed doors U-value: 3.10 (equal to or lower than) SHGC: 0.27 (±10%)

Ventilated roof

Loss of ceiling insulation has been accounted for in accordance with BASIX Thermal Protocol 4.13.1 and NatHERS Technical Note 1.2

Well ventilated fridge space

# **SECTION A-A** 1:100

**SPECIFICATION NOTES** 

INTERNAL LINING
- PLASTERBOARD LINING THROUGHOUT.

FLOOR:
- TIMBER FRAMED FINISHED WITH T&G HARDWOOD FLOORING.

BEARERS AND JOISTS:
- SHALL BE INSTALLED TO COMPLY WITH AS1684 AS AMENDED.

- DESIGN AND INSTALLATION SHALL BE IN ACCORDANCE WITH AS 1562.

- SHALL BE IN ACCORDANCE WITH NCC VOL.1 PART B1.4 OR VOL.2 PART 3.2.3.

- FOOTINGS TO BE IN ACCORDANCE WITH NCC VOL.2 PARTS 3.2.3, 3.2.4 AND 3.2.5

- ALL WORKMANSHIP AND MATERIALS SHALL BE IN ACCORDANCE WITH CURRENT EDITIONS OF THE

ANT CAPS:
- SHALL BE INSTALLED IN ACCORDANCE WITH AS3660.

FOOTINGS:
- FOOTINGS TO BE IN ACCORDANCE WITH AS2870.

- PROVIDE A GUARANTEED FLEXIBLE WATERPROOF MEMBRANE TO ALL WET AREA FLOORS & SHOWERS WALLS TO MANUFACTURES INSTRUCTIONS

<u>EXTERNAL WALLS:</u>
- LIGHTWEIGHT TIMBER CLADDING.

PROFILED STEEL ROOF:

- COLORBOND ROOF CLADDING.

NCC VOL.2 PART 3.5.1

ROOFING:

TIMBER TO COMPLY WITH AS1170.2 OR AS4055.

- ALL WORKMANSHIP AND MATERIALS SHALL BE IN ACCORDANCE WITH AS1684 AND 1720 AS APPLICABLE.

- TO COMPLY WITH NCC VOL.2 PART 3.4

GROUND FLOOR TIMBERS SHALL BE ONLY OF HARDWOOD, CYPRESS PINE OR PRESSURE TREATED RADIATA OR CANADA PINE BELOW A HEIGHT OF 300mm ABOVE FINISHED GROUND LEVEL AND MUST NOT RE BLIILT INTO BRICKWORK

- SUBFLOOR VENTILATION SHALL CONFORM TO NCC VOL.2 PART 3.4.1.
- IN BUSHFIRE PRONE AREAS SPECIAL CONDITIONS APPLY.
- WHERE TERMITE BARRIERS NEED TO BE INSPECTED, 400mm CLEARANCE IS REQUIRED BETWEEN THE UNDERSIDE OF BEARER AND GROUND SURFACE.
- USE TREATED TIMBER WHERE REQUIRED FOR DURABILITY.
- DO NOT USE TIMBER UNSUITABLE FOR EXPOSURE TO MOISTURE IN EXPOSED LOCATION.
- PROVIDE STRUCTURE BRACING IN ACCORDANCE WITH AS1684 - PROVIDE STRUCTURE TIEDOWN IN ACCORDANCE WITH AS1684
- USE GALVANISED FIXINGS WHERE EXPOSED TO WEATHER.

# TERMITE CONTROL:

- TO BE IN ACCORDANCE WITH TO AS3660.1
- SHALL BE IN ACCORDANCE WITH NCC VOL.2 PART 3.1.3 OR VOL.1 PART B1.4.

## FLASHING AND CAPPINGS:

- SELECTION AND INSTALLATION OF METAL RAINWATER GOODS REFER TO AS2180 FLASH PROJECTIONS ABOVE THE ROOF WITH TWO PART FLASHINGS CONSISTING OF AN APRON FLASHING AND OVER FLASHING, WITH AT LEAST 100mm OVERLAP.
- PROVIDE FOR INDEPENDENT MOVEMENT BETWEEN ROOF AND PROJECTION.

## LIGHTING:

- 40% OF NEW OR ALTERED LIGHT FIXTURES TO BE FITTED WITH FLUORESCENT, COMPACT FLUORESCENT, OR LIGHT-EMITTING-DIODE (LED) LAMPS.

## DOOR & WINDOWS:

- ALUMINIUM FRAMED WINDOWS AND DOORS.
   WEATHER STRIPPING IS TO BE PROVIDED TO ALL EXTERNAL WINDOWS AND DOORS.

# STAIRS, HANDRAILS AND BALUSTRADES:

- TIMBER BALUSTRADE

- TO BE IN ACCORDANCE WITH NCC PART 3.9.1 & AS 1657.

- MATERIALS TO BE USED FOR SURFACES OF FLOORS, STAIR LANDING, STEPS AND NOSINGS SHALL BE IN ACCORDANCE WITH THE CLASSIFICATIONS FOR SLIP RESISTANCE AS APPLY IN AS4586 AND HB198.

- TO COMPLY WITH AS/NZS 2179 FOR METAL AND AS1273 FOR UPVC COMPONENTS. NEW DOWNPIPES TO BE CONNECTED INTO EXISTING STORMWATER LINE

**SECTION B-B** 

1:100

- COLORBOND GUTTERS AND DOWNPIPES
- MINIMUM SLOPE OF EAVES AND GUTTERS 1:200

GLAZING: - NCC VOL.1 PARTS B 1.4, D 3.12, F1.13 OR NCC VOL.2 PART 3.6

SMOKE DETECTORS/ALARMS:
- NCC VOL 2 PART 3.7.2, FIRE/SMOKE DETECTORS COMPLYING WITH THE REQUIREMENTS OF THE LOCAL GOVERNMENT ACT AND/OR STATE OR TERRITORY REGULATIONS MUST BE FITTED IN THE LOCATIONS REQUIRED AND APPROVED BY THE AUTHORITY AND SHALL BE INSTALLED IN ACCORDANCE WITH AS3786.

- INSTALLATIONS IN BUILDINGS OTHER THAN CLASS 1 AND 10 MUST BE INSTALLED AND MANAGED TO COMPLY WITH NCC SPEC, E2,2a,

- MULTIPLE ALARMS WITHIN HOUSES AND SOLE OCCUPANCY UNITS MUST BE HARD WIRED AND INTERCONNECTED.

## WASTE MANAGEMENT:

- ALL WASTE SHALL BE TAKEN AWAY BY TRUCKS TO A SUITABLE LANDFILL OR RECYCLE DEPOT.
- ALL WASTE SHALL BE COVERED DURING TRANSPORTATION.
- WASTE GENERATED DURING CONSTRUCTION SHALL BE PLACED IN STEEL BINS AND TAKEN AWAY BY AN APPROVED CONTRACTOR TO A APPROVED LANDFILL SITE.

- A FILTER CLOTH SYSTEM SHALL BE INSTALLED IN ACCORDANCE WITH COUNCIL CONTROLS.

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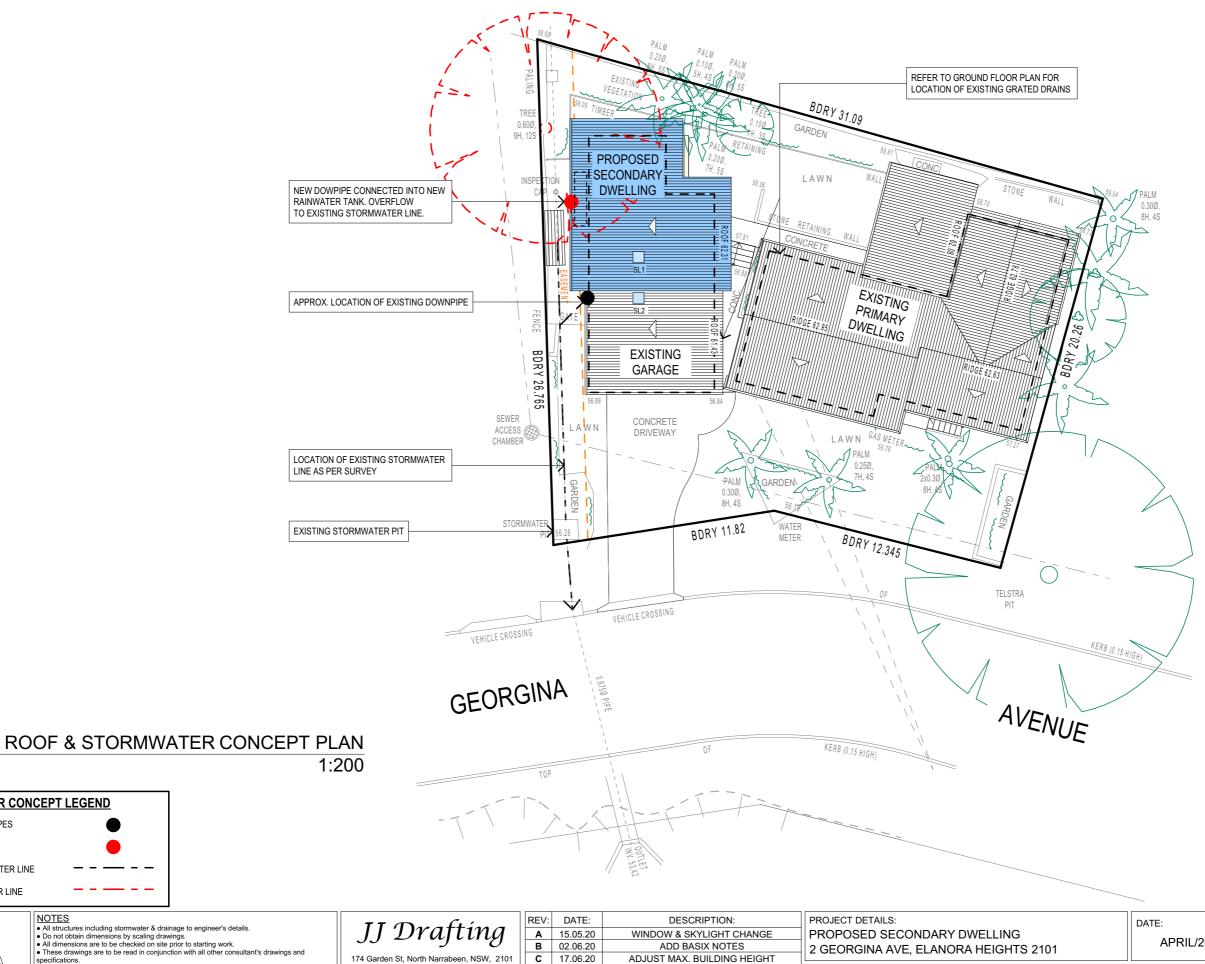
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DRAWING TITLE: SECTIONS / BASIX	JOB N	

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WING TITLE: CTIONS / BASIX	JOB No: 794/20	CHECKED BY:	DRAWING No: DA.05



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EXISTING DOWNPIPES **NEW DOWNPIPES** 

EXISTING STORWATER LINE NEW STORMWATER LINE

STORMWATER CONCEPT LEGEND


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DRAWING TITLE: ROOF & STORMWATER CONCEPT PLAN	JOB No: 794/20	CHECKED BY:	DRAWING No: DA.06





**EXISTING LANDSCAPED AREA PLAN** 1:200

**CALCULATIONS** SITE AREA 602.20m<sup>2</sup> LANDSCAPE CONTROL 60% 361.32m<sup>2</sup> EXISTING LANDSCAPED AREA (INCLUDES 6% OF 57% 343.09m<sup>2</sup> OUTDOOR REC. AREA) HARD SURFACE REINSTATED TO POROUS 28.05m<sup>2</sup> 57.23% 344.65m<sup>2</sup> TOTAL NEW LANDSCAPED AREA EXISTING HARD SURFACE AREA 295.24m<sup>2</sup> TOTAL HARD SURFACE AREA TO BE RETAINED 296.81m<sup>2</sup> NEW HARD SURFACE AREA 26.48m<sup>2</sup> 1.57m<sup>2</sup> NEW ADDITIONAL HARD SURFACE AREA
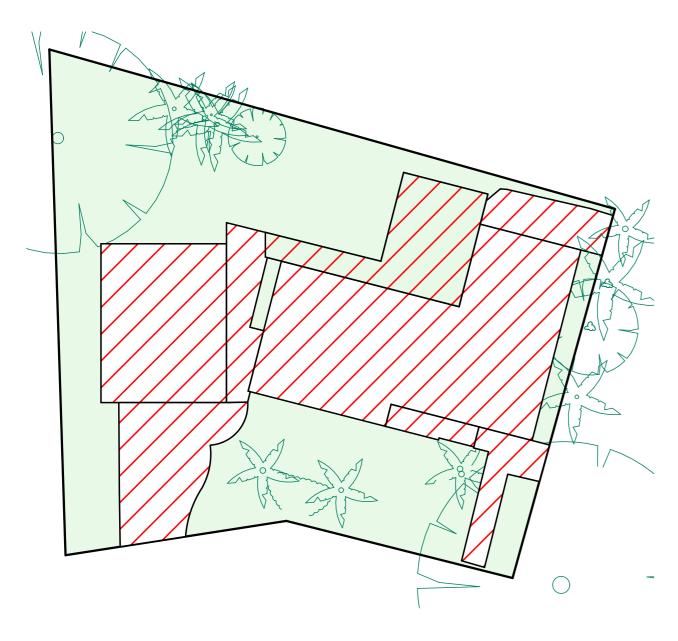
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DRAWING TITLE: LANDSCAPED AREA CALCULATION PLAN	JOB No: 794/20	CHECKED BY:	DRAWING No: DA.07

# **NOTES**

## DESIGNATED SITE MANAGER/BUILDER

PRIOR TO COMMENCEMENT OF WORK A SITE MANAGER OR BUILDER MUST BE NOMINATED. THE SITE MANAGER OR BUILDER WILL BE RESPONSIBLE AND LIABLE FOR ALL WORKS CARRIED OUT ON THE SITE. THIS ASSUMES THE RESPONSIBILITY FOR THE ACTIONS OF ALL SUBCONTRACTED PARTIES AS WELL AS ADVISING THEM OF COUNCIL'S REQUIREMENTS WHEN CARRYING OUT

## TOPSOIL MANAGEMENT

PRIOR TO THE STRIPPING OF TOPSOIL, THE VEGETATIVE COVER MUST BE REDUCED BY EITHER SLASHING OR MOWING. ALL TOPSOIL IS TO BE RETAINED AND PROTECTED FOR REUSE ON SITE. SOIL STOCKPILES MUST NOT BE LOCATED ON NATURE STRIPS, FOOTPATHS, ROADWAYS, KERBS, ACCESSWAYS, WITHIN DRAINAGE LINES/FLOWS/PATHS OR AROUND OR AGAINST TREE SHRUBS. SEDIMENT CONTROL MEASURES MUST BE INCORPORATED WITH ANY RESULTING STOCKPILE. THE STOCKPILE CAN BE PROTECTED FROM EROSION BY COVERING IT WITH AN MPERVIOUS MATERIAL, IN CONJUNCTION WITH THE INSTALLATION OF A SEDIMENT FENCE AROUND IT. IF STOCKPILES ARE TO REMAIN FOR MORE THAN ONE MONTH THEY ARE TO BE GRASSED IMMEDIATELY AND STABILISED WITHIN FOURTEEN DAYS. SURPLUS TOPSOIL MUST BE REASONABLY REMOVED FROM SITE.

## **BUILDING MATERIAL STOCKPILING**

SUFFICIENT AREA MUST BE ALLOCATED WITHIN THE SITE FOR SUCH STORAGE OF BUILDING MATERIALS, DEMOLITION WASTE, WASTE CONTAINERS, ETC. AS WILL BE REQUIRED.

A SEDIMENT FENCE SHOULD BE LOCATED ALONG THE DOWNSLOPE BOUNDARY(S) OF THE SITE. ON THE CONSTRUCTION SIDE OF THE TURF FILTER STRIP OR NATIVE VEGETATION, AND AROUND ALL STOCKPILES OF MATERIAL ON THE SITE.

ALL TRUCKS/UTES MUST COVER THEIR LOADS AT ALL TIMES. APPROPRIATE METHODS ARE TO BE EMPLOYED TO PREVENT BLOWING DUST CREATING AN UNACCEPTABLE HAZARD OR NUISANCE ON THE SITE OR DOWN WIND. PRODUCTION OF DUST CAN BE MINIMISED BY LIMITING AREA OF EARTHWORKS, WATERING AND PROGRESSIVE VEGETATION. WHERE DUST IS CREATED AS A RESULT WORKS AND/OR SOIL EXPOSURE, THE BARE SOIL AREAS MUST BE WATERED, DURING AND/OR AT THE END OF EACH DAY TO LAY THE DUST. EARTH MOVING ACTIVITIES SHOULD BE AVOIDED WHERE WINDS ARE SUFFICIENTLY STRONG ENOUGH TO RAISE VISIBLE

## EROSION & SEDIMENT CONTROLS

APPROPRIATE EROSION AND SEDIMENT CONTROLS MUST BE IMPLEMENTED ON ALL SITES THAT INVOLVE SOIL DISTURBANCE. THE MEASURES MUST BE IN PLACE PRIOR TO THE COMMENCEMENT OF WORK. THOSE CONTROLS ARE TO BE MONITORED AND MAINTAINED IN ORDER TO SERVE THEIR INTENDED FUNCTION FOR THE DURATION OF THE WORKS OR UNTIL SUCH TIME AS THE SITE IS FULLY STABILISED. IF ANY CONTROLS ARE DAMAGED OR BECOME INEFFECTIVE DURING THE COURSE OF THE WORKS THEY ARE TO BE REINSTATED OR REPLACED IMMEDIATELY. SUFFICIENT ACCESS TO THESE CONTROLS MUST BE PROVIDED IN CASE OF THE

# SEDIMENT TRAPS


WHERE A SEDIMENT FENCE IS NOT USED APPROPRIATE SEDIMENT TRAPS SHOULD BE LOCATED. AT ALL POINTS WHERE STORMWATER LEAVES THE CONSTRUCTION SITE OR LEAVES THE GUTTER AND ENTERS THE DRAINAGE SYSTEM. A COMMON TECHNIQUE IS THE GRAVEL SAUSAGE.

## **DIVERSION CHANNELS**


A DIVERSION CHANNEL IS AN EXCAVATED EARTH DITCH OR PATH. THESE STRUCTURES ARE USED TO INTERCEPT AND DIRECT RUN-OFF TO A DESIRED LOCATION WHERE POSSIBLE. ALL STORMWATER RUN-OFF FLOWING ONTO DISTURBED AREAS, INCLUDING STOCKPILES, MUST BE INTERCEPTED, DIVERTED AND/OR SAFELY DISPOSED OF. THIS CAN BE ACHIEVED BY CONSTRUCTING A TEMPORARY EARTH BANK AROUND THE UPSLOPE EXTENT OF THE CONSTRUCTION SITE WHERE THE DIVERSION DOES NOT AFFECT THE NEIGHBOURING

# VEHICLE MOVEMENTS

TO LIMIT DISTURBANCE TO THE SITE AND TRACKING OF MATERIAL ONTO THE STREET ALL VEHICLES AND PLANT EQUIPMENT ARE TO USE A SINGLE ENTRY/EXIT POINT UNLESS COUNCIL HAS APPROVED ALTERNATIVE ARRANGEMENTS. ACCESS POINTS AND PARKING AREAS ARE TO BE STABILISED WITH COMPACTED SUB-GRADE ASAP AFTER THEIR FORMATION. IF SPILLAGE DOES OCCUR IT IS TO BE CONTAINED IMMEDIATELY AND CAREFULLY REMOVED. THE AREA AFFECTED IS TO BE RESTORED TO A STANDARD EQUAL TO OR BETTER THAN ITS PREVIOUS CONDITION. ALL VEHICLES ARE TO BE WASHED PRIOR TO EXISTING THE SITE. THIS SERVES THE PURPOSE OF REMOVING SITE MATERIAL ON THE VEHICLE AND PREVENTS IT FROM BEING DEPOSITED ON THE ROAD NETWORK ADJACENT TO THE SITE AND THUS, THE STORMWATER SYSTEM. NO VEHICLE ASSOCIATED WITH THE WORK IS TO BE PARKED ON A FOOTPATH OR PUBLIC RESERVE. ALL VEHICLES VISITING THE SITE DURING DEMOLITION, EXCAVATION AND/OR CONSTRUCTION WORKS, ARE TO COMPLY WITH THE PARKING REQUIREMENTS IN THAT AREA.

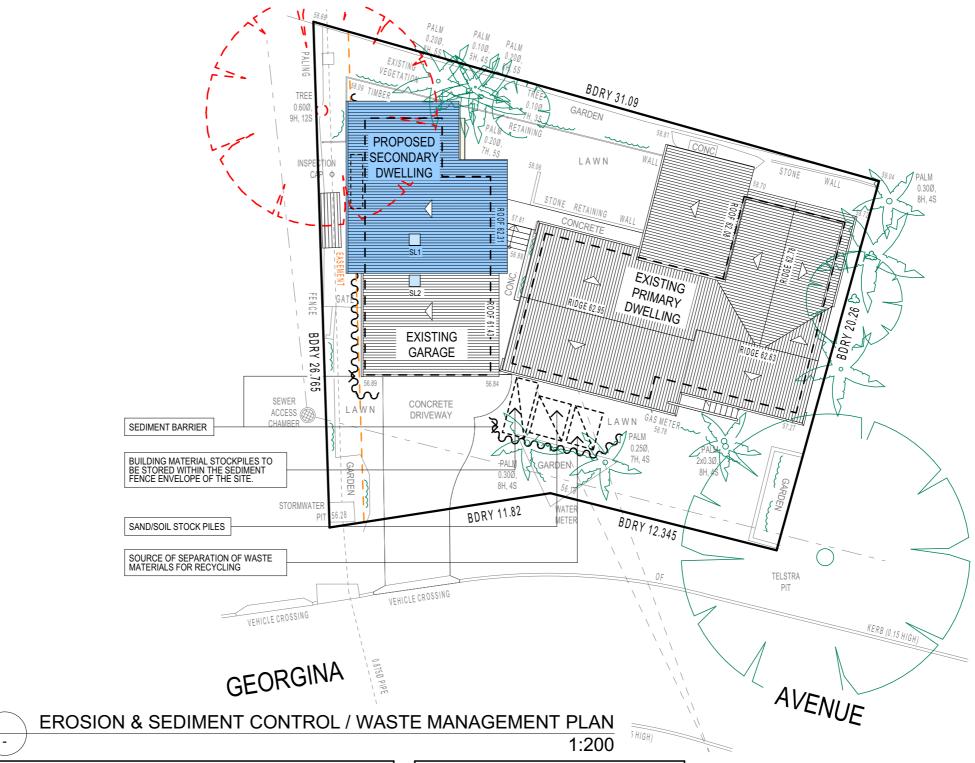



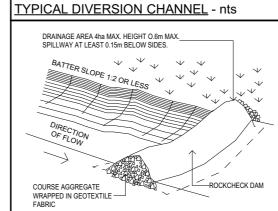

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FABRIC OVERLAP-

CHANNEL MINIMUM

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-GEOTEXTILE FILTER FABRIC

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1	DRAWING TITLE: EROSION & SEDIMENT CONTROL / WASTE MANAGEMENT PLAN	JOB No: 794/20	CHECKED BY:	DRAWING No: DA.08

