

Scale: 1:200

DRAINAGE DESIGN SUMMARY			
IMPERVIOUS AREAS DRAINING TO OSD SYSTEM			
INCREASE IN IMPERVIOUS AREA	69m2		
WATER MANAGEMENT FOR DEVELOPMENT			
POLICY TABLE 7	45001		
MIN OSD CAPACITY >50-75m2	4500 L		
PERMISSIBLE SITE DISCHARGE	2 L/S		
ORIFICE PLATE DIAMETER	29mm		

REV	AMENDMENT	ISSUED	DATE
Α	INITIAL ISSUE	DE	24/05/24
В	RAINGARDEN ADDED	DE	22/08/24

LODESSA P: 0418681794

SANDRO ILLANI

DRAINAGE PLAN FOR PROPOSED SUBDIVISION 7 COOLEENA ROAD ELEANORA HEIGHTS

Designed: Drawn: Checked: DE 5-COO-001 File Ref.


DRAINAGE PLAN

X-Sect. Datum: A.H.D.

Horiz. Vert.

В

REV.

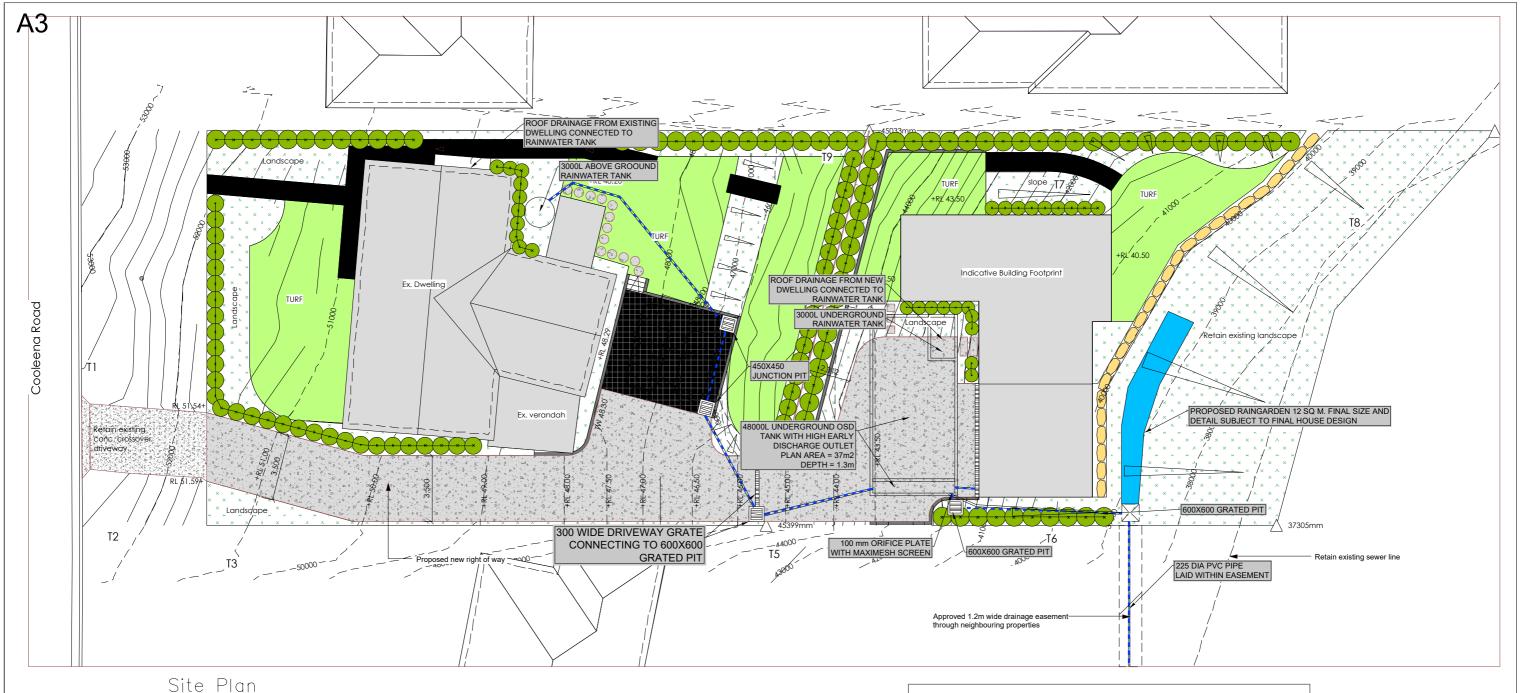

Site Plan Scale: 1:200

DRAINAGE DESIGN SUMMARY				
IMPERVIOUS AREAS DRAINING TO OSD SYSTEM				
EXISIING DWELLING	286m2			
PROPOSED DWELLING, DRIVEWAY AND PARKING AREAS	489m2			
TOTAL	775m2			
WATER MANAGEMENT FOR DEVELOPMENT POLICY TABLE 7				
MIN OSD CAPACITY >700-800m2	48000 L			
PERMISSIBLE SITE DISCHARGE	24 L/S			

REV	AMENDMENT	ISSUED	DATE
Α	INITIAL ISSUE	DE	24/05/24
В	RAINGARDEN ADDED	DE	22/08/24

LODESSA

SURVEYING
CIVIL ENGINEERING
STRUCTURAL ENGINEERING
PROJECT MANAGEMENT

SANDRO ILLANI

DRAINAGE PLAN FOR PROPOSED SUBDIVISION 7 COOLEENA ROAD ELEANORA HEIGHTS

 Designed:
 Scales: Plan

 Drawn:
 DE
 Horiz. Vert.

 Checked:
 DE
 X-Sect.

5-COO-002
File Ref.

DRAINAGE PLAN

Datum: A.H.D.

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