SUBSET NAME	DRAWING No.	DESCRIPTION	REVISION ID
Architectural set - S	64.55		
	A000	COVER PAGE	03
	A001	LEGEND AND SPECIFICATIONS	03
	A002	SURVEY	03
	A003	SITE PLAN	03
	A004	DEMOLITION PLAN	03
	A005	DEMOLITION PLAN - WALLS	03
	A006	LANDSCAPE PLAN	03
Floor Plans			
	A100	GROUND FLOOR	03
	A101	FIRST FLOOR	03
	A102	ROOF PLAN	03
Elevations			
	A200	EAST AND SOUTH ELEVATION	03
	A201	NORTH AND WEST ELEVATION	03
Sections			
	A300	SECTIONS	03
Control Plans			
	A400	CONTROL PLAN	03
Schedules			
	A500	WINDOW SCHEDULE	03
	A501	DOOR SCHEDULE	03





OUTES

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LEGEND

SITE BOUNDARY

SUBDIVISION LINE

PROPOSED GROUND FLOOR OUTLINE PROPOSED FIRST FLOOR OUTLINE

DRAWING TITLE COVER PAGE

1108 OXFORD FALLS RD

SCALE NOT TO SCALE

A000

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DEMOLITION

- AS 2601:2001 - THE DEMOLITION OF STRUCTURES

BUILDING SPECIFICATION - BUILDING CLASS 2 - B

SITE PREPARATION

- PART 3.1 OF THE BCA [NCC 2019 VOLUME 2]

EARTHWORKS

- TO BE CARRIED OUT IN ACCORDANCE WITH THE REQUIREMENTS OF THE ENVIRONMENTAL PLANNING & ASSESSMENT ACT 1979 AND DEVELOPMENT CONSENT CONDITIONS
- PART 3.1.1 OF THE BCA [NCC 2019 VOLUME 2]
- AS 3798:2007 GUIDELINES ON EARTHWORKS FOR COMMERCIAL & RESIDENTIAL DEVELOPMENTS
- AS 4678:2002 EARTH-RETAINING STRUCTURES DRAINAGE
- PART 3.1.3 OF THE BCA [NCC 2019 VOLUME 2]
- AS/NZS 3500.1:2018 PLUMBING & DRAINAGE WATER SERVICES
- AS/NZS 3500.2:2018 PLUMBING & DRAINAGE SANITARY PLUMBING DRAINAGE
- AS/NZS 3500.3:2018 PLUMBING & DRAINAGE STORMWATER DRAINAGE
- AS/NZS 3500.4:2018 PLUMBING & DRAINAGE HEATED WATER **SERVICES**

TERMITE MANAGEMENT

- PART 3.1.4 OF THE BCA [NCC 2019 VOLUME 2]
- AS 3660.1:2014 TERMITE MANAGEMENT NEW BUILDING WORK
- AS 3660.2:2017 TERMITE MANAGEMENT IN AND AROUND EXISTING **BUILDINGS & STRUCTURES**

FOOTINGS & SLABS

- PART 3.2 OF THE BCA [NCC 2019 VOLUME 2]
- AS 2159:2009 PILING DESIGN & INSTALLATION
- AS 2870:2011 RESIDENTIAL SLABS & FOOTINGS
- AS 3600:2018 CONCRETE STRUCTURES MASONRY
- PART 3.3 OF THE BCA [NCC 2019 VOLUME 2]
- AS 3700:2018 MASONRY STRUCTURES

FRAMING

- PART 3.4 OF THE BCA [NCC 2019 VOLUME 2]
- AS 1684.2:2010 RESIDENTIAL TIMBER-FRAMED CONSTRUCTION -NON-CYCLONIC AREAS
- AS 1720.1:2010 TIMBER STRUCTURES DESIGN METHODS
- AS 4100:1998 STEEL STRUCTURES

ROOF & WALL CLADDING

- PART 3.5 OF THE BCA [NCC 2019 VOLUME 2]
- AS 1273:1991 UNPLASTICIZED PVC (UPVC) DOWNPIPES & FITTINGS FOR RAINWATER
- AS 1562.1:2018 DESIGN & INSTALLATION OF SHEET ROOF & WALL **CLADDING - METAL**
- AS 1562.2:1999 DESIGN & INSTALLATION OF SHEET ROOF & WALL CLADDING - CORRUGATED FIBRE-REINFORCED CEMENT
- AS/NZS 1562.3:1996 DESIGN & INSTALLATION OF SHEET ROOF & WALL

CLADDING - PLASTIC

- AS 2049:2002 ROOF TILES
- AS 2050:2018 INSTALLATION OF ROOF TILES
- AS 4285:2019 ROOFLIGHTS

GLAZING

- PART 3.6 OF THE BCA [NCC 2019 VOLUME 2]
- AS 1288:2006 GLASS IN BUILDINGS SELECTION & INSTALLATION
- AS 2047:2014 WINDOWS & EXTERNAL GLAZED DOORS IN BUILDINGS
- AS/NZS 2208:1996 SAFETY GLAZING MATERIALS IN BUILDINGS

ENERGY EFFICIENCY

SITE BOUNDARY

SUBDIVISION LINE

- PART 3.12 OF THE BCA [NCC 2019 VOLUME 2]
- TO MEET THE BASIX CERTIFICATE REQUIREMENTS

FIRE SAFETY

- PART C OF THE BCA [NCC 2019 VOLUME 2]
- AS 3786:2014 SMOKE ALARMS USING SCATTERED LIGHT, TRANSMITTED LIGHT OR IONIZATION

HEALTH & AMENITY

- PART 3.8 OF THE BCA [NCC 2019 VOLUME 2]
- AS/NZS ISO 717.1:2004 ACOUSTICS RATING OF SOUND INSULATION IN BUILDINGS & OF BUILDING ELEMENTS - AIRBORNE SOUND INSULATION
- AS ISO 717.2:2004 ACOUSTICS RATING OF SOUND INSULATION IN **BUILDINGS**
- & OF BUILDING ELEMENTS IMPACT SOUND INSULATION
- AS 1668.2:2012 THE USE OF VENTILATION & AIR CONDITIONING IN BUILDINGS
- MECHANICAL VENTILATION IN BUILDINGS
- AS 1668.4:201 THE USE OF VENTILATION & AIR CONDITIONING IN **BUILDINGS -NATURAL VENTILATION OF BUILDINGS**
- AS/NZS 1680.0:2009 INTERIOR LIGHTING SAFE MOVEMENT
- AS/NZS 1680.1:2006 INTERIOR & WORKPLACE LIGHTING GENERAL PRINCIPLES & RECOMMENDATIONS
- AS 3740:2010 WATERPROOFING OF DOMESTIC WET AREAS
- AS/NZS 4858:2004 WET AREA MEMBRANES

SAFE MOVEMENT & ACCESS

- PART 3.9 OF THE BCA [NCC 2019 VOLUME 2]
- AS 1428.1:2009 DESIGN FOR ACCESS & MOBILITY GENERAL REQUIREMENTS FOR ACCESS - NEW BUILDING WORK
- AS 1657:2018 FIXED PLATFORMS, WALKWAYS, STAIRWAYS & LADDERS
- DESIGN, CONSTRUCTION & INSTALLATION

SWIMMING POOLS

- TO BE CONSTRUCTED IN ACCORDANCE WITH THE REQUIREMENTS OF THESWIMMING POOLS ACT 1992 [NO. 49] & SWIMMING POOLS **REGULATION 2018**
- PART 3.10.1 OF THE BCA [NCC 2019 VOLUME 2]
- AS 1926.1:2012 SWIMMING POOL SAFETY SAFETY BARRIERS FOR SWIMMING POOLS
- AS 1926.2:2007 SWIMMING POOL SAFETY LOCATION OF SAFETY BARRIERS FOR SWIMMING POOLS
- AS 1926.3:2010 SWIMMING POOL SAFETY WATER RECIRCULATION SYSTEMS

STRUCTURAL DESIGN MANUALS

- AS/NZS 1170.0:2002 STRUCTURAL DESIGN ACTIONS GENERAL **PRINCIPLES**
- AS/NSZ 1170.1:2002 STRUCTURAL DESIGN ACTIONS PERMANENT, **IMPOSED & OTHER ACTIONS**
- AS/NZS 1170.2:2011 STRUCTURAL DESIGN ACTIONS WIND ACTIONS - AS/NZS 1170.3:2003 - STRUCTURAL DESIGN ACTIONS - SNOW & ICE
- ACTIONS - AS 1170.4:2007 - STRUCTURAL DESIGN ACTIONS - EARTHQUAKE
- **ACTIONS IN AUSTRALIA**
- AS/NZS 1664.1:1997 ALUMINIUM STRUCTURES LIMIT STATE DESIGN - AS/NZS 1664.2:1997 - ALUMINIUM STRUCTURES - ALLOWABLE STRESS DESIGN
- AS 1720.1:2010 TIMBER STRUCTURES DESIGN METHODS
- AS 1720.4:2006 TIMBER STRUCTURES FIRE RESISTANCE FOR STRUCTURAL ADEQUACY OF TIMBER MEMBERS
- AS 1720.5:2015 TIMBER STRUCTURES NAIL PLATED TIMBER ROOF **TRUSSES**
- AS/NZS 2269.0:2012 PLYWOOD STRUCTURAL SPECIFICATIONS - AS/NZS 2327:2017 - COMPOSITE STRUCTURES - COMPOSITE STEEL-
- CONCRETE CONSTRUCTION IN BUILDINGS - AS 2159:2009 - PILING - DESIGN & INSTALLATION
- AS 3600:2018 CONCRETE STRUCTURES
- AS 3700:2018 MASONRY STRUCTURES
- AS 3850.1:2015 PREFABRICATED CONCRETE STRUCTURES GENERAL REQUIREMENTS
- AS 3850.2:2015 PREFABRICATED CONCRETE STRUCTURES BUILDING
- CONSTRUCTION
- AS 4055:2012 WIND LOADS FOR HOUSING
- AS 4100:1998 STEEL STRUCTURES

CAR PARKING

ACTURE COOK A COOK BARIOUS EACH ITIES. OFF OTREET CAR BARIOUS

LEGEND

ABREVIATIONS

NOTES & ROLES

APES

AS

BCA

BYO

TBC

COS

ST

BIR

DP

FW

DW

WM

DRY

RG

FRD / FRZ

18 m or more

less than 1.5 m

3 m or more

less than 18 m

18 m or more

1.5 to less than 3 m

EXTERNAL COLUMN

Bounding public corridors, public lobbies and the like

Table C1.1 Type of construction required

FURNITURE

FIXTURES

Concrete

Existing Stone Path

Timber Decking

Floor tile

As per Architect Specifications

As per Engineer Specifications

Australian Standards

By Others

Storage

Downpipe

Floor waste

Dishwasher

Dryer

Washmachine

Fridge / Freezer

Kitchen Range (Stove and oven)

2, 3 or 4 part

90/ 60/ 30

-/ 60/ 30

60/60/60

60/60/60

Rise in storeys Class of building 2, 3, 9 Class of building 5, 6, 7, 8

Build in Robe

To be confirm

Confirm on Site

Building Code of Australia

Stepping stones with pebbles in gaps

OPENING

Wall Hole dimensions

Door

ANNOTATION LEGEND

GENERAL SYMBOL

Class of building-FRL: (in minutes

5, 7a or 9

-/ 90/ 60

-/120/ 90

(E) RL Existing Reference level

Sea level

Proposed Reference level

Smoke alarm

7b or 8

-/240/240

-/180/120

Window

WHD

Demolish



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1108 OXFORD FALLS RD

Frenchs Forest NSW 2086

NORTHERN BEACHES COUNCIL

ADDITION AND MODIFICATION

TOTAL LANDCASPE APPROVED

MANLY DCP - PART 4 - 4.1 RESIDENTIAL DC

WARRINGAH DCP

WARRINGAH LEP 2011

TO EXISTING DA

FSR 0.15:1

56 % 965.5 M2

261.1 M2

TOTAL GFA APPROVED

Y/-/DP395065

1726 m²

8.5 m

PLOT INFORMATION

LOT / SECTION / PLAN No

MAXIMAL HEIGHT LEP

ADDRESS

LOT AREA

COUNCIL

REGULATION

PORPOSED

APPROVED

DA2017/0386

DM: Deferred Matter

- DRAWINGS NOT ISSUED FOR CONSTRUCTION.

PROPOSED GROUND FLOOR OUTLINE

A001

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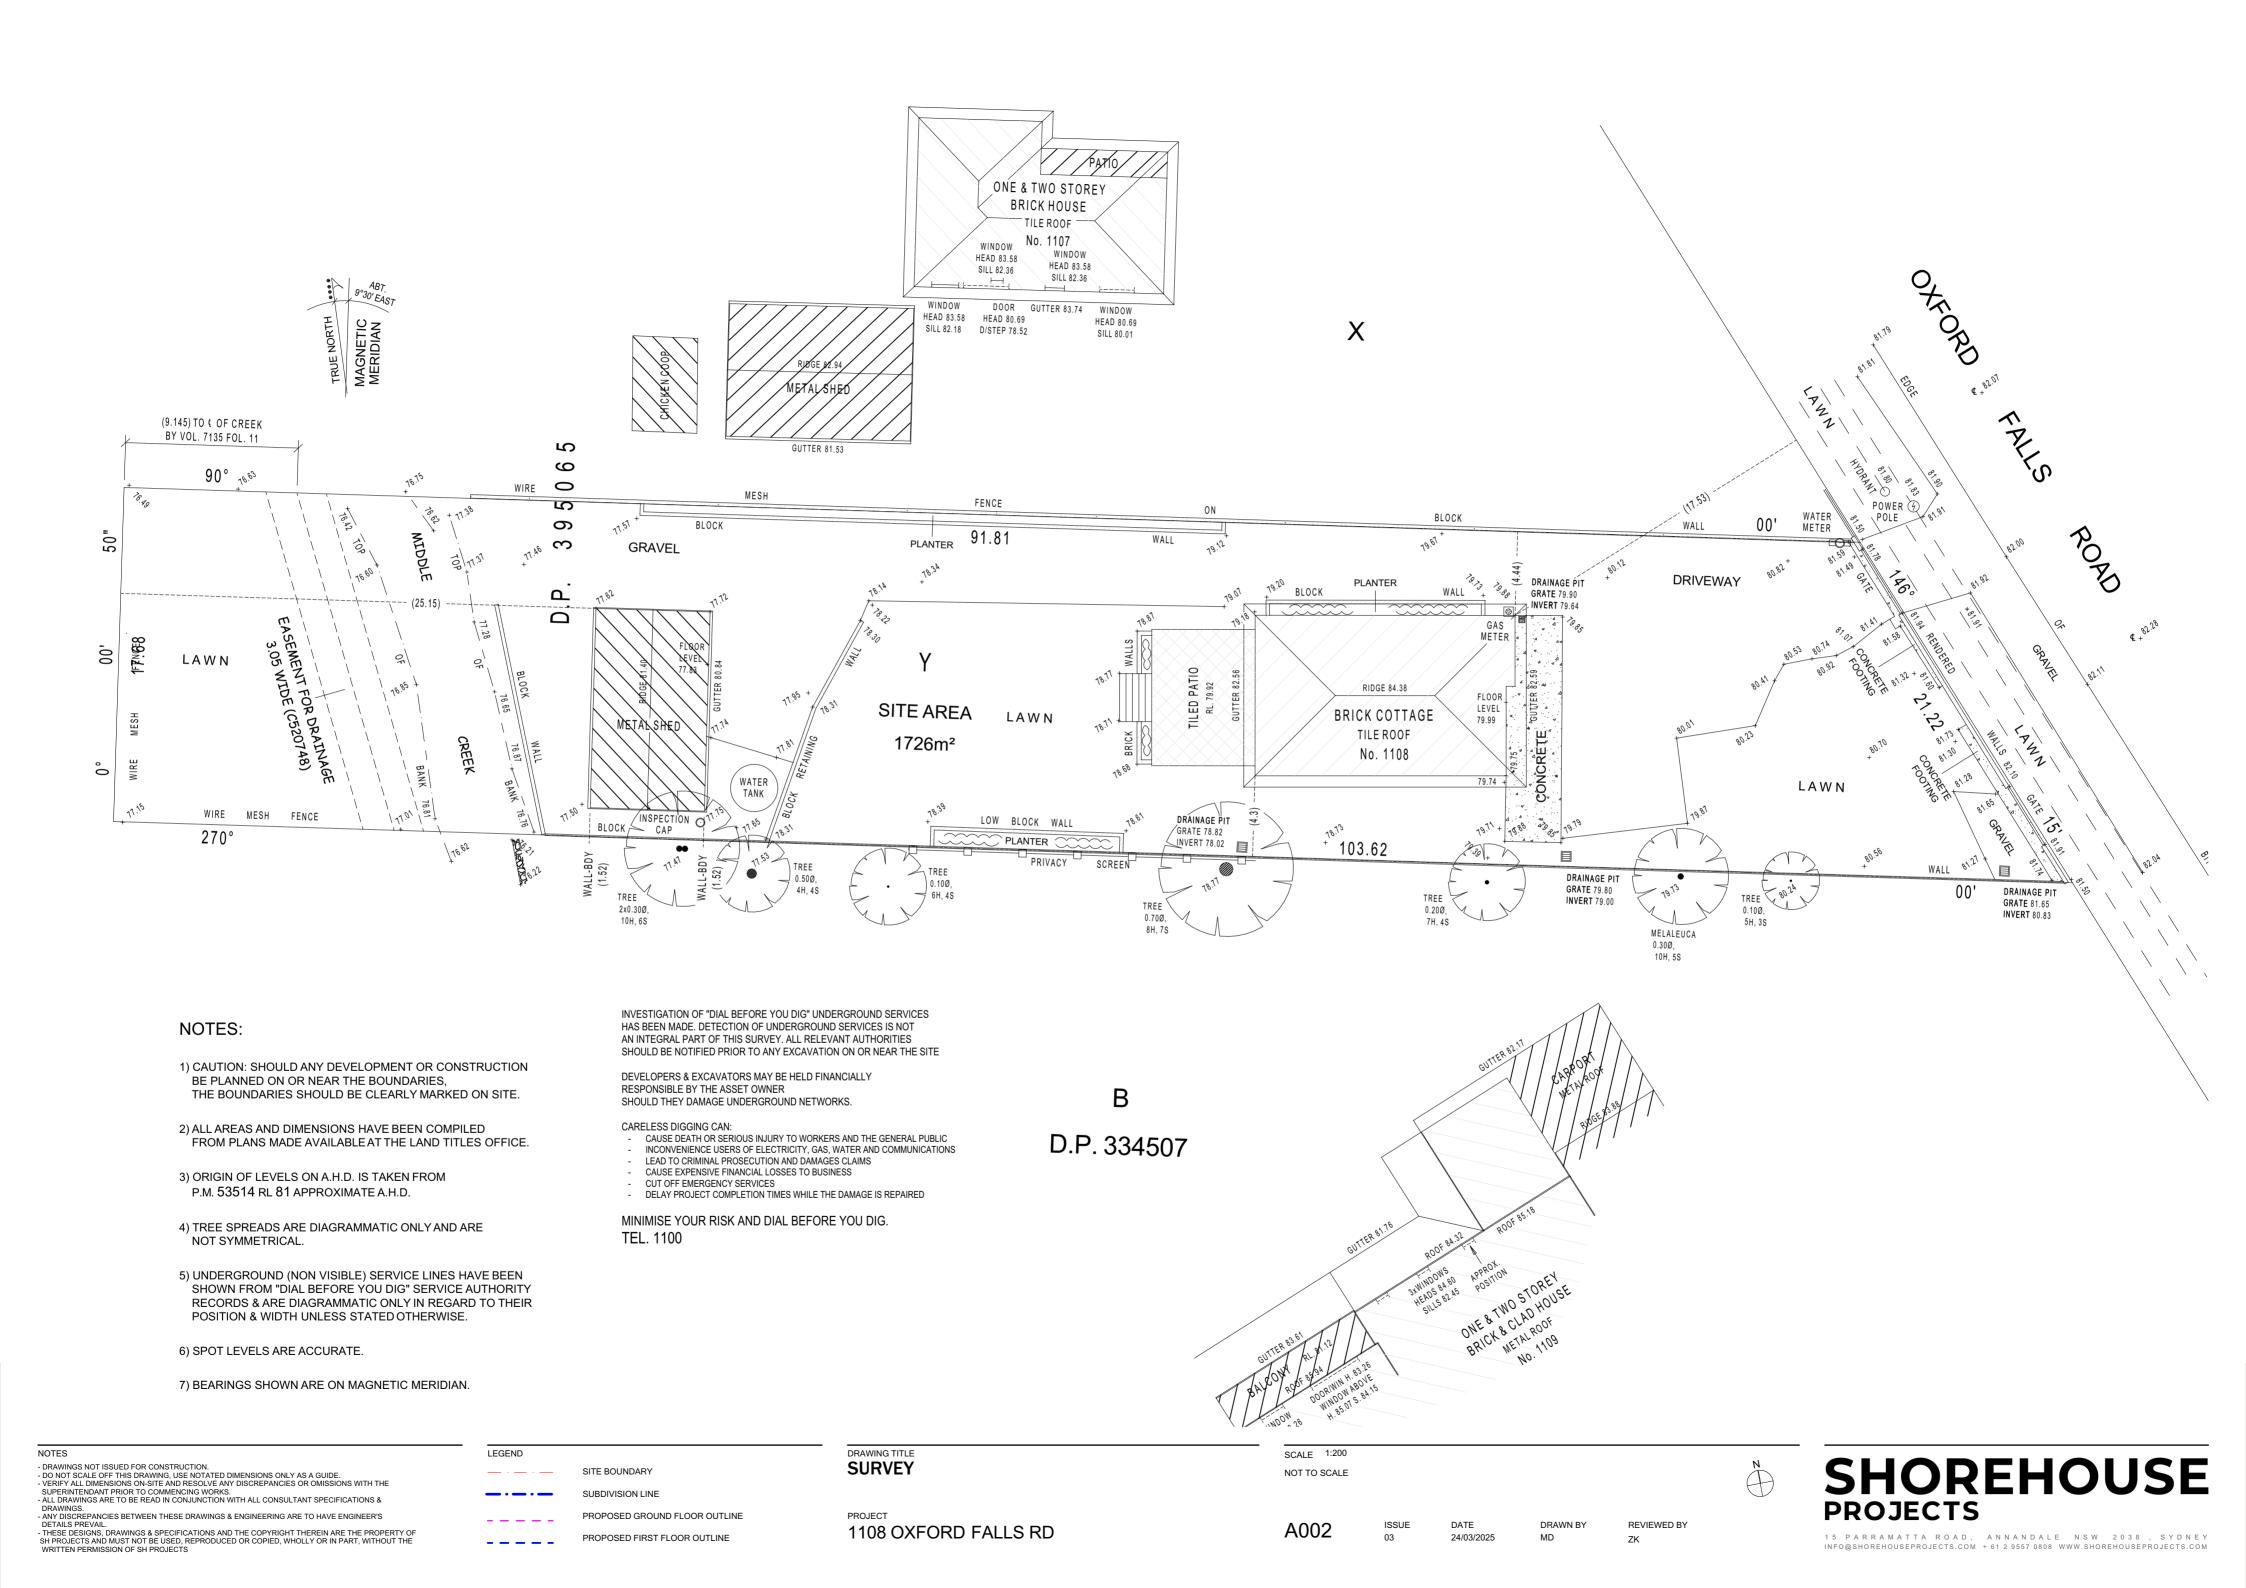
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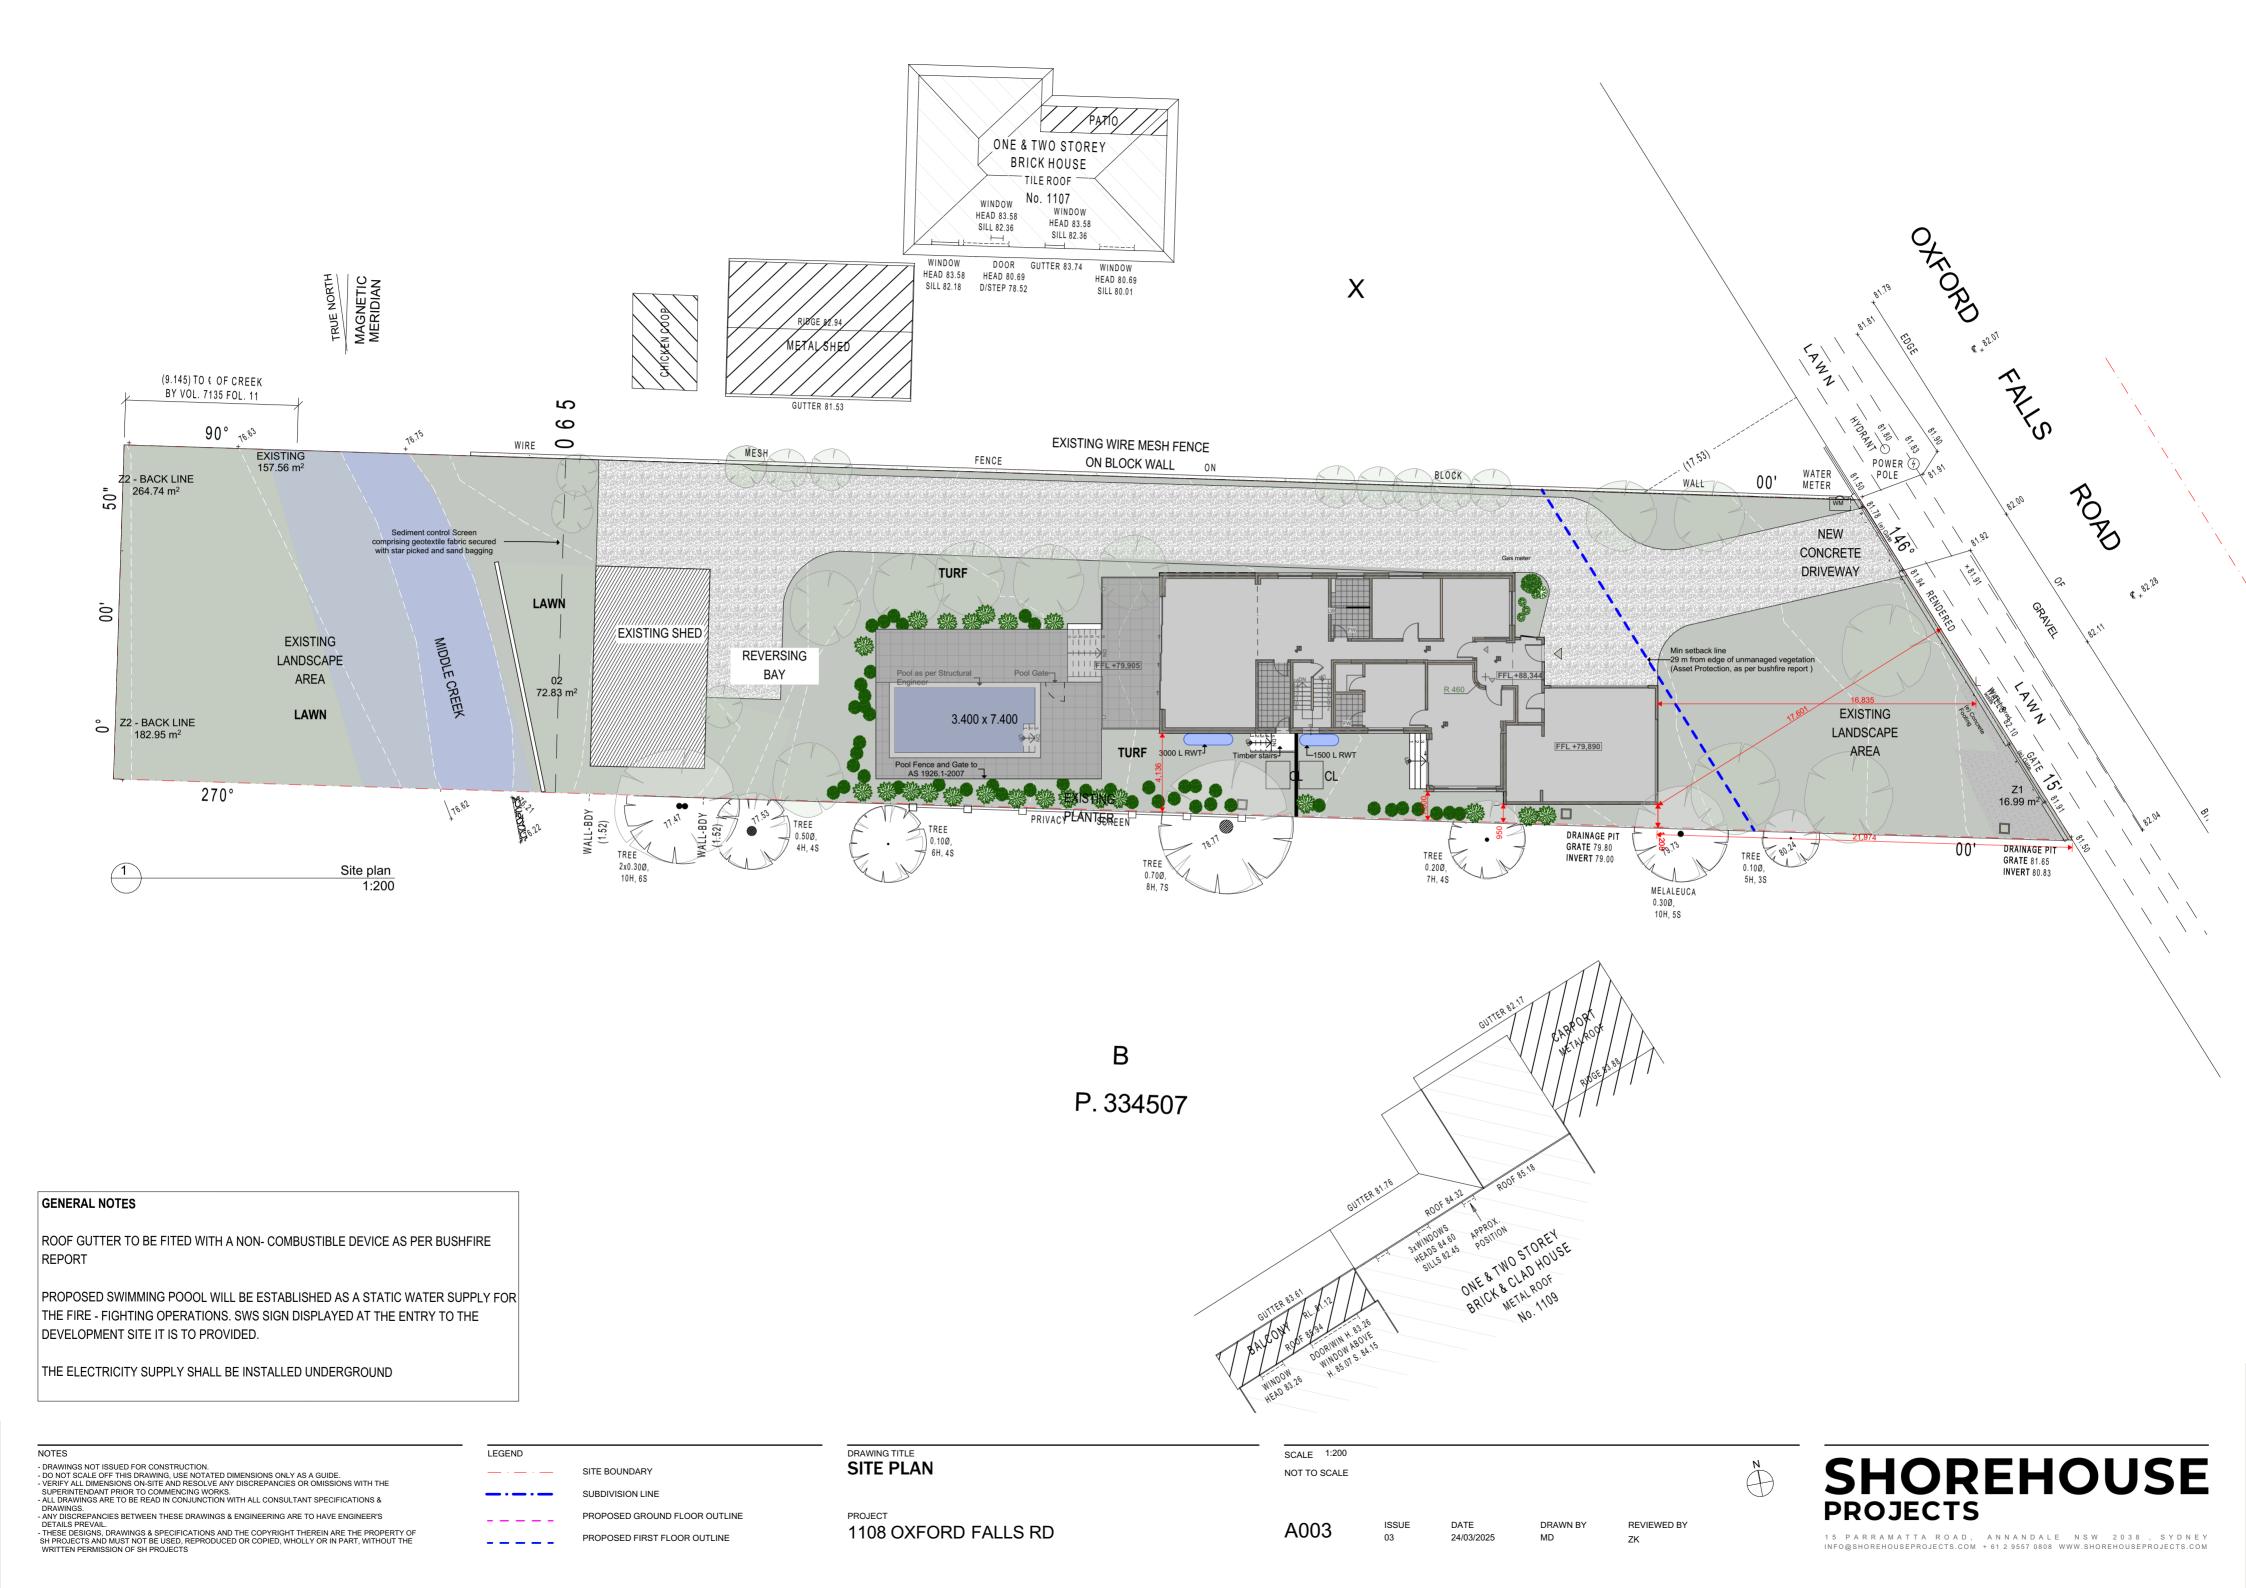
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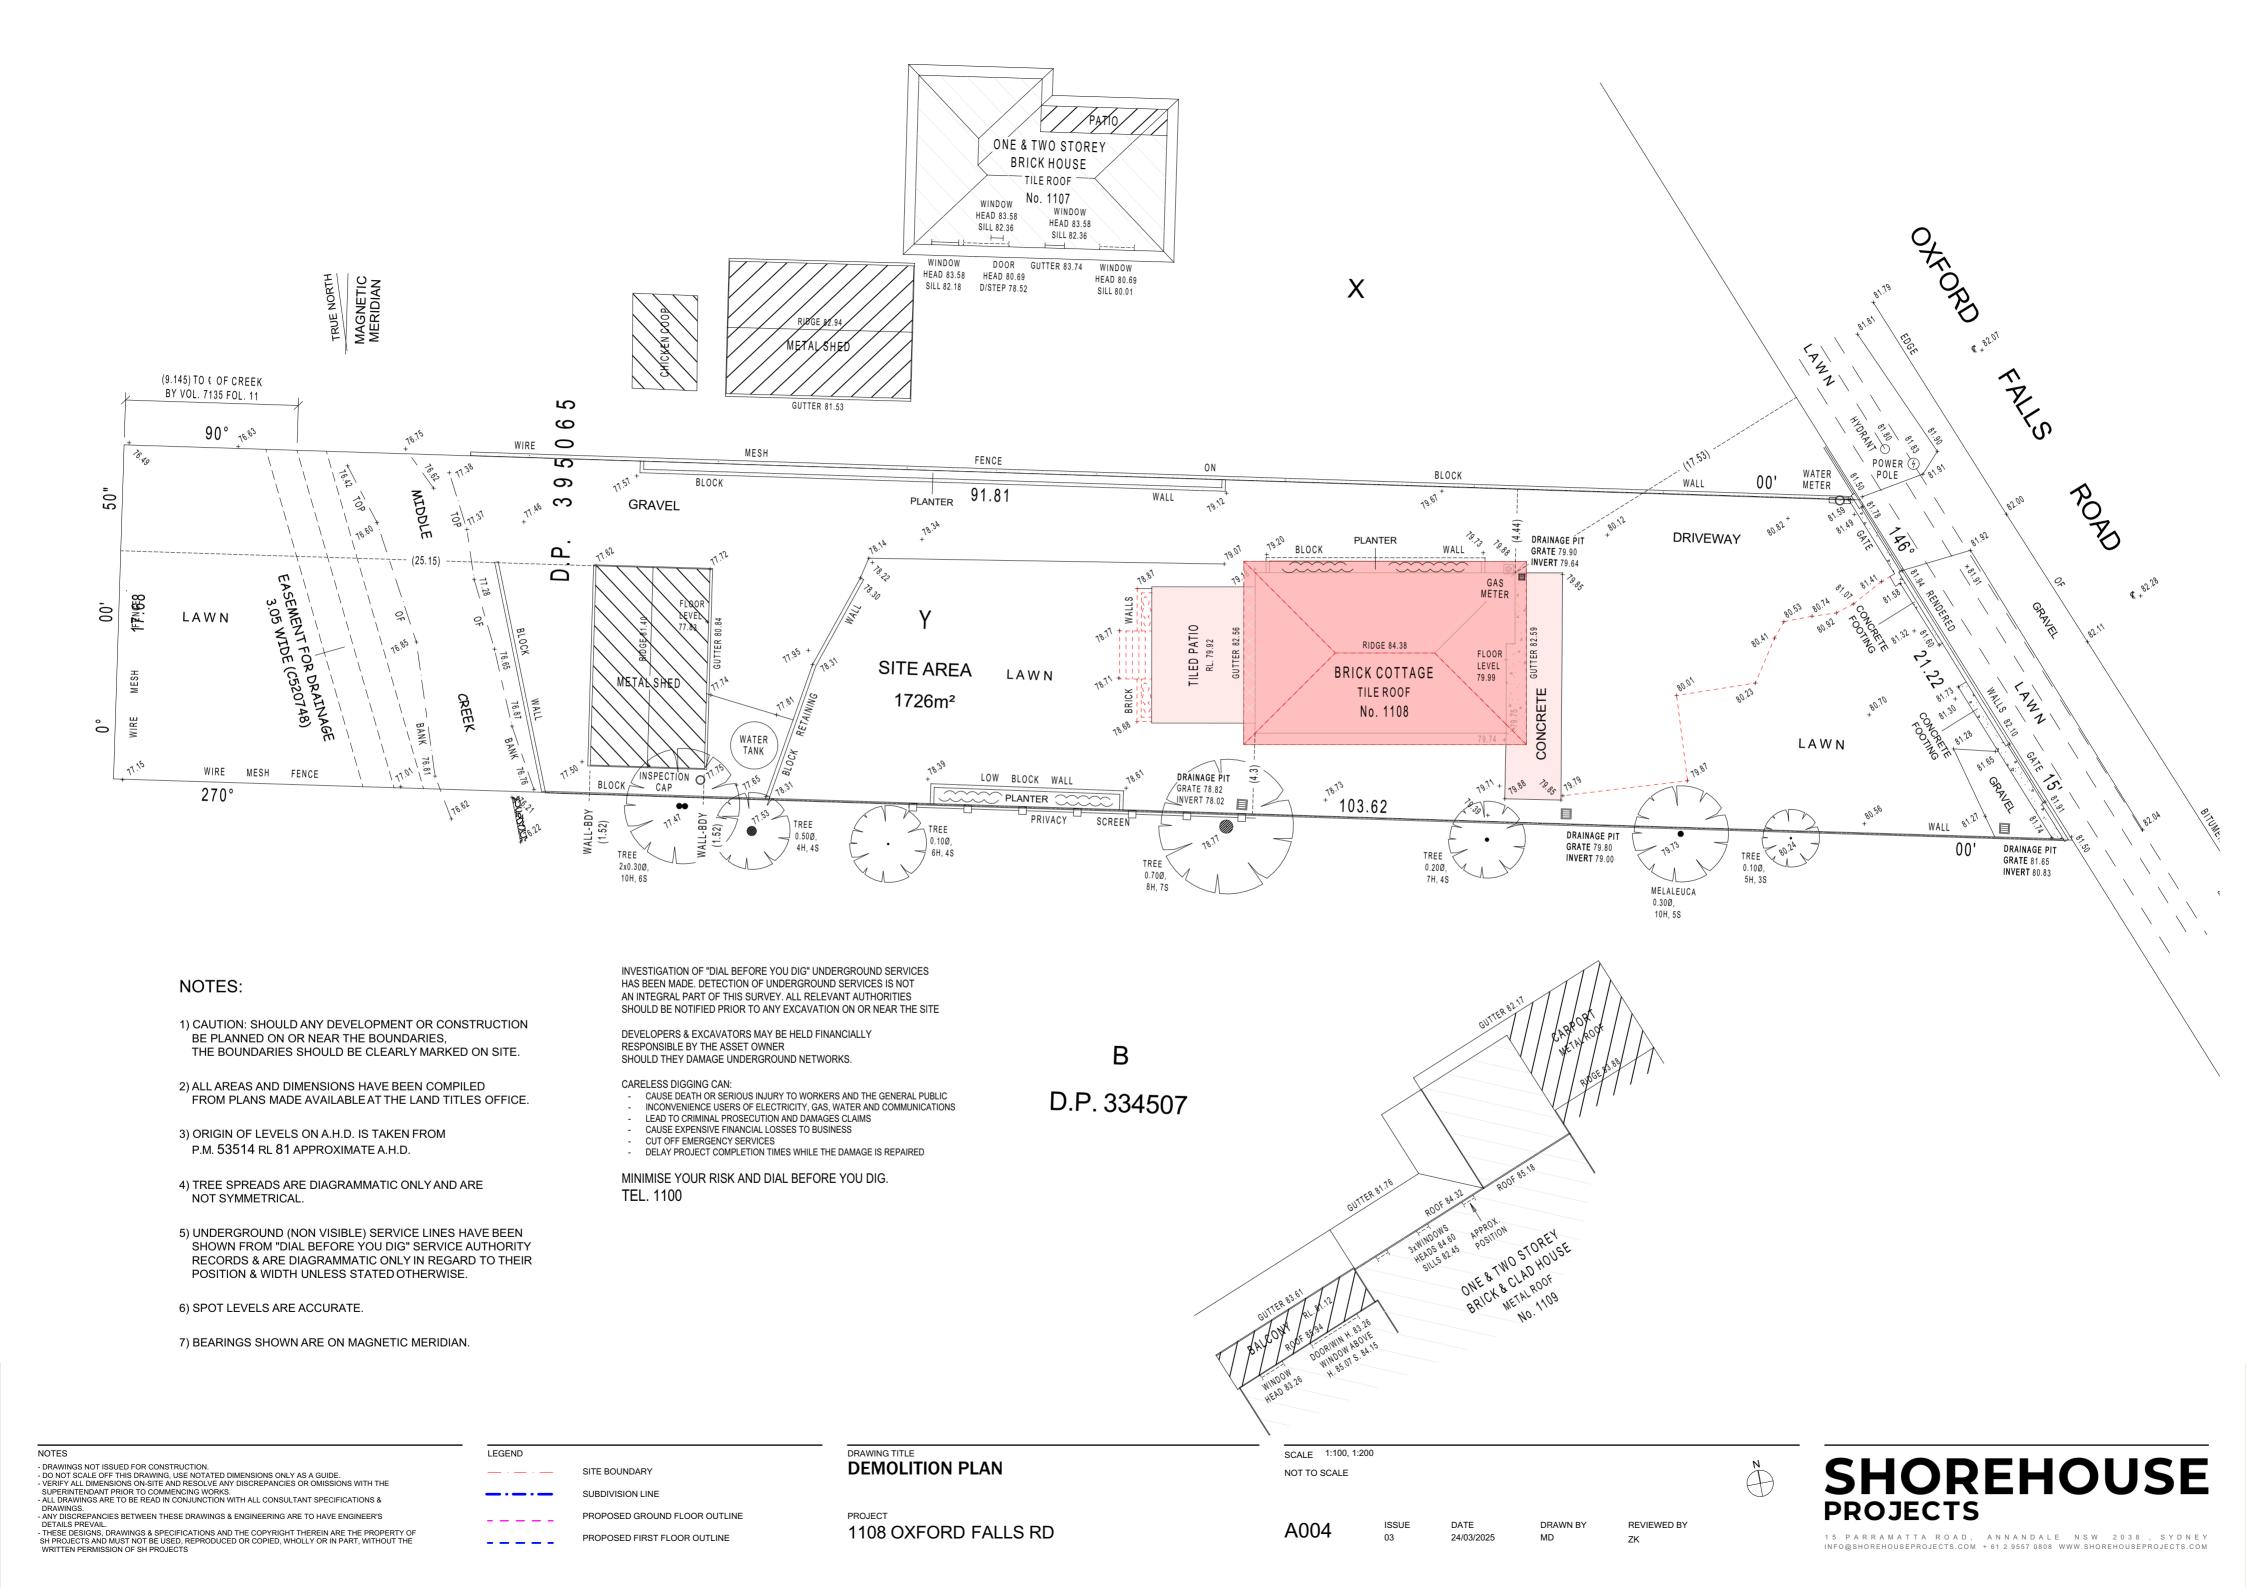
LEGEND


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LEGEND AND SPECIFICATIONS







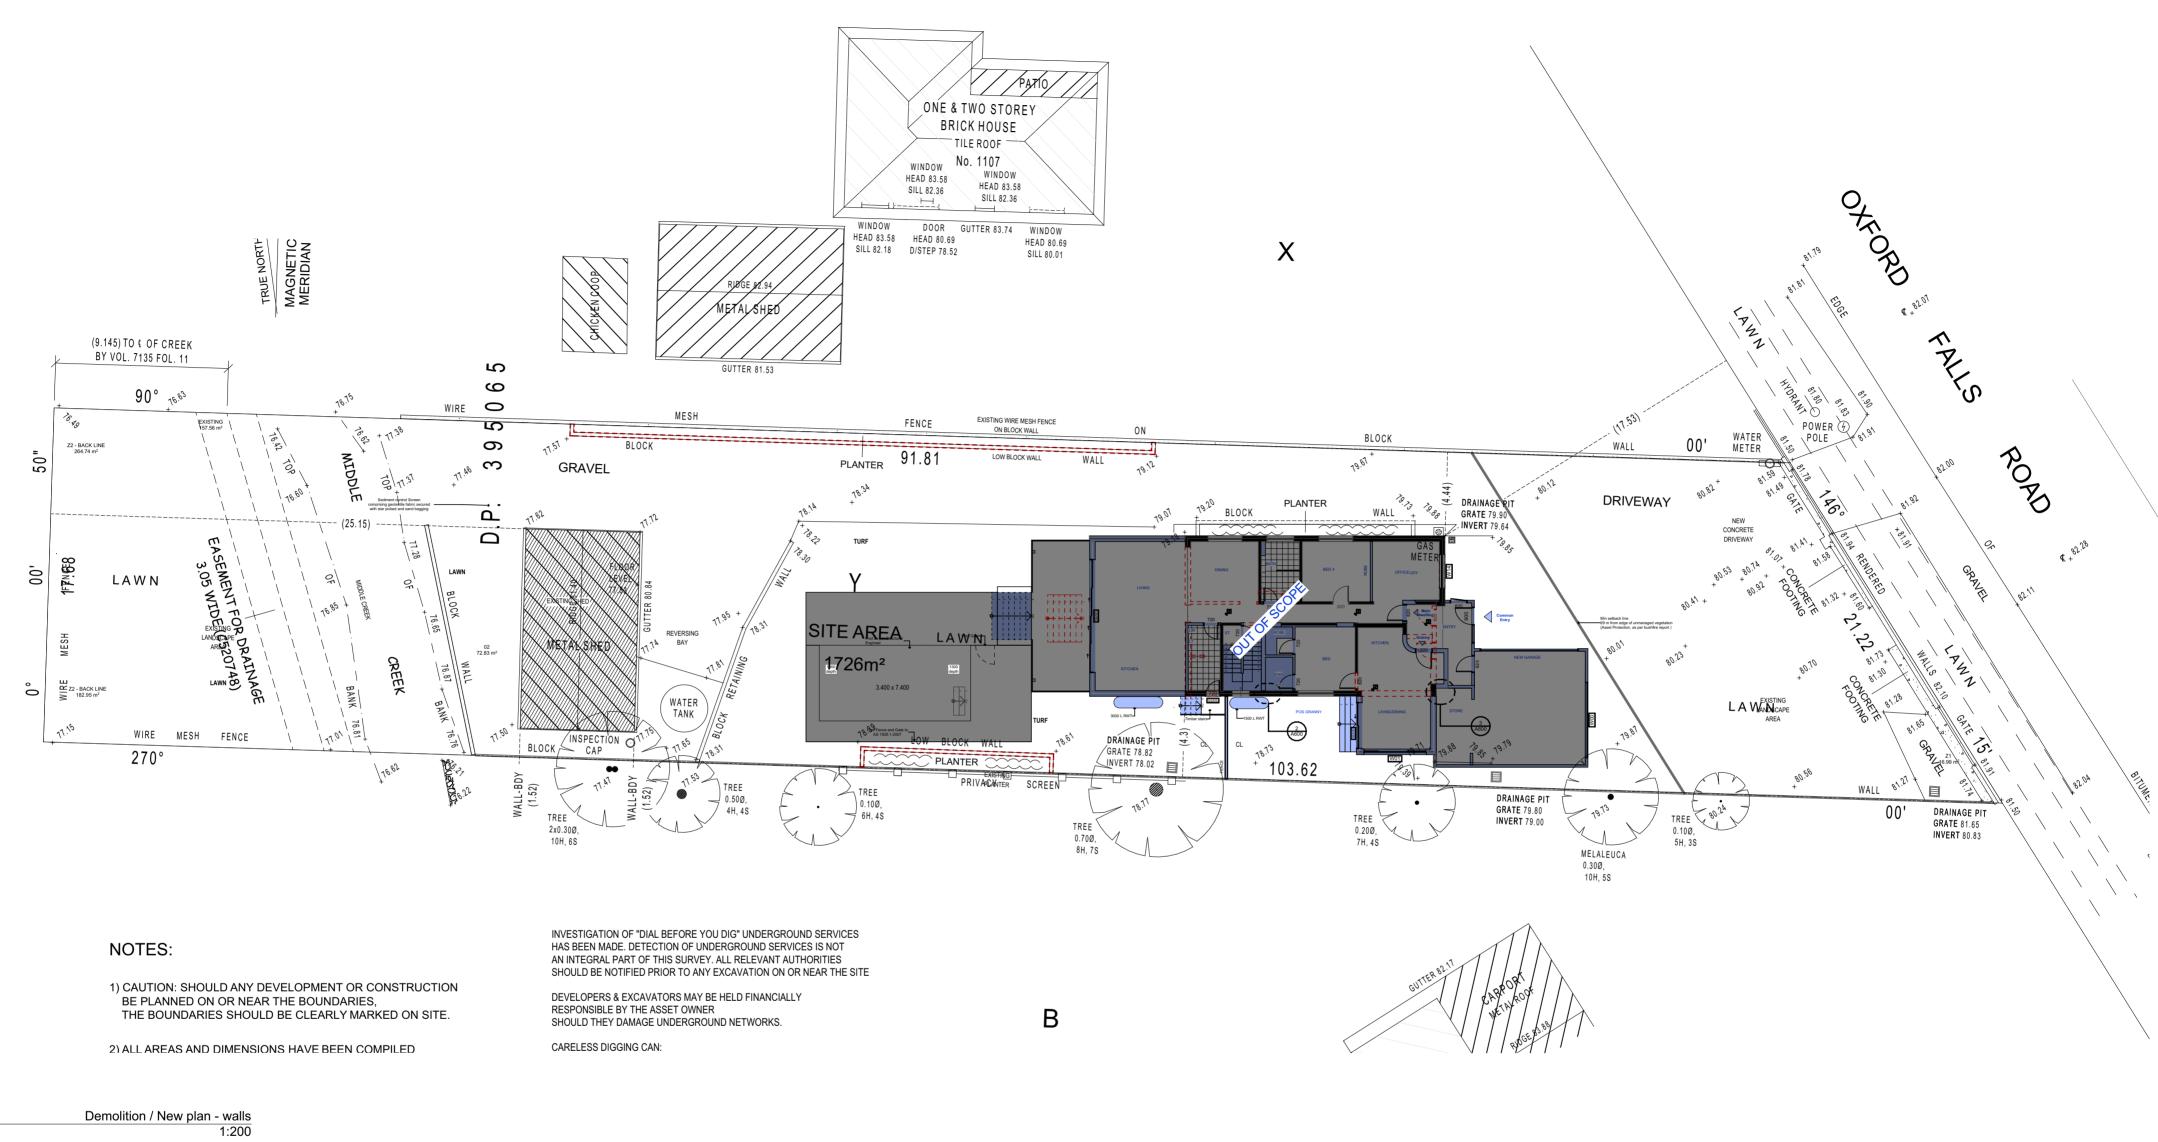

TO BE DEMOLISH

NEW

EXISTING

OTES

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LEGEND

SITE BOUNDARY SUBDIVISION LINE PROPOSED GROUND FLOOR OUTLINE

PROPOSED FIRST FLOOR OUTLINE

DEMOLITION PLAN - WALLS

1108 OXFORD FALLS RD

SCALE 1:200 NOT TO SCALE

A005

24/03/2025

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LEGEND & SCHEDULE

NOTES:

1. ALL FINAL PLANT QUANTITIES INDICATED ON PLANS SHALL BE CHECKED AND VERIFIED BY SUCCESSFUL LANDSCAPE CONTRACTOR.
2. ANY PLANT SUBSTITUTES REQUIRED DUE TO UNAVAILABILITY SHALL BE RECOMMENDED BY THE LANDSCAPE CONTRACTOR TO BEST MATCH SUBSTITUTED PLANTS

AND APPROVED PRIOR TO PURCHASING BY THE LANDSCAPE ARCHITECT.
3. WORKS CERTIFIED FOR FINAL OCCUPANCY CERTIFICATE ARE TO MATCH APPROVED LANDSCAPE PLANS.
4. LANDSCAPE CONTRACTOR SHALL LOCATE AND AVOID SITE STORM WATER & DRAINAGE SERVICES. LOCATE TREES A MINIMI IM 1.25M FROM PITS.

MINIMUM 1.25M FROM PITS

5. ALL PLANTING AROUND EXISTING TREES SHALL BE ADJUSTED TO AVOID DAMAGE AND CLASHING WITH SURFACE

2D	FOTO	KEY	DESCRIPTION	
		FL	Fiddle Leaf fig tree Ficus Lyrata Mature H : 3 m	
		WA	Westringia 'Aussie Box' Native box plant. Mature H x S: 0.9 x 0.6 m	
		AC	Alpina caerulea ' Red Back' Exotic Mature H x S: 2 x1.5 m Pot Size: 300 mm	
		MP	Myoporum parvifolium Creeping Boobialla Mature H x S: 1x1 m Pot Size: 300 mm	
East S		LM	Lirope Muscari ' Evergreen Giant ' Mature H : 75 cm Pot Size: 140 mm	











Lomandra longifolia Spiny Head Mat Rush Mature H x S: 2 x1.2 m Pot Size: 300 mm

Banksia Aemula Wallum Banksia Mature H x S: 2 x 2 m Pot Size: 300 mm

Existing trees to be retained and protected

2D	FOTO	KEY	DESCRIPTION
			Steel edging
		TA	Lawn - Turf area
		С	Concrete
		ST	Stepping stones with pebbles in gaps
		(EP)	Existing Stone Path
		TD	Timber Decking

CATEGORY	LOCATION	TYPE	M2
	RMEABLE TO WATER)		1412
LANDOCALE (I EI	Z1 - FRONT LINE	LAWN	27.58
	Z1 - FRONT LINE	LAWN	217.93
	Z2 - BACK LINE	LAWN	107.15
	Z2 - BACK LINE	LAWN	264.74
	Z2 - BACK LINE	TURF	15.40
	Z2 - BACK LINE	TURF	45.87
	Z2 - BACK LINE	TURF	198.47
	Z2 - BH BUILDING LINE	BANK	72.74
	Z2 - BH BUILDING LINE	PLANTER	14.72
			964.60 m²
LANDSCAPE OPE	N SPACE (IMPERMEABLE TO W.	ATER)	
	Z2 - BH BUILDING LINE	DECKING	24.54
			24.54 m²
LANDSCAPE BUIL	T (IMPERMEABLE TO WATER)		
	Z1	DECKING	16.99
	Z2 - BH BUILDING LINE	DECKING	28.35
	Z2 - BH BUILDING LINE	DECKING	28.79
			74.13 m²
LANDSCAPE BUIL	T (POOL)		
	Z2 - BH BUILDING LINE	POOL	25.16
			25.16 m²
			1,088.43 m²

NOTES

OTES

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LEGEND

SITE BOUNDARY SUBDIVISION LINE PROPOSED GROUND FLOOR OUTLINE PROPOSED FIRST FLOOR OUTLINE

LANDSCAPE PLAN

1108 OXFORD FALLS RD

SCALE 1:200, 1:1 NOT TO SCALE

A006


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REVIEWED BY ZK



15 PARRAMATTA ROAD, ANNANDALE NSW 2038, SYDNEY INFO@SHOREHOUSEPROJECTS.COM + 61 2 9557 0808 WWW.SHOREHOUSEPROJECTS.COM



THE BUILDING SHALL BE CONSTRUCTED TO THE FOLLOWING BAL STANDARDS IN ACCORDANCE WITH

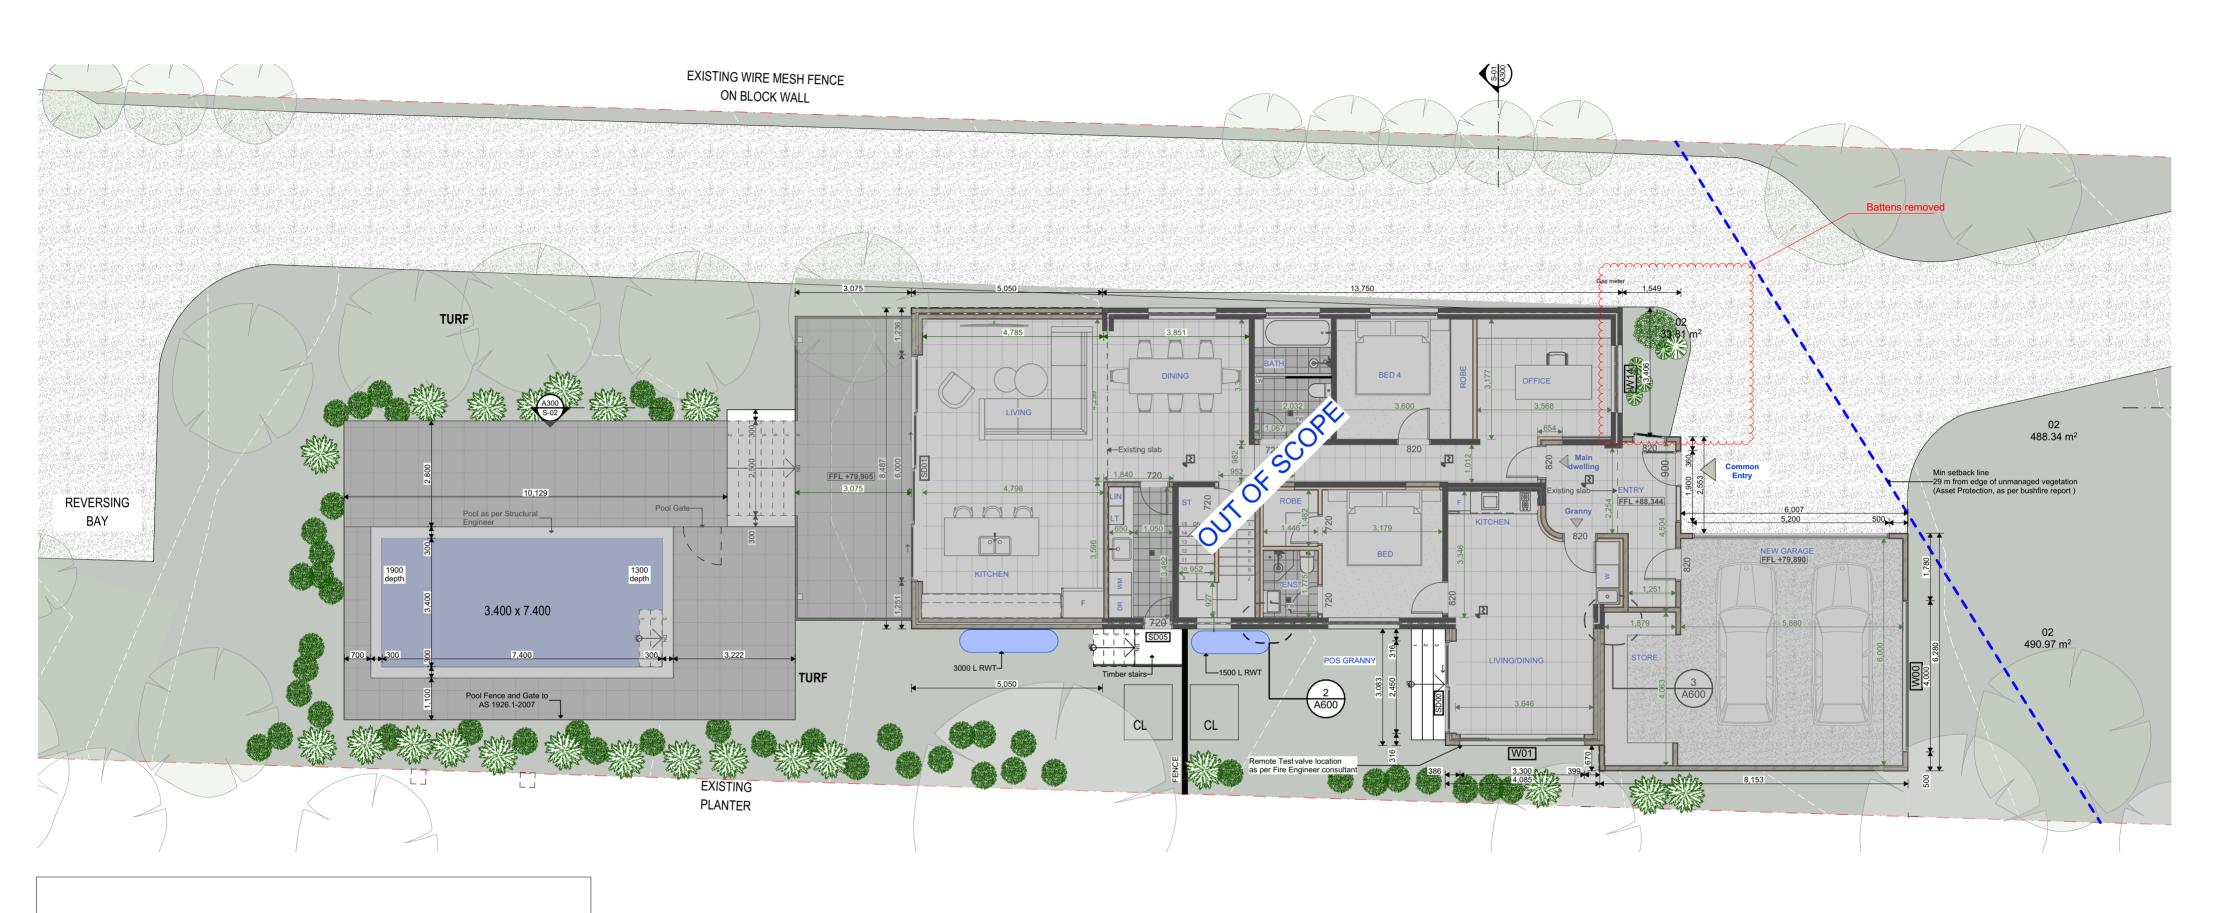EAST ELEVATION & GARAGE- BAL 29 REMAINING ELEVATIONS-WINDOWS & EXTERNAL DOORS

WINDOWS AND EXTERNAL DOORS SHALL BE ALUMINIUM. GLAZING SHALL BE MINIMUM 5MM. THICK TOUGHENED.

OPENABLE PORTIONS OF WINDOWS SHALL BE SCREENED INTERNALLY OR EXTERNALLY TO CONFORM WITH CL.3.6 AND CL.7.5.2 OF AS3959-2-18

WHERE GLAZING IS LESS THAN 400MM FROM THE GROUND OF FINISHED SURFACE, THE GLAZING SHALL BE SCREENED EXTERNALLY WITH A SCREEN THAT CONFORMS WITH CL.3.6

AND CL.7.5.2 OF AS3959-2-18

SCREENS SHALL COMPRISE METAL FRAME AND SHALL HAVE
A MESH OR PERFORATED SHEET MADE OF CORROSION
RESISTANT STEEL, BRONZE OF ALUMINIUM.

SLIDING DOORS
GLAZING SHALL BE MINIMUM 6MM. THICK TOUGHENED.
SCREENS- NO REQUIREMENT FOR SCREENS.

GARAGE DOORS- METAL CONSTRCUTION FITTED WITH WEATHER STRIPS, SEALS OR GUIDE TRACKS WITH A MAXIMUM GAP OF 3MM.

VENTS AND WEEP HOLES SHALL BE SCREENED WITH A MESH MADE OF CORROSION RESISTANT STEEL, BRONZE OR ALUMINIUM. MAX 3MM APERTURE

ROOFING TO BE COLORBOND STEEL LAID OVER FOIL SARKING. SARKING TO BE LAID OVER THR ROOFING BATTENS PENETRATIONS- TO BE ADEQUATELY SEALED WITH NON-COMBUSTIBLE SEALER, TO PREVENT GAPS GREATER THAN 3MM.

FASCIAS AND BARGEBOARDS- WHERE TIMBER TO BE MADE FROM BUSFFIRE-RESISTING TIMBER OR METAL

EAVES LINING- FIBRE CEMENT SHEET MINIMUM 4.5MM THICK. JOINTS TO BE SEALED WITH PLASTIC JOINING STRIPS OR TIMBER STORM MOULDS.

WATER & GAS SUPPLY PIPES
WHERE ABOVE GROUND- TO BE METAL

NOTES

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LEGEND

SITE BOUNDARY

SUBDIVISION LINE PROPOSED GROUND FLOOR OUTLINE

PROPOSED FIRST FLOOR OUTLINE

DRAWING TITLE

GROUND FLOOR

1108 OXFORD FALLS RD


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THE BUILDING SHALL BE CONSTRUCTED TO THE FOLLOWING BAL STANDARDS IN ACCORDANCE WITH

EAST ELEVATION & GARAGE- BAL 29 REMAINING ELEVATIONS-WINDOWS & EXTERNAL DOORS

WINDOWS AND EXTERNAL DOORS SHALL BE ALUMINIUM. GLAZING SHALL BE MINIMUM 5MM. THICK TOUGHENED.

OPENABLE PORTIONS OF WINDOWS SHALL BE SCREENED INTERNALLY OR EXTERNALLY TO CONFORM WITH CL.3.6 AND CL.7.5.2 OF AS3959-2-18

WHERE GLAZING IS LESS THAN 400MM FROM THE GROUND OF FINISHED SURFACE, THE GLAZING SHALL BE SCREENED EXTERNALLY WITH A SCREEN THAT CONFORMS WITH CL.3.6

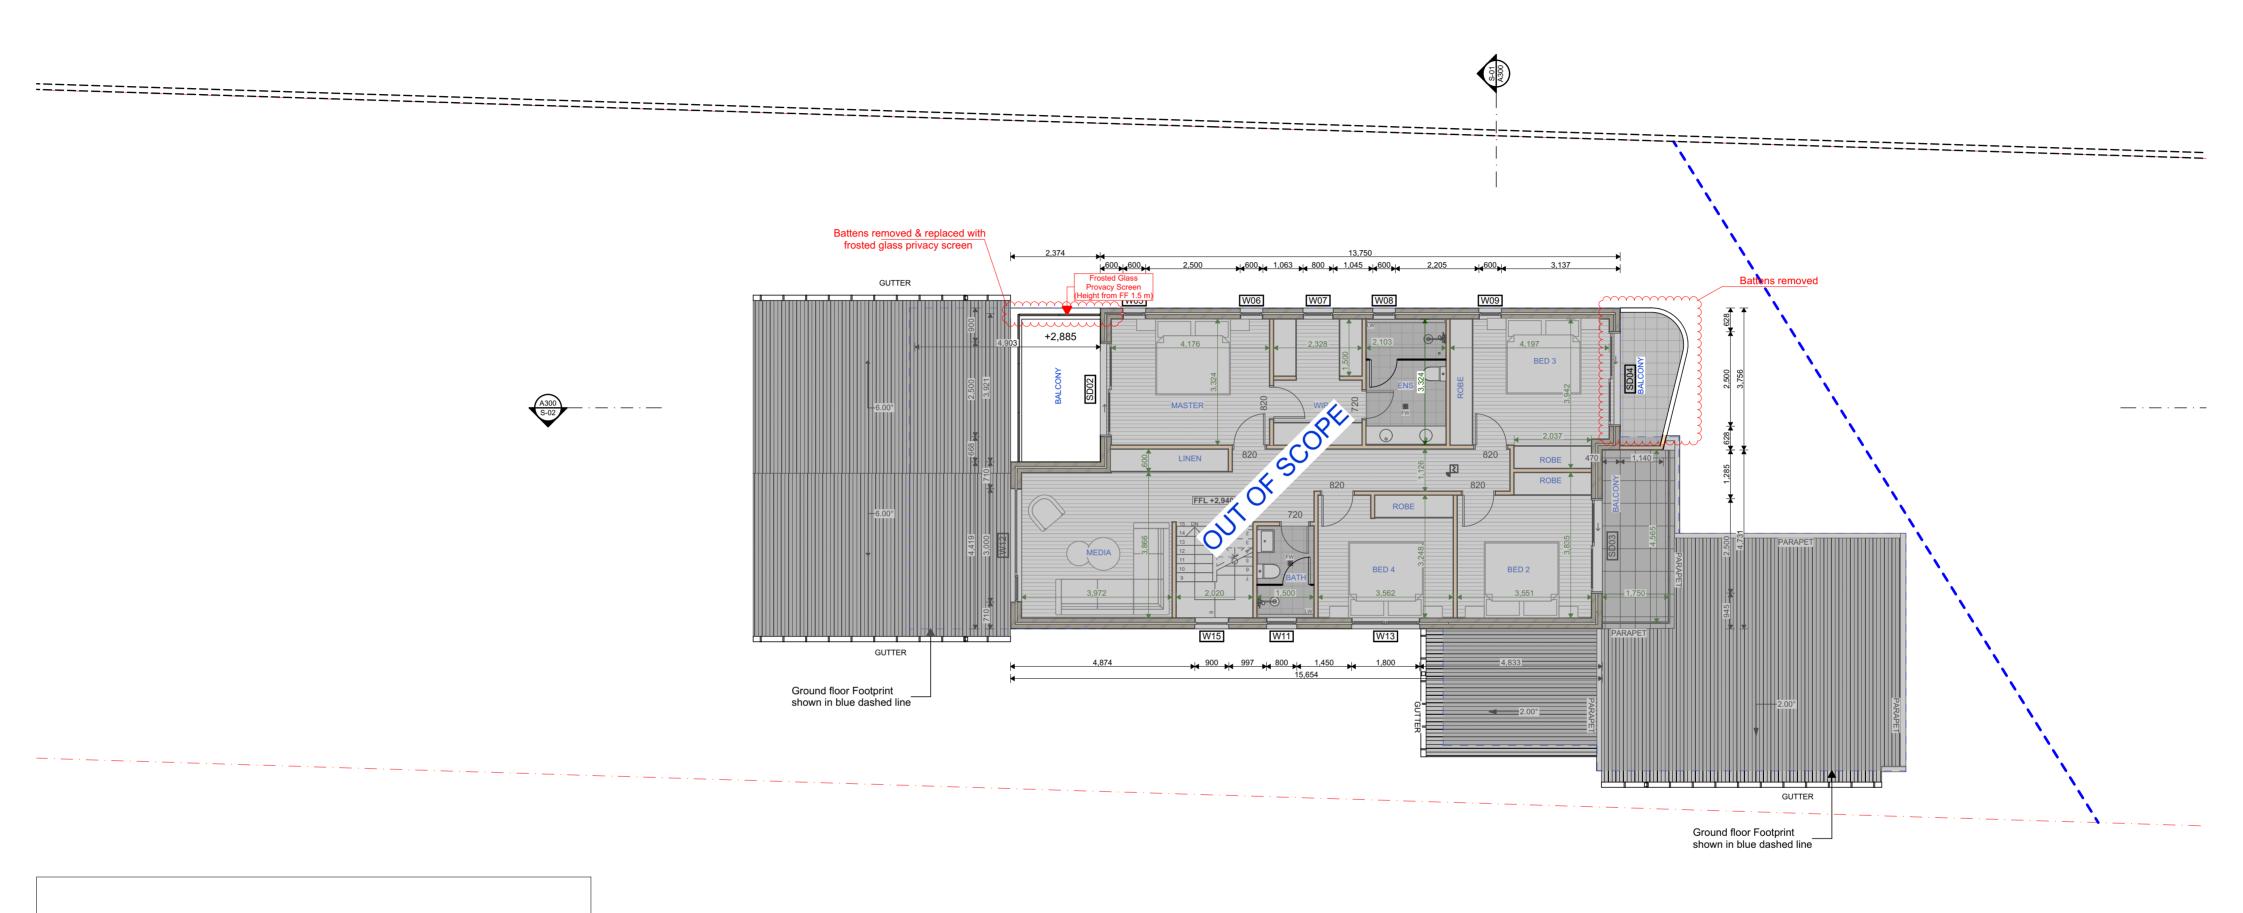AND CL.7.5.2 OF AS3959-2-18

SCREENS SHALL COMPRISE METAL FRAME AND SHALL HAVE
A MESH OR PERFORATED SHEET MADE OF CORROSION
RESISTANT STEEL, BRONZE OF ALUMINIUM.

SLIDING DOORS
GLAZING SHALL BE MINIMUM 6MM. THICK TOUGHENED.
SCREENS- NO REQUIREMENT FOR SCREENS. GARAGE DOORS- METAL CONSTRCUTION FITTED WITH WEATHER STRIPS, SEALS OR GUIDE TRACKS WITH A MAXIMUM GAP OF 3MM.

VENTS AND WEEP HOLES SHALL BE SCREENED WITH A MESH MADE OF CORROSION RESISTANT STEEL, BRONZE OR ALUMINIUM. MAX 3MM APERTURE

ROOFING TO BE COLORBOND STEEL LAID OVER FOIL SARKING. SARKING TO BE LAID OVER THR ROOFING BATTENS PENETRATIONS- TO BE ADEQUATELY SEALED WITH NON-COMBUSTIBLE SEALER, TO PREVENT GAPS GREATER THAN 3MM.

FASCIAS AND BARGEBOARDS- WHERE TIMBER TO BE MADE FROM BUSFFIRE-RESISTING TIMBER OR METAL

EAVES LINING- FIBRE CEMENT SHEET MINIMUM 4.5MM THICK. JOINTS TO BE SEALED WITH PLASTIC JOINING STRIPS OR TIMBER STORM MOULDS.

WATER & GAS SUPPLY PIPES
WHERE ABOVE GROUND- TO BE METAL

OUTES

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LEGEND

SUBDIVISION LINE

SITE BOUNDARY

PROPOSED GROUND FLOOR OUTLINE PROPOSED FIRST FLOOR OUTLINE

DRAWING TITLE FIRST FLOOR

1108 OXFORD FALLS RD

SCALE 1:100, 1:196.96 NOT TO SCALE

A101


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GENERAL NOTES

ROOF GUTTER TO BE FITED WITH A NON- COMBUSTIBLE DEVICE AS PER BUSHFIRE REPORT

BUSHFIRE CONSTRUCTION

THE BUILDING SHALL BE CONSTRUCTED TO THE FOLLOWING BAL STANDARDS IN ACCORDANCE WITH

EAST ELEVATION & GARAGE- BAL 29 REMAINING ELEVATIONS-WINDOWS & EXTERNAL DOORS

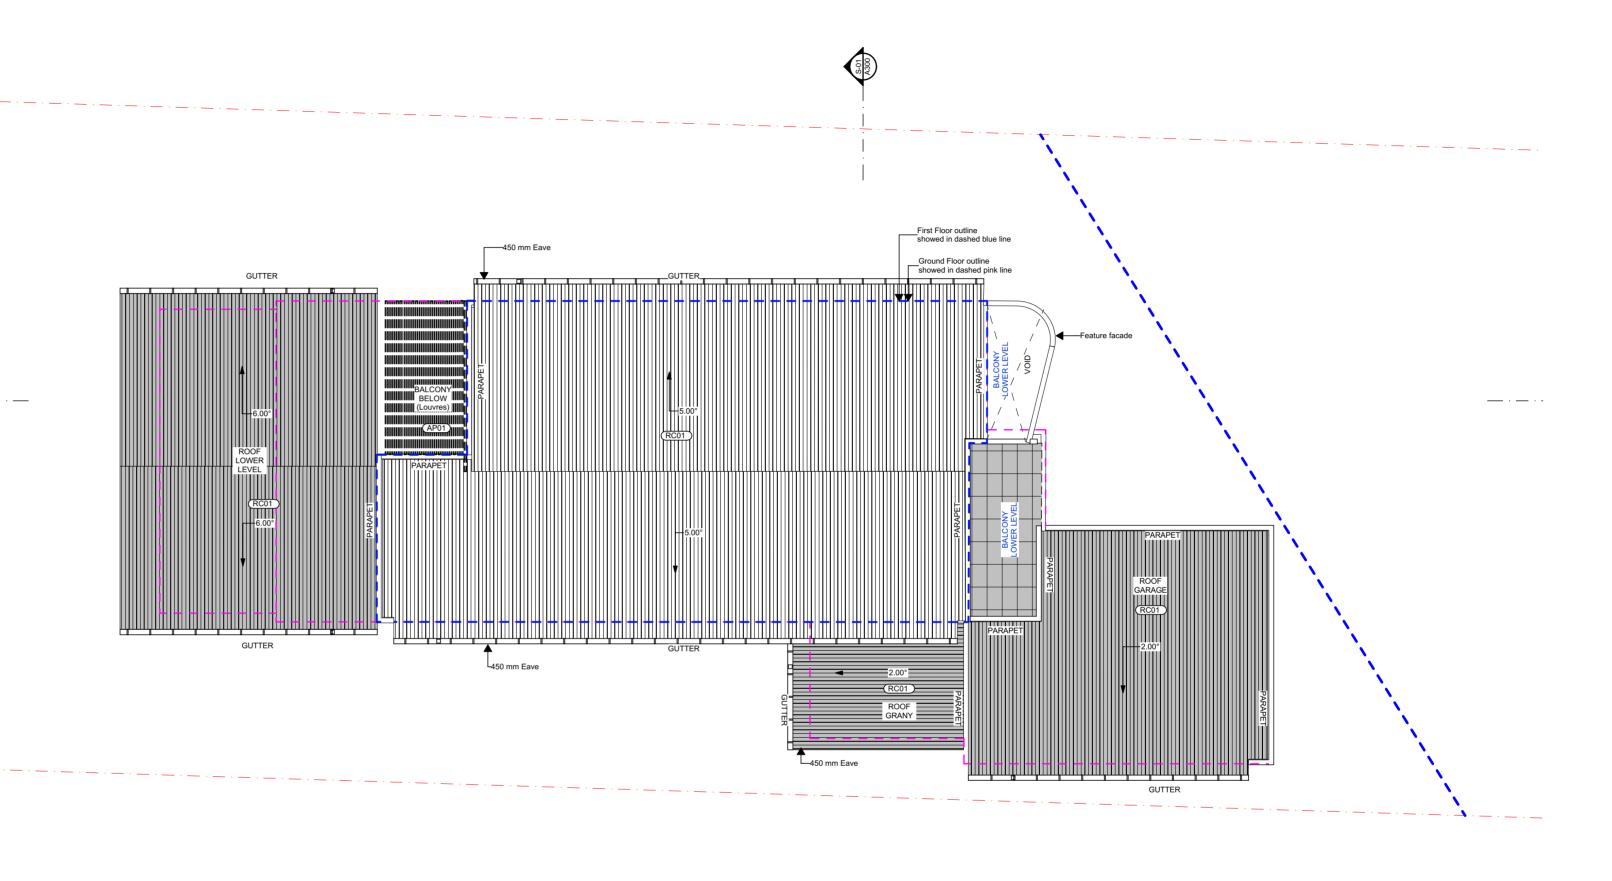WINDOWS AND EXTERNAL DOORS SHALL BE ALUMINIUM. GLAZING SHALL BE MINIMUM 5MM. THICK TOUGHENED.

OPENABLE PORTIONS OF WINDOWS SHALL BE SCREENED INTERNALLY OR EXTERNALLY TO CONFORM WITH CL.3.6 AND CL.7.5.2 OF AS3959-2-18

WHERE GLAZING IS LESS THAN 400MM FROM THE GROUND OF FINISHED SURFACE, THE GLAZING SHALL BE SCREENED EXTERNALLY WITH A SCREEN THAT CONFORMS WITH CL.3.6

AND CL.7.5.2 OF AS3959-2-18

SCREENS SHALL COMPRISE METAL FRAME AND SHALL HAVE
A MESH OR PERFORATED SHEET MADE OF CORROSION
RESISTANT STEEL, BRONZE OF ALUMINIUM.

SLIDING DOORS
GLAZING SHALL BE MINIMUM 6MM. THICK TOUGHENED.
SCREENS- NO REQUIREMENT FOR SCREENS.

GARAGE DOORS- METAL CONSTRCUTION FITTED WITH WEATHER STRIPS, SEALS OR GUIDE TRACKS WITH A MAXIMUM GAP OF 3MM.

VENTS AND WEEP HOLES SHALL BE SCREENED WITH A MESH MADE OF CORROSION RESISTANT STEEL, BRONZE OR ALUMINIUM. MAX 3MM APERTURE

ROOFING TO BE COLORBOND STEEL LAID OVER FOIL SARKING. SARKING TO BE LAID OVER THR ROOFING BATTENS PENETRATIONS- TO BE ADEQUATELY SEALED WITH NON-COMBUSTIBLE SEALER, TO PREVENT GAPS GREATER THAN 3MM.

FASCIAS AND BARGEBOARDS- WHERE TIMBER TO BE MADE FROM BUSFFIRE-RESISTING TIMBER OR METAL

EAVES LINING- FIBRE CEMENT SHEET MINIMUM 4.5MM THICK. JOINTS TO BE SEALED WITH PLASTIC JOINING STRIPS OR TIMBER STORM MOULDS.

WATER & GAS SUPPLY PIPES
WHERE ABOVE GROUND- TO BE METAL

OUTES

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LEGEND

SUBDIVISION LINE

SITE BOUNDARY

PROPOSED GROUND FLOOR OUTLINE PROPOSED FIRST FLOOR OUTLINE

DRAWING TITLE

ROOF PLAN

1108 OXFORD FALLS RD

SCALE 1:100, 1:196.96 NOT TO SCALE

ISSUE A102

24/03/2025


DRAWN BY MD


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ZK



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PV01

Outdoor paving

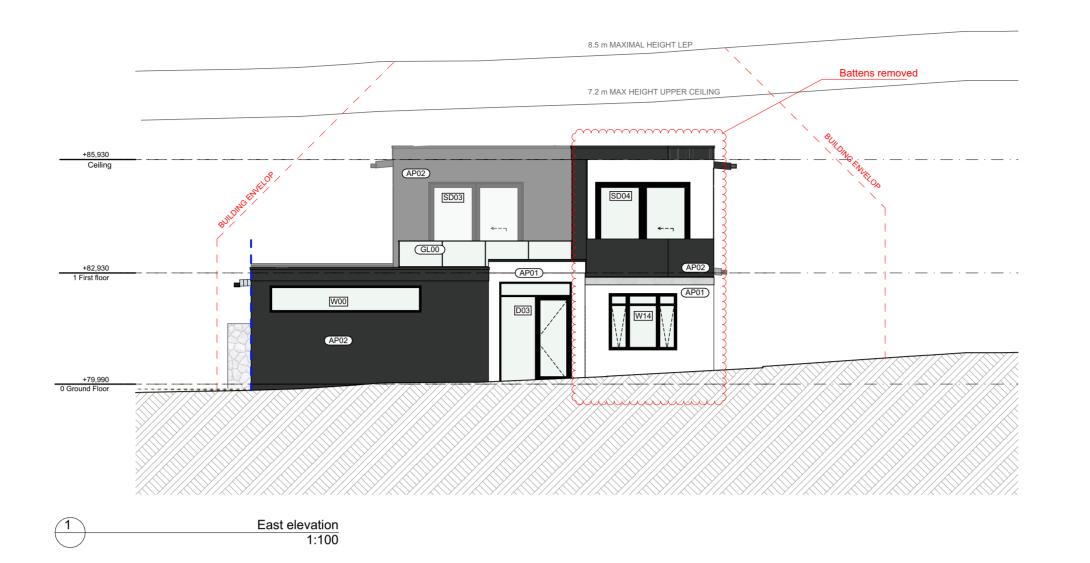Grigio colour *

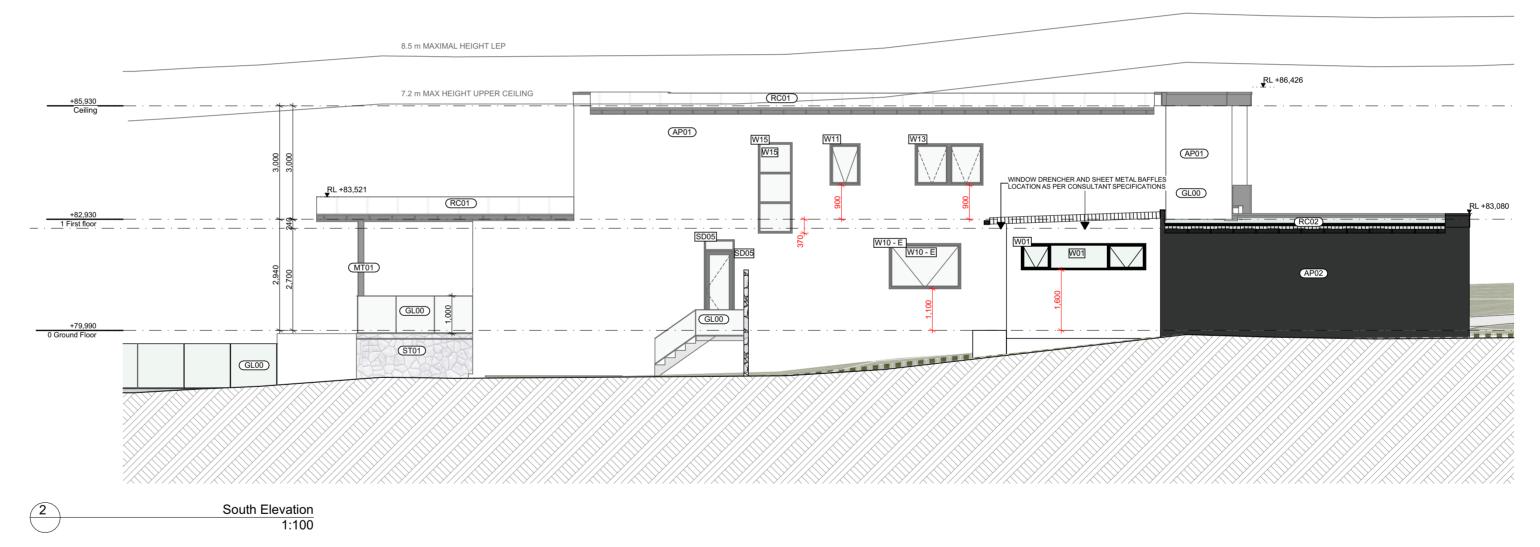TB01

Spotted Gum Timber

decking - Outdoor*

TL01 Outdoor porcelain tile Cream colour *

(AP01) Applied Render Paint Surfmist Colour*

(AP02) Render Basalt Colour* (GL01) Glass framed Balustrade

Clear colour

MT01 Facade slat Podwer coater - Metal


Frames and screens Light grey colour Dulux - Whisper White* Colorbond Basalt*

(W/D F01) (RC01) Window and Door Metal roofing

ST01





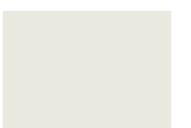















Crazy stone cladding

Outdoor walls

OUTES

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PROPOSED FIRST FLOOR OUTLINE

LEGEND

SITE BOUNDARY SUBDIVISION LINE PROPOSED GROUND FLOOR OUTLINE **EAST AND SOUTH ELEVATION**

1108 OXFORD FALLS RD

SCALE 1:100 NOT TO SCALE

A200


24/03/2025


DRAWN BY MD

REVIEWED BY

ZK



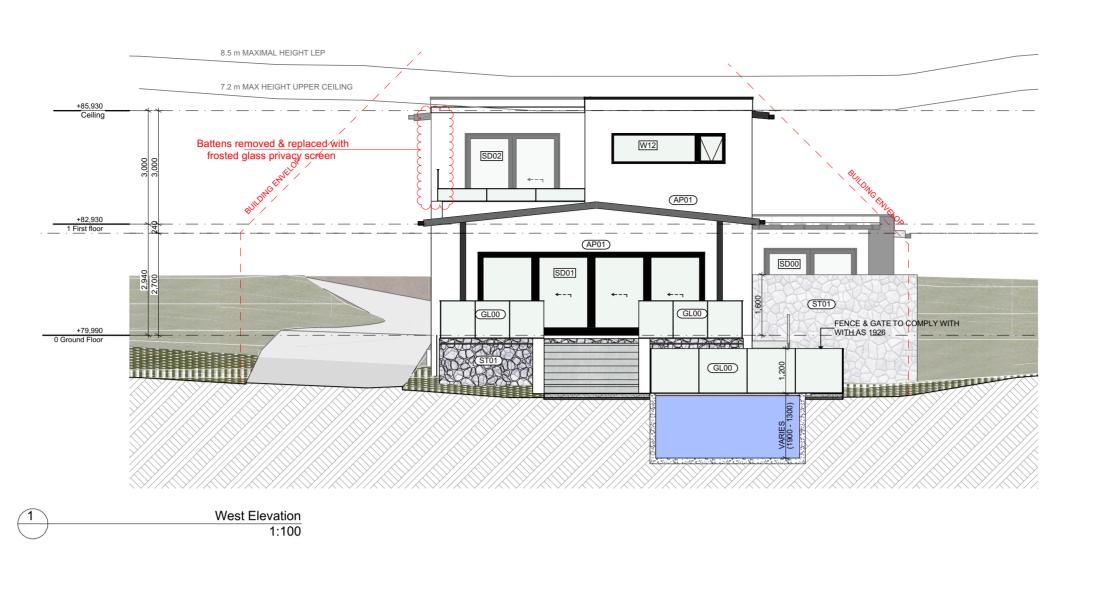

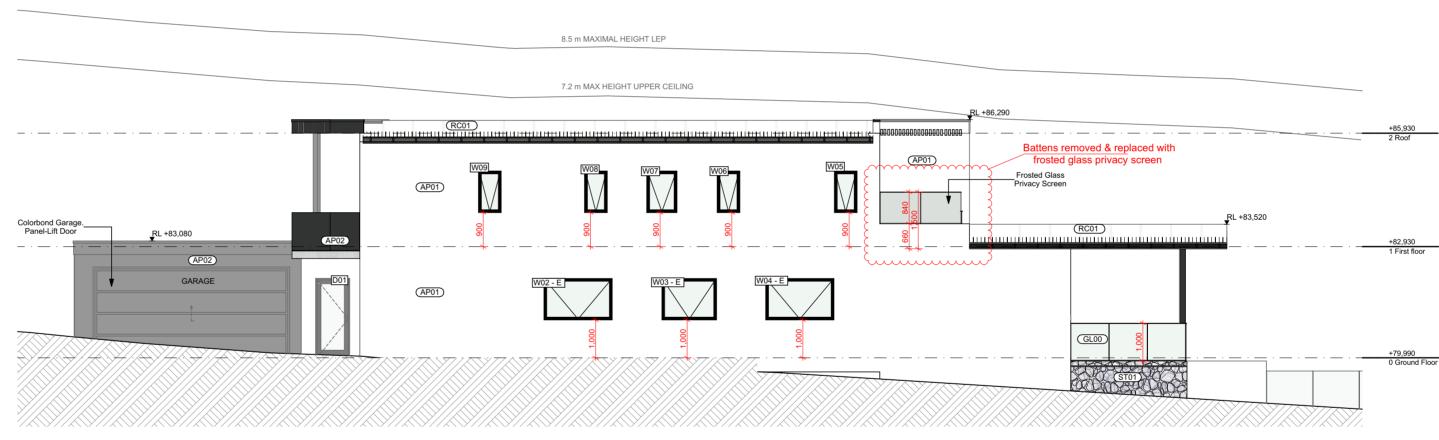

North elevation 1:100

PV01

Outdoor paving

Grigio colour *

(TB01)

Spotted Gum Timber decking - Outdoor*

TL01

Cream colour *

Outdoor porcelain tile

(AP01) **Applied Render Paint** Surfmist Colour*

(AP02)

Basalt Colour*

Render

(GL01) Clear colour

Glass framed Balustrade

MT01 Facade slat

Podwer coater - Metal Dulux - Whisper White*

(W/D F01) RC01

Window and Door Metal roofing

Frames and screens Light grey colour


ST01

Crazy stone cladding Outdoor walls







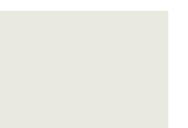











Colorbond Basalt*





OUTES

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LEGEND

SITE BOUNDARY SUBDIVISION LINE PROPOSED GROUND FLOOR OUTLINE

PROPOSED FIRST FLOOR OUTLINE

NORTH AND WEST ELEVATION

1108 OXFORD FALLS RD

SCALE 1:100 NOT TO SCALE

A201

24/03/2025

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OUTES

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LEGEND

SITE BOUNDARY

SUBDIVISION LINE PROPOSED GROUND FLOOR OUTLINE PROPOSED FIRST FLOOR OUTLINE

DRAWING TITLE **SECTIONS**

1108 OXFORD FALLS RD

SCALE 1:100 NOT TO SCALE

A300


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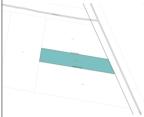
ZK

SHOREHOUSE 15 PARRAMATTA ROAD, ANNANDALE NSW 2038, SYDNEY INFO@SHOREHOUSEPROJECTS.COM + 61 2 9557 0808 WWW.SHOREHOUSEPROJECTS.COM





PLOT INFORMATION **ADDRESS** 1108 OXFORD FALLS RD Frenchs Forest NSW 2086 Y/-/DP395065 LOT / SECTION / PLAN No LOT AREA 1726 m² MAXIMAL HEIGHT LEP 8.5 m NORTHERN BEACHES COUNCIL COUNCIL REGULATION WARRINGAH DCP MANLY DCP - PART 4 - 4.1 RESIDENTIAL DC WARRINGAH LEP 2011 ADDITION AND MODIFICATION PORPOSED TO EXISTING DA APPROVED TOTAL GFA APPROVED DA2017/0386 FSR 0.15:1 261.1 M2 TOTAL LANDCASPE APPROVED 56 % 965.5 M2

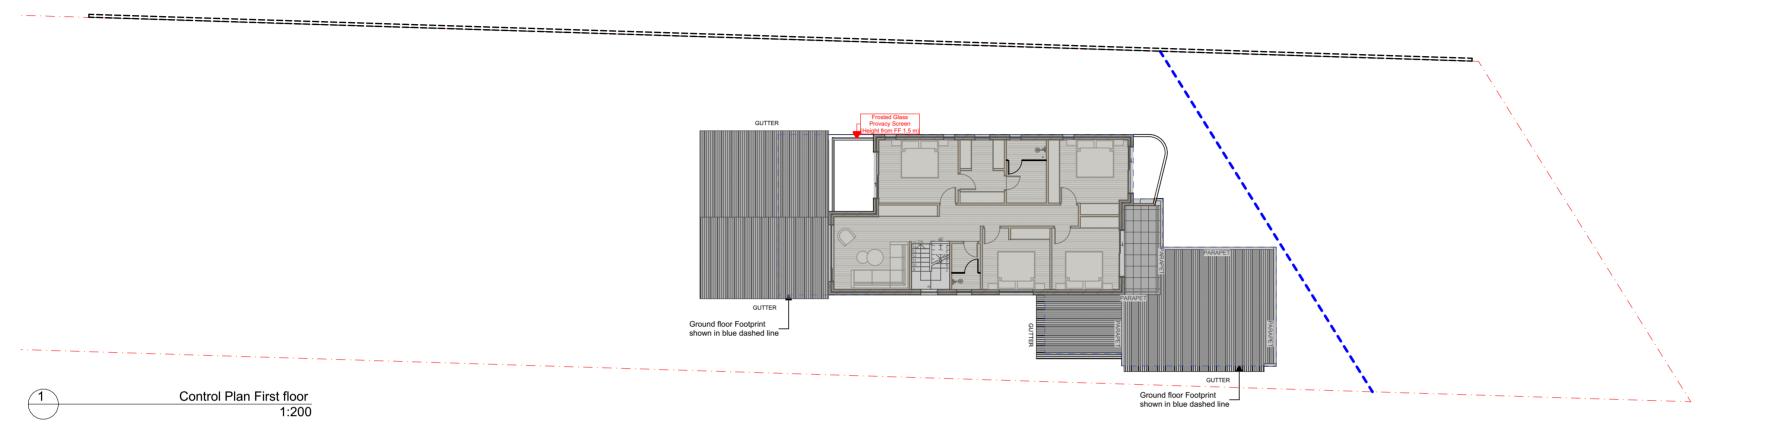



102.89 m²

GFA NEW		
ZONE	STOREY	AREA
Granny		
	Ground Floor	43.83
Main Dwelling		
	Ground Floor	119.13
	First floor	106.98
		269.94 m²

NEW PROPOSED FSR	0.15:1
PREVIOUS APPROVED FSR	0.15:1

Control Plan GF 1:200

OTES

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LEGEND

SITE BOUNDARY

SUBDIVISION LINE

PROPOSED GROUND FLOOR OUTLINE

PROPOSED FIRST FLOOR OUTLINE

CONTROL PLAN

1108 OXFORD FALLS RD

SCALE 1:200 NOT TO SCALE

A400

24/03/2025

DRAWN BY REVIEWED BY ZK

SHOREHOUSE

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Window Schedule							
Home Story Name	Ground Floor						
Renovation Status	Existing	Existing	Existing	Existing	New	New	New
ID	W02 - E	W03 - E	W04 - E	W10 - E	D01	D03	SD00
W x H Size	1,810×1,100	1,450×1,100	1,810×1,100	1,900×1,200	900×2,100	1,900×2,700	2,450×2,300
Sill Height	1,000	1,000	1,000	1,100	0	0	0
Head Height	2,100	2,100	2,100	2,300	2,100	2,700	2,300
Plan Preview		<u></u>			820	900	$\overset{\longrightarrow}{\rightarrow}$
3D Back View	1,810	1,450	1,810	1,900	2 100	1,900	2.450

Window Schedule									
Home Story Name						First floor			
Renovation Status	New	New	New	New	New	New	New	New	New
ID	SD01	SD05	W00	W01	W14	SD02	SD03	SD04	W05
W x H Size	6,000×2,200	800×2,400	4,000×700	3,300×700	1,800×1,500	2,500×2,400	2,500×2,400	2,500×2,400	600×1,100
Sill Height	0	0	1,900	1,600	900	0	0	0	900
Head Height	2,200	2,400	2,600	2,300	2,400	2,400	2,400	2,400	2,000
Plan Preview		720			(├	←	←	
3D Back View	*	800	4.000	3,300	1,800	←-¬	← - ¬	₹ 2.599	* 600 * 1100



THE BUILDING SHALL BE CONSTRUCTED TO THE FOLLOWING BAL STANDARDS IN ACCORDANCE WITH AS3959-2018

EAST ELEVATION & GARAGE- BAL 29 REMAINING ELEVATIONS- BAL 19

WINDOWS & EXTERNAL DOORS

WINDOWS AND EXTERNAL DOORS SHALL BE ALUMINIUM. GLAZING SHALL BE MINIMUM 5MM. THICK TOUGHENED.

WINDOWS

OPENABLE PORTIONS OF WINDOWS SHALL BE SCREENED INTERNALLY OR EXTERNALLY TO CONFORM WITH CL.3.6 AND CL.7.5.2 OF AS3959-2-18

WHERE GLAZING IS LESS THAN 400MM FROM THE GROUND OF FINISHED SURFACE, THE GLAZING SHALL BE SCREENED EXTERNALLY WITH A SCREEN THAT CONFORMS WITH CL.3.6 AND CL.7.5.2 OF AS3959-2-18

SCREENS SHALL COMPRISE METAL FRAME AND SHALL HAVE A MESH OR PERFORATED SHEET MADE OF CORROSION RESISTANT STEEL, BRONZE OF ALUMINIUM.

SLIDING DOORS
GLAZING SHALL BE MINIMUM 6MM. THICK TOUGHENED.
SCREENS- NO REQUIREMENT FOR SCREENS.

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LEGEND SITE BOUNDARY SUBDIVISION LINE PROPOSED GROUND FLOOR OUTLINE

PROPOSED FIRST FLOOR OUTLINE

WINDOW SCHEDULE

1108 OXFORD FALLS RD

SCALE 1:196.96 NOT TO SCALE

A500


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ZK





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OUTES

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LEGEND SITE BOUNDARY SUBDIVISION LINE PROPOSED GROUND FLOOR OUTLINE PROPOSED FIRST FLOOR OUTLINE

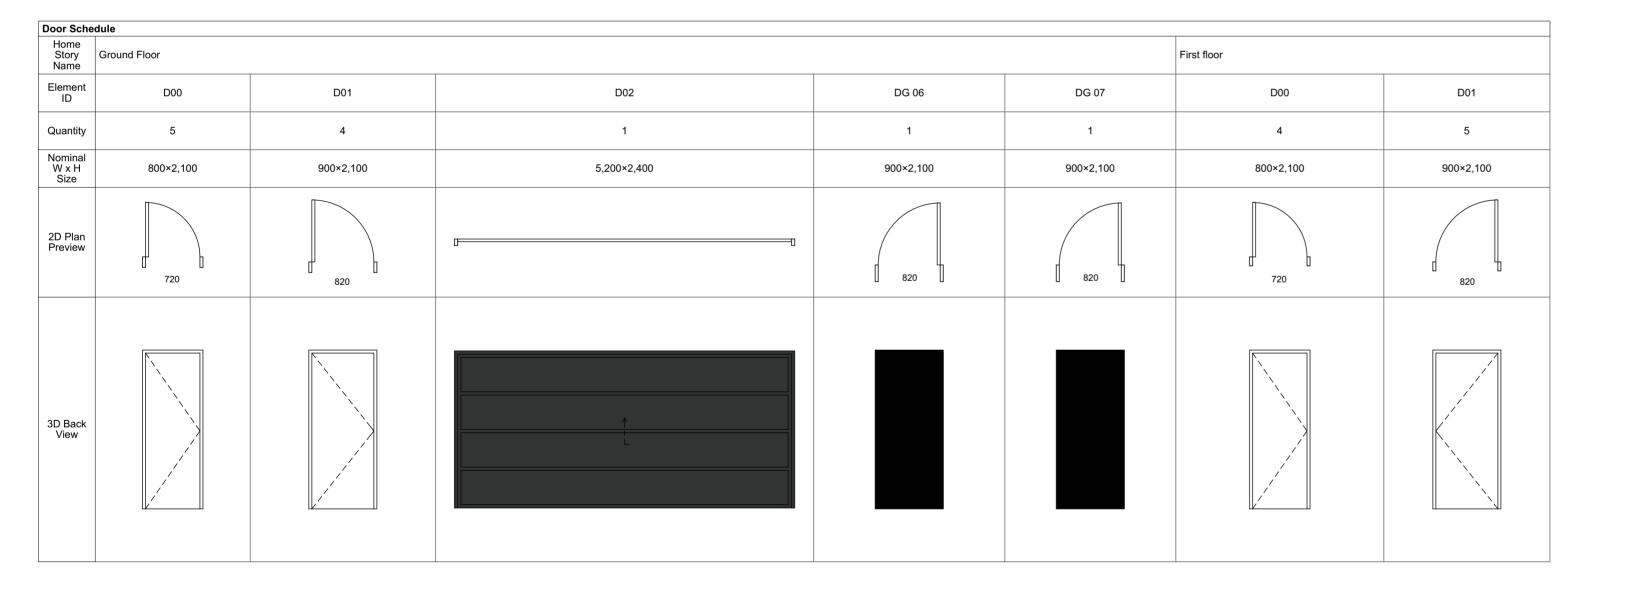DRAWING TITLE **DOOR SCHEDULE**

1108 OXFORD FALLS RD

SCALE 1:1 NOT TO SCALE

A501

24/03/2025

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REVIEWED BY

ZK



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