# STORMWATER MANAGEMENT PLAN PROPOSED DUAL OCCUPANCY No.2 BARDOO AVENUE, NORTH BALGOWLAH

## **GENERAL NOTES:**

- THESE PLANS REMAIN THE PROPERTY OF NY CIVIL ENGINEERING PTY LTD AND ARE SUBJECT TO COPYRIGHT
- ALL DIMENSIONS IN MILLIMETERS UNLESS OTHERWISE STATED. ALL REDUCED LEVELS (SURFACE LEVELS, INVERT LEVELS) AND CHAINAGES ARE IN METERS UNLESS OTHERWISE STATED. DO NOT SCALE OFF THE DRAWINGS, SCALES ARE AS SHOWN, USE FIGURED DIMENSIONS
- THIS PLAN IS TO BE READ IN JUNCTION WITH LATEST ARCHITECTURAL STRUCTURAL LITHLITY AND LANDSCAPE PLANS IN ADDITION TO ANY QUOTED ON THIS PLAN.
- ALL WORKS SHALL BE CARRIED OUT TO LOCAL COUNCIL'S DEVELOPMENT CONTROL PLAN AND SPECIFICATIONS, ASINZS 3500.3 AND B.C.A.
- ALL LEVELS SHALL RELATE TO THE ESTABLISHED BM. PM AND/OR LM. ALL EXISTING SERVICES ARE TO BE VERIFIED FOR LOCATION AND DEPTH PRIOR TO COMMENCEMENT OF ANY WORK. CONTRACTOR TO NOTIFY DESIGNER OF ANY DISCREPANCIES OF SERVICE LEVELS QUOTED ON THIS PLAN. ALL SURVEY INFORMATION, BUILDING AND FINISHED SURFACE LEVELS SHOWN IN THESE DRAWINGS ARE BASED ON LEVELS OBTAINED
- IT IS THE RESPONSIBILITY OF THE CONTRACTOR TO ORTAIN ANY PRIOR APPROVAL REQUIRED FROM COLINCIL WITH RESPECT TO POTENTIAL IMPACT ON TREES FOR ANY WORKS SHOWN ON THIS DRAWING PRIOR TO THE COMMENCEMENT OF WORKS. NO TREES SHALL BE REMOVED WITHOUT THE WRITTEN PERMISSION OF COUNCIL
- THE CONTRACTOR SHALL TAKE ALL DUE CARE TO USE THE ABSOLUTE MINIMUM AREA FOR CONSTRUCTION AND THAT NO UNDUE DAMAGE IS
- THE CONTRACTOR SHALL COMPLY WITH CONDITIONS, AND SPECIFICATION OF COUNCIL AND ALL ACTS OF THE NSW EPA.
- THE CONTRACTOR SHALL TAKE ALL REASONABLE CARE TO PROTECT EXISTING SERVICES. DAMAGED SERVICES SHALL BE REPAIRED AT THE
- ALL NEW WORK IS TO MAKE A SMOOTH JUNCTION WITH EXISTING WORK
- SUITABLE WARNING SIGNS AND BARRICADES ARE TO BE PROVIDED IN ACCORDANCE WITH THE AUSTRALIAN STANDARDS AND AS DIRECTED BY
- SERVICES SHOWN ARE INDICATIVE ONLY FROM AVAILABLE INFORMATION AND THE TIME OF SITE INVESTIGATION (IF ANY). THE BUILDER IS TO
- RESTORE ALL TRAFFIC AREAS TO PRE EXISTING CONDITION. FOR ALL SURFACES OTHER THAN IN TRAFFIC AREAS RESTORE DISTURBED SURFACES TO PRE-EXISTING CONDITION AND COMPACT AS SPECIFIED.
- RESTORE ALL AUTHORITY OWNED AREAS TO COUNCIL AND/OR AUTHORITY STANDARD AND SPECIFICATION.
- THE WORK AS CONSTRUCTED WORKS SHALL BE INSPECTED BY THE ENGINEER, MINIMUM 48 HOURS NOTICE SHALL BE PROVIDED FOR ALL
- THE DESIGN PLANS HEREIN ARE SUBJECT TO COUNCIL APPROVAL PRIOR TO CONSTRUCTION.
- WORK AS CONSTRUCTED DRAWINGS TO BE REQUESTED AND RECEIVED IN CAD/DWG FILE TYPE AND HARD COPY 'RED LINE' MARKUP FROM

# **ROOF STORMWATER DRAINAGE NOTES:**

- ALL DOWN PIPES TO BE MINIMUM DN90 OR 100x50mm FOR GUTTERS SLOPE 1:500 AND STEEPER AS PER AS 3500.3 3.7.8
- 2. ALL ROOF GUTTERS TO HAVE OVERFLOW PROVISION IN ACCORDANCE WITH AS 3500.3 AND SECTIONS 3.5.3, 3.7.5 AND APPENDIX G OF AS 3500.3.
- ALL DOWNPIPES TO BE FITTED VERTICALLY TO THE SOLE OF EAVES GUTTERS, RAINHEAD AND/OR SUMP.
- ALL DOWNPIPES TO DRAIN INTO RAINWATER TANK AND OR PIT PRIOR TO DISCHARGE OFFSITE UNLESS PRIOR APPROVAL IS OBTAINED FROM
- ALL EAVES GUTTERS TO BE SIZED FOR ARI 20 AS PER AS 3500.3 3.5 AND APPENDIX H.
- ROOF DRAINAGE INSTALLATION TO BE IN ACCORDANCE TO AS 3500.3 SECTION 4.
- 7. INTERNAL DOWNPIPES TO BE PROVIDED WITH ACOUSTIC LAGGING TO MANUFACTURERS SPECIFICATIONS

## STORMWATER DRAINAGE NOTES:

### PIPE SIZE:

- 1. THE MINIMUM PIPE SIZE SHALL BE:
- DN90 FOR ALL DOWNPIPES:
- DN100 WHERE THE LINE ONLY RECEIVES ROOF STORMWATER RUNOFF, OR
- DN100 WHERE THE LINE RECEIVES RUNOFF FROM PAVED OR UNPAVED AREAS.

### PIPE GRADE:

- THE MINIMUM PIPE GRADE SHALL BE:
- FOR DN100 DN150 1.00%
- FOR DN225 0.50% FOR DN300 - 0.45%

### STANDARD COVER:

- MINIMUM PIPE COVER FOR PVC PIPES SHALL BE AS PER AS 3500.3 TABLE 6.2.5:
- NOT SUBJECT TO VEHICULAR LOADING:
- WITHOUT PAVEMENT SINGLE DWELLINGS 100mm
- WITHOUT PAVEMENT OTHER THAN SINGLE DWELLINGS 300mm
- WITH PAVEMENT (BRICK/PAVERS) AND/OR UNREINFORCED CONCRETE 100mm
- SUBJECT TO VEHICULAR LOADING:
- ROADS (LINSEALED) 750mm
- OTHER THAN ROADS (WITH PAVEMENT) 100mm OTHER THAN ROADS (WITHOUT PAVEMENT) - 450mm

### PIPES AND FITTINGS FOR STORMWATER DRAINAGE SHALL BE AS FOLLOWS:

- FOR PIPE SIZES UP TO DN225 PVC WITH SOLVENT WELDED JOINTS (IN GROUND).
- FOR PIPE SIZES GREATER THAN DN225 RCP WITH RUBBER RING JOINTS.
- FOR LARGER PIPE DEPTHS AS SPECIFIED IN AS 3500.3 RCP WITH RUBBER RING JOINTS.
- FOR PIPES AND FITTINGS FOR SUBSOIL DRAINAGE SHALL BE SLOTTED PVC WITH SOLVENT WELDED JOINTS MINIMUM DN150. INSPECTION RISERS TO BE PROVIDED AT 30m (MAXIMUM) INTERVALS TO ALL LENGTHS OF PIPE GREATER THAN 30m.
- FOR GRATED DRAINS SHALL BE MINIMUM DN150 IN NON-TRAFFICABLE ZONES AND DN225 IN TRAFFICABLE ZONES.
- LAY AND JOINT ALL PIPES IN ACCORDANCE WITH THE MANUFACTURING RECOMMENDATIONS AND
- AS 3725-1989 LOADS ON BURIED CONCRETE PIPES
- AS 2566 1988 BURIED FLEXIBLE PIPELINES
- AS 1597.2 1996 PRECAST REINFORCED CONCRETE BOX CULVERTS
- AS 3500 1990 NATIONAL PLUMBING AND DRAINAGE CODE PART 2 SANITARY PLUMBING AND SANITARY DRAINAGE SYDNEY WATER REQUIREMENTS.
- 4. ALLOW TO TEST ALL PIPES AND PITS TO MANUFACTURERS REQUIREMENTS.

### CONNECTIONS TO STORMWATER SYSTEMS UNDER BUILDINGS

IN ACCORDANCE WITH AS 3500.3 SECTION 6. TESTING IN ACCORDANCE WITH AS 3500.3 SECTION 9.2

### CONNECTIONS TO COUNCIL STORMWATER SYSTEMS:

CONNECTION TO COUNCIL STORMWATER SYSTEM TO BE IN ACCORDANCE TO LOCAL COUNCIL DCP AND STANDARDS. NO CONNECTIONS TO BE MADE UNTIL PERMIT/APPROVALS ARE OBTAINED FROM LOCAL COUNCIL IN WRITING.

EXISTING SERVICES SHOWN ON THESE PLANS ARE NOT GUARANTEED COMPLETE OR CORRECT AND FURTHER INFORMATION IS REQUIRED FROM THE RELEVANT AUTHORITY AND FIELD INVESTIGATION AND ARE TO BE VERIFIED BY THE CONTRACTOR PRIOR TO CONSTRUCTION.

# **LEGEND**

(IIIIIIIIIII)	GRATED TRENCH DRAIN		SURFACE INLET PIT
	ABSORPTION TRENCH	<u> </u>	SURFACE INLET PIT (WITH ENVIROPOD 200 MICRON)
<del></del>	PROPOSED ROOF GUTTER FALL		ACCESS GRATE
₩ SP 90	PROPOSED DOWNPIPE SPREADER	_	(WITH GROSS POLLUTANT TRAP)
• (DP)	PROPOSED DOWNPIPE	450 X 450	450 SQUARE INTERNAL
~	90mm DIA. OR 100mm x 50mm MIN.	SL 75.50	GRATE LEVEL = RL 75.50
O IR	INSPECTION RISER	IL 75.20	INVERT LEVEL = RL 75.20
•	RAINWATER HEAD	× 10.00	NATURAL GROUND FINISHED
		. [10.00]	DESIGN LEVEL

# STORMWATER PIT/STRUCTURES NOTES:

PIT SIZES WILL BE AS FOLLOWS:

DEPTH (mm)	MIN. PIT SIZE (mm)
UP TO 450	350x350
450 - 600	450x450
600 - 900	600x600
900 - 1200	600x900
1200+	900x900 (WITH STEP IRONS)


### PIT DESIGNS:

- TRENCH DRAINS: CONTINUOUS TRENCH DRAINS ARE TO BE MIN. DN150 AND MIN. 100mm DEPTH, THE BARS OF THE GRATE ARE TO BE PARALLEL
- STEP IRONS: PITS BETWEEN 1.2m AND 6m ARE TO HAVE STEP IRONS IN ACCORDANCE WITH AS 1657. FOR PITS GREATER THAN 6m OTHER MEANS
- 3. PLASTIC/PVC PITS: PVC PITS WILL ONLY BE PERMITTED IF THEY ARE MAX. 450x450 AND MAX. 450mm DEPTH AS WELL AS BEING HEAVY DUTY.
- IN-SITU PITS: IN-SITU PITS ARE TO BE CONSTRUCTED ON A CONCRETE BED OF AT LEAST 150mm THICK. THE WALLS ARE TO BE DESIGNED TO MEET THE MINIMUM REQUIREMENTS OF CLAUSE 4.6.3 OF AS 3500.4. PITS DEEPER THAN 1.8m SHALL BE CONSTRUCTED WITH REINFORCED
- GRATES GRATES ARE TO BE GALVANIZED STEEL GRID TYPE. GRATES ARE TO BE OF HEAVY-DUTY TYPE IN AREAS WHERE THEY MAY BE SUBJECT TO VEHICLE LOADING

# INSTALLATION NOTES

- ALL PIPES INTO PITS TO BE CUT FLUSH WITH PIT WALL
- GRATED COVERS ON PITS GREATER THAN 600mm TO BE HINGED
- MINIMUM 20mm FALL TO BE PROVIDED ACROSS BASE OF PIT

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		MIEAust CPEng NER 3894863					DETAILS, NOTES & LEGEND	DESIGNED EM	L230133
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		© (02) 4610 5262					No.2 BARDOO AVENUE	1330L A	No. IN SET
N	Y CIVIL ENGINEERING	□ admin@nycivilengineering.com.au  ⊕ www.nycivilengineering.com.au					NORTH BALGOWLAH	SCALE -	8

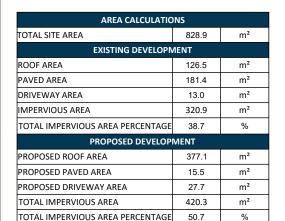

BELOW GROUND OSD TANK A

SURFACE LEVEL

CENTRELNE LEVEL

SOFFIT LEVEL

HED LEVEL

INVERT LEVEL

VOLUME (m3)

SURFACE AREA

AVERAGE DEPTH

T.W.L.

OSD

RL 84.00

RL 83.80

RL 83.70

RL 83.60

RL 82.95

RL 82.90

6.6m<sup>2</sup>

0.78m

5.15m<sup>3</sup>

### **DRAINAGE PIPE LEGEND**

- EXISTING STORMWATER PIPE
- DRAINAGE PIPES TO RAINWATER TANK
- IN-GROUND DRAINAGE PIPES VIA GRAVITY
- CHARGED DRAINAGE PIPES

Ø100mm 'CHARGED LINE'

TO RWT (TYPICAL

PIPES STRAPPED TO UNDERSIDE OF SLAB

NOTE: ALL IN GROUND PIPES TO BE Ø100 PVC AT 1% (MIN) UNO

Ø100 AT 1%

(MIN)

TERRACE

FFL 84.650

OSD CALCULATION SUMMARY	DWELLING	A
STORM (AEP) SITE AREA	1%	20%
PREDEVELPOED PSD (L/s)	-	12
POSTDEVELOPED OSD DISCHARGE (L/s)	7	7
POSTDEVELOPED BYPASS (L/s)	5	2
OSD VOLUME (m³)	5.1	0.8

THEREFORE POST DEVELOPMENT DISCHARGE LIMITED TO REDEVELOPED STATE IN ANY STORM EVENT UP TO AND INCLUDING

Ø100 (OVERFLOW

FROM RWT) BY

**GRAVITY** 

PROPOSED

**DWELLING A** 

OSD CALCULATION SUMMARY	DWELLING	В
STORM (AEP) SITE AREA	1%	20%
PREDEVELPOED PSD (L/s)	-	12
POSTDEVELOPED OSD DISCHARGE (L/s)	10	10
POSTDEVELOPED BYPASS (L/s)	2	1
OSD VOLUME (m <sup>3</sup> )	6.1	0.2

THEREFORE POST DEVELOPMENT DISCHARGE LIMITED TO PREDEVELOPED STATE IN ANY STORM EVENT UP TO AND INCLUDING

POOL

Ø100mm

'CHARGED LINE'

TO RWT (TYPICAL)

Ø100 AT 1%

Ø100 (OVERFLOW

PROPOSED

**DWELLING B** 

FFL 85.000

FROM RWT) BY

**GRAVITY** 

# **RAINWATER RE-USE TANK - RWT**

(AS PER BASIX REQUIREMENTS

SIZE: 2,000 LITRES (MIN)

SLIMLINE TANK BY "KINGSPAN" OR SIMILAR

(2100L x 550W x 2015H)

INSTALL TO MANUFACTURES SPECIFICATIONS, AS3500 AND COUNCIL REQUIREMENTS

- FOR RE-USE AS SPECIFIED BY BASIX CERTIFICATE
- ENSURE TOP OF TANK IS MIN 0.5m BELOW ROOF GUTTERS TO

ACCORDANCE WITH AS/NZS 3500.3.2021 AND NSW CODE OF

ENSURE SUFFICIENT HEAD FOR THE SYSTEM TANK TO BE INSTALLED BY LICENSED PLUMBER IN

PRACTICE PLUMBING AND DRAINAGE 2006

### **INSPECTION RISER (IR)**

PROVIDE 'SCREW CAP' INSPECTION RISER AT LOWEST POINT OF 'CHARGED LINES'

NOTE: ENSURE ANY PROPOSED PAVING IS GRADED SO THAT IT IS NOT IMPACTING ADJOINING PROPERTIES.

**GRATED DRAIN** PROVIDE 150mm WIDE GRATED DRAINS

OSD WARRANT


- NORTHERN BEACHES COUNCIL


SOURCE- WATER MANAGEMENT DEVELOPMENT POLICY

ONSITE STORMWATER DISPOSAL REQUIREMENTS REGION 3

THE DEVELOPMENT IS **NOT** A ONE-OFF EXTENSION OR AN ADDITION, INVOLVING AN INCREASE IN IMPERVIOUS AREA OF LESS THAN 50m<sup>2</sup> AND THE TOTAL EXISTING IMPERVIOUS AREAS OF THE SITE DOES NOT EXCEED 35%.

THEREFORE, OSD REQUIRED

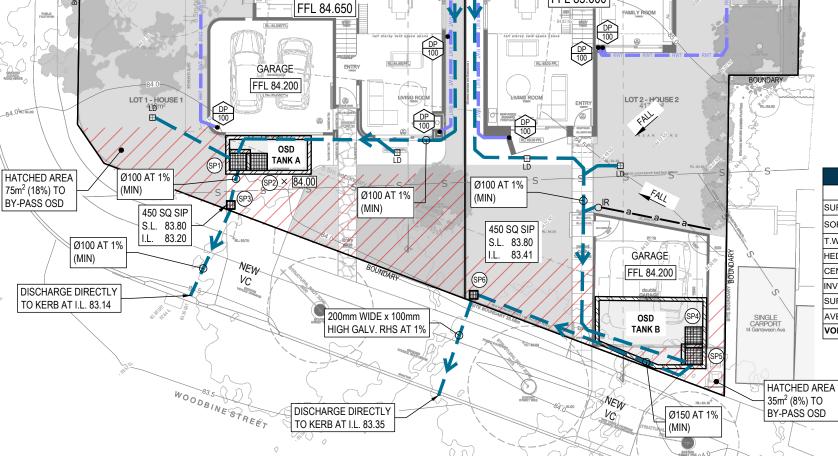

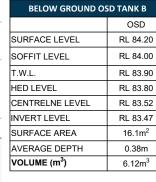

PLANS ARE FOR CONCEPT ONLY AND NOT FOR CONSTRUCTION



APPROVED BY	REVISION	DRAWN	DESCRIPTION	DATE	
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admin@nycivilengineering.com.au					1
www.nycivilengineering.com.au					

# STORMWATER MANAGEMENT PLAN

PROPOSED DUAL OCCUPANCY No.2 BARDOO AVENUE **NORTH BALGOWLAH** 


SHEET SIZE A3 JOB REFERENCE E250155 DESIGNED EM

CHECKED NZ

ISSUE

No. IN SET 8 SCALE 1:200

DRAWING No D2

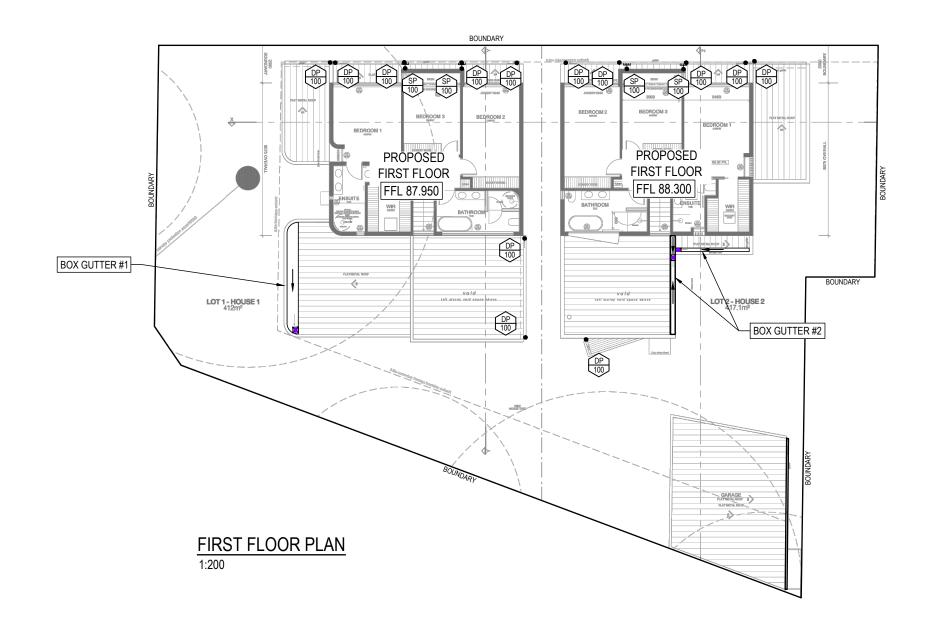

ROOF DRAINAGE

- STRATCO HALF ROUND UNSLOTTED OR EQUIVALENT GUTTER WITH CROSS SECTIONAL AREA GREATER THAN

7700mm<sup>2</sup>

• DOWN PIPES - Ø90 PVC

NOTE: ROOF DESIGNED TO 5% AEP INTENSITY 205 mm/hr



PLANS ARE FOR CONCEPT ONLY AND NOT FOR CONSTRUCTION

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APPROVED BY	REVISION	DRAWN	DESCRIPTION	DATE	
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DIAWING TITEL
STORMWATER MANAGEMENT
FIRST FLOOR PLAN

PROPOSED DUAL OCCUPANCY No.2 BARDOO AVENUE NORTH BALGOWLAH

SHEET SIZE A3	JOB REFERENCE
DESIGNED EM	E250155
	DRAWING No.


CHECKED NZ

ISSUE

No. IN SET SCALE 1:200

D3

8

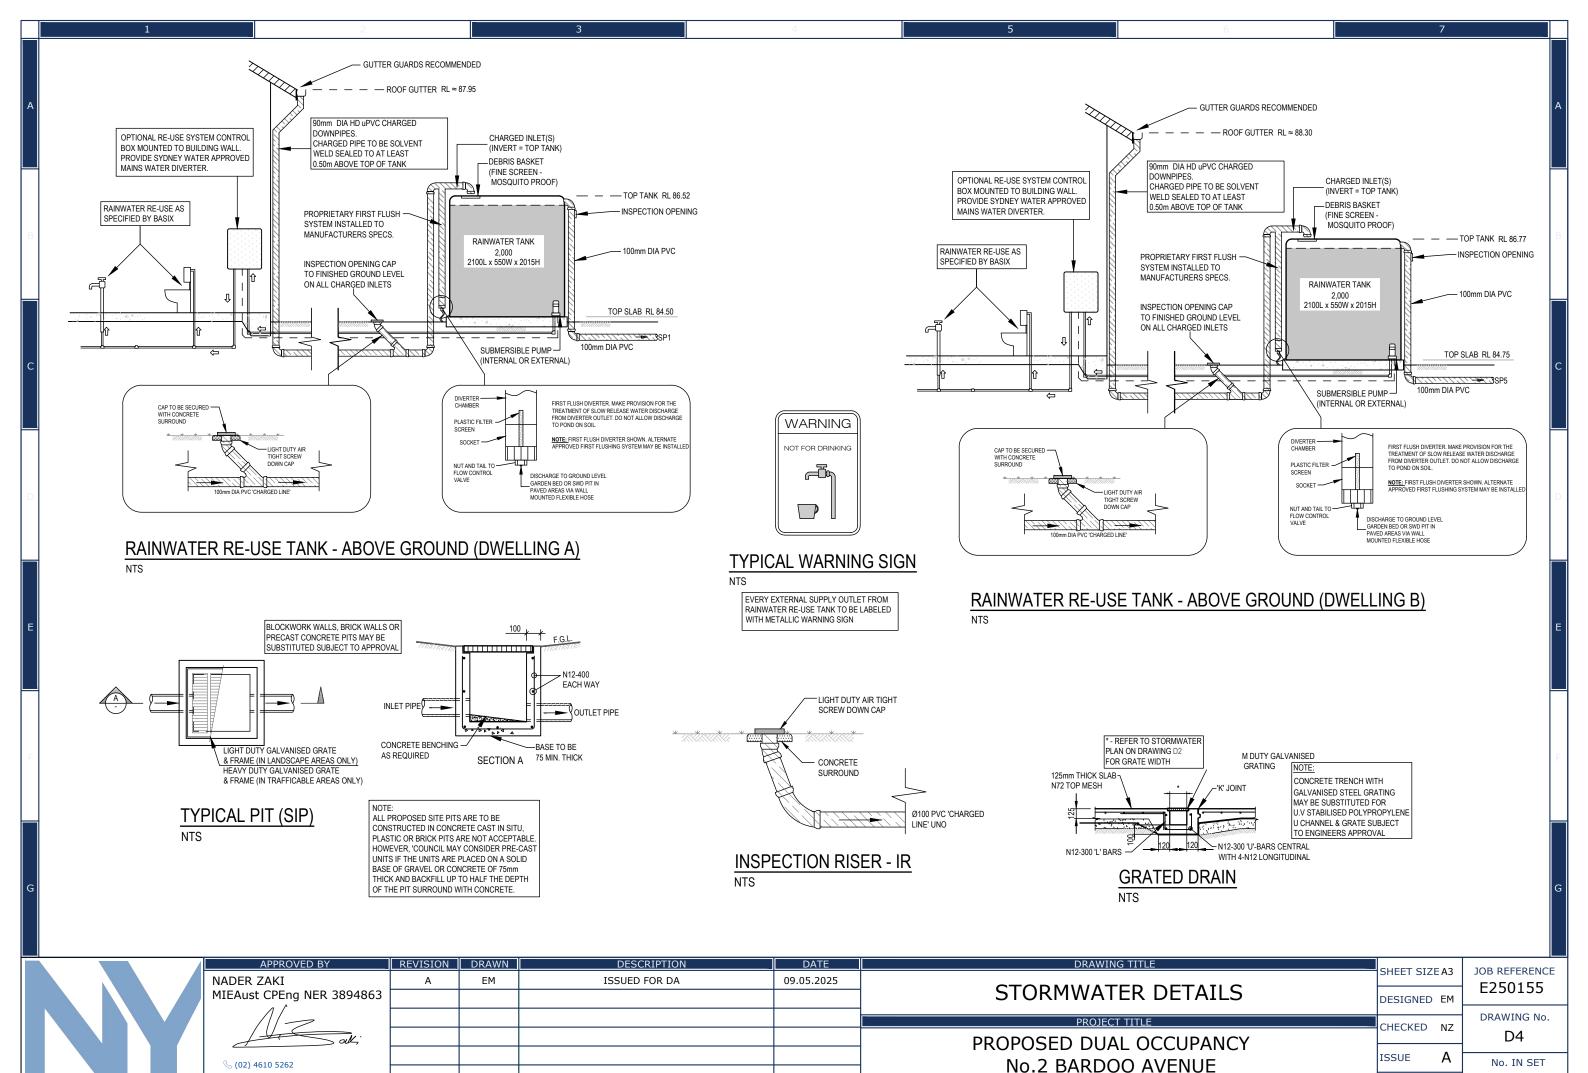

8

SCALE AS NOTED

**NORTH BALGOWLAH** 

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# FLO-WAY & RAINWATER


PIT AND GRATES

Flo-way Pits suit 90mm or 100mm PVC Pipe


### SPECIFICATIONS - SHALLOW


Length: 257mm Width: Shallow Height: 257mm 75mm Capacity:



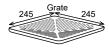

# LANDSCAPE DRAIN - LD

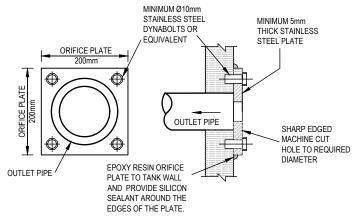

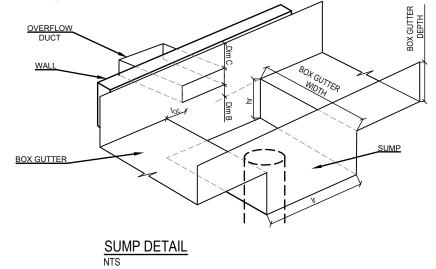

DIMENSIONS (mm)					
	BOX GUTTER #1	BOX GUTTER #2			
CATCHMENT AREA TO DOWNPIPE	32m <sup>2</sup>	30m <sup>2</sup>			
RUNOFF (L/s)	2.6	2.9			
WIDTH OF BOX GUTTER	600	200			
DEPTH OF BOX GUTTER (AT HP)	110	125			
DEPTH OF BOX GUTTER (AT SUMP)	140	155			
SLOPE OF BOX GUTTER	1:200	1:200			
SUMP WIDTH	600	200			
SUMP LENGTH (Ir)	400	400			
SUMP DEPTH (hr)	50	55			
OVERFLOW WIDTH	300	200			
OVERFLOW DEPTH	65	65			
DIMENSION I <sub>OC</sub>	15	30			
DIMENSION B	10	20			
DIMENSION C	35	40			
DOWNPIPE DIA	90	90			

ROOF DRAINAGE DESIGNED FOR 100 YEAR ARI STORM EVENT (I = 269 mm/hr)

# ORIFICE PLATE DETAIL

NTS



NOTE:-

1 - SIGN SHALL BE PLACED IN A CLEAR AND VISIBLE LOCATION OF EACH DETENTION

COLOURS:-TRIANGLE AND "WARNING"

RED FIGURE AND OTHER LETTERING - BLACK

**ON-SITE DETENTION** WARNING SIGN

ORIFICE PLATE, SEE DETAIL HANDLE STELL PLATE CLIP WELDED TO BASKET GALVANISED. TYPICAL BOTH SIDES STEEL PLATE BRACKET GALVANISED FIXED TO FIT WALL WITH 2 LOXINS TO SEAT CLIPS INTO. - RH3030 LYSAGHT TRASH SCREEN NTS




CORNERS: SQUARE

COLOUR: ETCHED AND FILLED BLACK LEGEND ON NATURAL SILVER BACKGROUND

OSD PLAQUE

	APPROVED BY	REVISION	DRAWN	DESCRIPTION	DATE	DRAWING TITLE	SHEET SIZE A3	JOB REFERENC
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	© (02) 4610 5262						ISSUE A	No. IN SE
						No.2 BARDOO AVENUE		0
IVIL ENGINEERING	www.nycivilengineering.com.au					NORTH BALGOWLAH	SCALE AS NOTED	0

NOTE: ALL INLET PIPES TO OSD AREA TO BE DIRECTLY CONNECTED TO HIGH EARLY DISCHARGE CONTROL CHAMBER

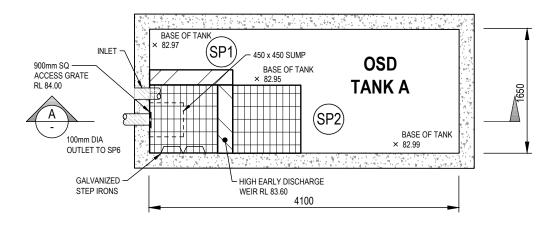

# PLAN VIEW 1:50

