

ACTION PLANS

m: 0426 957 518 e: operations@actionplans.com.au w: www.actionplans.com.au

DEVELOPMENT APPLICATION THESE PLANS ARE FOR DEVELOPMENT APPROVAL ONLY.

ITEM DETAILS	DEVELOPMENT APPLICATION			
ADDRESS	39 PRINCE EDWARD ROAD, SEAFOR	TH. NSW. 2092		
LOT & DP/SP	LOT 141 DP 11162	, - ,		
COUNCIL	NORTHERN BEACHS COUNCIL (MAN	LY)		
SITE AREA	518.50m ²			
FRONTAGE	12.19m			
CONTROLS	PERMISSIBLE / REQUIRED	EXISTING	PROPOSED	COMPLIANCE
	m / m² / %	m / m² / %	m / m² / %	
<u>LEP</u>				
LAND ZONING	R2 – LOW DENSITY RESIDENTIAL	R2	R2	YES
MINIMUM LOT SIZE	500m ²	518.50m ²	UNCHANGED	YES
FLOOR SPACE RATIO	0:45 : 1 (233.325m ²)	0.31 : 1 (162.96m ²)	0.37 : 1 (191.96m ²)	YES
MAXIMUM BUILDING HEIGHT	8.5m	9.6m	UNCHANGED	NO
HAZARDS				
ACID SULFATE SOILS	NOT IDENTIFIED	N/A	N/A	N/A
FLOOD PLANNING	NOT IDENTIFIED	N/A	N/A	N/A
TERRESTRIAL BIODIVERSITY	NOT IDENTIFIED	N/A	N/A	N/A
RIPARIAN LAND & WATERCOURSE	NOT IDENTIFIED	N/A	N/A	N/A
WETLANDS	NOT IDENTIFIED	N/A	N/A	N/A
LANDSLIP RISK	NOT IDENTIFIED	N/A	N/A	N/A
TERRESTRIAL BIODIVERSITY	NOT IDENTIFIED	N/A	N/A	N/A
FORESHORE SCENIC PRO. AREA	NOT IDENTIFIED	N/A	N/A	N/A
BUSHFIRE	NOT IDENTIFIED	N/A	N/A	N/A
DCP	-			
RESIDENTIAL OPEN SPACE	AREA OS3			
TOTAL OPEN SPACE (TOS)	55% (285.175m ²)	392.52m ² (75%)	334.5m ² (64%)	YES
LANDSCAPE AREA	35% OF TOS (55%) : 99.81m ²	280.34m ²	314.93m ²	YES
OPEN SPACE ABOVE GROUND	MAX. 40% OF TOS (55%) : 114.07m ²	13.40m ²	31.72m ²	YES
PRINCIPAL PRIVATE OPEN SPACE	18m²	0m²	21.84m ²	YES
FRONT SETBACK	PREVALING BULDING LINE: 6m	10.9m	8.93m	YES
REAR SETBACK	8.0m	16.6m	UNCHANGED	YES
	1/3 WALL HEIGHT	N:0.994m	N:UNCHANGED	NO
SIDE SETBACKS	3.050m	S:1.016m	S:UNCHANGED	NO
CAR PARKING SPACES	Required: 1	1	UNCHANGED	YES

SHEET NUMBER	SHEET NAME	DATE PUBLISHED
DA00	COVER	06/04/2020
DA01	NOTATION	06/04/2020
DA02	SITE ANALYSIS	06/04/2020
DA03	SITE / ROOF / SEDIMENT EROSION / WASTE MANAGEMENT / STORMWATER CONCEPT PLAN	06/04/2020
DA04	EXISTING GARAGE FLOOR PLAN	06/04/2020
DA05	EXISTING GROUND FLOOR PLAN	06/04/2020
DA06	EXISTING FIRST FLOOR PLAN	06/04/2020
DA07	PROPOSED GARAGE FLOOR PLAN	06/04/2020
DA08	PROPOSED GROUND FLOOR PLAN	06/04/2020
DA09	PROPOSED FIRST FLOOR PLAN	06/04/2020
DA10	NORTH / EAST ELEVATION	06/04/2020
DA11	SOUTH / WEST ELEVATION	06/04/2020
DA12	PROPOSED CARPORT / DRIVEWAY	06/04/2020
DA13	NORTH / EAST ELEVATION - CARPORT	06/04/2020
DA14	SOUTH / WEST ELEVATION - CARPORT	06/04/2020
DA15	LONG / CROSS SECTION	06/04/2020
DA16	DRIVEWAY LONG / CROSS SECTION	06/04/2020
DA17	AREA CALCULATIONS / SAMPLE BOARD	06/04/2020
DA18	WINTER SOLSTICE 9 AM	06/04/2020
DA19	WINTER SOLSTICE 12 PM	06/04/2020
DA20	WINTER SOLSTICE 3 PM	06/04/2020
DA21	BASIX COMMITMENTS	06/04/2020



- EARTHWORKS - PA
- EARTH RETAINING
- DRAINAGE - PART 3
- TERMITE-RISK MAN
- FOOTINGS & SLAB
- MASONRY - PART 3
- FRAMING - PART 3.4
- SUB FLOOR VENTIL
- ROOF CLADDING AI
- GLAZING - PART 3.6
- FIRE SAFETY - PAR
- FIRE SEPERATION - - FIRE PROTECTION
- SMOKE ALARMS - P
- WET AREAS AND EX
- ROOM HEIGHTS - P.
- FACILITIES - PART 3
- LIGHT - PART 3.8.4 (
- VENTILATION - PAR
- SOUND INSULATION
- STAIRWAYAND RAN
- BARRIERS AND HAM
- SWIMMING POOLS
- CONSTRUCTION IN
- FENCING & OTHER
- DEMOLITION WORK
- ALL WATERPROOF
- ALL PLUMBING & DR
- SITE CLASSIFICATION
- ALL PLASTERBOAR
- ALL STRUCTURAL S
- ALL CONCRETE WC
- ALL ROOF SHEETIN
- ALL SKYLIGHTS TO
- ALL CERAMIC TILIN
- ALL GLAZING ASSE - ALL TIMBER RETAIN
AS 1720.2-2006, AS
- ALL RETAINING WAI
- ALL CONSTRUCTIO

39 PRINCE EDWARD ROAD, SEAFORTH NSW 2092

NCC & AS COMPLIANCES SPECIFICATIONS

RT 3.1.1 OF NCC STRUCTURES - PART 3.1.2 OF NCC 3.1.3 OF NCC NAGEMENT - PART 3.1.4 OF NCC - PART 3.2 OF NCC INCLUDING AS2870 3.3 OF NCC INCLUDING AS3700 .4 OF NCC LATION - PART 3.4.1 OF NCC ND WALL-CLADDING - PART 3.5 OF NCC 6 OF NCC INCLUDING AS1288 RT 3.7 OF NCC - PART 3.7.2 OF NCC OF SEPERATING WALLS AND FLOORS- PART 3.7.3 OF NCC PART 3.7.5 OF NCC XTERNAL WATERPROOFING - PART 3.8.1 OF NCC PART 3.8.2 OF NCC 3.8.3 OF NCC OF NCC RT 3.8.5 OF NCC N - PART 3.8.6 OF NCC MP CONSTRUCTION - PART 3.9.1 OF NCC NDRAILS - PART 3.9.2 OF NCC - PART 3.10.1 OF NCC **BUSHFIRE PRONE AREAS - PART 3.10.5 OF NCC** PROVISIONS - REGS & AS1926 KS - AS2601-1991 THE DEMOLITION OF STRUCTURES. MEMBRANES TO COMPLY WITH WITH AS 3740-2010 RAINAGE WORK TO COMPLY WITH AS 3500 ON AS TO AS 2870 RD WORK TO COMPLY WITH AS 2588-1998 STEEL WORK TO COMPLY WITH AS 4100 & AS 1554 ORK TO COMPLY WITH AS 3600 NG WORK TO COMPLY WITH AS 1562-1992 COMPLY WITH WITH AS 4285-2007 IG TO COMPLY WITH AS 3958.1-2007 & 3958.2-1992 MBLIES TO COMPLY WITH AS2047 & 1288 NING WALLS ARE TO COMPLY WITH AS 1720.1-2010, 1720.4-2006, AS 1170.1-1989 & AS 1170.4-2007 ALLS ARE TO COMPLY WITH 3700 - 2011 & AS 3600 - 2009 ALL CONSTRUCTION TO COMPLY TO AS3959- 2009

NOTES

• APPROVED MEANS BY THE 'RELEVANT LOCAL AUTHORITY' OR COUNCIL

• THE OWNER WILL DIRECTLY PAY THE FEES ASSOCIATED WITH THE FOLLOWING:

BUILDING APPROVAL FROM COUNCIL, FOOTPATHAND KERB DEPOSITS WITH THE LOCAL COUNCIL, INSURANCE FEE TO BUILDING SERVICES CORPORATION, LONG SERVICE LEAVE SERVICE LEVY FEE AND APPROVAL FEE BY WATER AND SEWERAGE AUTHORITY. ALL OTHER FEES ARE TO BE PAID BY THE BUILDER. THE AMOUNT OF ANY LOCAL AUTHORITY DEPOSITS WHICH ARE FORFEITED DUE TO DAMAGE OR OTHER CAUSE WILL BE DEDUCTED FROM THE PAYMENTS DUE TO THE BUILDER.

• THE BUILDER IS TO PROVIDE AT HIS/HER OWN EXPENSE ADEQUATE PUBLIC RISK INSURANCE AND ARRANGE INDEMNIFICATION UNDER THE WORKERS COMPENSATION ACT. WORKS INSURANCE TO BE STATED IN THE CONTRACT CONDITIONS.

• ALL WORK TO BE CARRIED OUT IN A TRADESMEN LIKE MANNER AND IN ACCORDANCE WITH THE STANDARDS CODES AND REGULATIONS OF THE STANDARDS ASSOCIATION OF AUSTRALIA. BUILDING CODE OF AUSTRALIA AND ANY STATUTORY AUTHORITY HAVING JURISDICTION OVER THE WORK.

• ALL TENDERERS ARE TO VISIT THE SITE TO SATISFY THEMSELVES AS TO THE NATURE AND EXTENT OF THE WORKS, FACILITIES AVAILABLE AND DIFFICULTIES ENTAILED IN THE WORKS AS VARIATIONS WILL NOT BE ALLOWED DUE TO WORK ARISING OWING TO NEGLECT OF THIS CLAUSE.

• ALL WORK AND MATERIALS TO COMPLY WITH THE CURRENT AUSTRALIAN STANDARDS AT THE TIME OF COMMENCEMENT WERE APPLICABLE.

• THESE DRAWINGS SHALL BE READ IN CONJUNCTION WITH ALL STRUCTURAL AND OTHER CONSULTANTS DRAWINGS AND SPECIFICATIONS AND WITH ANY SUCH WRITTEN INSTRUCTIONS AS MAY BE ISSUED. DURING THE COURSE OF THE CONTRACT.

• SET OUT DIMENSIONS SHOWN ON THIS DRAWING SHALL BE VARIFIED BY THE BUILDER ON SITE BEFORE COMMENCEMENT OF ANY WORK, DIMENSIONS SHOULD NOT BE OBTAINED BY SCALING THE DRAWINGS. USE ONLY FIGURED DIMENSIONS, ALL DIMENSIONS ARE IN MILLIMETRES.

• THE BUILDER IS TO ENSURE ALL CONSTRUCTION. LEVELS AND OTHER ITEMS COMPLY WITH THE CONDITIONS OF THE BUILDING APPROVAL.

• THE BUILDER IS TO COMPLY WITH ALL ORDINANCES, LOCAL AUTHORITY REGULATIONS AND THE REQUIREMENTS OF ALL SERVICES SUPPLY AUTHORITIES HAVING JURISDICTION OVER THE WORKS. • ALL PLUMBING AND DRAINAGE WORK TO BE INSTALLED AND COMPLETED BY A LICENCED TRADESMAN AND IN ACCORDANCE WITH THE STATUTORY BODY HAVING AUTHORITY OVER THE WORKS. CONNECT ALL WASTE TO SYDNEY WATER SEWER LINE

ALL NEW DOWNPIPES ARE TO BE CONNECTED TO THE EXISTING STORM WATER SYSTEM.

ALL POWER AND STORMWATER OUTLET LOCATIONS SHALL BE DETERMINED ONSITE BY THE OWNER.

SMOKE DETECTOR ALARM TO BE INSTALLED IN ACCORDANCE WITH AS3786 AND THE BUILDING CODE OF AUSTRALIA.

• ELECTRICAL WORK TO BE IN ACCORDANCE WITH SAA WIRING RULES AND BE DONE BY A LICENCED TRADESMAN

• ANY DETAILING IN ADDITION TO WHAT IS SUPPLIED SHALL BE RESOLVED BETWEEN THE OWNER AND THE BUILDER TO THE OWNERS APPROVAL, EXCEPT FOR ANY STRUCTURAL DETAILS OR DESIGN WHICH IS SUPPLIED BY THE ENGINEER.

ALL TIMBER SIZES AND CONCRETE DETAILS TO BE CONFIRMED BY THE BUILDER PRIOR TO COMMENCEMENT OF ANY WORK.

• ALL STRUCTURAL WORK IS TO BE IN ACCORDANCE WITH THE STRUCTURAL DETAILS PREPARED BY A STRUCTURAL ENGINEER (i.e.) PIERS, FOOTINGS, CONCRETE SLABS, RETAINING WALLS, STEELWORK, FORMWORK, UNDERPINNING, ADDITIONAL STRUCTURAL LOADS, TIMBER FRAMING, WIND BRACING AND ASSOCIATED CONNECTIONS. BUILDER TO OBTAIN PRIOR TO FINALISING TENDER.

• ANY WORK INDICATED ON THE PLANS BUT NOT SPECIFIED, AND ANY ITEM NOT SHOWN ON THE PLAN WHICH IS OBVIOUSLY NECESSARY AS A PART OF CONSTRUCTION AND/OR FINISH IS TO BE CONSIDERED AS SHOWN AND SPECIFIED, AND IS TO BE DONE AS PART OF THE CONTRACT. VARIATIONS WILL NOT BE PERMITTED WITHOUT THE WRITTEN CONSENT OF THE OWNER.

• THE BUILDER SHALL PROVIDE SEDIMENT AND SILTRATION CONTROL MEASURES AS REQUIRED BY COUNCIL AND MAINTAIN THEM THROUGH THE DURATION OF THE WORKS.

• A LEGIBLE COPY OF THE PLANS BEARING APPROVAL STAMPS MUST BE MAINTAINED ON THE JOB AT ALL TIMES. HOURS OF CONSTRUCTION WILL BE RESTRICTED TO THE TIMES AS REQUIRED BY THE BUILDING APPROVAL.

• THE BUILDER IS TO ARRANGE FOR ALL INSPECTIONS REQUIRED BY THE AUTHORITIES AND LENDING INSTITUTIONS TO THEIR REQUIREMENTS.

• THE BUILDER IS TO OBTAIN APPROVAL FOR INTERUPTIONS TO EXISTING SERVICES AND MINIMISE THE DURATION AND NUMBER OF INTERUPTIONS. ANY INTERRUPTIONS WITH EXISTING SERVICES AND EQUIPMENT TO BE ATTENDED TO BY THE APPROPRIATELY SKILLED TRADESMEN.

• THE BUILDER SHALL RESTORE, REINSTATE OR REPLACE ANY DAMAGE CAUSED TO EXISTING STRUCTURES OR LANDSCAPING BY CONSTRUCTION WORK OR WORKMEN. PROVIDE PROTECTION TO EXISTING TREES TO REMAIN AS REQUIRED BY APPROVAL CONDITIONS.

ALL BRICKWORK IS TO BE SELECTED BY OWNER AND IS TO COMPLY WITH AS1640

ALL MASONRY TO COMPLY WITH AS3700

ALL METALWORK AND FLASHING ITEMS NECESSARY TO SATISFACTORY COMLPETE WORK SHALL BE PROVIDED.

ALL GUTTERS, DOWNPIPES TO BE COLORBOND.

ALL TIMBER CONSTRUCTION TO BE IN ACCORDANCE WITH THE AUSTRALIAN STANDARD 1684 "TIMBER FRAMING CODE"


ALL GLAZING INSTALLED TO COMPLY WITH AS1288, 2047 AND IN ACCORDANCE WITH MANUFACTURERS RECOMMENDATION

• ALL WALL AND CEILING LININGS TO BE PLASTERBOARD OR CEMENT RENDER AS SELECTED AND VILLA BOARD IN WET AREAS, TO COMPLY WITH THE RELEVANT AUSTRALIAN STANDARDS OR INSTALLED IN ACCORDANCE WITH MANUFACTURERS SPECIFICATION. • ALL BATHROOMS AND WET AREAS TO BE ADEQUATELY WATERPROOFED TO MANUFACTURERS SPECIFATION AND AS3740 AND PART 3.8.1 OF THE BUILDING CODE OF AUSTRALIA HOUSING PROVISIONS


STAIRS AND BALUSTRADES TO COMPLYWITH PART 3.9.1 & 3.9.2 OF THE BUILDING CODE OF AUSTRALIA HOUSING PROVISION.

TERMITE PROTECTION MEASURES TO COMPLY WITH AS 3660 AND BE INSTALLED TO MANUFACTURERS SPECIFICATION.

• ANY DETAILING ADDITIONAL TO THAT SUPPLIED , SHALL BE RESOLVED BETWEEN THE OWNER AND THE BUILDER TO THE OWNERS APPROVAL. EXCEPT FOR ANY STRUCTURAL DETAILS OR DESIGN WHICH IS TO BE SUPPLIED BY THE STRUCTURAL ENGINEER.

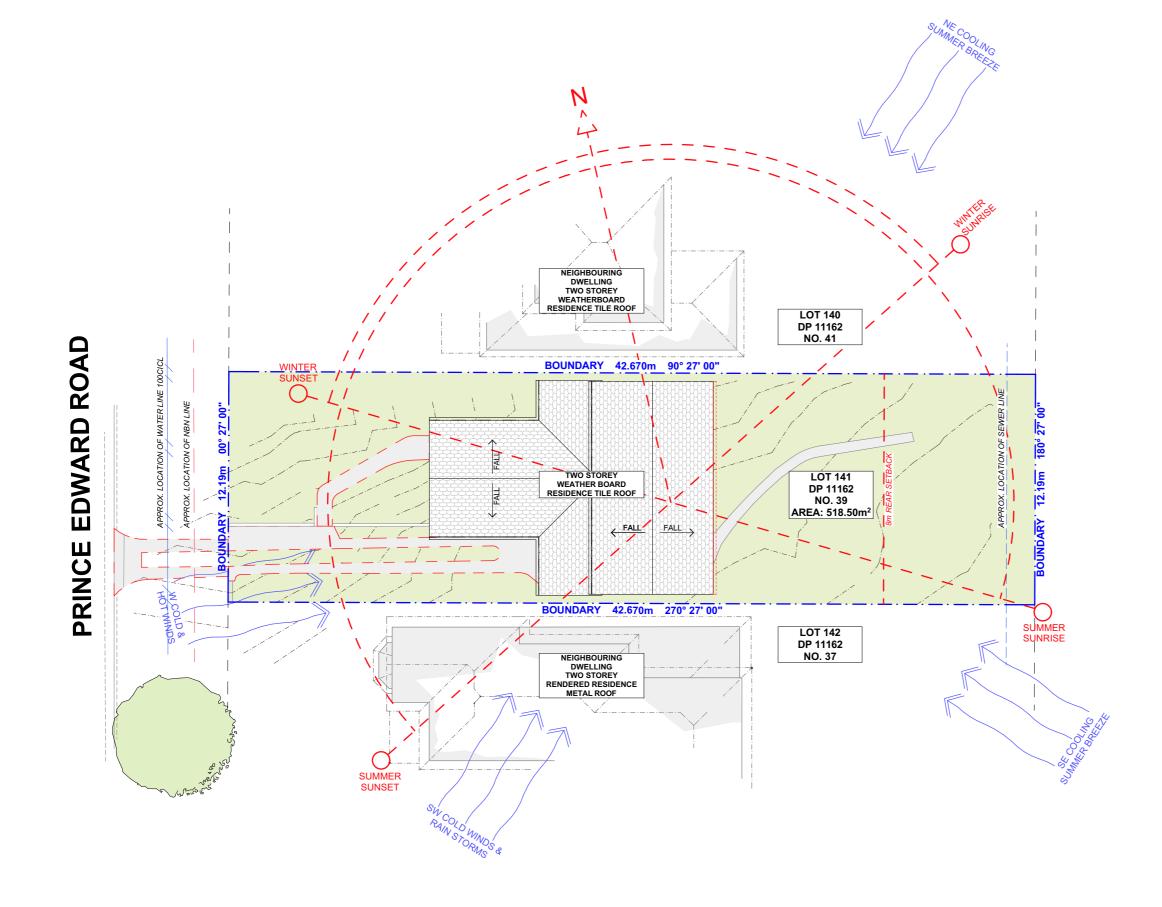


		REV.	DATE	COMMENTS	DRWN	NOTES This drawing is the copyright of Action Plans and not be	LEGE	ND		CLIENT	DRAWING NO
	ACTION PLANS	A	31/01/2020	INITIAL DESIGN PLAN	AL	altered, reproduced or transmitted in any form or by any means in part or in whole with the written permission of		LANDSCAPE	DP. DOWNPIPE	CHRIS & SUSIE	DA02
L.		В	09/03/2020	FIRST DESIGN AMENDMENT	DLR	Action Plans. Do not scale measure from drawings. Figured dimensions		HARD SURFACE	EARTH	McCALL	DAUZ
1	m: 0426 957 518	с	01/04/2020	DEVELOPMENT APPLICATION	LRP	are to be used only. The Builder/Contractor shall check and verify all levels and		PROPOSED	SETBACKS	PROJECT ADDRESS	DATE
+	e:operations@actionplans.com.au w: www.actionplans.com.au					dimensions on site prior to commencement of any work, creation of shop drawings, or fabrication of components. All errors and omissions are to be verified by the		EXISTING	- · - BOUNDARY LINE	39 PRINCE EDWARD ROAD. SEAFORTH	06 April 2020
						Builder/Contractor and referred to the designer prior to the commencement of works.		DEMOLISHED		NSW 2092	I

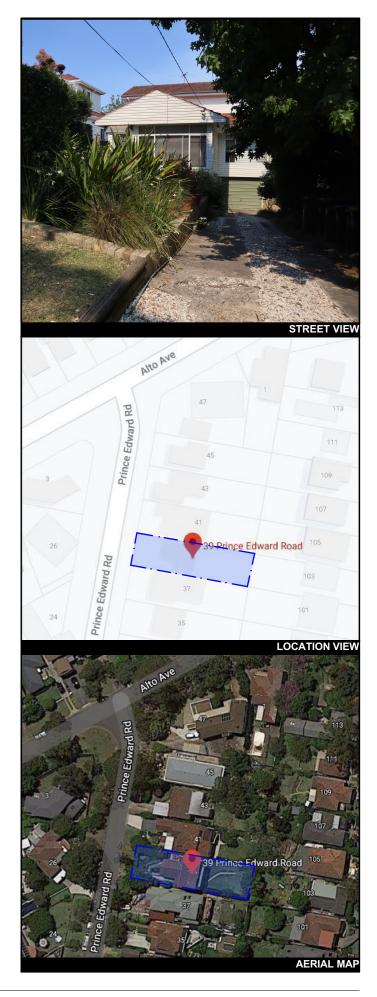



VING NO.


DRAWING NAME SITE ANALYSIS

SCALE 1:200 @A3

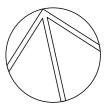

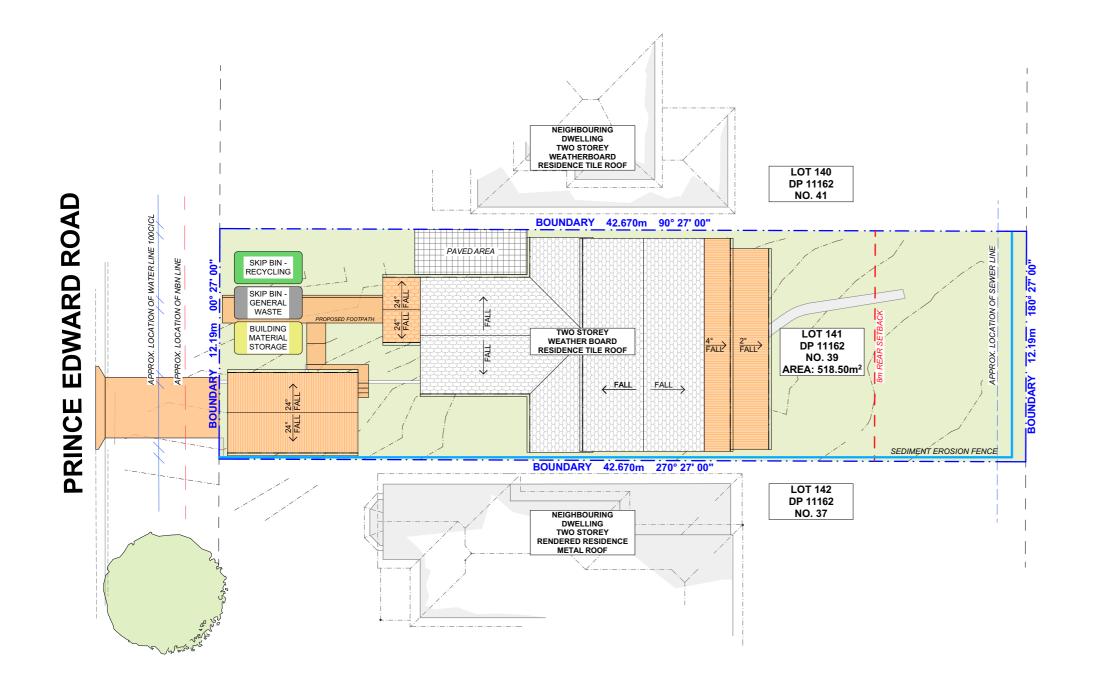


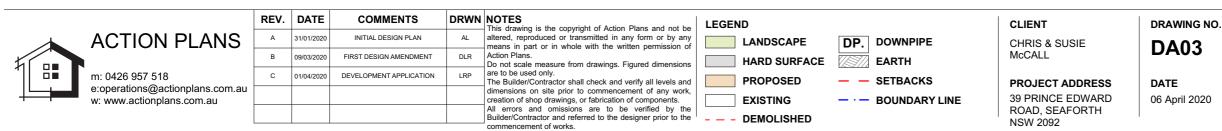

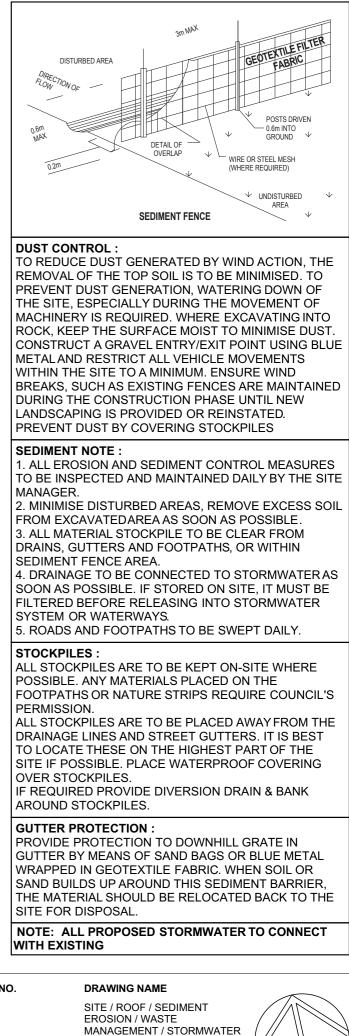





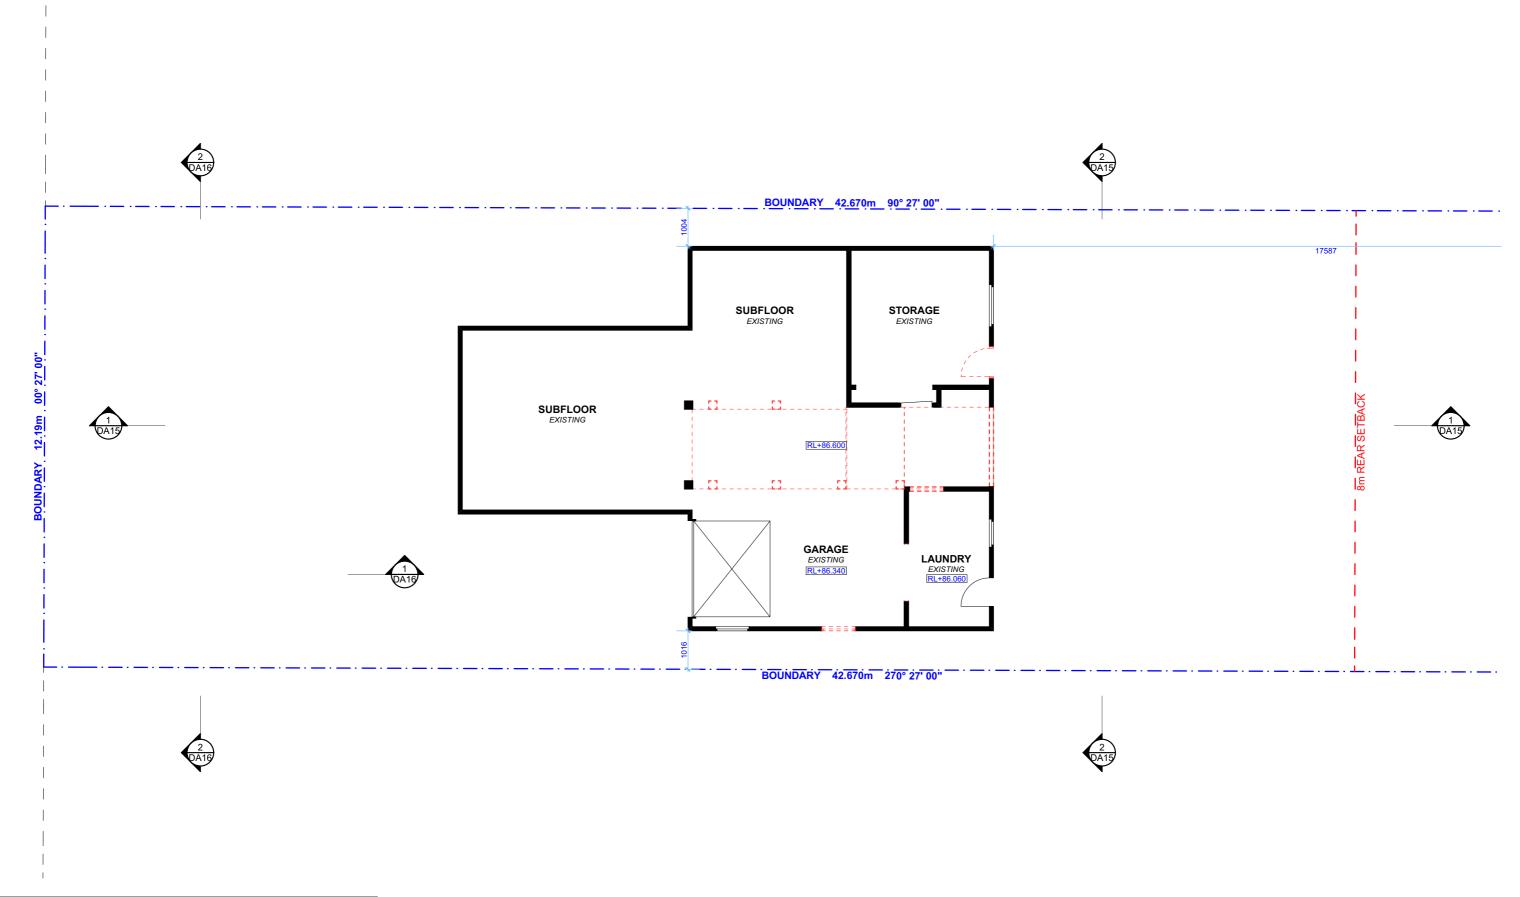



		REV.	DATE	COMMENTS		NOTES This drawing is the copyright of Action Plans and not be	LEGEND	CLIENT	DRAWING NO
	ACTION PLANS	А	31/01/2020	INITIAL DESIGN PLAN		altered, reproduced or transmitted in any form or by any means in part or in whole with the written permission of		CHRIS & SUSIE	DA04
		В	09/03/2020	FIRST DESIGN AMENDMENT	DLR	Action Plans. Do not scale measure from drawings. Figured dimensions	BROBOSED	McCALL	DA04
	m: 0426 957 518	с	01/04/2020	DEVELOPMENT APPLICATION	LRP	are to be used only. The Builder/Contractor shall check and verify all levels and		PROJECT ADDRESS	DATE
╨	e:operations@actionplans.com.au w: www.actionplans.com.au					dimensions on site prior to commencement of any work, creation of shop drawings, or fabrication of components. All errors and omissions are to be verified by the Builder/Contractor and referred to the designer prior to the commencement of works.		39 PRINCE EDWARD ROAD, SEAFORTH NSW 2092	06 April 2020




DRAWING NAME

EXISTING GARAGE FLOOR PLAN

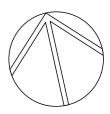

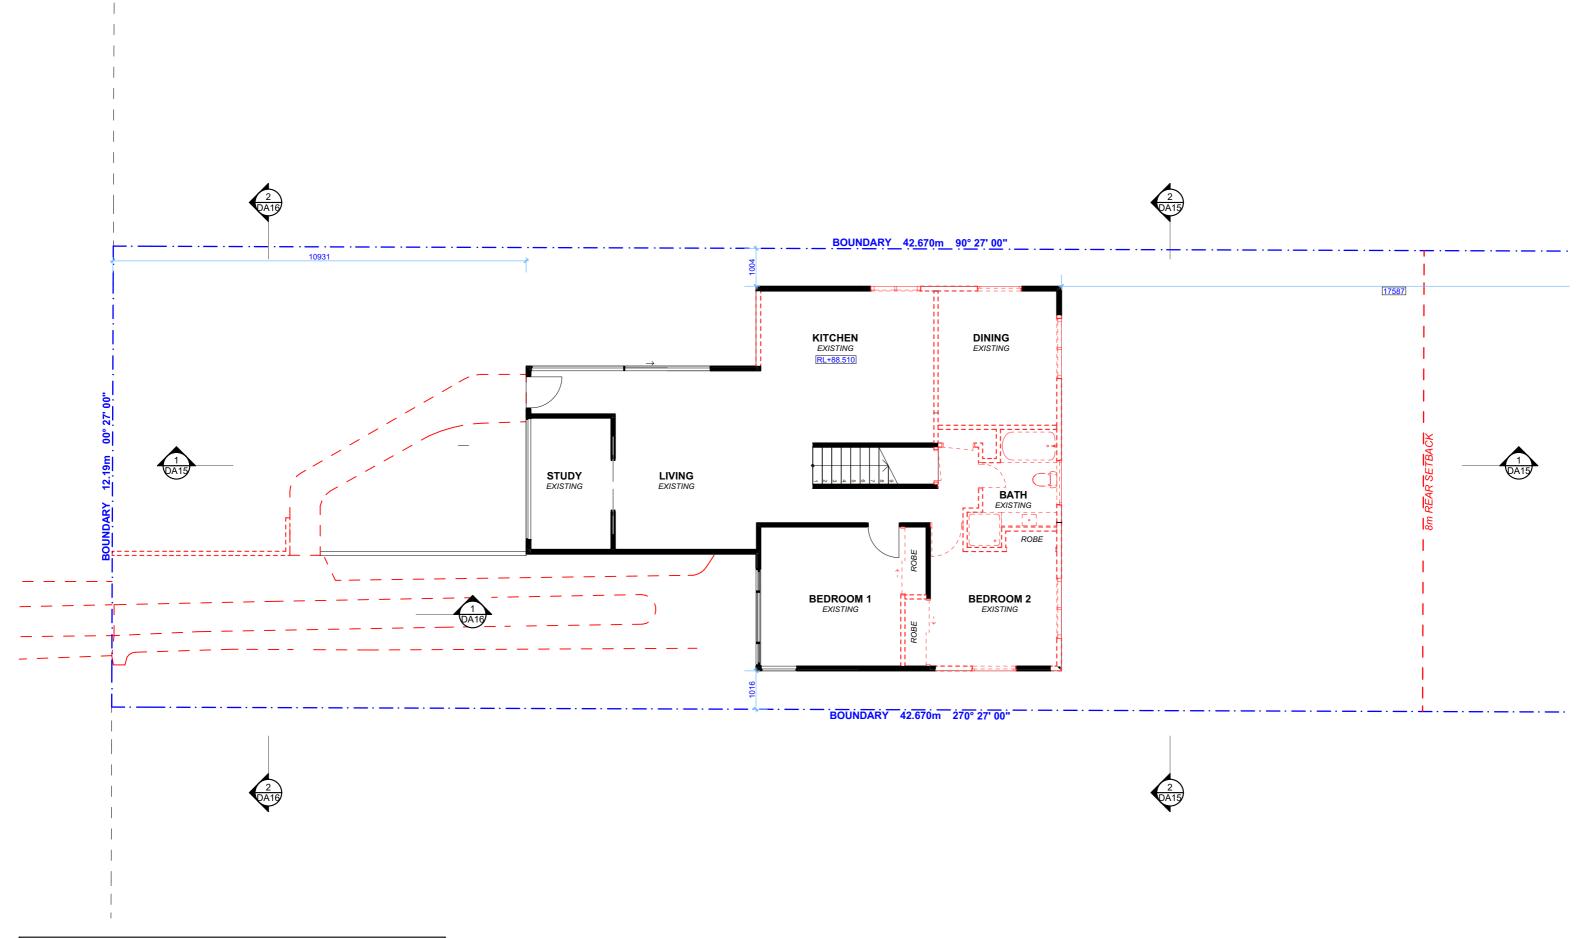


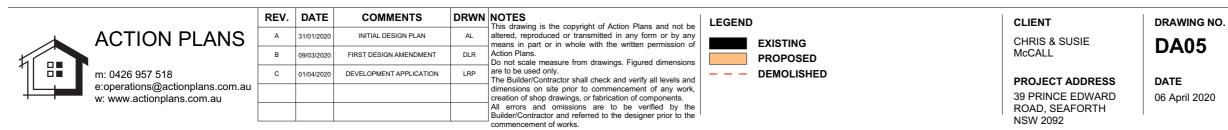





DRAWING NAME


EXISTING GROUND FLOOR PLAN

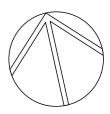


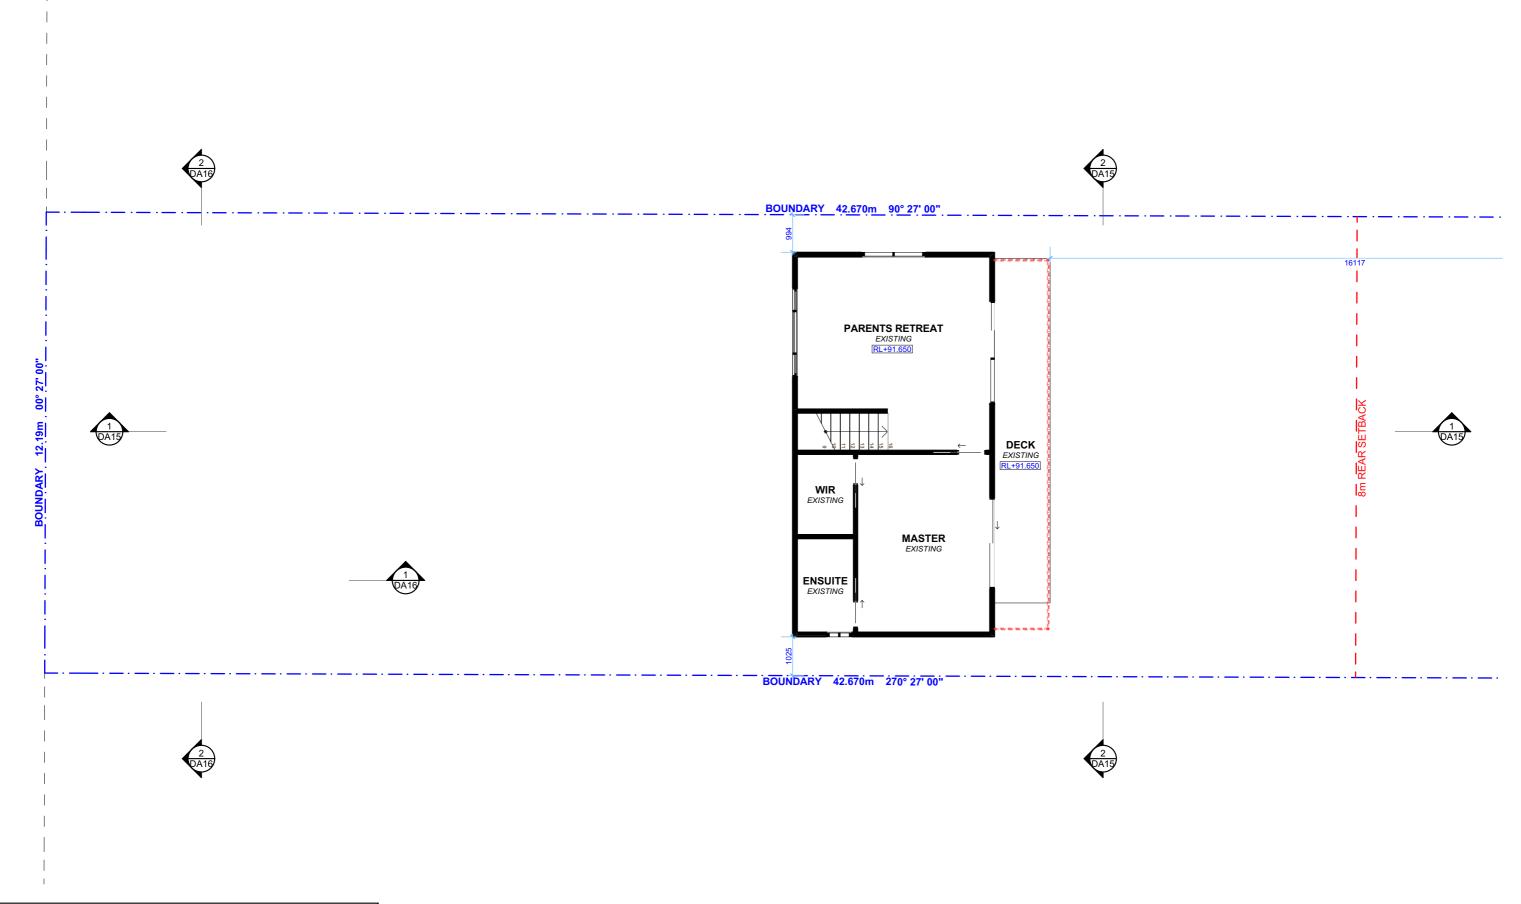

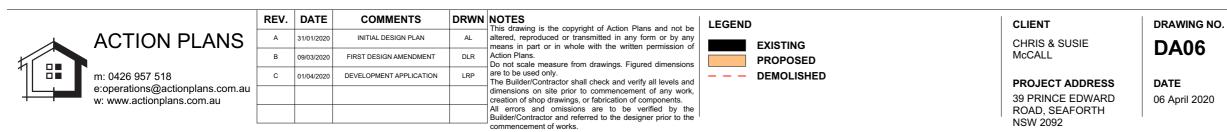

DRAWING NAME EXISTING FIRST FLOOR PLAN

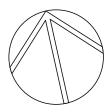

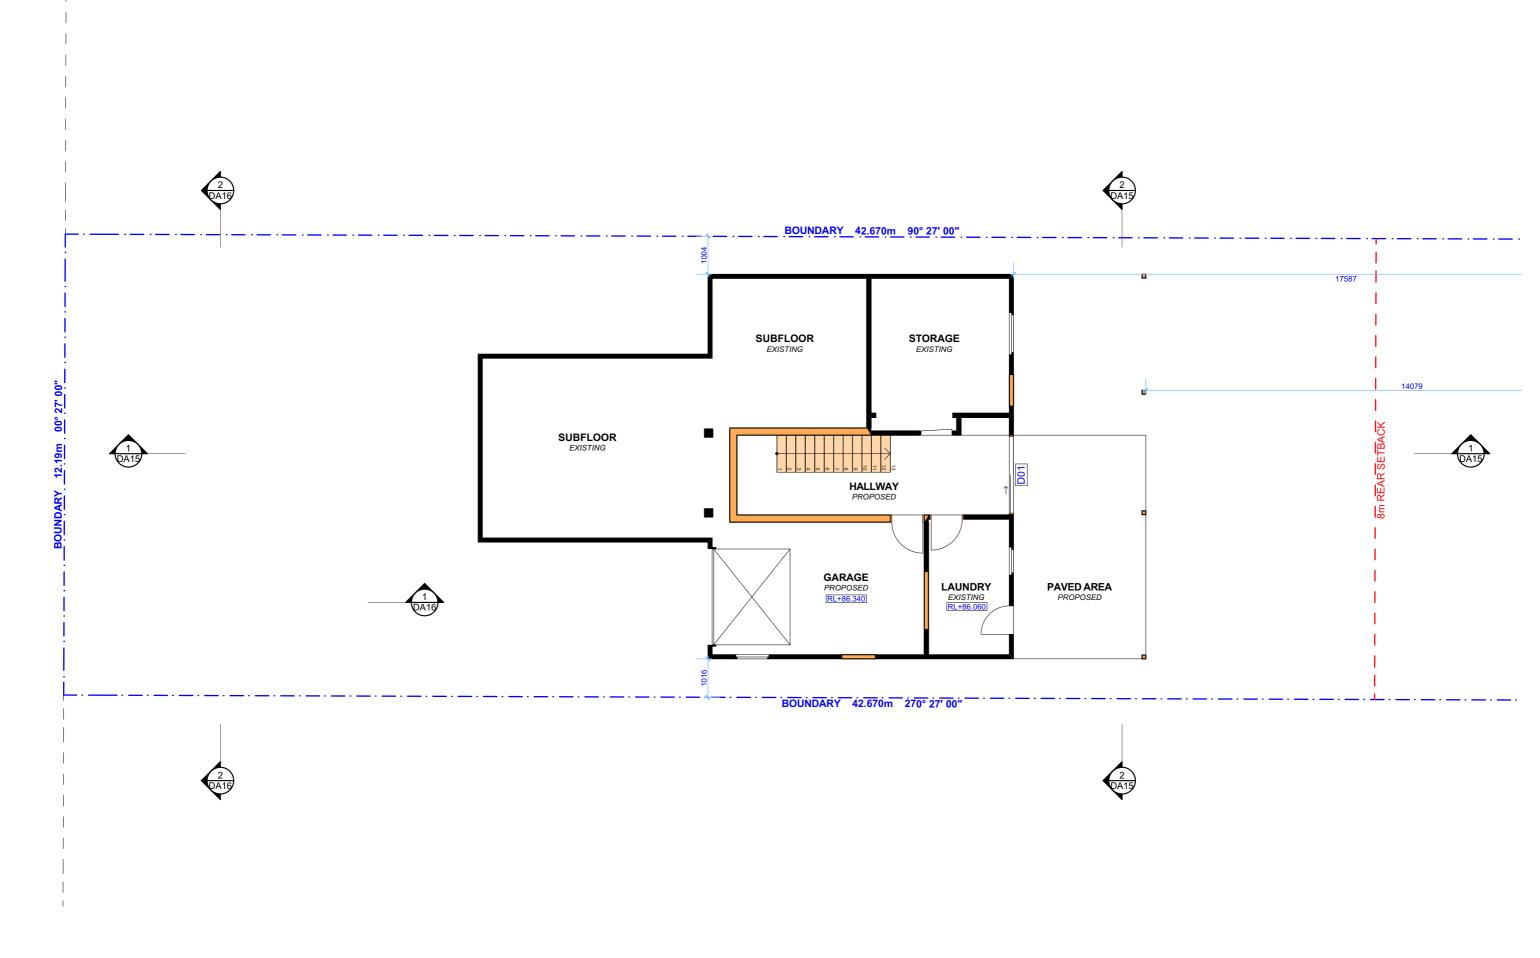


DATE	COMMENTS			LEGEND	CLIENT	DRAWING NO
31/01/2020	INITIAL DESIGN PLAN	AL	altered, reproduced or transmitted in any form or by any		CHRIS & SUSIE	DA07
09/03/2020	FIRST DESIGN AMENDMENT	DLR	Action Plans.	DROBOSED	McCALL	DAUT
01/04/2020	DEVELOPMENT APPLICATION	LRP	are to be used only.		PROJECT ADDRESS	DATE
			dimensions on site prior to commencement of any work, creation of shop drawings, or fabrication of components.		39 PRINCE EDWARD	06 April 2020
					ROAD, SEAFORTH	.
	31/01/2020 09/03/2020	31/01/2020 INITIAL DESIGN PLAN 09/03/2020 FIRST DESIGN AMENDMENT	31/01/2020 INITIAL DESIGN PLAN AL 09/03/2020 FIRST DESIGN AMENDMENT DLR 01/04/2020 DEVELOPMENT APPLICATION LRP	Initial design plan AL This drawing is the copyright of Action Plans and not be altered, reproduced or transmitted in any form or by any means in part or in whole with the written permission of Action Plans. 09/03/2020 FIRST DESIGN AMENDMENT DLR DLR Do not scale measure from drawings. Figured dimensions are to be used only. The Builder/Contractor shall check and verify all levels and dimensions on site prior to components. All errors and omissions are to be verified by the Builder/Contractor and referred to the designer prior to the	31/01/2020 INITIAL DESIGN PLAN AL This drawing is the copyright of Action Plans and not be altered, reproduced or transmitted in any form or by any means in part or in whole with the written permission of Action Plans. EEGEND 09/03/2020 FIRST DESIGN AMENDMENT DLR Do not scale measure from drawings. Figured dimensions are to be used only. Do not scale measure from drawings, or fabrication of components. PROPOSED 01/04/2020 DEVELOPMENT APPLICATION LRP The Builder/Contractor shall check and verify all levels and dimensions on site prior to commencement of any work, creation of shop drawings, or fabrication of components. All errors and omissions are to be verified by the Builder/Contractor and referred to the designer prior to the	INITIAL DESIGN PLAN AL This drawing is the copyright of Action Plans and not be altered, reproduced or transmitted in any form or by any means in part or in whole with the written permission of Action Plans. LEGEND CLIENT 09/03/2020 FIRST DESIGN AMENDMENT DLR AL Action Plans. Do not scale measure from drawings. Figured dimensions are to be used only. EXISTING CHRIS & SUSIE MCCALL 01/04/2020 DEVELOPMENT APPLICATION LRP The Builder/Contractor shall check and verify all levels and dimensions on site prior to commencement of any work, creation of shop drawings, or fabrication of components. PROPOSED PROJECT ADDRESS 39 PRINCE EDWARD ROAD, SEAFORTH

VING NO.

DRAWING NAME

PROPOSED GARAGE FLOOR PLAN

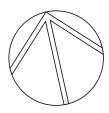




		REV.	DATE	COMMENTS	DRWN	NOTES This drawing is the copyright of Action Plans and not be	CLIENT	DRAWI
	ACTION PLANS	A	31/01/2020	INITIAL DESIGN PLAN	AL	altered, reproduced or transmitted in any form or by any means in part or in whole with the written permission of EXISTING	CHRIS & SUSIE	DAC
		в	09/03/2020	FIRST DESIGN AMENDMENT	DLR	Action Plans. Do not scale measure from drawings. Figured dimensions PROPOSED PROPOSED	McCALL	DAU
	m: 0426 957 518	с	01/04/2020	DEVELOPMENT APPLICATION	LRP	are to be used only. The Builder/Contractor shall check and verify all levels and	PROJECT ADDRESS	DATE
┦╧═╊━━┛	e:operations@actionplans.com.au w: www.actionplans.com.au					dimensions on site prior to commencement of any work, creation of shop drawings, or fabrication of components. All errors and omissions are to be verified by the Builder/Contractor and referred to the designer prior to the commencement of works.	39 PRINCE EDWARD ROAD, SEAFORTH NSW 2092	06 April

WING NO. DR. 408 PRI PLA

DRAWING NAME PROPOSED GROUND FLOOR PLAN

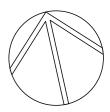

pril 2020





	REV.	DATE	COMMENTS	DRWN	OTES is drawing is the copyright of Action Plans and not be LEGEND	CLIENT	DRAWING NO
ACTION PLANS	А	31/01/2020	INITIAL DESIGN PLAN	AL	ered, reproduced or transmitted in any form or by any ans in part or in whole with the written permission of	CHRIS & SUSIE	DA09
	в	09/03/2020	FIRST DESIGN AMENDMENT	DLR	tion Plans. prot scale measure from drawings. Figured dimensions PROPOSED	McCALL	DAUS
□■ m: 0426 957 518	С	01/04/2020	DEVELOPMENT APPLICATION	IRP	e to be used only. e Builder/Contractor shall check and verify all levels and DEMOLISHED	PROJECT ADDRESS	DATE
e:operations@actionplans.com.au					nensions on site prior to commencement of any work, eation of shop drawings, or fabrication of components. errors and omissions are to be verified by the uilder/Contractor and referred to the designer prior to the mmencement of works.	39 PRINCE EDWARD ROAD, SEAFORTH NSW 2092	06 April 2020


VING NO.

DRAWING NAME

PROPOSED FIRST FLOOR PLAN

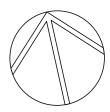

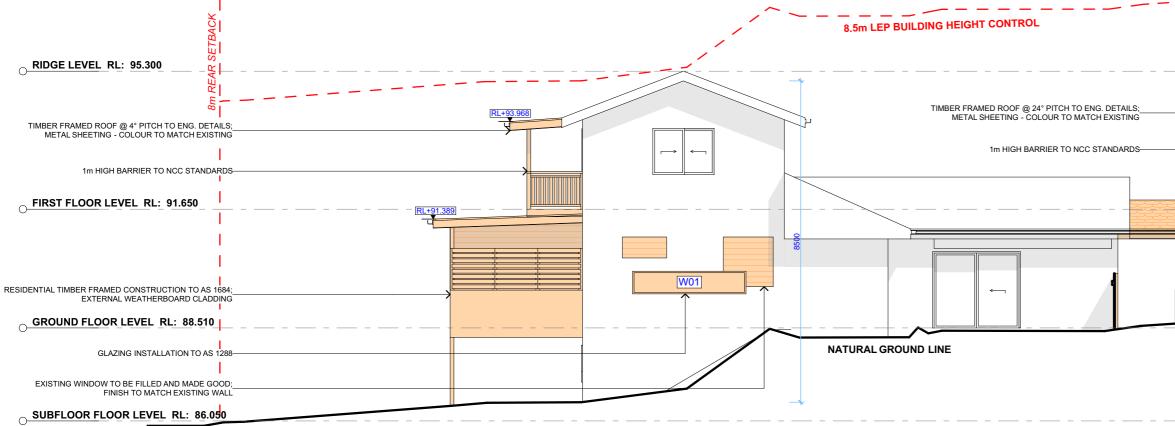

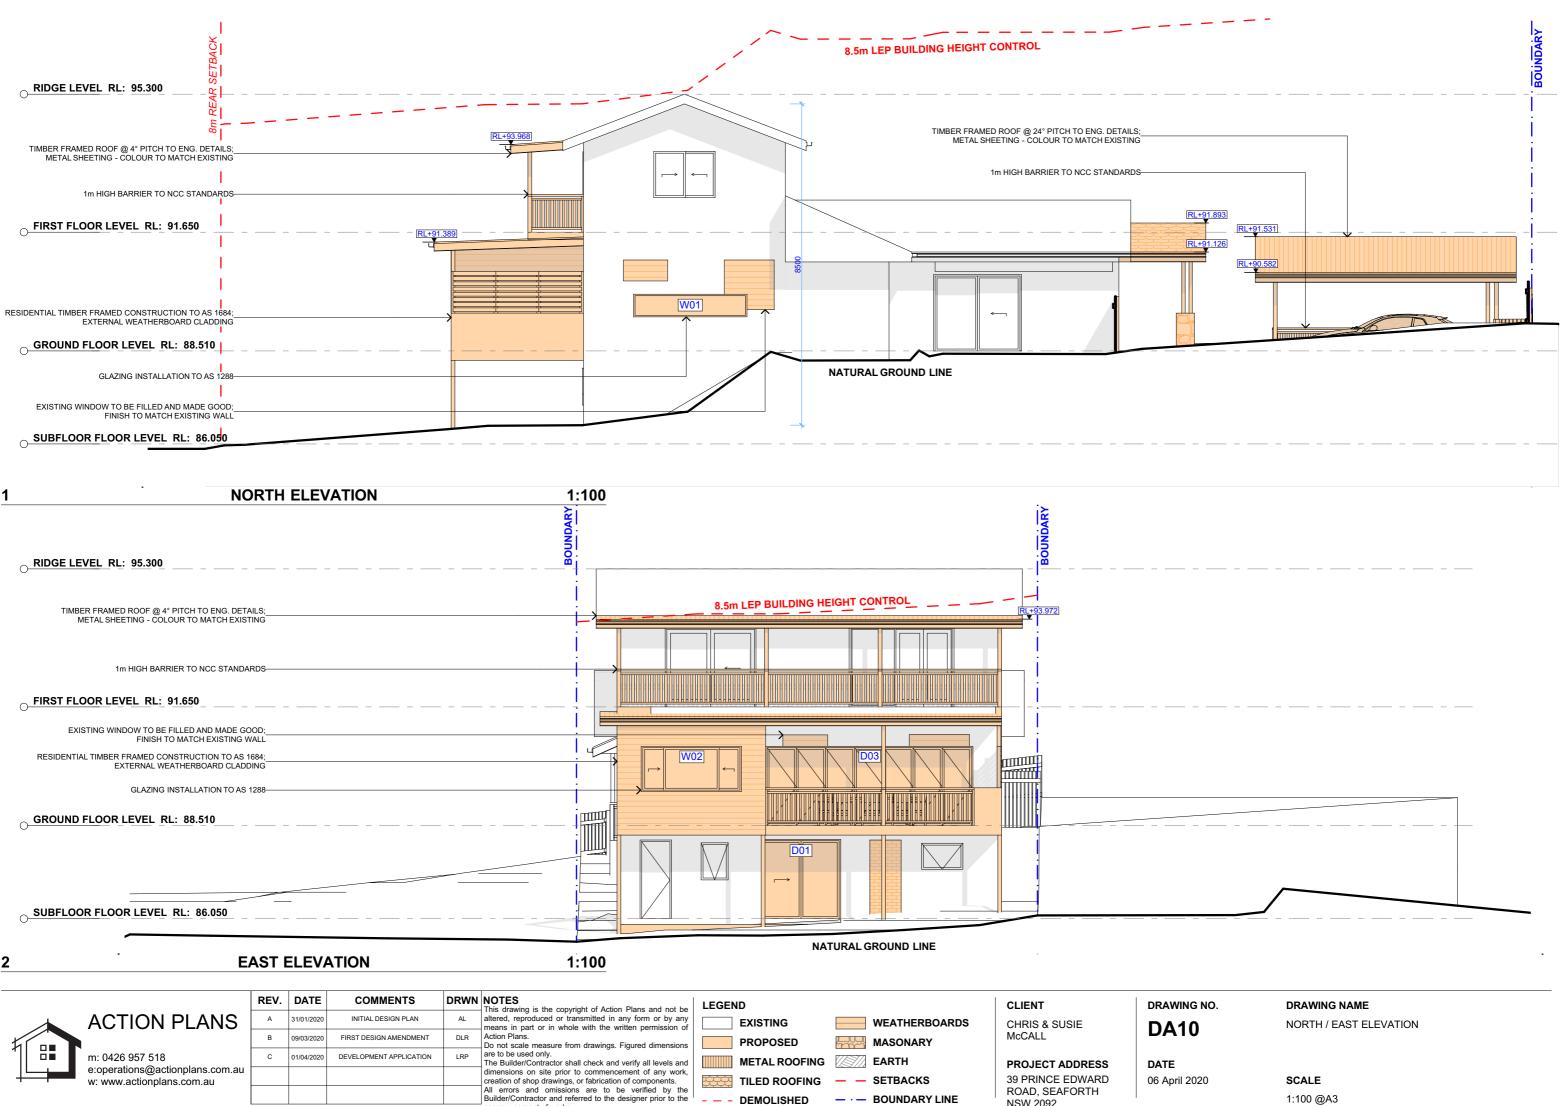



DEMOLISHED

NSW 2092

commencement of works.

1:100 @A3

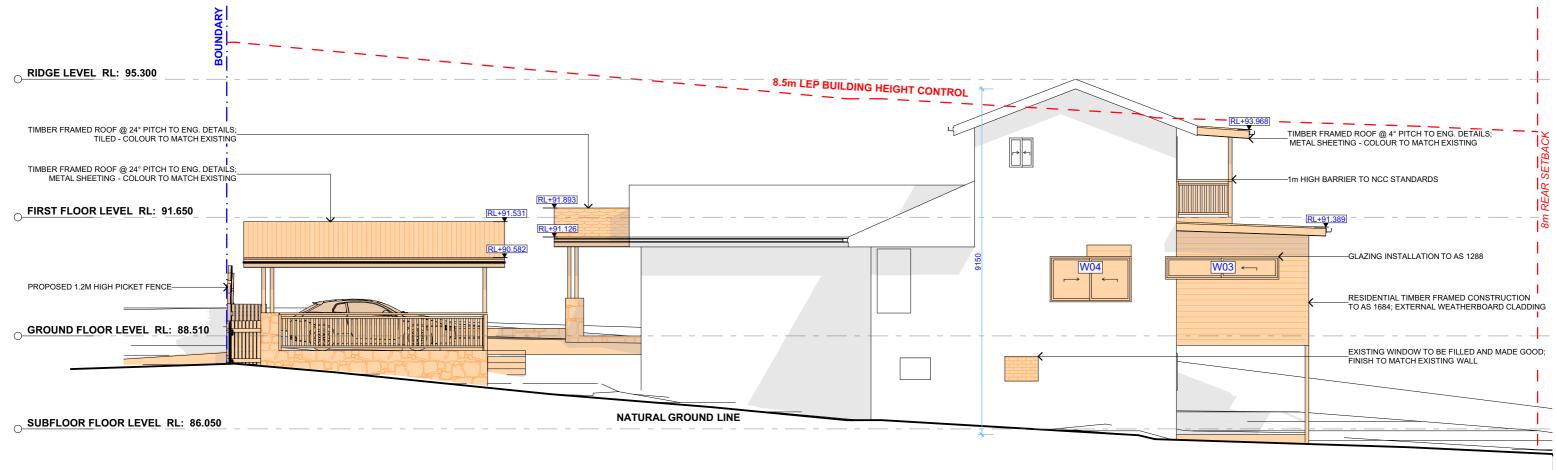

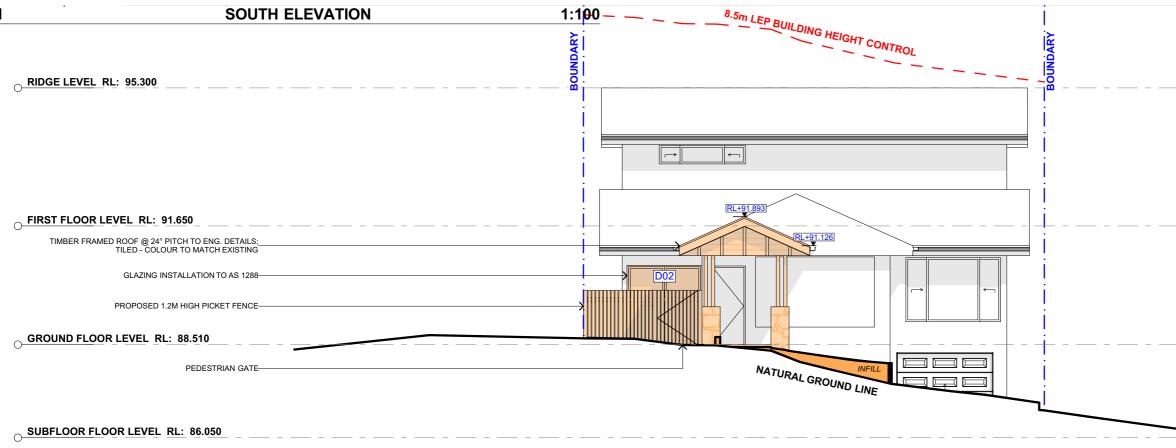

WEST ELEVATION

2


1:100

		REV.	DATE	COMMENTS		NOTES This drawing is the copyright of Action Plans and not be	LEGEND		CLIENT	DRAWING
	ACTION PLANS	A	31/01/2020	INITIAL DESIGN PLAN	AL	altered, reproduced or transmitted in any form or by any means in part or in whole with the written permission of	EXISTING	WEATHERBOARDS	CHRIS & SUSIE	DA11
5		В	09/03/2020	FIRST DESIGN AMENDMENT	DLR	Action Plans. Do not scale measure from drawings. Figured dimensions	PROPOSED	MASONARY	McCALL	DAII
1	m: 0426 957 518	с	01/04/2020	DEVELOPMENT APPLICATION	LRP	are to be used only. The Builder/Contractor shall check and verify all levels and	METAL ROOFING	EARTH	PROJECT ADDRESS	DATE
┦┕	e:operations@actionplans.com.au w: www.actionplans.com.au					dimensions on site prior to commencement of any work, creation of shop drawings, or fabrication of components.		— — SETBACKS	39 PRINCE EDWARD	06 April 20
						All errors and omissions are to be verified by the Builder/Contractor and referred to the designer prior to the commencement of works.	DEMOLISHED	- · - BOUNDARY LINE	ROAD, SEAFORTH NSW 2092	



DRAWING NAME SOUTH / WEST ELEVATION

2020

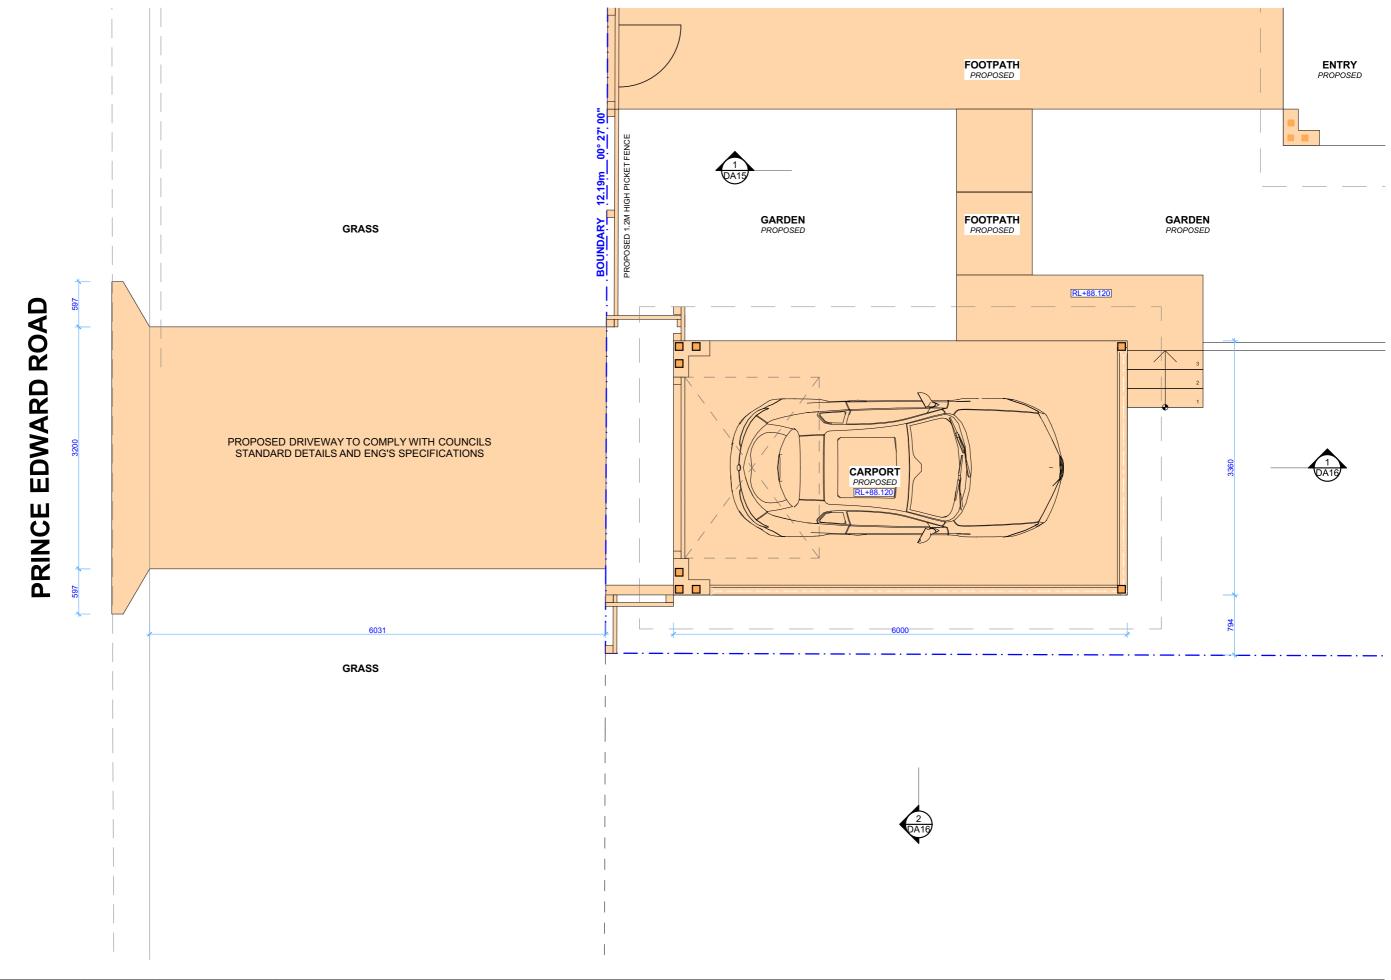



1 QA16

	REV.	DATE	COMMENTS	DRWN	NOTES This drawing is the copyright of Action Plans and not be	LEGEND)	(CLIENT
NS	А	31/01/2020	INITIAL DESIGN PLAN	AL	altered, reproduced or transmitted in any form or by any means in part or in whole with the written permission of		EXISTING	C	CHRIS & SUSIE
	в	09/03/2020	FIRST DESIGN AMENDMENT	DLR	Action Plans. Do not scale measure from drawings. Figured dimensions		PROPOSED	N	McCALL
	с	01/04/2020	DEVELOPMENT APPLICATION	LRP	are to be used only. The Builder/Contractor shall check and verify all levels and		DEMOLISHED	F	PROJECT ADDRESS
com.au					dimensions on site prior to commencement of any work, creation of shop drawings, or fabrication of components.			-	39 PRINCE EDWARD
1					All errors and omissions are to be verified by the Builder/Contractor and referred to the designer prior to the commencement of works.			F	ROAD, SEAFORTH NSW 2092




06 April 2020

DRAWING NO.


DA12

DATE

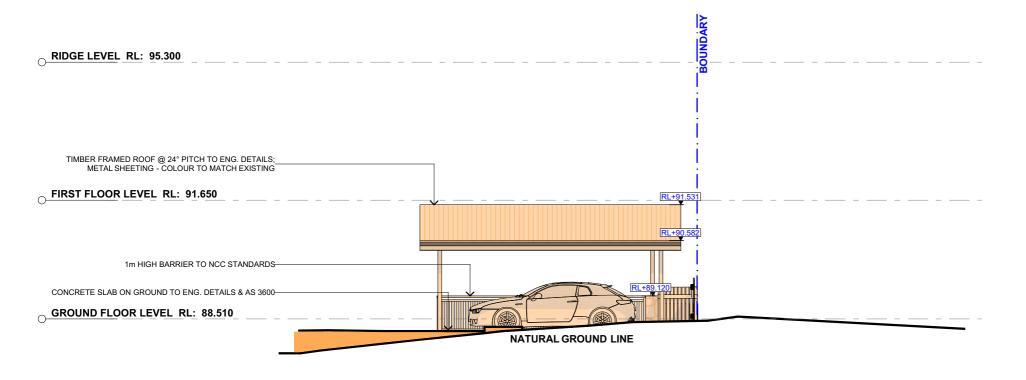


O SUBFLOOR FLOOR LEVEL RL: 86.050

2

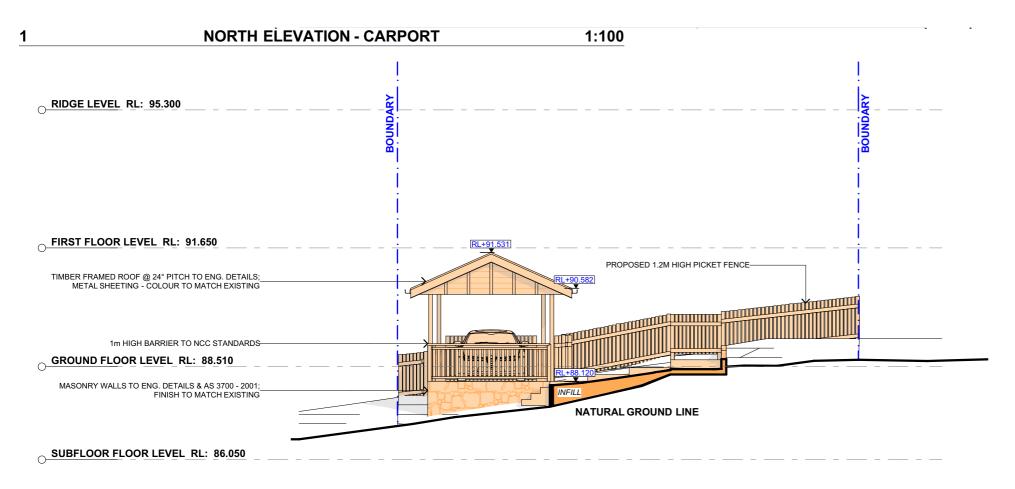


EAST ELEVATION - CARPORT

1:100

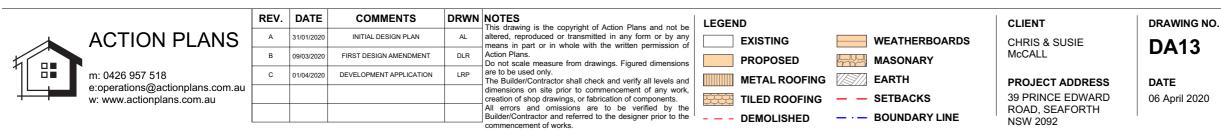



DRAWING NAME

NORTH / EAST ELEVATION -CARPORT

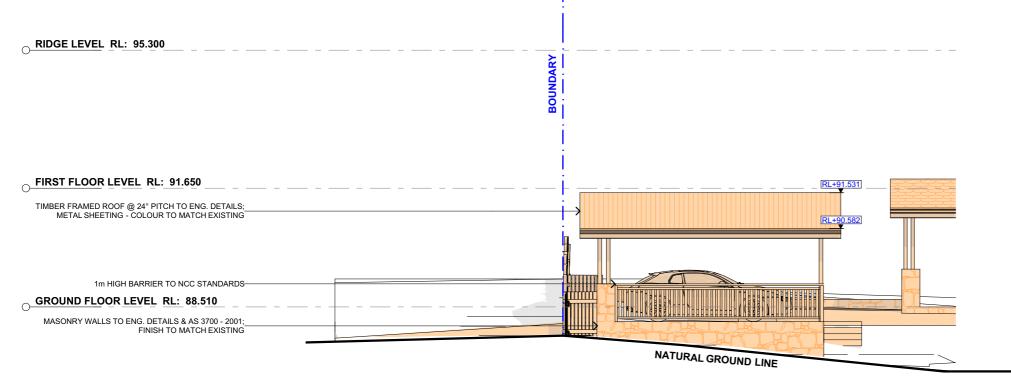


O SUBFLOOR FLOOR LEVEL RL: 86.050

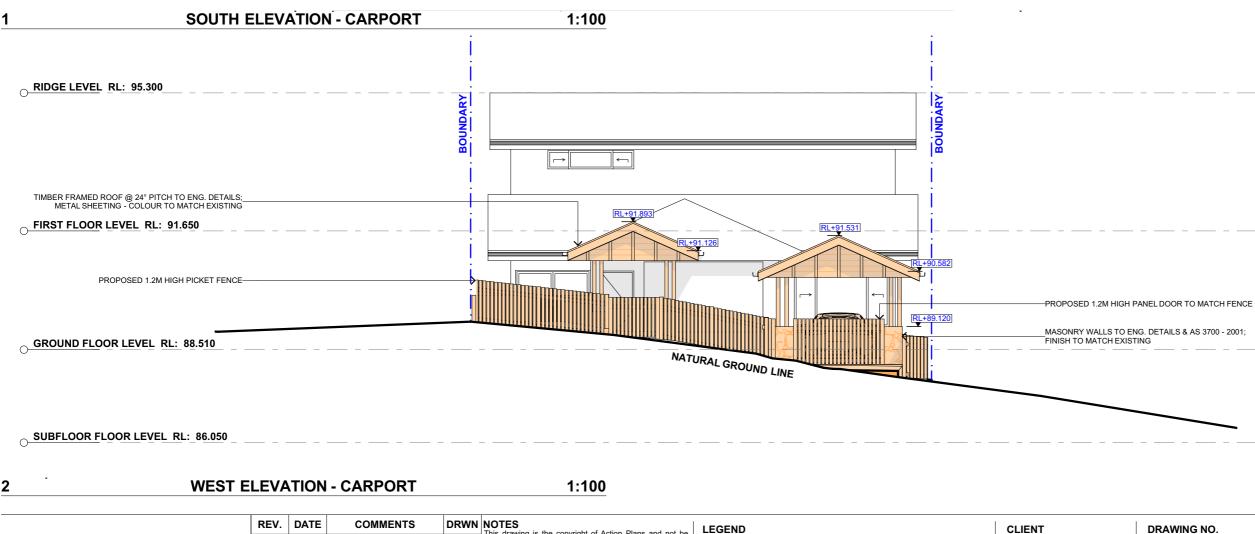


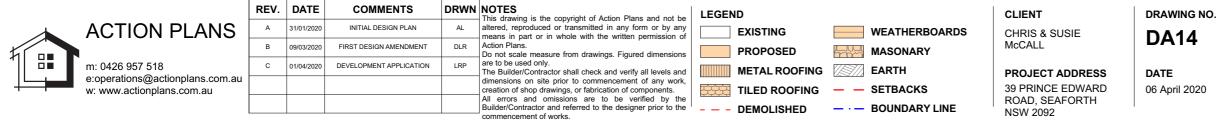


DRAWING NAME


SOUTH / WEST ELEVATION -CARPORT

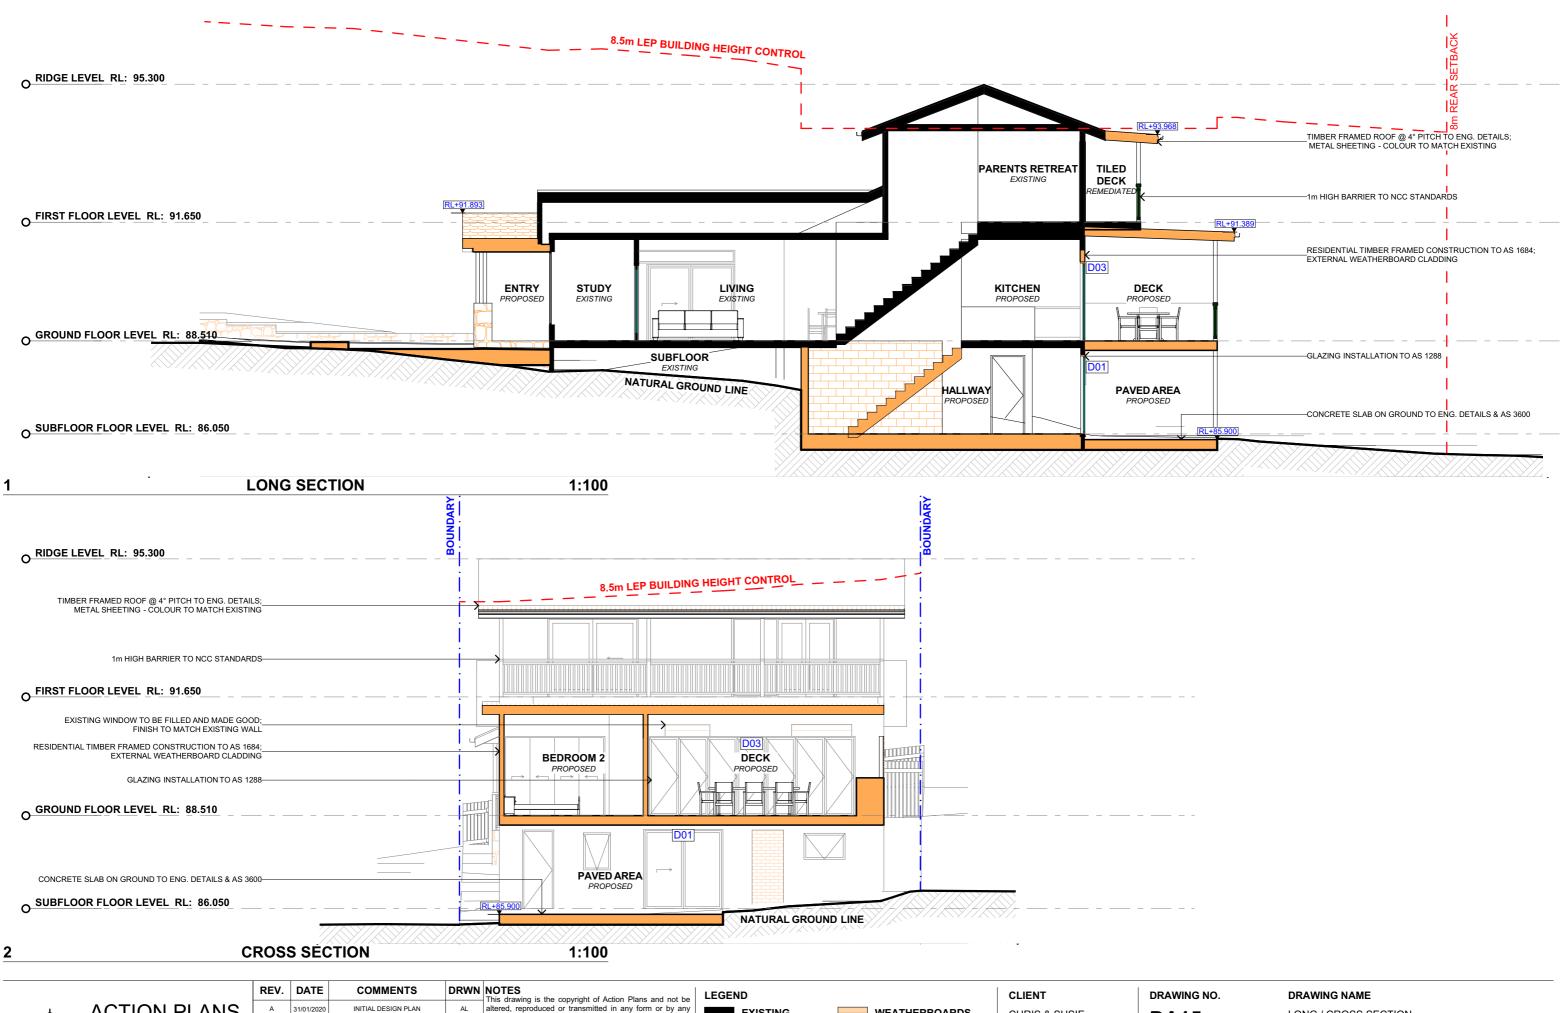

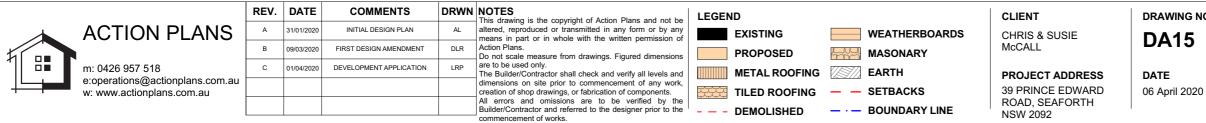

LONG / CROSS SECTION

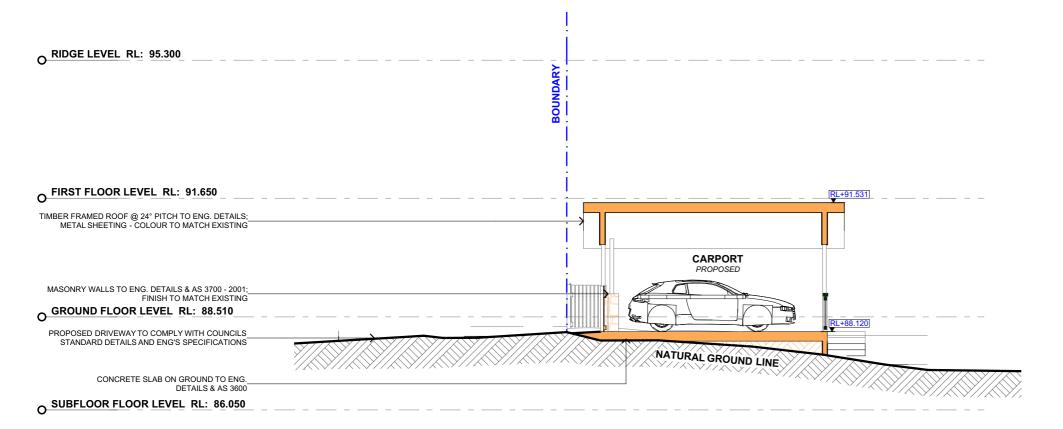


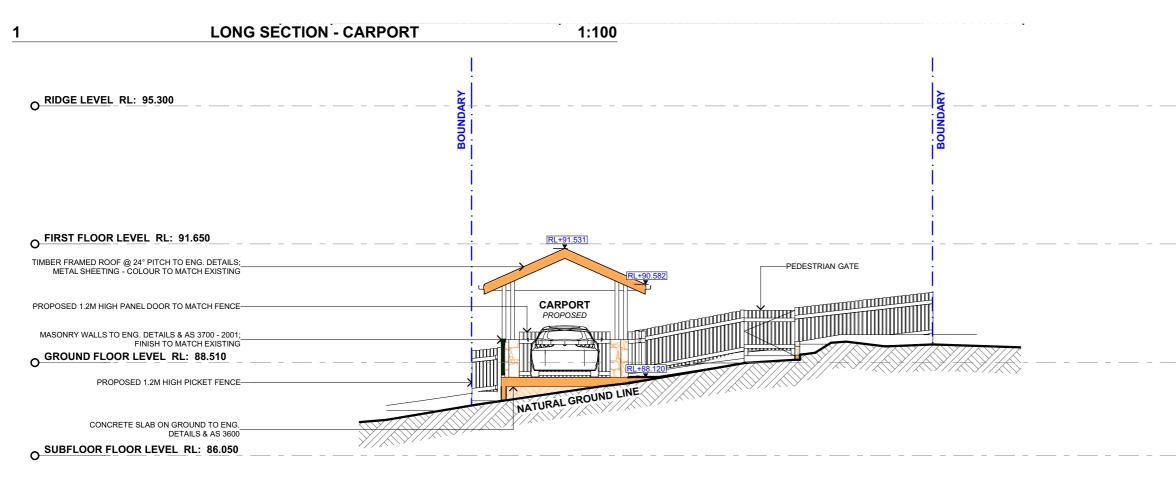


CROSS SECTION - CARPORT

2

1:100

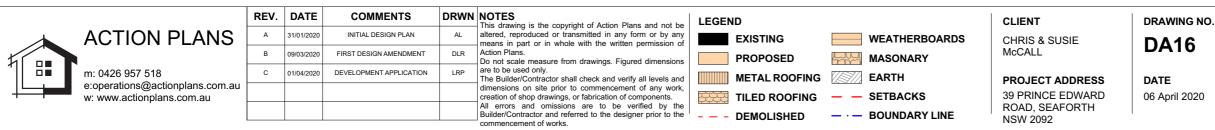

DRAWING NAME DRIVEWAY LONG / CROSS SECTION

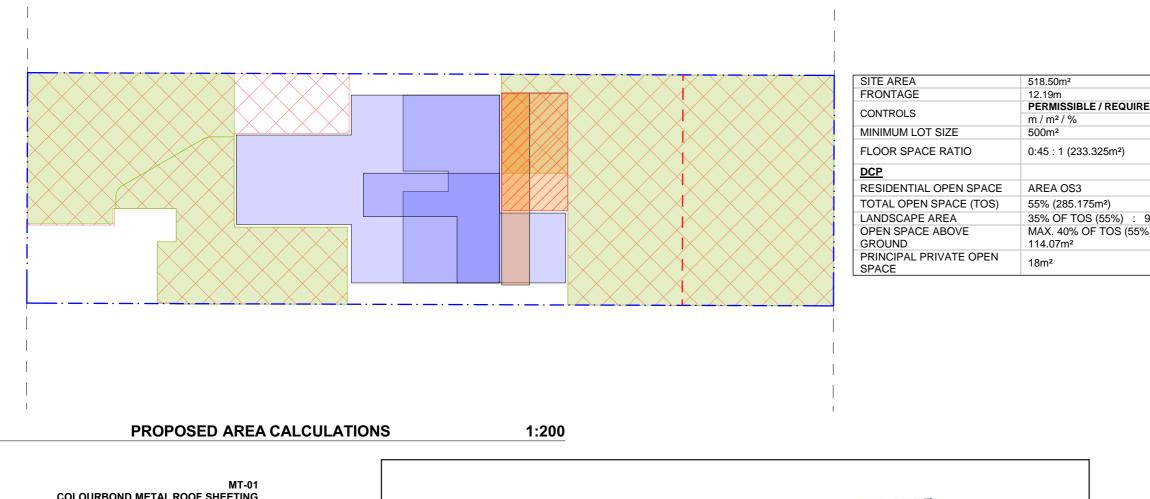



SAMPLE BOARD

2

		REV.	DATE	COMMENTS		NOTES This drawing is the copyright of Action Plans and not be	LEGEND	CLIENT	DRAWING
	ACTION PLANS	A	31/01/2020	INITIAL DESIGN PLAN	AL	altered, reproduced or transmitted in any form or by any means in part or in whole with the written permission of	FLOOR SPACE RATIO	CHRIS & SUSIE	DA17
Г		В	09/03/2020	FIRST DESIGN AMENDMENT	DLR	Action Plans. Do not scale measure from drawings. Figured dimensions	LANDSCAPED AREA	McCALL	DAT
1	m: 0426 957 518	с	01/04/2020	DEVELOPMENT APPLICATION	LRP	are to be used only. The Builder/Contractor shall check and verify all levels and	OPEN SPACE ABOVE GROUND	PROJECT ADDRESS	DATE
+	e:operations@actionplans.com.au w: www.actionplans.com.au					dimensions on site prior to commencement of any work, creation of shop drawings, or fabrication of components.	TOTAL OPEN SPACE	39 PRINCE EDWARD	06 April 202
						All errors and omissions are to be verified by the Builder/Contractor and referred to the designer prior to the commencement of works.	PRIVATE OPEN SPACE	ROAD, SEAFORTH NSW 2092	


RED	EXISTING	PROPOSED	COMPLIANCE
	m / m² / %	m / m² / %	
	518.50m ²	UNCHANGED	YES
	0.31 : 1 (162.03m ²)	0.37 : 1 (191.96m ²)	YES
	392.52m² (75%)	334.5m² (64%)	YES
99.81m ²	280.34m ²	314.93m ²	YES
%) :	13.40m ²	31.72m ²	YES
	0m²	21.84m ²	YES

ASD ALUMINIUM BIFOLD DOOR FRAME POWDERCOAT FINISH 'BLACK' OR SIMILAR WHERE MARKED ON ELEVATION.


NG NO.

DRAWING NAME

AREA CALCULATIONS / SAMPLE BOARD

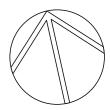


2020

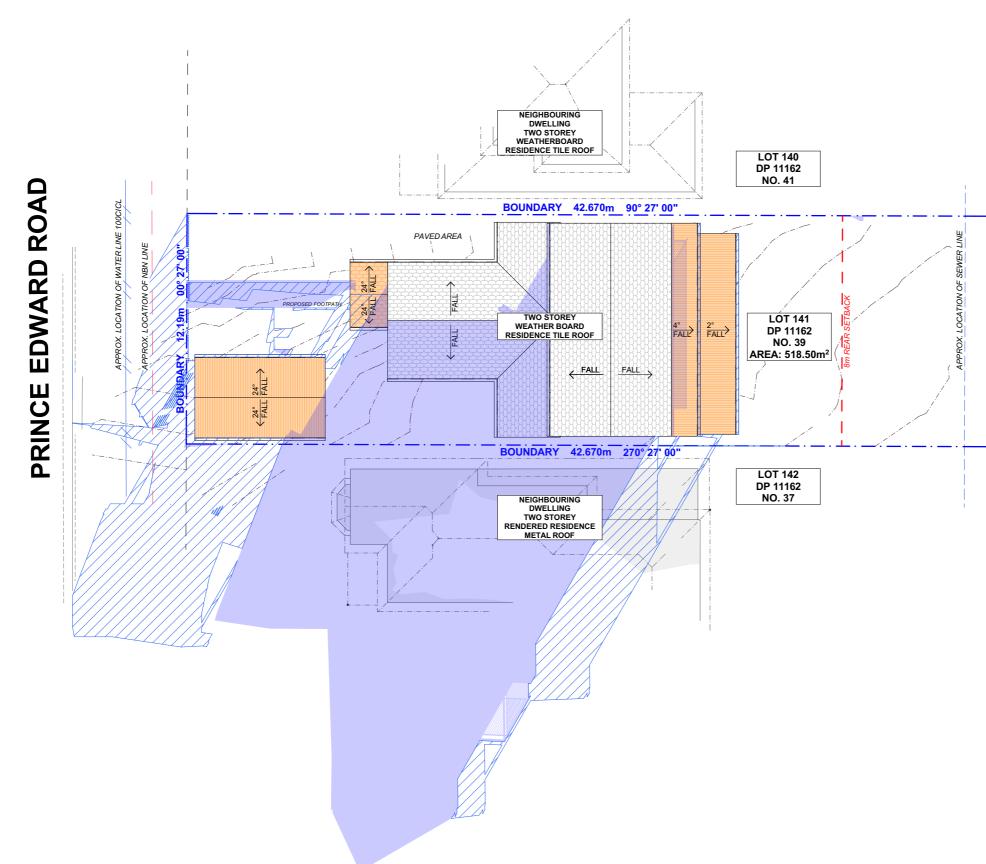


		REV.	DATE	COMMENTS	DRWN	NOTES This drawing is the copyright of Action Plans and not be	LEGEND		CLIENT	DRAWI
	ACTION PLANS m: 0426 957 518 e:operations@actionplans.com.au w: www.actionplans.com.au	А	31/01/2020	INITIAL DESIGN PLAN	AL	altered, reproduced or transmitted in any form or by any means in part or in whole with the written permission of		EXISTING SHADOWS	CHRIS & SUSIE McCALL	DA1
		в	09/03/2020	FIRST DESIGN AMENDMENT	DLR	Action Plans. Do not scale measure from drawings. Figured dimensions		PROPOSED SHADOWS		DAI
		с	01/04/2020	DEVELOPMENT APPLICATION	LRP	are to be used only. The Builder/Contractor shall check and verify all levels and		NEIGHBOURING SHADOWS	PROJECT ADDRESS	DATE
						dimensions on site prior to commencement of any work, creation of shop drawings, or fabrication of components. All errors and omissions are to be verified by the Builder/Contractor and referred to the designer prior to the			39 PRINCE EDWARD ROAD, SEAFORTH NSW 2092	06 April
						commencement of works.			11311 2092	

wing no. **\18** **DRAWING NAME** WINTER SOLSTICE 9 AM



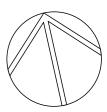


pril 2020

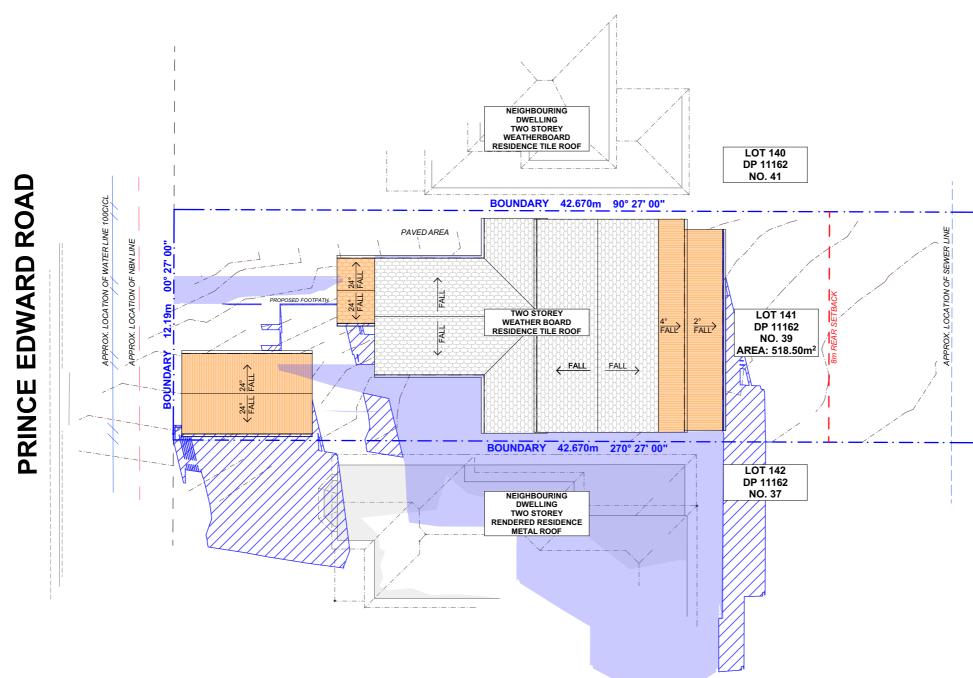


		REV.	DATE	COMMENTS	DRWN	NOTES This drawing is the copyright of Action Plans and not be	ND	CLIENT	DRAWING
	ACTION PLANS	А	31/01/2020	INITIAL DESIGN PLAN	AL	altered, reproduced or transmitted in any form or by any means in part or in whole with the written permission of	EXISTING SHADOWS	CHRIS & SUSIE	DA19
		В	09/03/2020	FIRST DESIGN AMENDMENT	DLR	Action Plans. Do not scale measure from drawings. Figured dimensions	PROPOSED SHADOWS	McCALL	DAT
	m: 0426 957 518	с	01/04/2020	DEVELOPMENT APPLICATION	LRP	are to be used only. The Builder/Contractor shall check and verify all levels and	NEIGHBOURING SHADOWS	PROJECT ADDRESS	DATE
	e:operations@actionplans.com.au w: www.actionplans.com.au					dimensions on site prior to commencement of any work, creation of shop drawings, or fabrication of components. All errors and omissions are to be verified by the Builder/Contractor and referred to the designer prior to the commencement of works.		39 PRINCE EDWARD ROAD, SEAFORTH NSW 2092	06 April 20

ing no. **19** DRAWING NAME WINTER SOLSTICE 12 PM



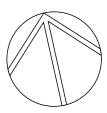

I 2020

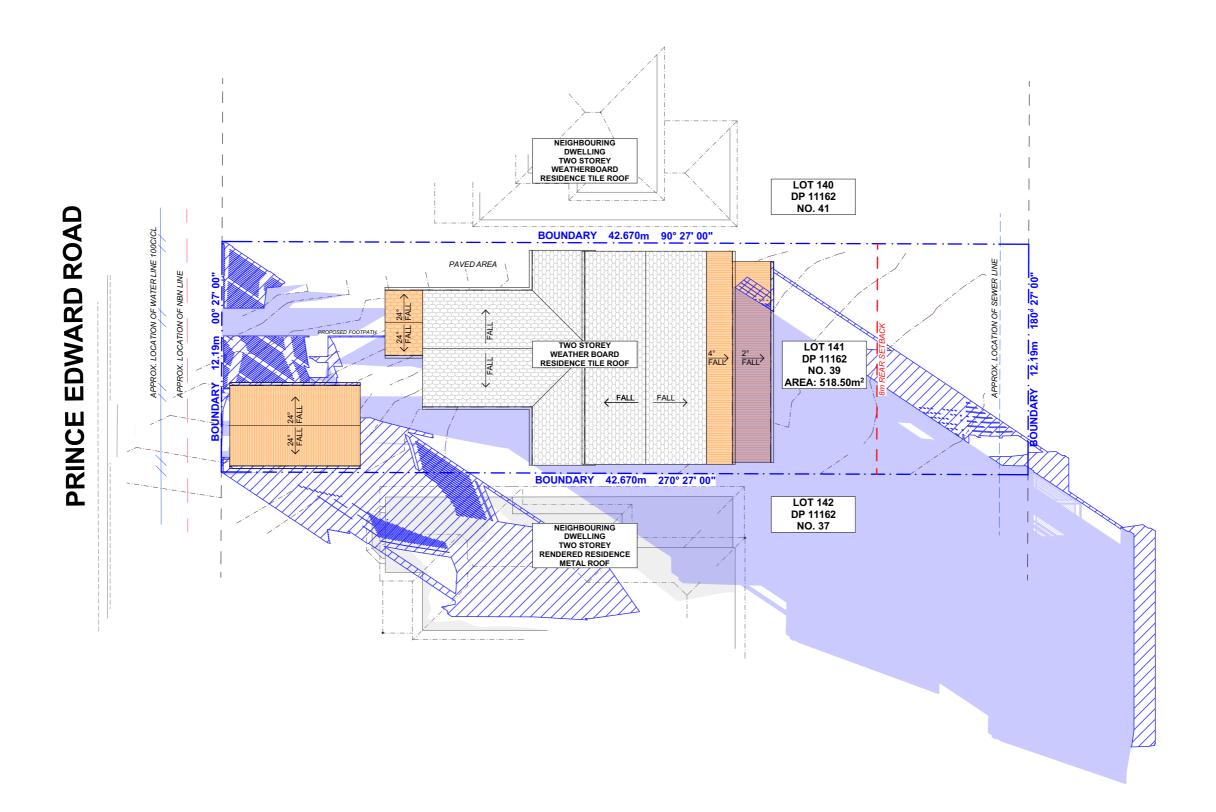


		REV.	DATE	COMMENTS		NOTES This drawing is the copyright of Action Plans and not be	LEGEND		CLIENT	DRAWING
AC	TION PLANS	А	31/01/2020	INITIAL DESIGN PLAN	AL	altered, reproduced or transmitted in any form or by any means in part or in whole with the written permission of		EXISTING SHADOWS	CHRIS & SUSIE	DA2
		в	09/03/2020	FIRST DESIGN AMENDMENT	DLR	Action Plans. Do not scale measure from drawings. Figured dimensions		PROPOSED SHADOWS	McCALL	DAZ
	26 957 518	С	01/04/2020	DEVELOPMENT APPLICATION	LRP	are to be used only. The Builder/Contractor shall check and verify all levels and		NEIGHBOURING SHADOWS	PROJECT ADDRESS	DATE
	ations@actionplans.com.au w.actionplans.com.au					dimensions on site prior to commencement of any work, creation of shop drawings, or fabrication of components. All errors and omissions are to be verified by the Builder/Contractor and referred to the designer prior to the commencement of works.			39 PRINCE EDWARD ROAD, SEAFORTH NSW 2092	06 April 20

VING NO.

DRAWING NAME

WINTER SOLSTICE 3 PM

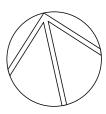

I 2020

page 2 / 6

page 3 / 6

page 6 / 6

BASIX[°]Certificate

Building Sustainability Index www.basix.nsw.gov.au

Secretary Date of issue: Wednesday, 01, April 2020 To be valid, this certificate must be lodged within 3 months of the date of issue.

Alterations and Additions

Certificate number: A373780

This certificate confirms that the proposed development will meet the NSW government's requirements for sustainability, if it is built in accordance with the commitments set out below. Terms used in this certificate, or in the commitments, have the meaning given by the document entitled "BASIX Alterations and Additions Definitions" dated 06/10/2017 published by the Department. This document is available at www.basix.nsw.gov.au



	Planning,
	Industry &
NSW	
GOVERNMENT	Environment

t	Project address								
Ð	Project name	39 PRINCE EDWARD ROAD, SEAFORTH							
īoj	Street address	39 PRINCE EDWARD Road SEAFORTH 2092							
ĭ	Local Government Area	Northern Beaches Council							
D	Plan type and number	Deposited Plan 11162							
4	Lot number	141							
0	Section number								
2	Project type								
<u>.</u>	Dwelling type	Separate dwelling house							
ripti	Type of alteration and addition	My renovation work is valued at \$50,000 or more, and does not include a pool (and/or spa).							
Desci									

Certificate Prepared by (please complete before submitting to Council or PCA)
Name / Company Name: Action Plans
ABN (if applicable): 17118297587

BASIX Certificate number: A373780

Fixtures and systems	Show on DA Plans	Show on CC/CDC Plans & specs	Certifier Check
Lighting			
The applicant must ensure a minimum of 40% of new or altered light fixtures are fitted with fluorescent, compact fluorescent, or light-emitting-diode (LED) lamps.		~	~
Fixtures			
The applicant must ensure new or altered showerheads have a flow rate no greater than 9 litres per minute or a 3 star water rating.		\checkmark	\checkmark
The applicant must ensure new or altered toilets have a flow rate no greater than 4 litres per average flush or a minimum 3 star water rating.		\checkmark	\checkmark
The applicant must ensure new or altered taps have a flow rate no greater than 9 litres per minute or minimum 3 star water rating.		\checkmark	

BASIX Certificate number: A373780

Construction			Show on DA Plans	Show on CC/CDC Plans & specs	Certifier Check
Insulation requirements					
The applicant must construct the new or altere the table below, except that a) additional insula is not required for parts of altered construction Construction	~	~	~		
floor above existing dwelling or building.	nil				
external wall: framed (weatherboard, fibro, metal clad)	R1.30 (or R1.70 including construction)				

BASIX Certificate number: A373780

Legend

In these commitments, "applicant" means the person carrying out the development.
Commitments identified with a "
development application is to be lodged for the proposed development).
Commitments identified with a "\" in the "Show on CC/CDC plans & specs" column must be shown in the plans and specifications accompanying the application for a construction certificate / complying development certificate for the proposed development.

Commitments identified with a "v" in the "Certifier check" column must be certified by a certifying authority as having been fulfilled, before a final occupation certificate for the development may be issued.

		REV.	DATE	COMMENTS	DRWN	NOTES This drawing is the copyright of Action Plans and not be altered, reproduced or transmitted in any form or by any means in part or in	CLIENT	DRAWING NO
	ACTION PLANS	A	31/01/2020	INITIAL DESIGN PLAN	AL	whole with the written permission of Action Plans. Do not scale measure from drawings. Figured dimensions are to be used only.	CHRIS & SUSIE	DA21
				McCALL	DAZI			
	m: 0426 957 518 e:operations@actionplans.com.au w: www.actionplans.com.au	с		PROJECT ADDRESS	DATE			
						rson prior to the ordering of any such materials are to take place. _/ alue takes precedence over glazing type/colour in all cases. new glazing must meet the BASIX specified frame and glass type, <u>OR</u> meet the ecified U value and SHGC value.	39 PRINCE EDWARD ROAD. SEAFORTH	06 April 2020
							NSW 2092	1

Glazing	requirements

Glazing re	equirements						Show on DA Plans	Show on CC/CDC Plans & specs	Certifier Check
Windows	and glazed d	oors							
	ant must install t vershadowing s	~	\checkmark	~					
The followir	ng requirements			\checkmark	\checkmark				
have a U-va must be ca	alue and a Sola	ar glazing, or toned/air gap/clear glazing must le below. Total system U-values and SHGCs s. The description is provided for information		~	~				
					f each eave, pergola, verandah, bal than 2400 mm above the sill.	cony or awning must be no more than 500 mm	\checkmark	\checkmark	\checkmark
Pergolas w	vith polycarbonat	te roof or s	imilar tran	slucent mate	erial must have a shading coefficien	t of less than 0.35.		~	\checkmark
					e window or glazed door above whice ons must not be more than 50 mm.	ch they are situated, unless the pergola also	-	~	~
	s and glazed			<u> </u>					
Window / c no.	door Orientation	n Area of glass inc. frame (m2)	Oversha Height (m)	dowing Distance (m)	Shading device	Frame and glass type			
W01	N	1.8	0	0	eave/verandah/pergola/balcony >=600 mm	standard aluminium, single pyrolytic low-e, (U-value: 5.7, SHGC: 0.47)			
W02	E	3.18	0	0	eave/verandah/pergola/balcony >=600 mm	standard aluminium, single pyrolytic low-e, (U-value: 5.7, SHGC: 0.47)			
W03	S	1.8	0	0	eave/verandah/pergola/balcony >=600 mm	standard aluminium, single pyrolytic low-e, (U-value: 5.7, SHGC: 0.47)			
W04	S	2.58	0	0	eave/verandah/pergola/balcony >=600 mm	standard aluminium, single pyrolytic low-e, (U-value: 5.7, SHGC: 0.47)			
D01	E	4.41	0	0	eave/verandah/pergola/balcony >=900 mm	standard aluminium, single pyrolytic low-e, (U-value: 5.7, SHGC: 0.47)			

BASIX Certificate number: A373780

	equirements						Show on DA Plans	Show on CC/CDC Plans & specs	Certifier Check
Windows a	and glazed do	oors							
The applicant must install the windows, glazed doors and shading devices, in accordance with the specifications listed in the table below. Relevant overshadowing specifications must be satisfied for each window and glazed door.						\checkmark	\checkmark	~	
The following requirements must also be satisfied in relation to each window and glazed door:							\checkmark	\checkmark	
have a U-va must be calc	lue and a Solar culated in accor	Heat Gair dance with	n Coefficie h National	ent (SHGC) r Fenestratio	no greater than that listed in the tabl	ar glazing, or toned/air gap/clear glazing must le below. Total system U-values and SHGCs s. The description is provided for information		~	~
For projections described in millimetres, the leading edge of each eave, pergola, verandah, balcony or awning must be no more than 500 mm above the head of the window or glazed door and no more than 2400 mm above the sill.						\checkmark	\checkmark	\checkmark	
Pergolas with polycarbonate roof or similar translucent material must have a shading coefficient of less than 0.35.							\checkmark	\checkmark	
shades a pe	erpendicular win	dow. The	spacing b	etween batte	ens must not be more than 50 mm.	ch they are situated, unless the pergola also	-	~	~
shades a pe Windows	and glazed	dow. The doors g	spacing b	etween batte equireme	ens must not be more than 50 mm. nts		-	~	~
shades a pe Windows	erpendicular win	dow. The doors g	spacing b	etween batte equireme	ens must not be more than 50 mm.	ch they are situated, unless the pergola also	-	~	~
shades a pe Windows Window / do	and glazed	dow. The doors g Area of glass inc. frame	spacing b lazing r Oversha Height	etween batte equiremen dowing Distance	ens must not be more than 50 mm. nts		-	~	~
shades a pe Windows Window / do no.	and glazed oor Orientation	dow. The doors g Area of glass inc. frame (m2)	spacing b lazing r Oversha Height (m)	etween batte equiremen idowing Distance (m)	ens must not be more than 50 mm. nts Shading device eave/verandah/pergola/balcony	Frame and glass type standard aluminium, single pyrolytic low-e,		~	~
shades a pe Windows Window / do no. W01	and glazed of orientation	dow. The doors g Area of glass inc. frame (m2) 1.8	Spacing b Iazing n Oversha Height (m) 0	etween batte equiremen adowing Distance (m) 0	ens must not be more than 50 mm. ts Shading device eave/verandah/pergola/balcony >=600 mm eave/verandah/pergola/balcony	Frame and glass type standard aluminium, single pyrolytic low-e, (U-value: 5.7, SHGC: 0.47) standard aluminium, single pyrolytic low-e,		~	~
shades a pe Windows Window / do no. W01 W02	erpendicular win and glazed oor Orientation N E	dow. The doors g Area of glass inc. frame (m2) 1.8 3.18	spacing b lazing r Oversha Height (m) 0 0	etween batte equiremen idowing Distance (m) 0	ens must not be more than 50 mm. ts Shading device eave/verandah/pergola/balcony >=600 mm eave/verandah/pergola/balcony >=600 mm eave/verandah/pergola/balcony	Frame and glass type standard aluminium, single pyrolytic low-e, (U-value: 5.7, SHGC: 0.47) standard aluminium, single pyrolytic low-e, (U-value: 5.7, SHGC: 0.47) standard aluminium, single pyrolytic low-e,		~	~

page 4/6