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DEVELOPMENT CONSULTANTS

Supplementary Water Management Report

Response to Contentions

For a Proposed Residential Development

Prepared for: Warriewood Developers Pty Ltd

Project address: Lots 1 & 2 in DP 349085 (No. 45-49) and Lot 2 in DP 972209 (No.43)

Warriewood Road, Warriewood

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VERSION HISTORY

Version	Date	Purpose	Prepared By	Approved By
А	15/12/2023	Supplementary Water Management Report	Nathan Broadbent	

Review Panel							
Division/Office	Name						

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1 Introduction

This report has been prepared as a supplementary report to the Engineering Report prepared by C & M Consulting Engineers, Report No. R2192, Revision C, dated 4 June 2021 and seeks to address the relevant contentions outlined in the Statement of Facts and Contentions (SOFCAS) reference No. 2023/00096634. This report also incorporates engineering concepts discussed with Northern Beaches Council and their representatives during the preparation of this report.

During the preparation of this report, information was sourced from various documents. These included, but are not limited to the following:

- Addendum Flood Impact Assessment prepared by BMT, reference L.N20951.007_Warriewood_Rd_FloodingRFI.docx, dated 8 July 2022.
- Civil Engineering Works prepared by C & M for the subject site, drawing No.'s 02192-100 to 02192 (14 sheets), revision 4, dated 26 July 2023.
- Detailed Site Investigation report prepares by Sydney Environmental Group, Report No. 2148-DSI-01-280723.v1f, dated 28 July 2023.
- Engineering Report prepared by C & M, reference R02192, Revision C, dated 4 June 2021.
- Northern Beaches Council Pittwater Development Control Plan (DCP) 21
- Northern Beaches Council Warriewood Valley Water Management Specification 2001
- Statement of Facts and Contentions (SOFCAS) reference No. 2023/00096634 filed 18 May 2023.

2 Site overview

The subject site is known as Lots 1 & 2 in DP 349085 (No. 45-49) and Lot 2 in DP 972209 (No.43) Warriewood Road, Warriewood.

A detailed description of the site can be found in the in Detailed Site Investigation report prepares by Sydney Environmental Group, Report No. 2148-DSI-01-280723.v1f, dated 28 July 2023.

2.1 Proposed development

The proposed development consists of two Residential Flat Buildings and a Torrens Title Subdivision creating 11 new residential allotments.

The primary details of the proposed development are depicted on Site Plan prepared by Archidrome, Drawing No.A03, Revision 10, dated 11 December 2023.



3 Contentions

To address the contentions raised by Council, supplementary civil engineering plans have been prepared. In this regard, we refer to our document reference CC230177, sheets C1.00 to C3.16 (22 sheets), revision A, dated 15 December 2023 (copies enclosed under Annexure A). The DRAINS modelling and MUSIC modelling which forms the basis for our revised design can be forwarded to Council and their representatives for review. A description of the DRAINS modelling parameters are outlined in Addendum Flood Impact Assessment prepared by BMT, reference L.N20951.007_Warriewood_Rd_FloodingRFI.docx, dated 8 July 2022.

The relevant contentions and associated responses are included in Table 1.

Table 1.

No.	Contention	Response
3.a.i	The proposal seeks to discharge stormwater into the wetlands at the rear of the site. The Applicant has not addressed the impacts of the outlet flow upon the wetlands, which contain a groundwater dependent EEC.	We refer to our document CC230177, sheets C1.00 to C3.16 (22 sheets), revision A, dated 15 December 2023 and note that an updated BDAR has been prepared based on these plans. We confirm our revised engineering plans provide an outcome that accommodates the maintenance of base flows currently servicing the EEC.
3.a.ii	The proposal seeks to construct a 900mm RCP stormwater line within the existing drainage reserve (43 Warriewood Road) to cater for the 1 in 100-year AEP upper catchment flow from upslope of the site. Although this approach is supported in principle, the Applicant has not demonstrated how the flow of water from upslope is to be suitably captured/directed into the proposed pipeline	A DRAINS model has been prepared based on our revised civil engineering plans. The model demonstrates that the revised stormwater system is able to capture all of the 100 Year ARI +CC30 flows from Warriewood Road and convey them via the proposed culvert to Narrabeen Creek. The DRAINS modelling includes a 20% blockage applied to all on-grade pits and a 50% blockage to all sag pits.
3.a.iii	The proposed 900mm RCP stormwater line within the existing drainage reserve (43 Warriewood Road) is required to be included in the TUFLOW model, inclusive of all existing and proposed drainage systems in the catchment in order to demonstrate that there are no adverse impacts associated with the proposal up to the PMF Event. The assessment needs to assess the worst-case scenario where there is a coincidental local catchment and Narrabeen Creek event up to the PMF event.	Supplementary flood modelling has been undertaken to assess the PMF behaviour within Warriewood Road as DRAINS modelling was deemed unsuitable for this assessment. The revised modelling prepared by BMT includes a direct rainfall TUFLOW model used to assess PMF overland flows occurring near the site. In this regard, we refer to the revised PMF assessment prepared by BMT.
3.a.iv	The Applicant has not provided sufficient detail with respect to the design of the overland flow path over the proposed stormwater line within the existing drainage reserve. Cross sections are required along the overland flow path to detail the 1& AEP Top Water Levels and to ensure that all habitable areas are a minimum of 500mm above these levels.	We refer to our response to contention 3.a.ii and note that a revised design and associated DRAINS model has been prepared which demonstrates the system depicted on our revised civil engineering plans can sufficiently capture and convey 100 Year ARI + CC30 flows through the site.



No.	Contention	Response
3.a.v	The overland flow path dissects Lot 1 and limits the available footprint for future development.	We refer to Site Plan prepared by Archidrome, Drawing No.A03, Revision 10, dated 11 December 2023 and note the revised overland flow path does not encroach on the proposed new Lot 1
3.a.vi	The Applicant does not adequately demonstrate suitable infrastructure upgrades on Warriewood Road, with a new 375mm RCP pipe and pit/s required.	We refer to our revised civil engineering plans and note that a revised stormwater drainage system for Warriewood Road has been documented.
3.a.vii	The development application is not supported by sufficient long sections of stormwater lines, required to detail surface levels, the location of the pipe, the hydraulic grade line, velocities, and flows.	We refer to our revised civil engineering plans and note that a revised stormwater drainage long section has been document. The long section includes a hydraulic grade line analysis for the 100 Year ARI flows plus Climate Change.
3.a.viii	It is unclear whether the Overland Flow Study was undertaken in accordance with Australian Rainfall and Runoff 2019 and Book 9 A Guide to Flood Estimation in Urban Areas, or whether climate change was incorporated into the modelling. Further, the modelling needs to be undertaken by an Engineer that is registered under the NSW Design and Building Practitioners Act and Regulation.	We refer to Addendum Flood Impact Assessment prepared by BMT, reference L.N20951.007_Warriewood_Rd_FloodingRFI.docx, dated 8 July 2022. In this regard, we have reviewed the adopted methodology and confirm that climate change has been considered. Additionally, we are of the view that the view the adopted flood modelling is appropriate to allow for an assessment of flood impacts and flood risk associated with the development.
3.a.ix	The development application is not accompanied by a completed/signed Documentation Checklist – Development Application, as required by the Water Management Specification.	We refer to our revised civil engineering plans and note that some of the measures included in our assessment result from an engineering assessment. Whilst these concepts have been discussed with Council's representatives, a merit-based assessment is required which falls outside the items defined within the checklist.
3.a.x	The Applicant has not demonstrated that flood free evacuation from all lots is possible in the PMF event.	We refer to our response to contention 3.a.iii and note supplementary modelling has been undertaken. In this regard, we refer to the revised PMF assessment prepared by BMT.
3.a.xi	The Applicant has failed to consider potential impacts upon the water table, or the groundwater dependent EEC.	We refer to our document CC230177, sheets C1.00 to C3.16 (22 sheets), revision A, dated 15 December 2023 and note that an updated BDAR has been prepared based on these plans. We confirm our revised engineering plans provide an outcome that accommodates the maintenance of base flows currently servicing the EEC.
3.a.xii	The Applicant has not adequately address water quality, with over simplified and generalised statements that are not specific to the unique circumstances of the site.	A detailed MUSIC model has been prepared as part of our revised assessment. The MUSIC model can be provided to Council's representative for assessment. We can confirm that the MUSIC modelling was undertaken in accordance with Council's DCP requirements, and the pollutant reduction targets of Council's Water Management for Development Specification have been met for scenarios representing a dry, wet, and average rainfall year.



No.	Contention	Response
3.a.xiii	Insufficient information has been provided in relation to the proposed infiltration basin, with concern that large volumes of runoff will not be treated. A bioretention basin is considered to be more suitable in this instance.	We refer to our document CC230177, sheets C1.00 to C3.16 (22 sheets), revision A, dated 15 December 2023 and note that two basins have been documented to manage stormwater flows and to provide a compliant water quality outcome. The details of the basin are depicted on our revised documents.
3.a.xiv	The proposed infiltration basin has a weir to control the outflow. The Applicant has not demonstrated that this is an appropriate outlet method in light of the groundwater dependent EEC along the creek line.	We refer to our document CC230177, sheets C1.00 to C3.16 (22 sheets), revision A, dated 15 December 2023 and note that weir overflows are proposed to an energy dissipation swale. This method has been discussed with Council's representatives in concept and are documented on our revised civil engineering plans. We understand this is a satisfactory outcome resulting in minimal impact to the EEC.
3.a.xv	The proposed use of litter baskets is not a practical outcome, with a gross pollutant trap is more appropriate.	We refer to our document CC230177, sheets C1.00 to C3.16 (22 sheets), revision A, dated 15 December 2023 and note two GPTs have been proposed. We acknowledge the limited fall available to provide a large GTP due to the Lorikeet Grove Road surface levels required to tie in with existing road levels. Notwithstanding, we have been liaising with manufacturers who have advised custom solutions are available to suit.
3.a.xvi	The MUSIC Model is to be prepared in accordance with Council's guidelines and is to be supplied to Council as a model file (.sqz).	We can provide our MUSIC model for assessment.
3.a.xvii	The Engineering Report (C&M Consulting Engineers, 4 June 2021) relies upon rainwater tanks on each of the 11 residential lots that are not proposed as part of the proposal, and the assumed rainwater reuse is inconsistent with the submitted BASIX Certificate.	We confirm our revised assessment includes both the ultimate scenario described in the C & M report dated 4 June 2021, and also an assessment that does not include rainwater tanks on the proposed Torrens Title lots. In this regard, we confirm our assessment does not rely on the provision of future rainwater tanks on Torrens Title lots to meet water quality targets prescribed by Council.
3.a.xviii	The Engineering Report (C&M Consulting Engineers, 4 June 2021) makes assumptions regarding the developed conditions of Catchment 3, being the proposed Torrens Title lots fronting Lorikeet Drive and the access driveway for the residential flat buildings. It is unclear how these assumed calculations have been derived or how the consent authority can ensure consistency with these assumptions in the long term.	We refer to drawing C1.01 which depicts the catchments draining to each of the proposed basins. A DRAINS model has been prepared to size the OSD basins to ensure post-development flows do not exceed pre-developed conditions for a range of storm events from the 1 Year ARI to 100 Year ARI flood event plus climate change.
3.a.xviii	For the purpose of assessing water management and flooding, is it unclear whether the relevant technical consultants have relied upon the architectural plans or the civil plans, which significantly differ with respect to the earthworks proposed and resultant ground levels.	We confirm our revised documents are consistent with the details depicted on Site Plan prepared by Archidrome, Drawing No.A03, Revision 10, dated 11 December 2023.



No.	Contention	Response
3.b	Clause C6.1 (Integrated Water Cycle Management) of P21 DCP and the Water Management Specification require a cohesive, site specific solution for water management across a development site.	We confirm our revised documents are consistent with the details depicted on Site Plan prepared by Archidrome, Drawing No.A03, Revision 10, dated 11 December 2023.
3.c	Although individual technical reports have been provided, they are internally inconsistent, and with each other, and do not satisfactorily demonstrate how the water cycle is cohesively managed on the site.	
3.e	Without consistency with the Water Management Specification or adequate consideration of impacts associated with the proposal, it is also inconsistent with the requirements and objectives of cl.5.21 (Flood planning) of PLEP 2014.	
3.d	Without consistency with the Water Management Specification or adequate consideration of impacts associated with the proposal, it is also inconsistent with the	
	requirements and objectives of cl.6.1(3) of PLEP 2014.	



4 Stormwater Quality

Stormwater runoff quality from the development has been assessed using a MUSIC model which considers the treatment train depicted in Figure 1. The minimum pollutant capture targets achieved are outlined in Table 2.

Table 2: Pollutant capture targets.

Pollutant	Target				
Total suspended solids (TSS)	80% capture				
Total phosphorus (TP)	65% capture				
Total nitrogen (TN)	45% capture				
Gross pollutants (GP)	90% capture				

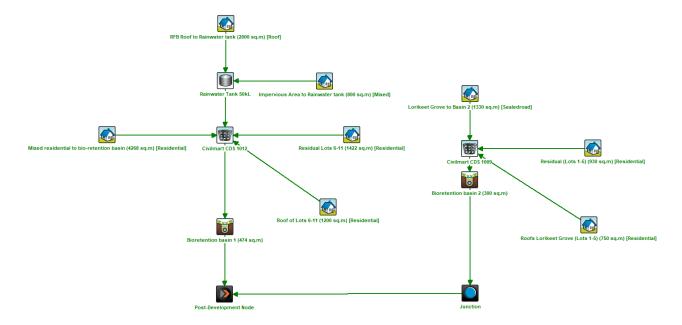


Figure 1: MUSIC model layout.

5 On-site Detention (OSD)

We refer to our document CC230177, sheets C1.00 to C3.16 (22 sheets), revision A, dated 15 December 2023 which depicts two OSD basins. A total OSD storage volume of 540 m³ has been provided which limits post-development flows to pre-development conditions for all storm events ranging from the 1 Year ARI storm event up to the 100 Year ARI storm event plus climate change. A copy of our DRAINS modelling can be provided to Council.



6 Conclusion

Based on the foregoing, we are of the view that the current list of civil engineering contentions before the court can be satisfactorily addressed based on the contents of our revised documents.

Yours faithfully,

ACOR Consultants (CC) Pty Ltd

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Nathan Broadbent

BEng(Civil) CPEng NER



Annexure A ACOR Consultants (CC) Pty Ltd Civil Engineering Plans, reference CC230177, sheets C1.00 to C3.16 (22 sheets), Revision A dated 15 December 2023

PROPOSED DEVELOPMENT (No.43-49) WARRIEWOOD ROAD, WARRIEWOOD

CIVIL ENGINEERING PLANS

GENERAL NOTES

- THESE DRAWINGS SHALL BE READ IN CONJUNCTION WITH ALL ARCHITECTURAL AND OTHER CONSULTANTS DRAWINGS AND SPECIFICATIONS AND WITH SUCH OTHER WRITTEN INSTRUCTIONS AS MAY BE ISSUED.
- THE CONTRACTOR BEFORE CONSTRUCTION
- DIMENSIONS SHALL NOT BE OBTAINED BY SCALING THE DRAWINGS.
- ALL DIMENSIONS ON DETAILS ARE IN MILLIMETRES UNLESS STATED OTHERWISE, ALL PLANS AND LEVELS ARE EXPRESSED IN METRES.
- DURING CONSTRUCTION THE CONTRACTOR SHALL BE RESPONSIBLE FOR MAINTAINING THE STRUCTURAL STABILITY OF THE WORKS AND ENSURE NO PARTS BE OVER STRESSED UNDER CONSTRUCTION ACTIVITIES.
- THE APPROVAL OF A SUBSTITUTION SHALL BE SOUGHT FROM THE ENGINEER BUT IS NOT AN AUTHORISATION FOR A VARIATION. ANY VARIATIONS INVOLVED MUST BE TAKEN UP WITH THE ARCHITECT OR PROJECT MANAGER BEFORE THE WORK COMMENCES.
- ANY DISCREPANCIES OR OMISSIONS SHALL BE REFERRED TO THE ENGINEER FOR A
- THE BUILDER SHALL GIVE 48 HOURS NOTICE FOR ALL ENGINEERING INSPECTIONS
- 10. BUILDING FROM THESE DRAWINGS IS NOT TO COMMENCE UNTIL APPROVED BY THE LOCAL
- THE WORD 'ENGINEER' USED IN THESE NOTES REFER TO AN EMPLOYEE OR NOMINATED

ROADWORKS NOTES

- ALL BASECOURSE AND SUB-BASECOURSE MATERIALS SHALL CONFORM WITH AUSTRALIAN
- ALL BASECOURSE AND SUB-BASE MATERIALS SHALL BE COMPACTED TO ACHIEVE A MINIMUM
- CONCRETE FOR KERB SHALL HAVE A CONCRETE STRENGTH OF 20MPa AT 28 DAYS, MINIMUM SLUMP OF 60mm AND MAXIMUM AGGREGATE SIZE OF 40mm.

EXISTING SERVICES AND FEATURES

- THE CONTRACTOR SHALL ALLOW FOR THE CAPPING OFF, EXCAVATION, REMOVAL AND DISPOSAL IF REQUIRED OF ALL EXISTING SERVICES IN AREAS AFFECTED BY WORKS WITHIN THE CONTRACT AREA, AS SHOWN ON THE DRAWINGS UNLESS DIRECTED OTHERWISE BY THE
- THE CONTRACTOR IS TO CONDUCT A THOROUGH UNDERGROUND SERVICES INVESTIGATION TO LOCATE ALL SERVICES WITHIN THE AREA OF WORKS PRIOR TO ANY DEMOLITION WORKS
- THE CONTRACTOR SHALL ENSURE THAT AT ALL TIMES SERVICES TO ALL BUILDINGS NOT
- PRIOR TO COMMENCEMENT OF ANY WORKS THE CONTRACTOR SHALL GAIN WRITTEN
- CONTRACTOR SHALL CONSTRUCT TEMPORARY SERVICES TO MAINTAIN EXISTING SUPPLY TO BUILDINGS REMAINING IN OPERATION DURING WORKS TO THE SATISFACTION AND APPROVAL OF THE SUPERINTENDENT. ONCE DIVERSION IS IS COMPLETE AND COMMISSIONED THE CONTRACTOR SHALL REMOVE ALL SUCH TEMPORARY SERVICES AND MAKE GOOD TO THE SATISFACTION OF THE SUPERINTENDENT.
- INTERRUPTION TO SUPPLY OF EXISTING SERVICES SHALL BE DONE SO AS NOT TO CAUSE ANY INCONVENIENCE TO THE PRINCIPAL CONTRACTOR TO GAIN APPROVAL OF SUPERINTENDENT FOR TIME OF INTERRUPTION.

SITEWORKS NOTES

- ORIGIN OF LEVELS :- AUSTRALIAN HEIGHT DATUM (A.H.D.)
- CONTRACTOR MUST VERIFY ALL DIMENSIONS AND EXISTING LEVELS ON SITE PRIOR TO
- ALL WORK IS TO BE UNDERTAKEN IN ACCORDANCE WITH THE DETAILS SHOWN ON THE
- EXISTING SERVICES HAVE BEEN PLOTTED FROM SUPPLIED DATA AND AS SUCH THEIR ACCURACY CANNOT BE GUARANTEED. IT IS THE RESPONSIBILITY OF THE CONTRACTOR TO ESTABLISH THE LOCATION AND LEVEL OF ALL EXISTING SERVICES PRIOR TO THE CIPAL'S REPRESENTATIVE. CLEARANCES SHALL BE OBTAINED FROM THE RELEVANT
- WHERE NEW WORKS ABUT EXISTING THE CONTRACTOR SHALL ENSURE THAT A SMOOTH EVEN PROFILE, FREE FROM ABRUPT CHANGES IS OBTAINED.
- THE CONTRACTOR SHALL ARRANGE ALL SURVEY SETOUT TO BE CARRIED OUT BY A
- CARE IS TO BE TAKEN WHEN EXCAVATING NEAR EXISTING SERVICES. NO MECHANICA EXCAVATIONS ARE TO BE UNDERTAKEN OVER COMMUNICATIONS OR ELECTRICAL SERVICES. HAND EXCAVATE IN THESE AREAS
- ALL SERVICE TRENCHES LINDER VEHICLILAR PAVEMENTS SHALL BE RACKELLED WITH AN MAXIMUM DRY DENSITY IN ACCORDANCE WITH AS 1289.5.1.1.
- TRENCH BACKFILL MATERIAL SHALL BE COMPACTED TO THE SAME DENSITY AS THE
- ON COMPLETION OF PIPE INSTALLATION ALL DISTURBED AREAS MUST BE RESTORED TO ORIGINAL, INCLUDING KERBS, FOOTPATHS, CONCRETE AREAS, GRAVEL AND GRASSED AREAS AND ROAD PAVEMENTS.
- PROVIDE 12mm WIDE EXPANDING CORK JOINTS BETWEEN CONCRETE PAVEMENTS AND ALL BUILDINGS, WALLS, FOOTINGS, COLUMNS, KERBS, DISH DRAINS, GRATED DRAINS, BOLLARD
- CONTRACTOR TO OBTAIN ALL AUTHORITY APPROVALS
- ALL BATTERS TO BE GRASSED LINED WITH MINIMUM 100 TOPSOIL AND APPROVED COUCH LAID AS TURF.
- THE CONTRACTOR SHALL PROVIDE ALL TEMPORARY DIVERSION DRAINS AND MOUNDS TO ENSURE THAT AT ALL TIMES EXPOSED SURFACES ARE FREE DRAINING AND WHERE NECESSARY EXCAVATE SUMPS AND PROVIDE PUMPING EQUIPMENT TO DRAIN EXPOSED
- THESE PLANS SHALL BE READ IN CONJUNCTION WITH APPROVED ARCHITECTURAL
- TRENCHES THROUGH EXISTING ROAD AND CONCRETE PAVEMENTS SHALL BE SAWCUT TO
- INCLUDING, BUT NOT LIMITED TO, KERBS, FOOTPATHS, CONCRETE AREAS, GRASS AND

COMPACTION NOTES

- SUPERINTENDENT AND REPLACED WITH APPROVED MATERIAL SATISFYING THE
- ALL FILL MATERIAL SHALL BE FROM A SOURCE APPROVED BY THE SUPERINTENDENT AND SHALL COMPLY WITH THE FOLLOWING :
 - FREE FROM ORGANIC, PERISHABI F AND CONTAMINATED MATTER
 - MAXIMUM PARTICLE SIZE 75MM PLASTICITY INDEX BETWEEN 2% AND 15%

RECTIFIED BY THE CONTRACTOR AT THEIR COST

- THE CONTRACTOR SHALL PROGRAM THE EARTHWORKS OPERATION SO THAT THE WORKING AREAS ARE ADEQUATELY DRAINED DURING THE PERIOD OF CONSTRUCTION. THE SURFACE SHALL BE GRADED AND SEALED OFF TO REMOVE DEPRESSIONS AND SIMILAR WHICH WOULD ALLOW WATER TO POND AND PENETRATE THE UNDERLYING MATERIAL. ANY DAMAGE
- TESTING OF THE SUBGRADE SHALL BE CARRIED OUT BY AN APPROVED NATA REGISTERED

STORMWATER NOTES

- ALL 225 DIA, DRAINAGE PIPES AND LARGER SHALL BE CLASS "2" APPROVED SPIGOT AND ALL 22 DIM. DANIMAGE FIFES AND LANCES SPAILE BE CLASS 2 AFFROVED STIGUT SOCKET FAC OR RCP PIPES WITH RUBBER RING JOINTS. (U.N.O.) ALL DOWNPIPE DR LINES SHALL BE SEWER GRADE UPVC WITH SOLVENT WELD JOINTS. (U.N.O.)
- ALL PIPE JUNCTIONS UP TO AND INCLUDING 450 DIA. AND TAPERS SHALL BE VIA PURPOSE
- MINIMUM GRADE TO STORMWATER LINES TO BE 1%. (U.N.O.)
- CONTRACTOR TO SUPPLY AND INSTALL ALL FITTINGS AND SPECIALS INCLUDING VARIOUS
- ALL CONNECTIONS TO EXISTING DRAINAGE PITS SHALL BE MADE IN A TRADESMAN-LIKE MANNER AND THE INTERNAL WALL OF THE PIT AT THE POINT OF ENTRY SHALL BE CEMENT RENDERED TO ENSURE A SMOOTH FINISH.
- PRECAST PITS SHALL NOT BE USED UNLESS WRITTEN APPROVAL IS OBTAINED FROM THE
- WHERE TRENCHES ARE IN ROCK, THE PIPE SHALL BE BEDDED ON A MIN. 50MM CONCRETE BED (OR 75MM THICK BED OF 12MM BLUE METAL) UNDER THE BARREL OF THE PIPE. THE PIPE COLLAR AT NO POINT SHALL BEAR ON THE ROCK. IN OTHER THAN ROCK, PIPES SHALL BE LAID ON A 75MM THICK SAND BED. IN ALL CASES BACKFILL THE TRENCH WITH SAND TO 200MM ABOVE THE PIPE, WHERE THE PIPE IS UNDER PAVEMENTS BACKFILL REMAINDER OF TRENCH WITH SAND OR APPROVED GRANLII AR BACKEILL COMPACTED IN 150MM LAYERS TO 98%
- BEDDING SHALL BE (U.N.O.) TYPE H1. IN ACCORDANCE WITH CURRENT RELEVANT
- WHERE STORMWATER LINES PASS UNDER FLOOR SLABS SEWER GRADE RUBBER RING
- WHERE SUBSOIL DRAINAGE LINES PASS UNDER FLOOR SLABS AND VEHICULAR PAVEMENTS UNSLOTTED UPVC SEWER GRADE PIPE SHALL BE USED.
- PROVIDE 3.0M LENGTH OF 100 DIA. SUBSOIL DRAINAGE PIPE WRAPPED IN FABRIC SOCK, AT

CONCRETE PAVEMENT NOTES

- - MAXIMUM AGGREGATE SIZE 20mn - FLEXURAL STRENGTH AT 28 DAYS = 3.5MPa
 - FLEXURAL STRENGTH AT 90 DAYS = 3.85 MPa
 - MAXIMUM WATER / CEMENT RATIO = 0.55 MAXIMUM SHRINKAGE I IMIT = 650 MICRON STRAINS
 - (AS 1012 Pt 13)
 MINIMUM CEMENT CONTENT = 300kg/m3
 - CEMENT TO BE TYPE "A" (NORMAL CEMENT) TO AS.1315
- JOINT TO BE SAWN AS SOON AS CONCRETE HAS HARDENED SUFFICIENTLY THAT IT WILL NOT BE DAMAGED BY SAWING. IF AN UNPLANNED CRACK OCCURS THE CONTRACTOR SHALL REPLACE WHOLE SLABS EITHER SIDE OF THE UNPLANNED CRACK, UNLESS
- CONSTRUCT JOINTS AS DETAILED
- CONSTRUCTION JOINTS WHERE REQUIRED BUT NOT SHOWN, SHALL BE LOCATED TO THE APPROVAL OF THE ENGINEER AND CONSTRUCTED AT THE CONTRACTORS EXPENSE.
- ALL LONGITUDINAL CONSTRUCTION JOINTS SHALL BE FORMED AND INCLUDE DOWE INCLUDE DOWEL BARS AS SPECIFIED.
- BOND BREAKER TO BE TWO (2) UNIFORM COATS OF BITUMEN EMULSION ALL OVER THE EXPOSED SURFACE AND ON END.
- DOWELS AND TIE BARS TO MEET STRENGTH REQUIREMENTS OF STRUCTURAL GRADE STEEL IN ACCORDANCE AS, 1302. DOWELS AND TIE BARS SHALL BE ;-
- CLEAN AND FREE FROM MILL SCALE, RUST AND OIL. - SAWN TO LENGTH NOT CROPPED.
- DIMENSIONS OF SEALANT RESERVOIR DEPENDANT ON THE SEALANT TYPE ADOPTED
- DIMENSIONS OF SEALANT RESERVOIR DEPENDANT ON THE SEALANT 11PE ADDPTED.

 ENGINEERS APPROVAL TO BE OBTAINED FOR SEALANT AND RESERVOIR DIMENSIONS
 AND DETAIL PROPOSED BY THE CONTRACTOR. REFER DETAIL "B" FOR TYPICAL
 ARRANGEMENT AND SEALANT.
- PRIOR TO THE PLACEMENT OF CONCRETE IN THE ADJACENT SLAB, SELF EXPANDING CORK FILLER SHALL BE ADHERED TO THE ALREADY CAST AND CLEANED CONCRETE FACE USING AN APPROVED WATERPROOF ADHESIVE. ADHESIVE SHALL BE LIBERALLY APPLIED TO THE FULL FACE OF THE CONCRETE SLAB TO BE COVERED BY THE FILLER, AND ON THI
- REFER TO COMPACTION NOTES FOR PREPARATION OF SUB-BASE AND SUB-GRADE
- ALL WORK TO BE BROOM FINISH.

ASPHALTIC CONCRETE NOTES

- EMAL
 MINERAL AGGREGATES TO COMPLY WITH AUSTRALIAN STANDARDS
 MINERAL FILLER TO COMPLY WITH AS 2357 MINERAL FILLERS OR ASPHALT
 BITUMEN BINDER SHALL COMPLY WITH AS 2008

- JOB MIX 10mm NOMINAL SIZE AGGREGATE. MINIMUM BITUMEN CONTENT BY MASS
- MIX STABILITY BETWEEN 16kN AND 36kN AS DETERMINED BY AS 289 AIR VOIDS IN COMPACTED MIX - BETWEEN 4% AND 7% OF THE VOI UME OF THE MIX.
- VOIDS FILLED IN BINDER 65-80% OF AIR VOIDS IN THE TOTAL MINERAL AGGREGATE FILLED BY BINDER IN ACCORDANCE WITH AUSTRALIAN STANDARDS

- PAVEMENT PREPARATION

 a) THE EXISTING SURFACE TO BE SEALED SHALL BE DRY AND BROOMED BEFORE
- COMMENCEMENT OF WORK TO ENSURE COMPLETE REMOVAL OF ALL SUPERFICIAL FOREIGN MATTER.
 ALL DEPRESSIONS OR UNEVEN AREAS ARE TO BE TACK-COATED AND BROUGHT UP TO GENERAL LEVEL OF PAVEMENT WITH ASPHALTIC CONCRETE BEFORE LAYING

TACK COAT

a) THE WHOLE OF THE AREA TO BE SHEETED WITH ASPHALTIC CONCRETE SHALL BE LIGHTLY AND EVENLY COATED WITH RAPID SETTING BITUMEN COMPLYING WITH AUSTRALIAN STANDARDS. APPLICATION RATE FOR RESIDUAL BITUMEN SHALL BE STANDARDS OF A PROPERTY AND PROPICATION SHALL BE BY MEANS OF A MECHANICAL SPRAYER WITH SPRAY BAR

- SPREADING

 a) ALL ASPHALTIC CONCRETE SHALL BE SPREAD WITH A SELF PROPELLED PAVING
- THE ASPHALTIC CONCRETE SHALL BE LAID AT A MIX TEMPERATURE AS SHOWN

ROAD SURFACE TEMPERATURE IN SHADE (°C)	MIX TEMPERATURES (°C)
5 - 10	NOT PERMITTED
10 - 15	150
45 05	1/15

- c) ASPHALTIC CONCRETE SHALL NOT BE LAID WHEN THE ROAD SURFACE IS WET OR
- THE MINIMUM COMPACTED THICKNESS IS 30mm OVER EXISTING SEALED. PAVEMENTS AND 50mm OVER NEW PAVEMENTS
- THE NUMBER OF JOINTS BOTH LONGITUDINAL AND TRANSVERSE SHALL BE KEPT
- THE ROUBLES OF SHARE SHARE SHARE BE SIMILAR TO THOSE OF THE REMAINDER OF THE LAYER.

- a) ALL COMPACTION SHALL BE UNDERTAKEN USING SELF PROPELLED ROLLERS.
 b) INITIAL ROLLING SHALL BE COMPLETE BEFORE THE MIX TEMPERATURE FALLS
- BELOW 105°C SECONDARY ROLLING SHALL BE COMPLETED BEFORE THE MIX TEMPERATURE
- FALLS BELOW 60°C
 MINIMUM CHARACTERISTICS VALUE OF RELATIVE COMPACTION OF A LOT WHEN

a) FINISHED PAVEMENT PROPERTIES

a) FINISHED SURFACES SHALL BE SMOOTH, DENSE AND TRUE TO SHAPE AND SHALL NOT VARY MORE THAN 10mm FROM THE SPECIFIED PLAN LEVEL AT ANY POINT AND SHALL NOT DEVIATE FROM THE BOTTOM OF A 3m STRAIGHT FDGE LAID IN ANY

DIAL BEFORE YOU DIG

DRAINAGE CATCHMENT PLAN SHEET C1.01 KEY PLAN - SITE STORMWATER MANAGEMENT SHEET C2.00 STORMWATER MANAGEMENT PLAN SHEET 1 OF 2 SHEET C2.01 STORMWATER MANAGEMENT PLAN SHEET 2 OF 2 SHEET C2.02 SHEET C3.00 KEY PLAN - ROADWORKS & DRAINAGE GENERAL ARRANGEMENT ROADWORKS & DRAINAGE PLAN SHEET 1 OF 5 SHEET C3.01 ROADWORKS & DRAINAGE PLAN SHEET 2 OF 5 SHEET C3.02 ROADWORKS & DRAINAGE PLAN SHEET 3 OF 5 SHEET C3.03 SHEET C3.04 ROADWORKS & DRAINAGE PLAN SHEET 4 OF 5 ROADWORKS & DRAINAGE PLAN SHEET 5 OF 5 SHEET C3.05 ROAD LONGITUDINAL SECTION (MC01) - LORIKEET GROVE SHEET C3.06

SHEET INDEX

SHEET C1 00

SHEET C3.16

COVER SHEET & NOTES

TYPICAL DETAIL SHEET 2 OF 2

ROAD CROSS SECTIONS (MC01) LORIKEET GROVE SHEET 1 OF 3 SHEET C3.07 ROAD CROSS SECTIONS (MC01) LORIKEET GROVE SHEET 2 OF 3 SHEET C3.08 ROAD CROSS SECTIONS (MC01) LORIKEET GROVE SHEET 3 OF 3 SHEET C3.09 ROAD LONGITUDINAL SECTION (MC02) - WARRIEWOOD ROAD SHEET C3 10 ROAD CROSS SECTIONS (MC02) WARRIEWOOD ROAD SHEET 1 OF 2 SHEET C3 1 ROAD CROSS SECTIONS (MC02) WARRIEWOOD ROAD SHEET 2 OF 2 SHEET C3.12

DRAINAGE EASEMENT LONGITUDINAL SECTION (DR01) SHEET C3.13 DRAINAGE PIT & PIPE LONGITUDINAL SECTION SHEET C3.14 SHEET C3.15 TYPICAL DETAIL SHEET 1 OF 2



TO MAINTAIN A CURRENT SET OF "DIAL BEFORE YOU DIG" DRAWINGS ON SITE AT ALL TIMES.

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Date Drawn App

WARRIEWOOD **DEVELOPERS**

ACOR Consultants (CC) Ptv Ltd Platinum Building, Suite 2.01, 4 Ilya Avenu ERINA NSW 2250, Australi

DEVELOPMENT T +61 2 4324 3499


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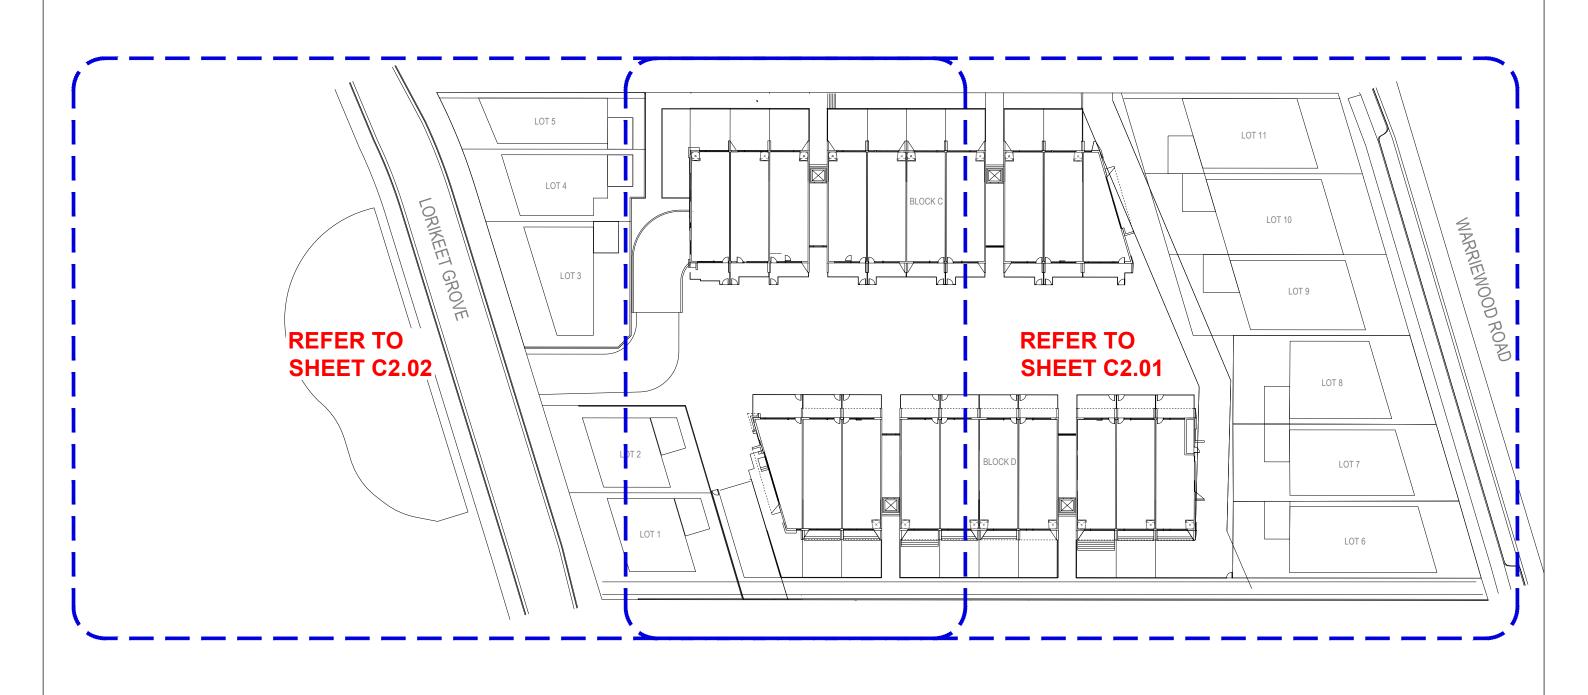
PROPOSED RESIDENTIAL

SEPT 23 AS NOTED CC230177

COVER SHEET & NOTES

DRAWINGS MUST BE PRINTED IN COLOUR



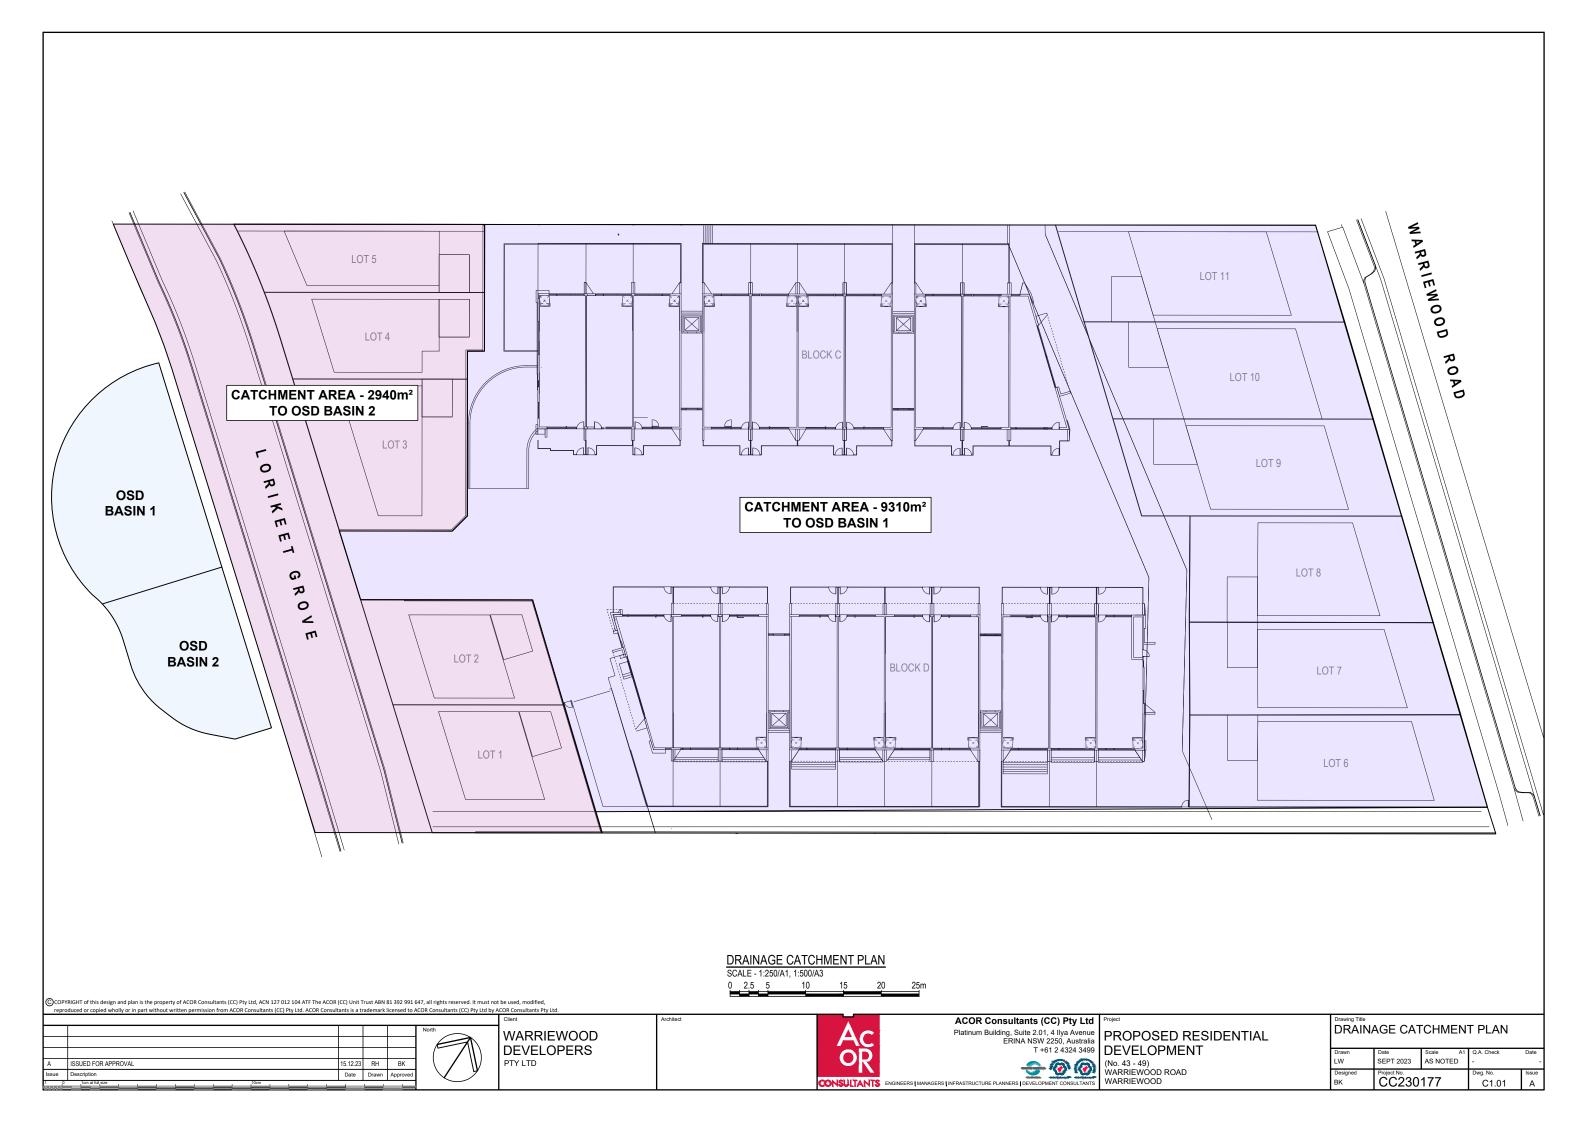

KEY PLAN SCALE - 1:300/A1, 1:600/A3 0 2 4 8 12 16 20m

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Α	ISSUED FOR APPROVAL	15.12.23	RH	BK
Issue	Description	Date	Drawn	Approved
	10cm at full give			

WARRIEWOOD DEVELOPERS PTY LTD


(No. 43 - 49) WARRIEWOOD ROAD WARRIEWOOD


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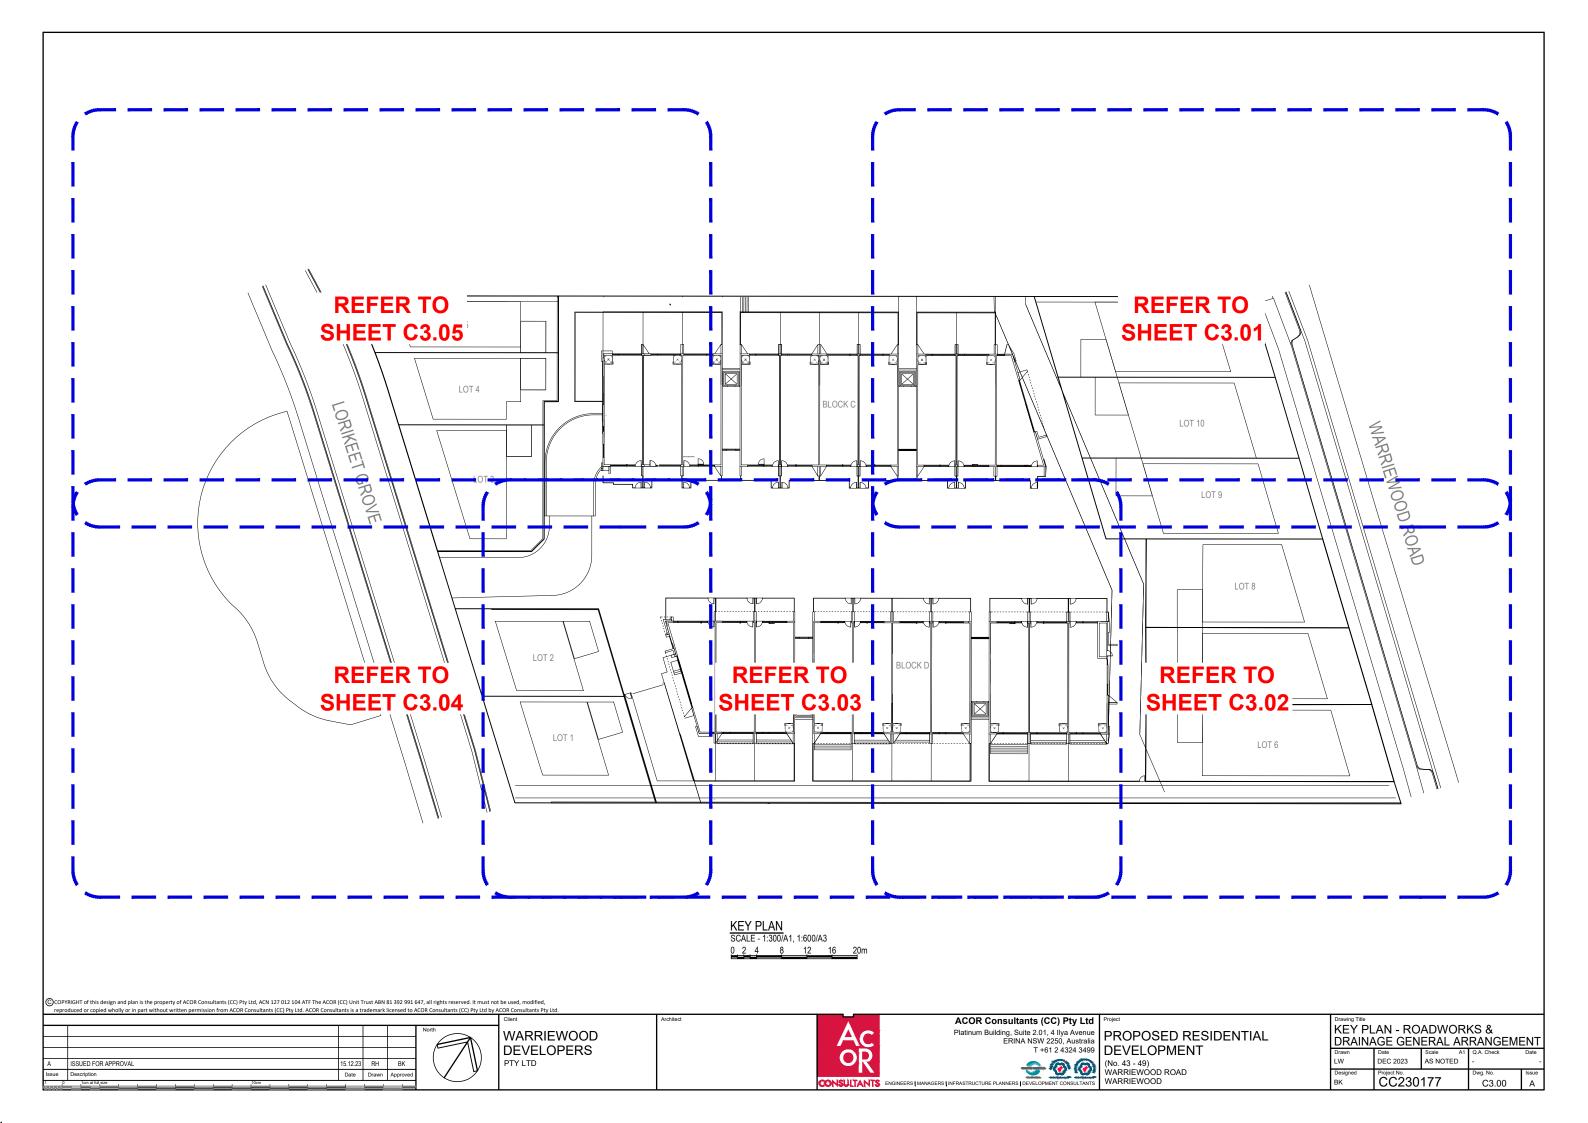
Platinum Building, Suite 2.01, 4 llya Avenue
ERINA NSW 2250, Australia
T +61 2 4324 3499


PROPOSED RESIDENTIAL
DEVELOPMENT


KEY PLAN - SITE
STORMWATER MANAGEMENT
Promission | Date | Scale | A1 | Q.A. Check Project No. CC230177 C2.00




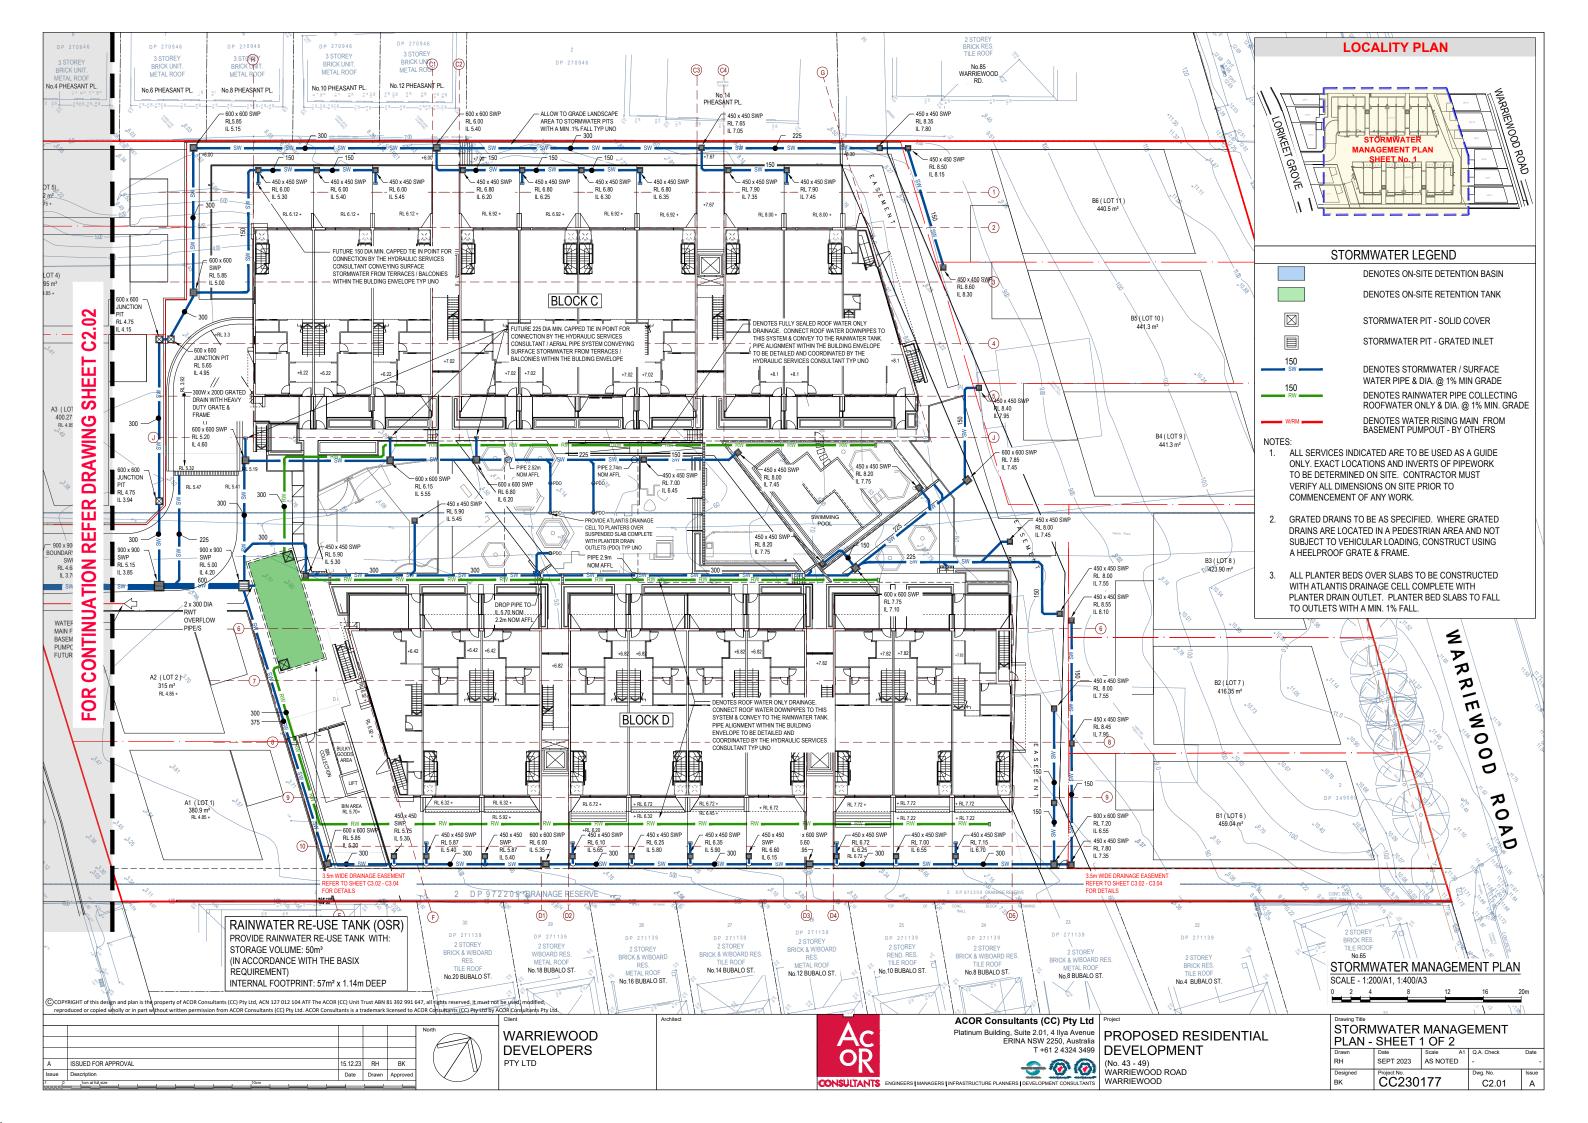


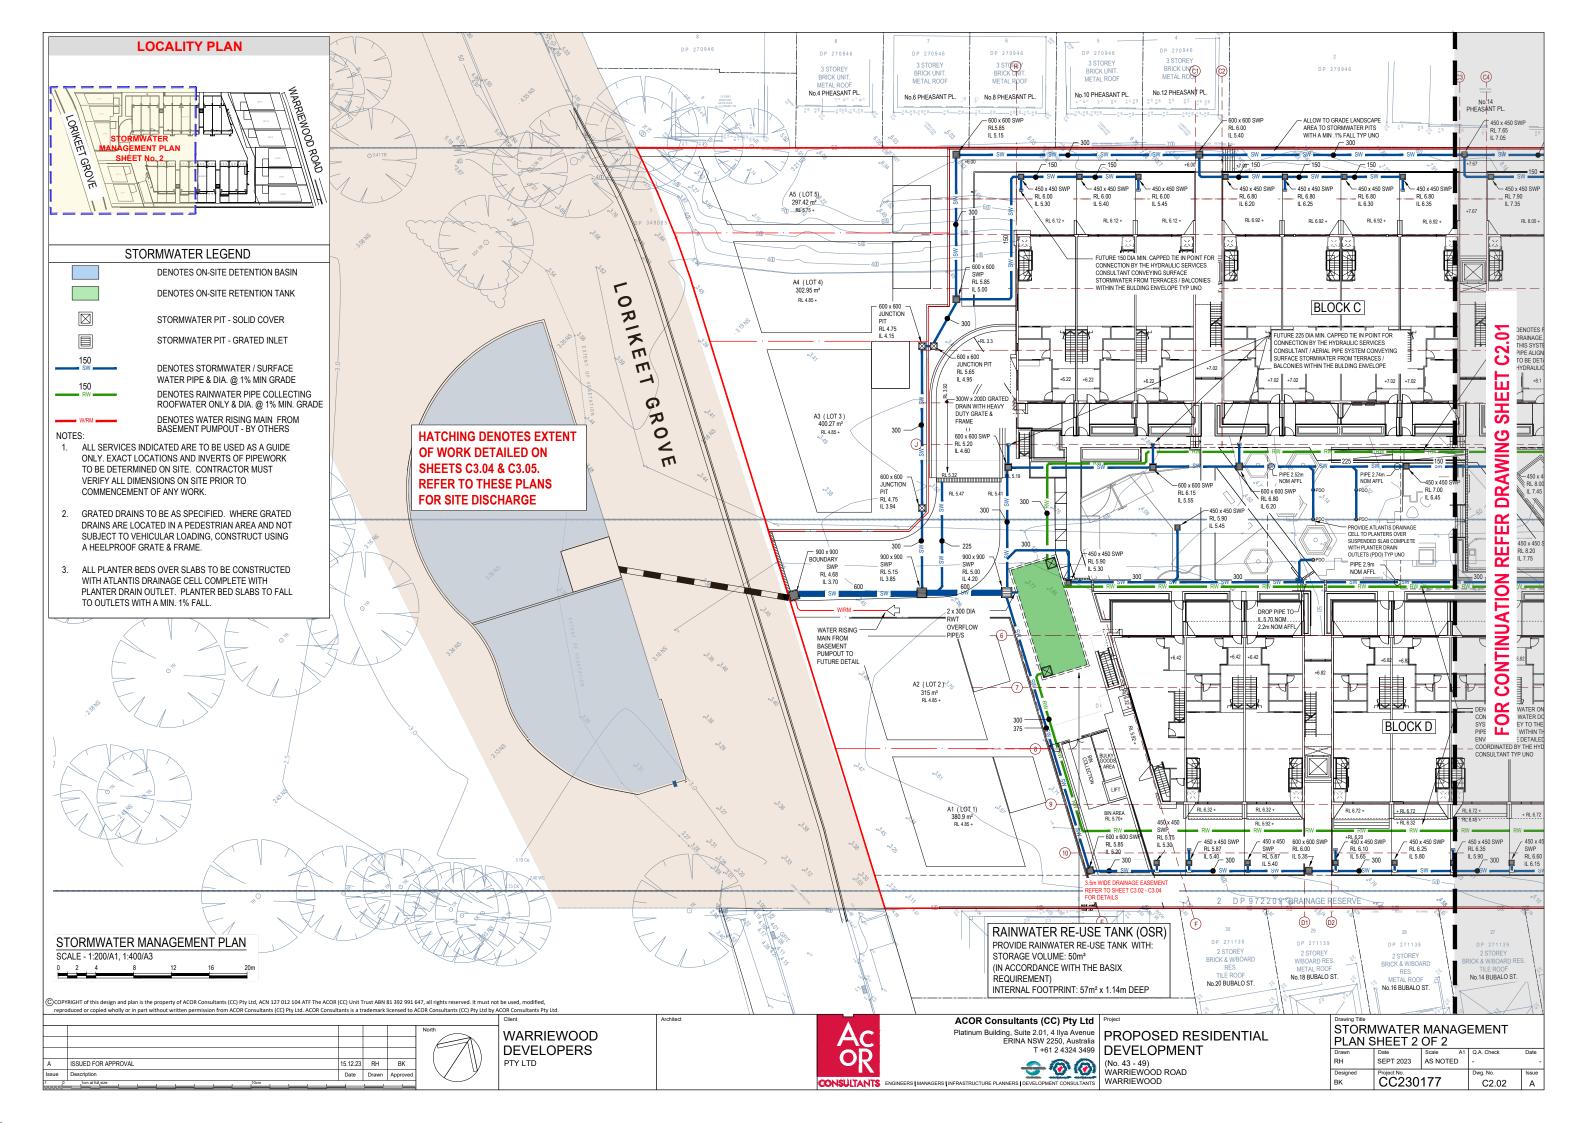


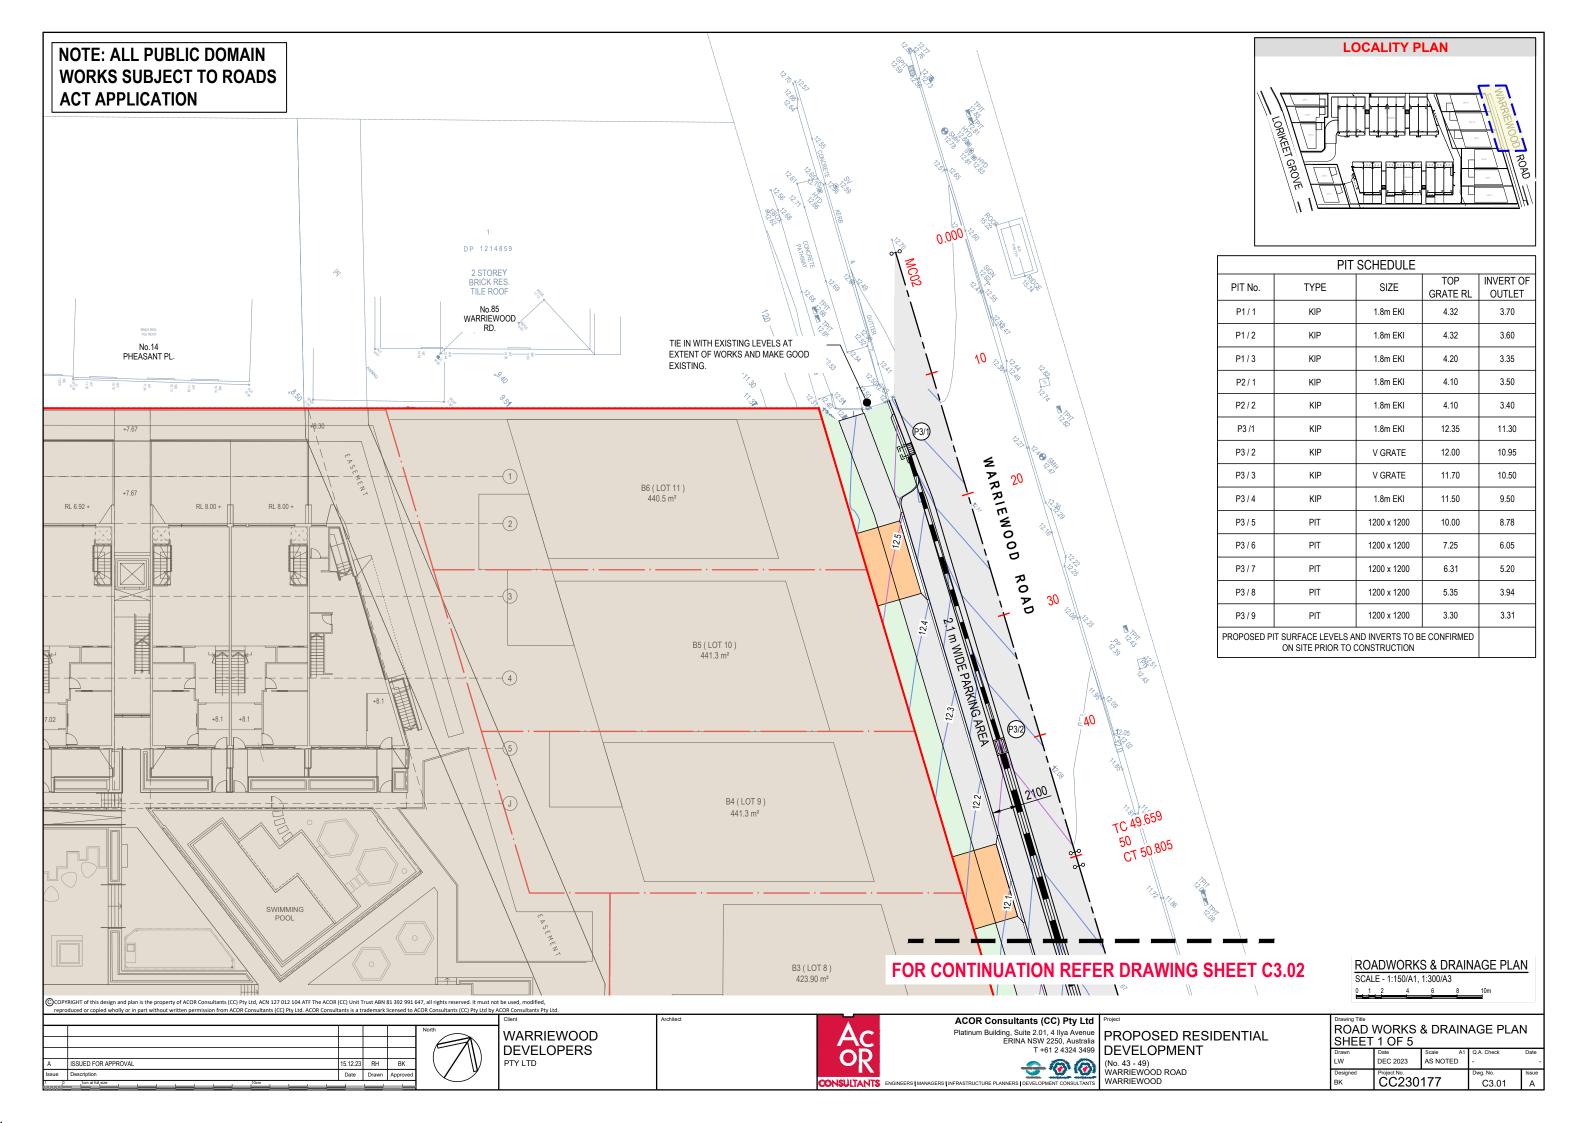


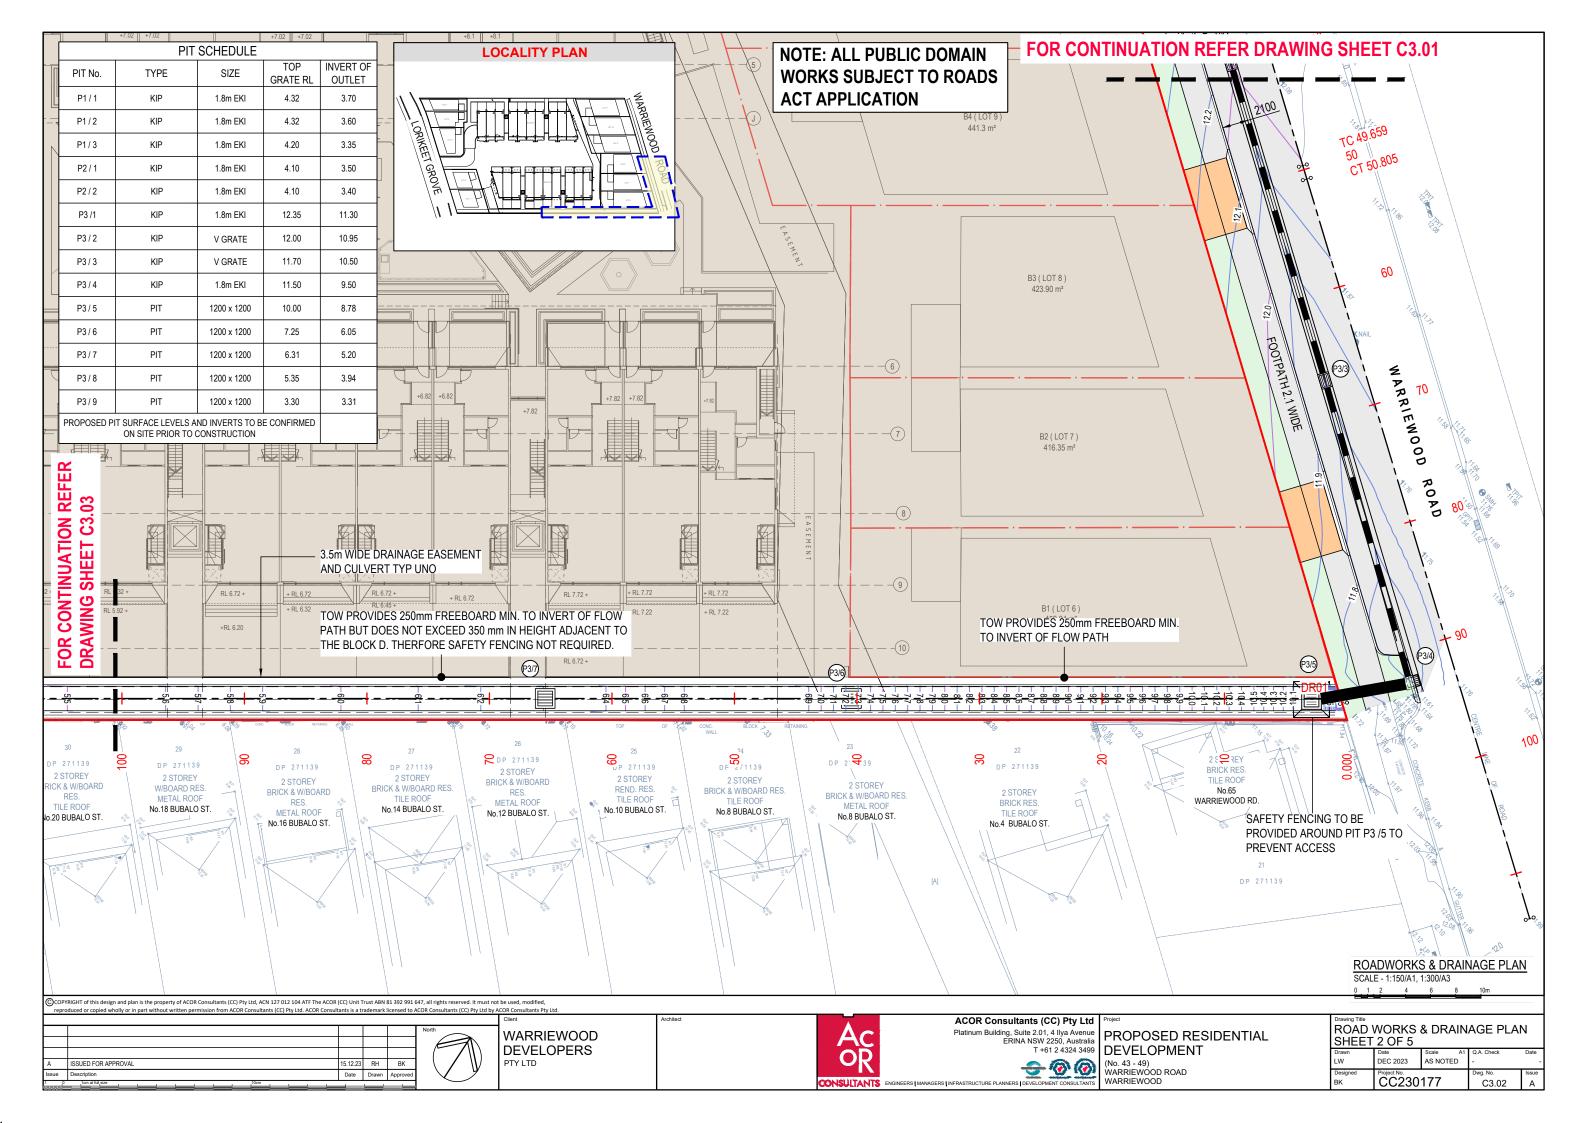

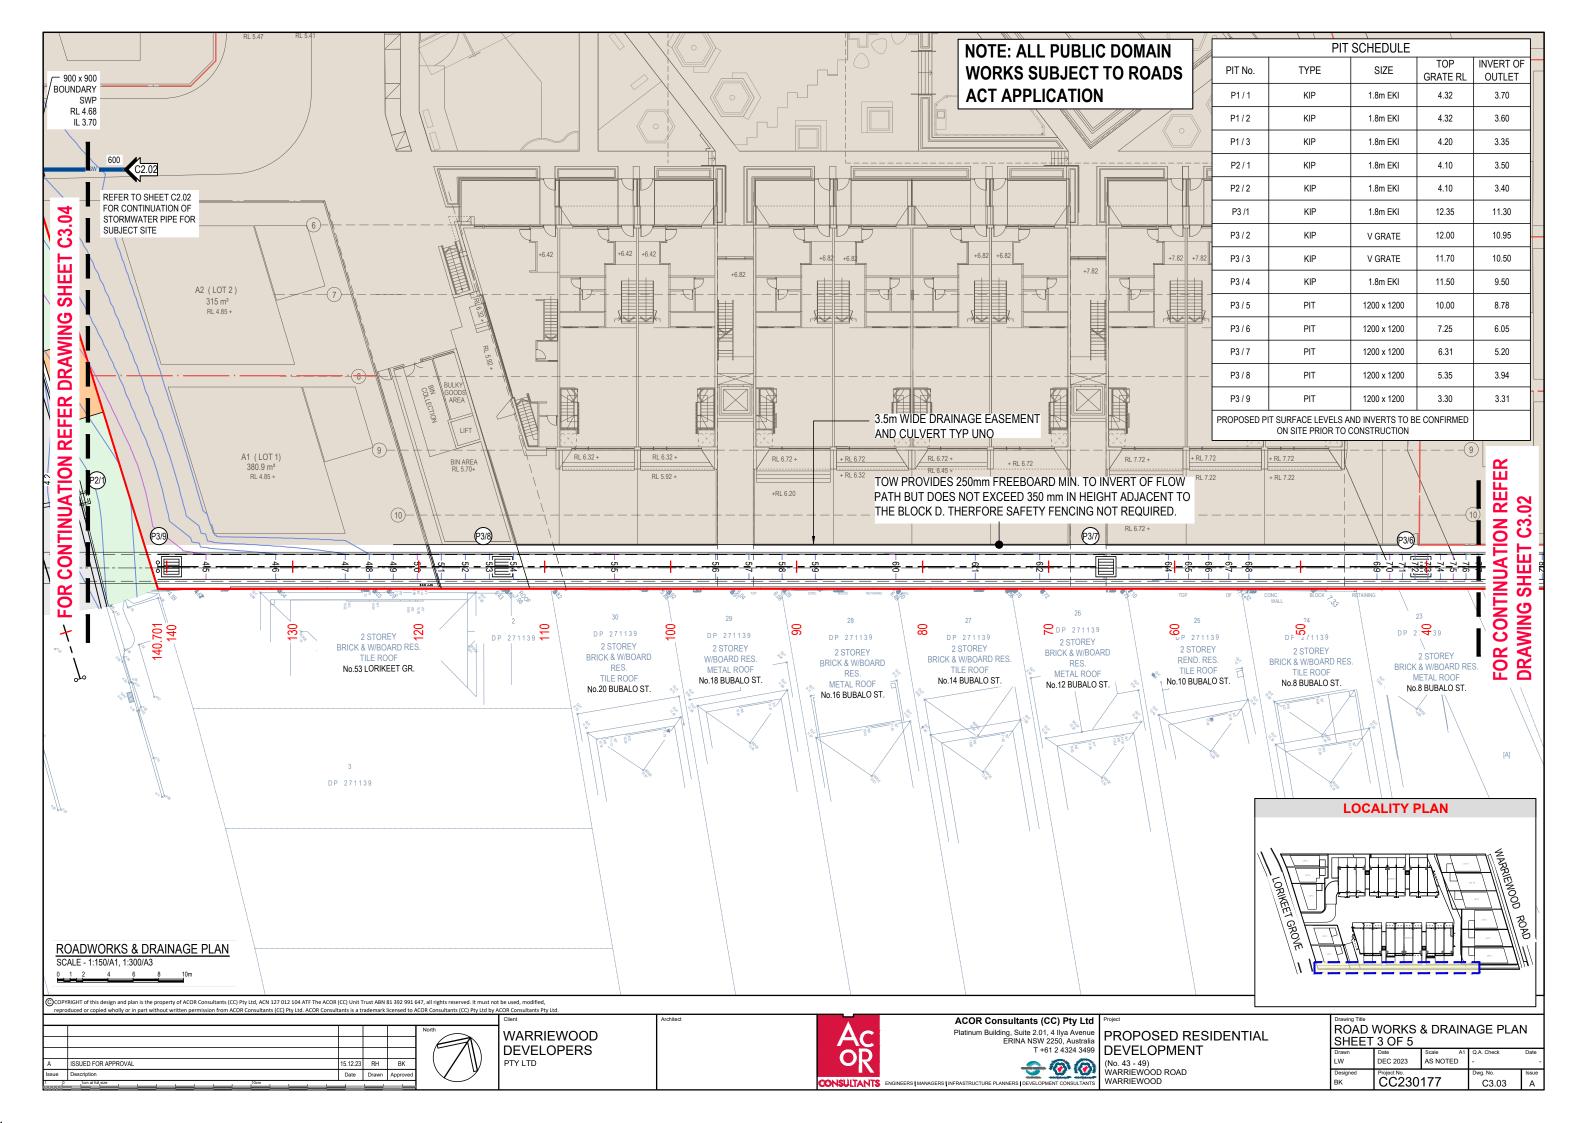

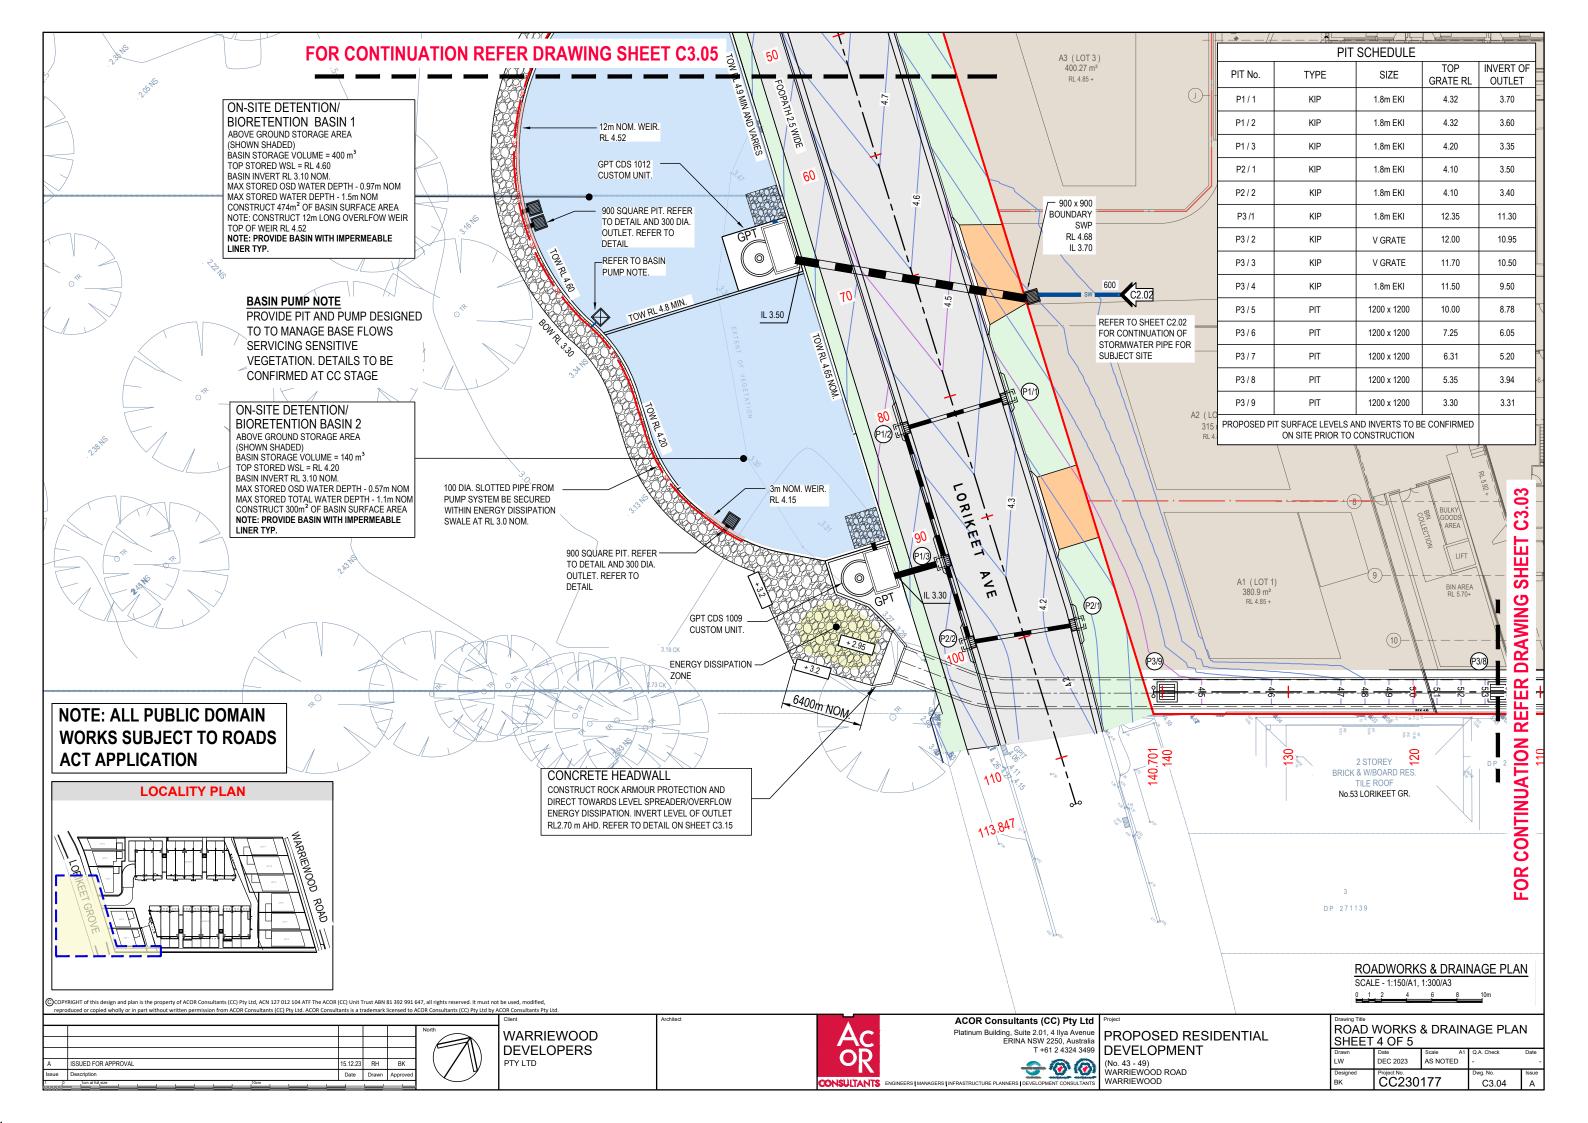

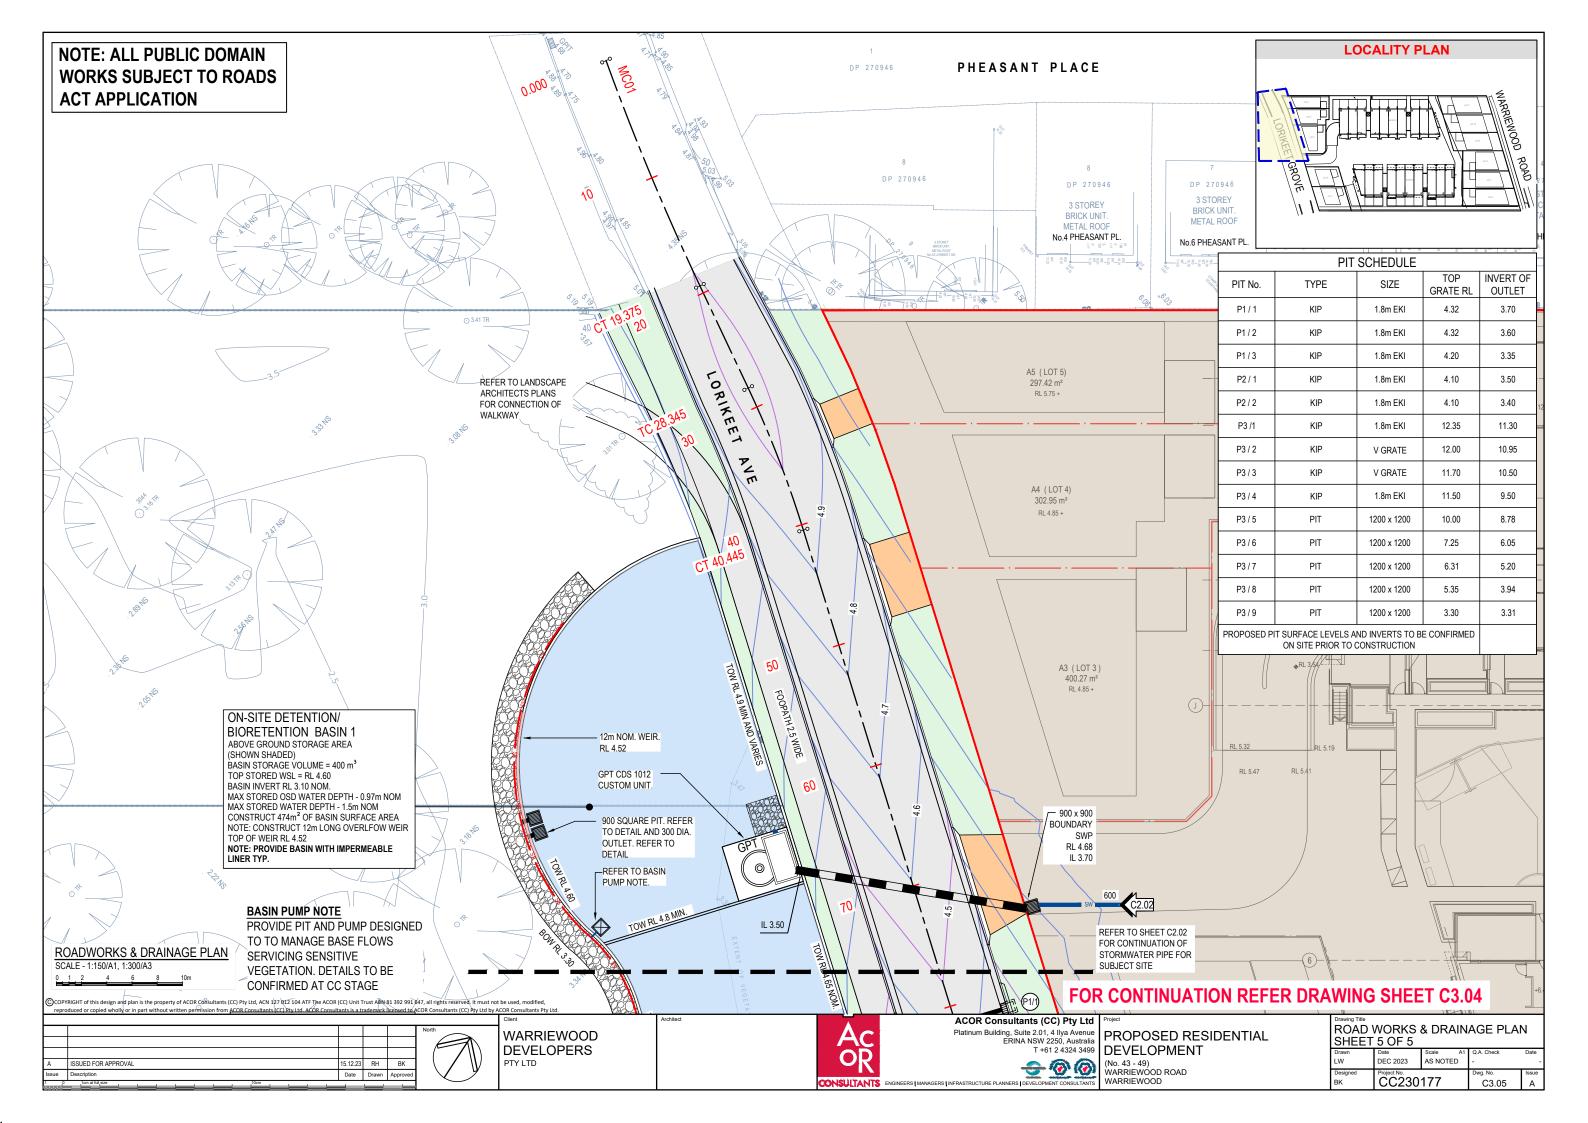

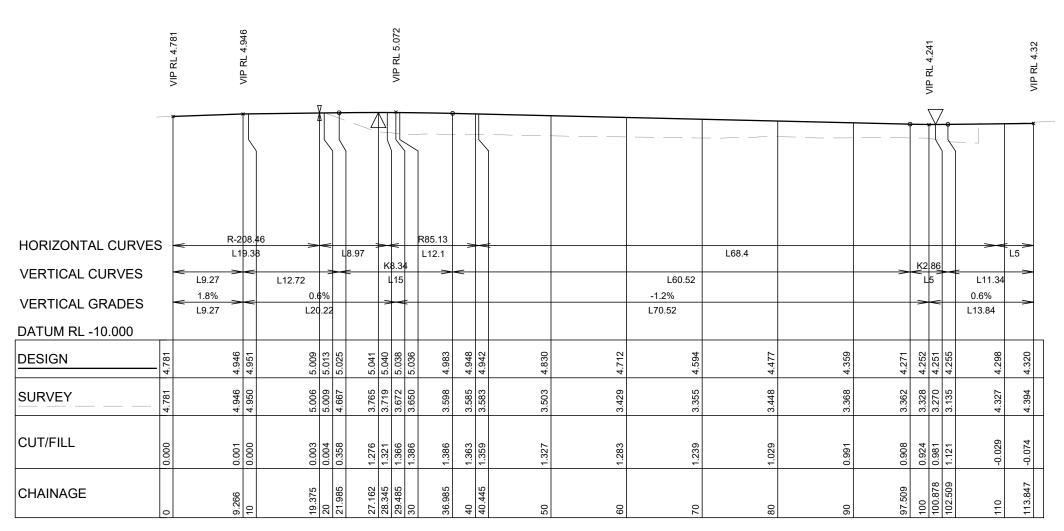

MC01 - LONGITUDINAL SECTION HORZ SCALE 1:500 VERT SCALE 1:250

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					North	۱۸//
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						DE
Α	ISSUED FOR APPROVAL	15.12.23	RH	BK		PTY
ssue	Description	Date	Drawn	Approved		
0	1cm at full size 10cm					

/ARRIEWOOD EVELOPERS



ACOR Consultants (CC) Pty Ltd


Platinum Building, Suite 2.01, 4 Ilya Avenue ERINA NSW 2250, Australia T +61 2 4324 3499 DEVELOPMENT PROPOSED RESIDENTIAL (No. 43 - 49) WARRIEWOOD ROAD


WARRIEWOOD

ROAD LONGITUDINAL SECTION (MC01) - LORIKEET GROVE Date Scale A DEC 2023 AS NOTED


CC230177

C3.06

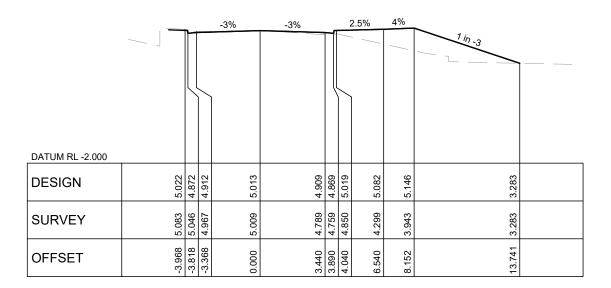

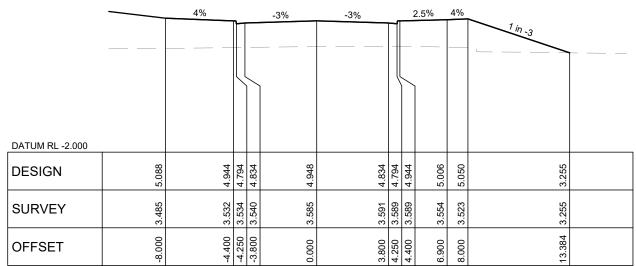

CH 20 CH 40

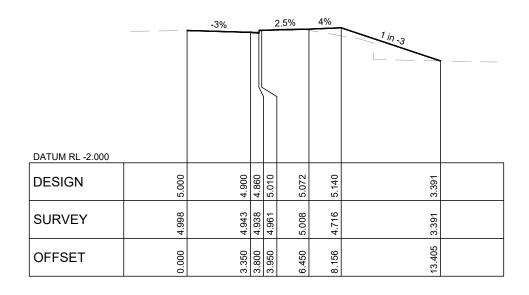

		4%	N	-3%	-3%	— 1	2	2.5%	4%	
										1 in -3
			$ \; \rangle$			\				
DATUM RL -2.000										
DESIGN	5.176	5.032	4.882	5.036	4.922	4.882	5.032	5.095	5.139	3.127
SURVEY	3.806	3.762	3.762	3.650	3.602	3.601	3.599	3.579	3.576	3.127
OFFSET	-8.000	-4.400				4.250	П	006.9	8.000	14.037

CH 18 CH 30

HORZ SCALE 1:200 VERT SCALE 1:400

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						Client
					North	WARRIEWOOD
						DEVELOPERS
	ISSUED FOR APPROVAL	15.12.23	RH	BK		PTY LTD
Э	Description	Date	Drawn	Approved		
				_		


AC OR consultants ACOR Consultants (CC) Pty Ltd
Platinum Building, Suite 2.01, 4 llya Avenue
ERINA NSW 2250, Australia
T +61 2 4324 3499
DEVELOPMENT

PROPOSED RESIDENTIAL
DEVELOPMENT

(No. 43 - 49)
WARRIEWOOD ROAD


WARRIEWOOD


| ROAD CROSS SECTIONS (MC01) | LORIKEET GROVE SHEET 1 OF 3 | Drawn | Date | DEC 2023 | Scale | A1 | Q.A. Check | Date | LW | DEC 2023 | AS NOTED | Dwg. No. | Issue | Designed | Drawn | Dwg. No. | C2.307 | AS NOTED | C3.07 | AS NOTED | C3.07 | AS NOTED | C3.07 | AS NOTED | Dwg. No. | Issue | Dwg. No. | Dwg. N

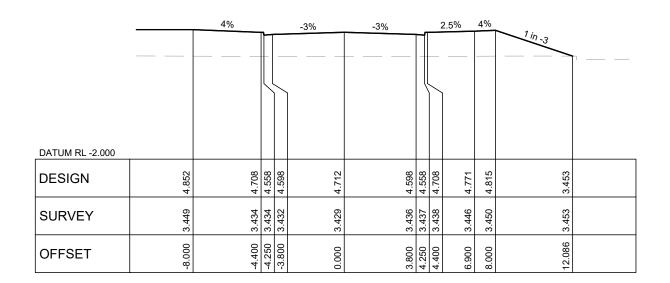

		4%	T		-3%	-3%			2.5	%	4%	1 in -3	
							_	#					
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DATUM RL -2.000							4	4	+				
DESIGN	4.617	4.473	4.323	4.363	4.477		4.363	4.323	4.473	4.535	4.579	3.323	
SURVEY	3.445	3.424	3.423	3.421	3.448		3.366	3.365	3.365	3.351	3.344	3.323	
OFFSET	-8.000	-4.400		-3.800	0.000			4.250		0.900	8.000	11.768	

CH 60 CH 80

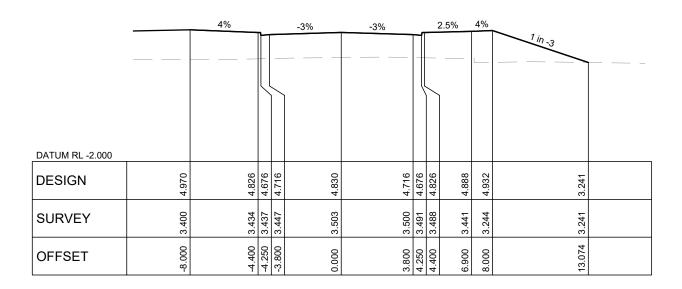

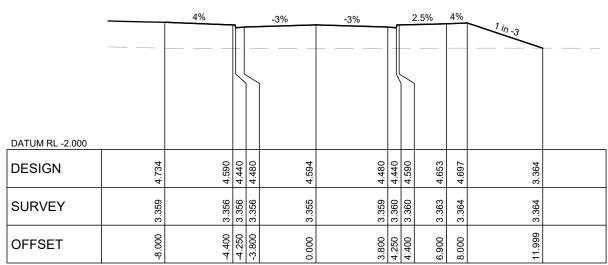

CH 50 CH 70

HORZ SCALE 1:200 VERT SCALE 1:400

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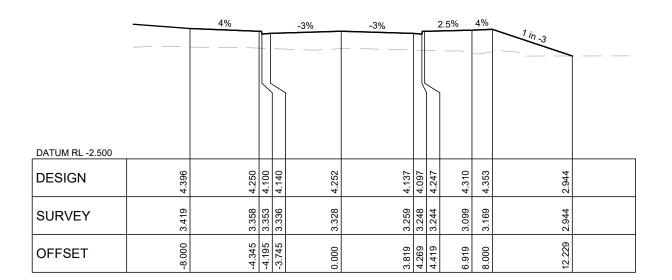
						Client
					North	WARRIEWOOD
						DEVELOPERS
	ISSUED FOR APPROVAL	15.12.23	RH	BK		PTY LTD
9	Description	Date	Drawn	Approved		

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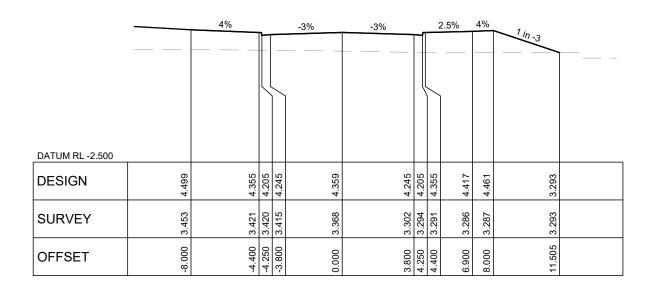
Platinum Building, Suite 2.01, 4 Ilya Avenue ERINA NSW 2250, Australia T +61 2 4324 3499 DEVELOPMENT PROPOSED RESIDENTIAL (No. 43 - 49) WARRIEWOOD ROAD

WARRIEWOOD

ROAD CROSS SECTIONS (MC01) LORIKEET GROVE SHEET 2 OF 3 DEC 2023 AS NOTED CC230177 C3.08



CH 100



		4%	- 1	-3%	
					-
DATUM RL -2.000	4.469	4.305	4.155 4.195	4.292	
SURVEY	4.191 4.		4.306 4. 4.406 4.	4.310 4.	
OFFSET	-7.950	-3.850	-3.700	0.000	

CH 90 CH 109

HORZ SCALE 1:200 VERT SCALE 1:400


						Ollotti
					North	WARRIEWOOD
						DEVELOPERS
	ISSUED FOR APPROVAL	15.12.23	RH	BK		PTY LTD
ıe	Description	Date	Drawn	Approved		
,0	1cm at full size 10cm			-		

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PROPOSED RESIDENTIAL
DEVELOPMENT (No. 43 - 49) WARRIEWOOD ROAD WARRIEWOOD

ROAD CROSS SECTIONS (MC01) LORIKEET GROVE SHEET 3 OF 3 Date Scale A DEC 2023 AS NOTED CC230177 C3.09



MC02 - LONGITUDINAL SECTION HORZ SCALE 1:500 VERT SCALE 1:250
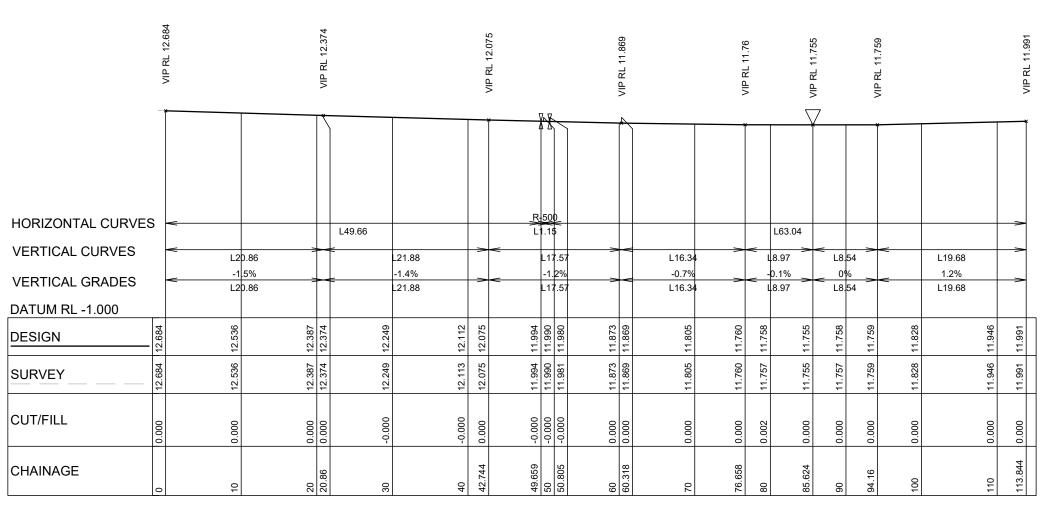
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					North	\\/ \ D
						VV/\\\
						DEAF
A	ISSUED FOR APPROVAL	15.12.23	RH	BK		PTY LTD
ssue	Description	Date	Drawn	Approved		
.0	1cm at full size 10cm					

RRIEWOOD /ELOPERS




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WARRIEWOOD

ROAD LONGITUDINAL SECTION (MC02) - WARRIEWOOD ROAD DEC 2023 AS NOTED

CC230177 C3.10



		-3%		3%		2.5%	3%	
DATUM RL 5.500								
DESIGN	12.112	12.029	11.989	12.078	12.228	12.281	12.335	
SURVEY	12.113	11.957	11.930	11.694	11.658	11.355	11.094	
OFFSET	0.000	2.794	3.244	5.344	5.524	7.624	9.424	

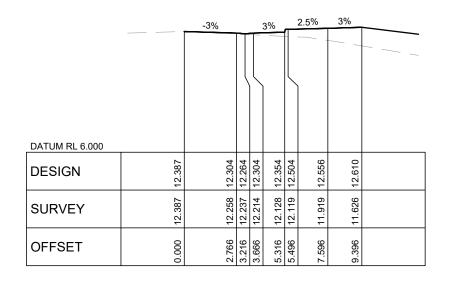		-3%		,	3%		2.5%	3%	
DATUM RL 6.000									
DESIGN	11.873	11.787	11.747	11.787	11.837	11.987	12.039	12.093	
SURVEY	11.873	11.710	11.684	11.644	11.509	11.494	11.353	11.262	
OFFSET	0.000	2.844	3.294	3.744	5.394	5.574	7.674	9.474	

CH 20 CH 40 CH 60

		-3%		2.	5%	3%	
DATUM RL 6.000					0		
DESIGN	12.519	12.417	12.377	12.527	12.580	12.677	
SURVEY	12.519	12.408	12.375	12.509	12.522	12.040	
OFFSET	0.000	3.400	3.850	4.030	6.130	9.383	

		-3%		3%	2.5%	3%	
DATUM RL 5.500							
DESIGN	12.249	12.166	12.126	12.215	12.365	12.472	
SURVEY	12.249	12.079	12.059	11.777	11.751	11.336	
	0.000	2.780	3.230	5.330	5.510	9.410	

		-3%		Ţ	3%		2.5%	3%	
DATUM RL 5.500									
DESIGN	11.990	11.906	11.866	11.906	11.955	12.105	12.158	12.212	
SURVEY	11.990	11.808	11.785	11.763	11.644	11.629	11.350	11.059	
OFFSET	0.000	2.808	3.258	3.708	5.358	5.538	7.638	9.438	

CH 11.122 CH 30 CH 50

HORZ SCALE 1:200 VERT SCALE 1:400

					Client
				North	WARRIEWOOD
					DEVELOPERS
ISSUED FOR APPROVAL	15.12.23	RH	BK		PTY LTD
Description	Date	Drawn	Approved		




ACOR Consultants (CC) Pty Ltd
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ERINA NSW 2250, Australia
T +61 2 4324 3499


WARRIEWOOD ROAD
WARRIEWOOD
WARRIEWOOD

ROAD CROSS SECTIONS (MC02)
WARRIEWOOD ROAD SHEET 1 OF 2 Date Scale A DEC 2023 AS NOTED

C3.11

Project No. CC230177

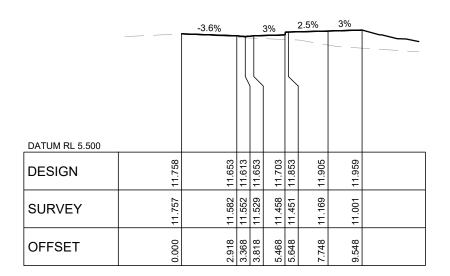

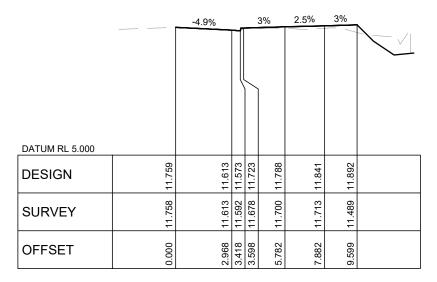

CH 80 CH 93.576

		-3%		;	3%		2.5%	3%	
DATUM RL 6.000									
DESIGN	11.805	11.718	11.678	11.718	11.768	11.918	11.970	12.024	
SURVEY	11.805	11.629	11.603	11.577	11.475	11.464	11.360	11.293	
OFFSET	0.000	2.881	3.331	3.781	5.431	5.611	7.711	9.511	

		-7.2%	3.	6%			2.5%	3%	
DATUM RL 5.000									
DESIGN	11.758	11.546	11.506	11.548	11.698	11.727	11.779	11.833	
SURVEY	11.757	11.502	11.468	11.470		11.411	11.305	11.132	
OFFSET	0.000	2.955	3.405	4.553	4.733	5.704	7.804	9.585	

CH 70 CH 90

HORZ SCALE 1:200 VERT SCALE 1:400

	Client				
				North	WARRIEWOOD
					DEVELOPERS
ISSUED FOR APPROVAL	15.12.23	RH	BK		PTY LTD
Description	Date	Drawn	Approved		




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ERINA NSW 2250, Australia
T +61 2 4324 3499

PROPOSED RESIDENTIAL
DEVELOPMENT

(No. 43 - 49) WARRIEWOOD ROAD WARRIEWOOD

ROAD CROSS SECTIONS (MC02) WARRIEWOOD ROAD SHEET 2 OF 2 Date Scale A DEC 2023 AS NOTED Project No. CC230177

C3.12

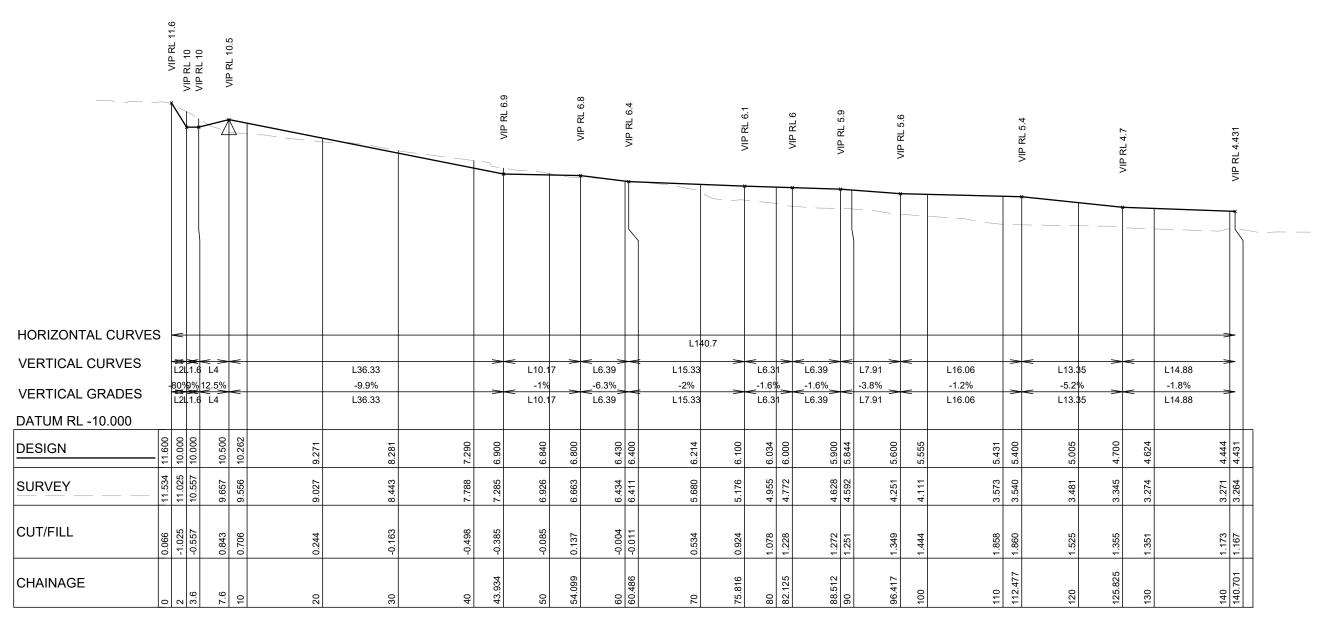

DR01 - LONGITUDINAL SECTION HORZ SCALE 1:500 VERT SCALE 1:250

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		Client				
					North	WARRIEWOOD
						DEVELOPERS
	ISSUED FOR APPROVAL	15.12.23	RH	BK		PTY LTD
е	Description	Date	Drawn	Approved		
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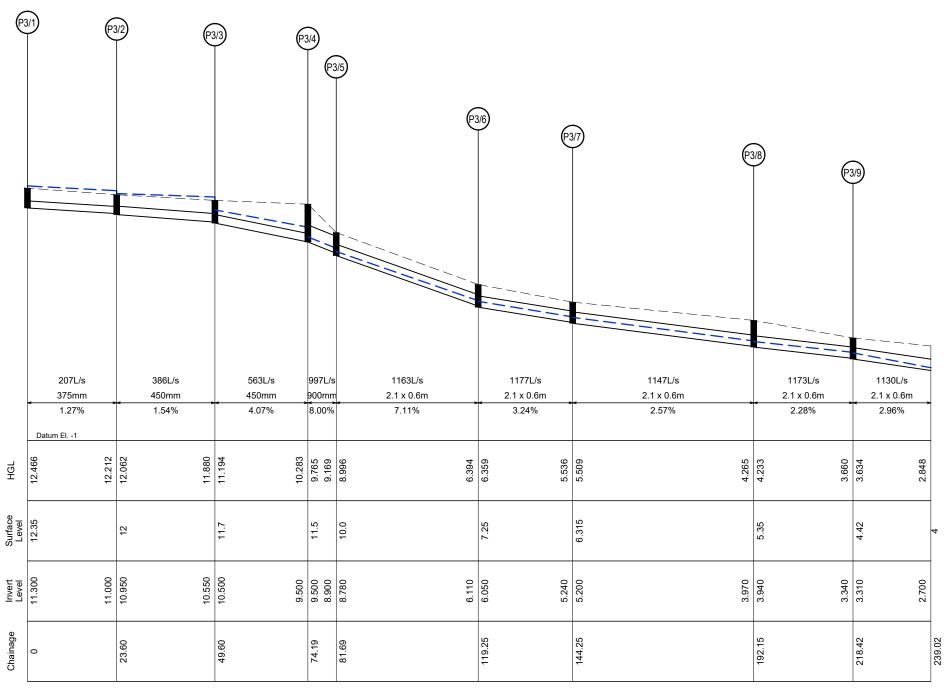
ACOR Consultants (CC) Pty Ltd

Platinum Building, Suite 2.01, 4 Ilya Avenue ERINA NSW 2250, Australia T +61 2 4324 3499 DEVELOPMENT PROPOSED RESIDENTIAL (No. 43 - 49) WARRIEWOOD ROAD


DRAINAGE EASEMENT LONGITUDINAL SECTION (DR01) Date Scale A DEC 2023 AS NOTED

CC230177

C3.13



LONG SECTION (100YR ARI + CC) DRAINAGE LINE 3

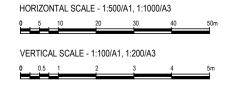

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		Client				
					North	WARRIEWOOD
						DEVELOPERS
	ISSUED FOR APPROVAL	15.12.23	RH	BK		PTY LTD
ıe	Description	Date	Drawn	Approved		
0	1cm at full size	_	_	Ī		




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ERINA NSW 2250, Australia


T +61 2 4324 3499
2 @ @

PROPOSED RESIDENTIAL
DEVELOPMENT
(No. 43 - 49)
WARRIEWOOD ROAD
WARRIEWOOD

	NAGE PIT & PIPE BITUDINAL SECTION								
Drawn	Date	Scale A1	Q.A. Check						
LW	DEC 2023	AS NOTED	-						
Designed	Project No.	Dwg. No.							
BK	CC230	C3.14							

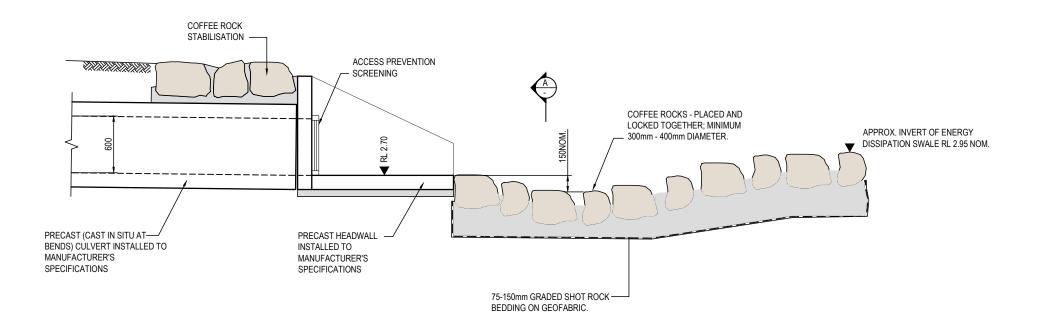

CULVERT HEADWALL SECTION SCALE - 1:20/A1, 1:40/A3

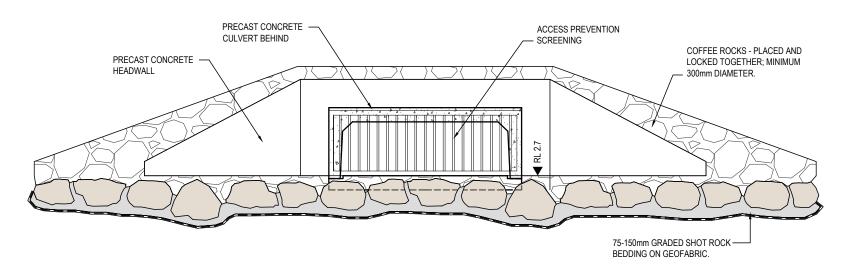

SECTION SCALE: 1:20/A1, 1:40/A3

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					North	WARRIEWOO
						DEVELOPERS
	ISSUED FOR APPROVAL	15.12.23	RH	BK		PTY LTD
е	Description	Date	Drawn	Approved		
- 0	1cm at full size 10cm					

OD RS




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Platinum Building, Suite 2.01, 4 llya Avenue
ERINA NSW 2250, Australia

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2 2 2
ANNERS DEVELOPMENT CONSULTANTS


PROPOSED RESIDENTIAL DEVELOPMENT

(No. 43 - 49) WARRIEWOOD ROAD WARRIEWOOD

TYPICAL DETAIL SHEET 1 OF 2									
Drawn	Date	Scale A1	Q.A. Check						
LW	DEC 2023	AS NOTED	-						
Designed	Project No.	Dwg. No.							
BK	CC230	C3.15							

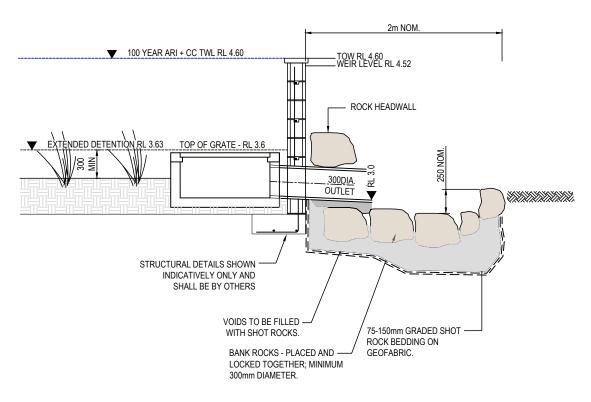

OUTLET AND ENERGY DISSIPATION SWALE - BASIN 1

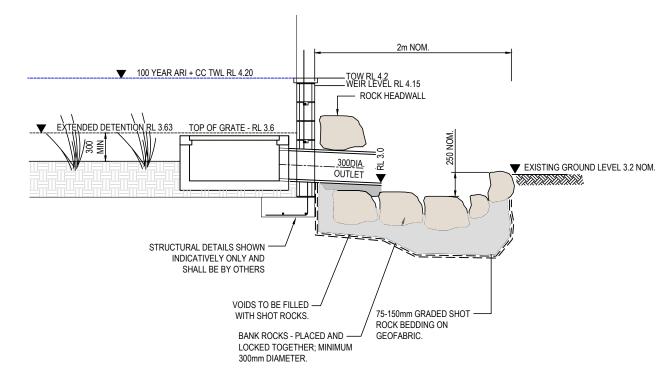

OUTLET AND ENERGY DISSIPATION SWALE - BASIN 2

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		Client							
					North	WARRIEWOOD			
						DEVELOPERS			
	ISSUED FOR APPROVAL	15.12.23	RH	BK	PTY LTD	PTY LTD			
sue	Description	Date	Drawn	Approved					
ľ	1cm at full size								



ACOR Consultants (CC) Pty Ltd

Platinum Building, Suite 2.01, 4 Ilya Avenue ERINA NSW 2250, Australia T +61 2 4324 3499 DEVELOPMENT PROPOSED RESIDENTIAL (No. 43 - 49) WARRIEWOOD ROAD

TYPICAL DETAIL SHEET 2 OF 2 DEC 2023 AS NOTED CC230177 C3.16