Certificate number: 1002814S_02

| 5-6 | | | |
|---|---------------------|------------------------------|--------------------|
| Water Commitments | Show on DA plans | Show on CC/CDC plans & specs | Certifier check |
| Fixtures | | | |
| The applicant must install showerheads with a minimum rating of 3 star (> 7.5 but <= 9 L/min) in all showers in the development. | | ~ | ~ |
| The applicant must install a toilet flushing system with a minimum rating of 4 star in each toilet in the development. | | ~ | ~ |
| The applicant must install taps with a minimum rating of 4 star in the kitchen in the development. | | ~ | |
| The applicant must install basin taps with a minimum rating of 4 star in each bathroom in the development. | | ~ | |
| Alternative water | | | |
| Rainwater tank | | | |
| The applicant must install a rainwater tank of at least 4000 litres on the site. This rainwater tank must meet, and be installed in accordance with, the requirements of all applicable regulatory authorities. | ~ | ~ | V |
| The applicant must configure the rainwater tank to collect rain runoff from at least 171.1 square metres of the roof area of the development (excluding the area of the roof which drains to any stormwater tank or private dam). | | ~ | ~ |
| The applicant must connect the rainwater tank to: | | | |
| all toilets in the development | | | |
| the cold water tap that supplies each clothes washer in the development | | | |
| at least one outdoor tap in the development (Note: NSW Health does not recommend that rainwater be used for human consumption in areas with potable water supply.) | | J | J |
| Thermal Comfort Commitments | Show on DA plans | Show on CC/CDC plans & specs | Certifier check |

| the cold water tap that supplies each clothes washer in the development at least one outdoor tap in the development (Note: NSW Health does not recommend that rainwater be used for human consumption in areas with potable water supply.) | | 7 | ~ |
|--|---------------------|------------------------------|-----------------|
| Thermal Comfort Commitments | Show on DA plans | Show on CC/CDC plans & specs | Certifier check |
| Simulation Method | | | |
| The applicant must attach the certificate referred to under "Assessor Details" on the front page of this BASIX certificate (the "Assessor Certificate") to the development application and construction certificate application for the proposed development (or, if the applicant is applying for a complying development, to that application). The applicant must also attach the Assessor Certificate to the application for an occupation certificate for the proposed development. | | | |
| The Assessor Certificate must have been issued by an Accredited Assessor in accordance with the Thermal Comfort Protocol. | | | |
| The details of the proposed development on the Assessor Certificate must be consistent with the details shown in this BASIX certificate, including the Cooling and Heating loads shown on the front page of this certificate. | | | |
| The applicant must show on the plans accompanying the development application for the proposed development, all matters which the Assessor Certificate requires to be shown on those plans. Those plans must bear a stamp of endorsement from the Accredited Assessor to certify that this is the case. The applicant must show on the plans accompanying the application for a construction certificate (or complying development certificate, if applicable), all thermal performance specifications set out in the Assessor Certificate, and all aspects of the proposed development which were used to calculate those specifications. | ~ | ~ | ~ |
| The applicant must construct the development in accordance with all thermal performance specifications set out in the Assessor Certificate, and in accordance with those aspects of the development application or application for a complying development certificate which were used to calculate those specifications. | | ~ | ~ |
| The applicant must construct the floors and walls of the dwelling in accordance with the specifications listed in the table below. | | | |

| Floor and wall construction | Area |
|--------------------------------------|---|
| floor - concrete slab on ground | All or part of floor area square metres |
| floor - suspended floor above garage | All or part of floor area |

| Energy Commitments | Show on DA plans | Show on CC/CDC plans & specs | Certifier check |
|--|------------------|------------------------------|--------------------|
| Hot water | | | |
| The applicant must install the following hot water system in the development, or a system with a higher energy rating: gas instantaneous with a performance of 5 stars. | V | ~ | ~ |
| Cooling system | | | |
| The applicant must install the following cooling system, or a system with a higher energy rating, in at least 1 living area: 3-phase airconditioning; Energy rating: EER 3.0 - 3.5 | | ~ | ~ |
| The applicant must install the following cooling system, or a system with a higher energy rating, in at least 1 bedroom: 3-phase airconditioning; Energy rating: EER 3.0 - 3.5 | | ~ | ~ |
| The cooling system must provide for day/night zoning between living areas and bedrooms. | | ~ | V |
| Heating system | | | |
| The applicant must install the following heating system, or a system with a higher energy rating, in at least 1 living area: 3-phase airconditioning; Energy rating: EER 3.0 - 3.5 | | ~ | ~ |
| The applicant must install the following heating system, or a system with a higher energy rating, in at least 1 bedroom: 3-phase airconditioning; Energy rating: EER 3.0 - 3.5 | | ~ | v |
| The heating system must provide for day/night zoning between living areas and bedrooms. | | ~ | V |
| Ventilation | | | |
| The applicant must install the following exhaust systems in the development: | | | |
| At least 1 Bathroom: individual fan, not ducted; Operation control: manual switch on/off | | ~ | V |
| Kitchen: individual fan, ducted to façade or roof; Operation control: manual switch on/off | | ~ | ~ |
| Laundry: natural ventilation only, or no laundry; Operation control: n/a | | ~ | ~ |
| Artificial lighting | | | |
| The applicant must ensure that the "primary type of artificial lighting" is fluorescent or light emitting diode (LED) lighting in each of the following rooms, and where the word "dedicated" appears, the fittings for those lights must only be capable of accepting fluorescent or light emitting idiode (LED) lamps: | | | |
| at least 4 of the bedrooms / study; | | ~ | ~ |
| Energy Commitments | Show on DA plans | Show on CC/CDC plans & specs | Certifier check |
| at least 5 of the living / dining rooms; | | | |
| | | • | |

| at least 4 of the bedrooms / study; | | ~ | • |
|---|---------------------|------------------------------|-----------------|
| Energy Commitments | Show on DA plans | Show on CC/CDC plans & specs | Certifier check |
| at least 5 of the living / dining rooms; | | ~ | ~ |
| • the kitchen; | | ~ | ~ |
| all bathrooms/toilets; | | ~ | ~ |
| the laundry; | | ~ | ~ |
| • all hallways; | | V | ~ |
| Natural lighting | | | |
| The applicant must install a window and/or skylight in 4 bathroom(s)/toilet(s) in the development for natural lighting. | ~ | ~ | V |
| Other | | | |
| The applicant must install a gas cooktop & electric oven in the kitchen of the dwelling. | | - | |
| The applicant must construct each refrigerator space in the development so that it is "well ventilated", as defined in the BASIX definitions. | | _ | |

| | | | | N | 19.02.20 | SERVICE FREE ZONE ADDED TO SITE | FD |
|--------------------|----------|-------------------|-----|-----|----------|---|------|
| QUOTE | DATE | QUOTE NUMBER | REV | М | 10.02.20 | BATH SHOWER CHANGE TO WHITELY RAIL | FD |
| KITCHEN | 18.04.19 | 11875 | - | L | 04.02.20 | TAP NOTE REMOVED FROM ALFRESCO AREA | FD |
| ZURCORP ELECTRICAL | 16.05.19 | ZAQ1903636 | - | K | 24.01.20 | FINAL CONSTRUCTION PLAN | FD |
| TILES | 12.12.19 | 5896 | - | J | 14.01.20 | CC AMENDMENTS | M.H. |
| CARPET | 22.03.19 | 29913455 | - | I | 09.01.20 | REGISTERED CONTOUR ADDED | JS |
| ZURCORP SECURITY | 16.05.19 | ZAQ1903635 | - | Н | 09.12.19 | RELOCATED DOORS TO ALFRESCO | FD |
| EHI | 04.04.19 | 101218-01 | - | G | 28.10.19 | INITIAL CONSTRUCTION PLAN | FD |
| AIR CONDITIONING | 27.03.19 | 29913455 | - | F | 12.04.19 | COORDINATE HYDRAULICS, EXTERNAL COLOURS & BASIX | MD |
| STAIRS | 15.03.19 | YQ113298-S | - | Е | 02.04.19 | COORDINATE RETAINING WALLS | MD |
| LANDSCAPE | 03.04.19 | 1903 | В | D | 19.03.19 | DA DRAWINGS | PG. |
| HYDRAULICS | 11.04.19 | C8985-13455 | 1 | С | 13.03.19 | PCV1 | PJ |
| ENGINEER | 16.01.20 | 85927CL | Α | В | 28.02.19 | CONTRACT DRAWINGS | PG. |
| PEG OUT | 17.01.20 | 21/1047441/294438 | I | Α | 07.02.19 | PRELIMINARY TENDER | BG |
| | | | | REV | DATE | AMENDMENTS | BY |

58.3 MJ/m²

www.nathers.gov.au

Certificate no.: Assessor Name: Accreditation no.: Certificate date: Dwelling Address: Proposed Road

Warriewood, NSW 2102

www.nathers.gov.au

0003694460 lan Fry VIC/BDAV/12/1441 15 Mar 2019



| SITE: | 330.00 m² |
|---------------|-----------------------|
| GROUND FLOOR: | 112.26 m² |
| FIRST FLOOR: | 139.05 m² |
| GARAGE: | 23.73 m² |
| PORCH: | 2.25 m ² |
| BALCONY: | N/A m² |
| ALFRESCO: | 15.52 m ² |
| | m² |
| TOTAL: | 292.81 m ² |
| | |

AREAS

| | 2.1 | CONSTRUCTION MANAGEMENT |
|---|----------------|-------------------------|
| | | |
| | 13 | DETAILS |
| | 12 | SLAB PLAN |
| | 11 | STEEL PLAN |
| | 10 | WET AREA DETAILS |
| | 9 | WET AREA DETAILS |
| | 8 | ELECTRICAL LAYOUT |
| | 7 | SECTION |
| | 6 | ELEVATIONS |
| | 5 | ELEVATIONS |
| | 4 | FIRST FLOOR PLAN |
| | 3 | GROUND FLOOR PLAN |
| | 2 | SITE PLAN |
| | c ¹ | COVER SHEET |
| Ч | SHEET | DESCRIPTION |

19/02/2020 12:34:36 PM, CONSTRUCTION DRAWIN

© ALL RIGHTS RESERVED This plan is the property of CLARENDON HOMES (NSW) P/L

Any copying or altering of the drawing shall not be undertaken without written nermission from

PRODUCT: PARKHILL 32 Prominent R/H Garage

Evolution Specification Master Issued: 07.08.15


CLIENT: FINAL CONSTRUCTION PLAN Mr. SOMMER Mrs. SOMMER DRAWN: DATE: 28.02.19 SITE ADDRESS: PG. Lot 17 RATIO @ A3: CHECKED: N\Α J.S No.1 Bubalo Street SHEET: JOB No: 29913455 NSW WARRIEWOOD 2102

Clarendon Homes

Clarendon Homes (NSW) P/L

21 Solent Circuit, Baulkham Hills NSW 2153 T: (02) 8851 5300

CLARENDON HOMES (NSW) P/L # ALL DIMENSIONS TO STRUCTURAL ELEMENTS. DIMENSIONS TO BE REAL IN PREFERENCE TO SCALING.

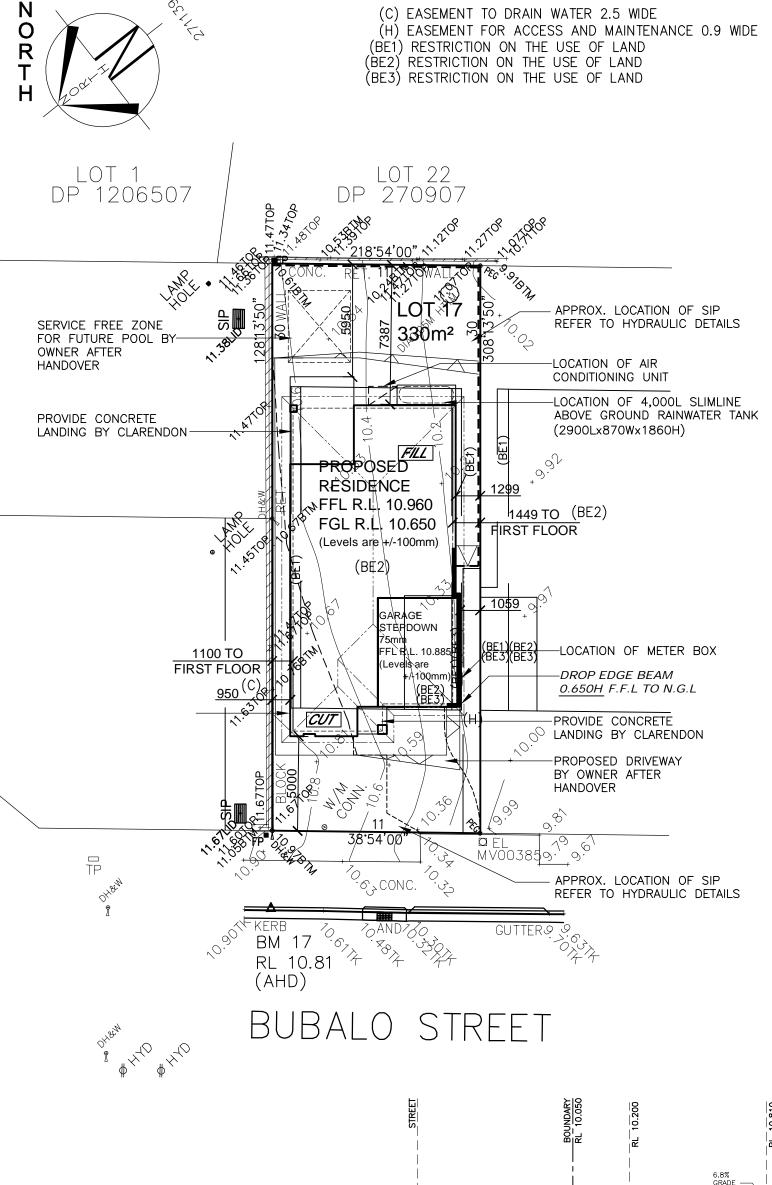

17 LOT D.P: 271139

L.G.A: NORTHERN BEACHES

SITING HAS BEEN COMPLETED IN ACCORDANCE WITH PITTWATER DCP 21 - D16

| SITE AREA | 330 m² |
|--|----------------------|
| SITE COVERAGE | |
| HOUSE FOOTPRINT: | 153.8 m² |
| ESTIMATED DRIVEWAY, PATHS & PAVING: | 49.4 m² |
| TOTAL SITE COVERAGE: | 203.2 m ² |
| | 61.6% |
| MAX. ALLOWABLE BY DEVELOPER: | 65 % |
| LANDSCAPED AREA | |
| TOTAL LANDSCAPE AREA: | 126.7 m² |
| (MIN. DIMENSION OF 3.0m) | 38.4 % |
| MIN. REQUIRED BY COUNCIL: | 35 % |
| PRIVATE OPEN SPACE | |
| TOTAL OPEN SPACE AREA: (MIN. DIMENSION OF 4.0m) | 95.3 m² |
| MIN. REQUIRED BY COUNCIL: | 24 m² |
| HEIGHT RESTRICTION | |
| MAXIMUM RIDGE HEIGHT | 10.5 m |
| (F.F.L. MUST BE ACCURATE. CHANGES IN MAY NOT COMPLY WITH REQUIREMENTS) | LEVELS |

Maximum 1000mm CUT Maximum 1000mm FILL

WIND CLASSIFICATION: "N2" SLAB CLASSIFICATION: "M "

NOTE:

ALL GROUND LINES ARE APPROXIMATE. EXTENT OF FILL & BATTER WILL BE DETERMINED ON SITE. SEDIMENT BARRIERS ARE TO BE CUSTOMISED SITE SPECIFIC

STORMWATER TO STREET VIA RAINWATER TANK

REFER TO HYDRAULIC DETAILS

WATER APPROVAL

APPLICATION No.: TIR 795510 PIER INSPECTION REQUIRED: NO

COUNCIL D.A. CONSENT

D.A. NUMBER: 2019/0385

SITE PLAN

SCALE 1:200

GENERAL NOTES

A) THIS SURVEY IS SPECIFICALLY FOR CONTOUR PURPOSES ONLY. THE BOUNDARIES OF THE SUBJECT PROPERTY HAVE NOT BEEN INVESTIGATED

B) AREAS AND DIMENSIONS ARE SUBJECT TO SURVEY

C) SERVICES SHOWN HAVE BEEN DERIVED FROM VISUAL EVIDENCE APPARENT AT THE TIME OF SURVEY. THE RELEVANT SERVICE AUTHORITY SHALL BE CONTACTED TO VERIFY THE EXISTENCE AND POSITION OF ALL SERVICES PRIOR TO THE COMMENCEMENT OF ANY CONSTRUCTION OR FYCAVATION. ANY CONSTRUCTION OR EXCAVATION

D) CONTIOURS ARE INDICATIVE OF SURFACE TOPOGRAPHY ONLY, SURVEYED SPOT LEVELS ARE THE ONLY VALUES TO BE RELIED ON FOR REDUCED LEVELS ON PARTICULAR FEATURES.

GRADE -CHANGE GARAGE FLOOR LEVEL 10% FFL RL10.960 16.80% EXISTING GRADE (1.2%) 10% RL10.00 LEVEL WITH T.K T.K. RL10.000 1500 TRANSITION 3630 1500 TRANSI 4100 EXISTING CROS 6630

DRIVEWAY GRADIENT PROFILE 19/02/2020 12:34:38 PMs@QNSTRUCTION DRAWINGS

Clarendon Homes


Clarendon Homes (NSW) P/L 21 Solent Circuit, Baulkham Hills NSW 2153 T: (02) 8851 5300


© ALL RIGHTS RESERVED This plan is the property of CLARENDON HOMES (NSW) P/L Any copying or altering of the drawing shall not be undertaken without written permission from CLARENDON HOMES (NSW) P/L # ALL DIMENSIONS TO STRUCTURAL ELEMENTS. DIMENSIONS TO BE REA N PREFERENCE TO SCALING.


PRODUCT: PARKHILL 32 Prominent R/H Garage


Evolution Specification

CLIENT FINAL CONSTRUCTION PLAN Mr. SOMMER Mrs. SOMMER DRAWN: DATE: 28.02.19 PG. SITE ADDRESS RATIO @ A3: CHECKED: Lot 17 1:200 J.S No.1 Bubalo Street SHEET: JOB No 29913455 NSW **WARRIEWOOD 2102**

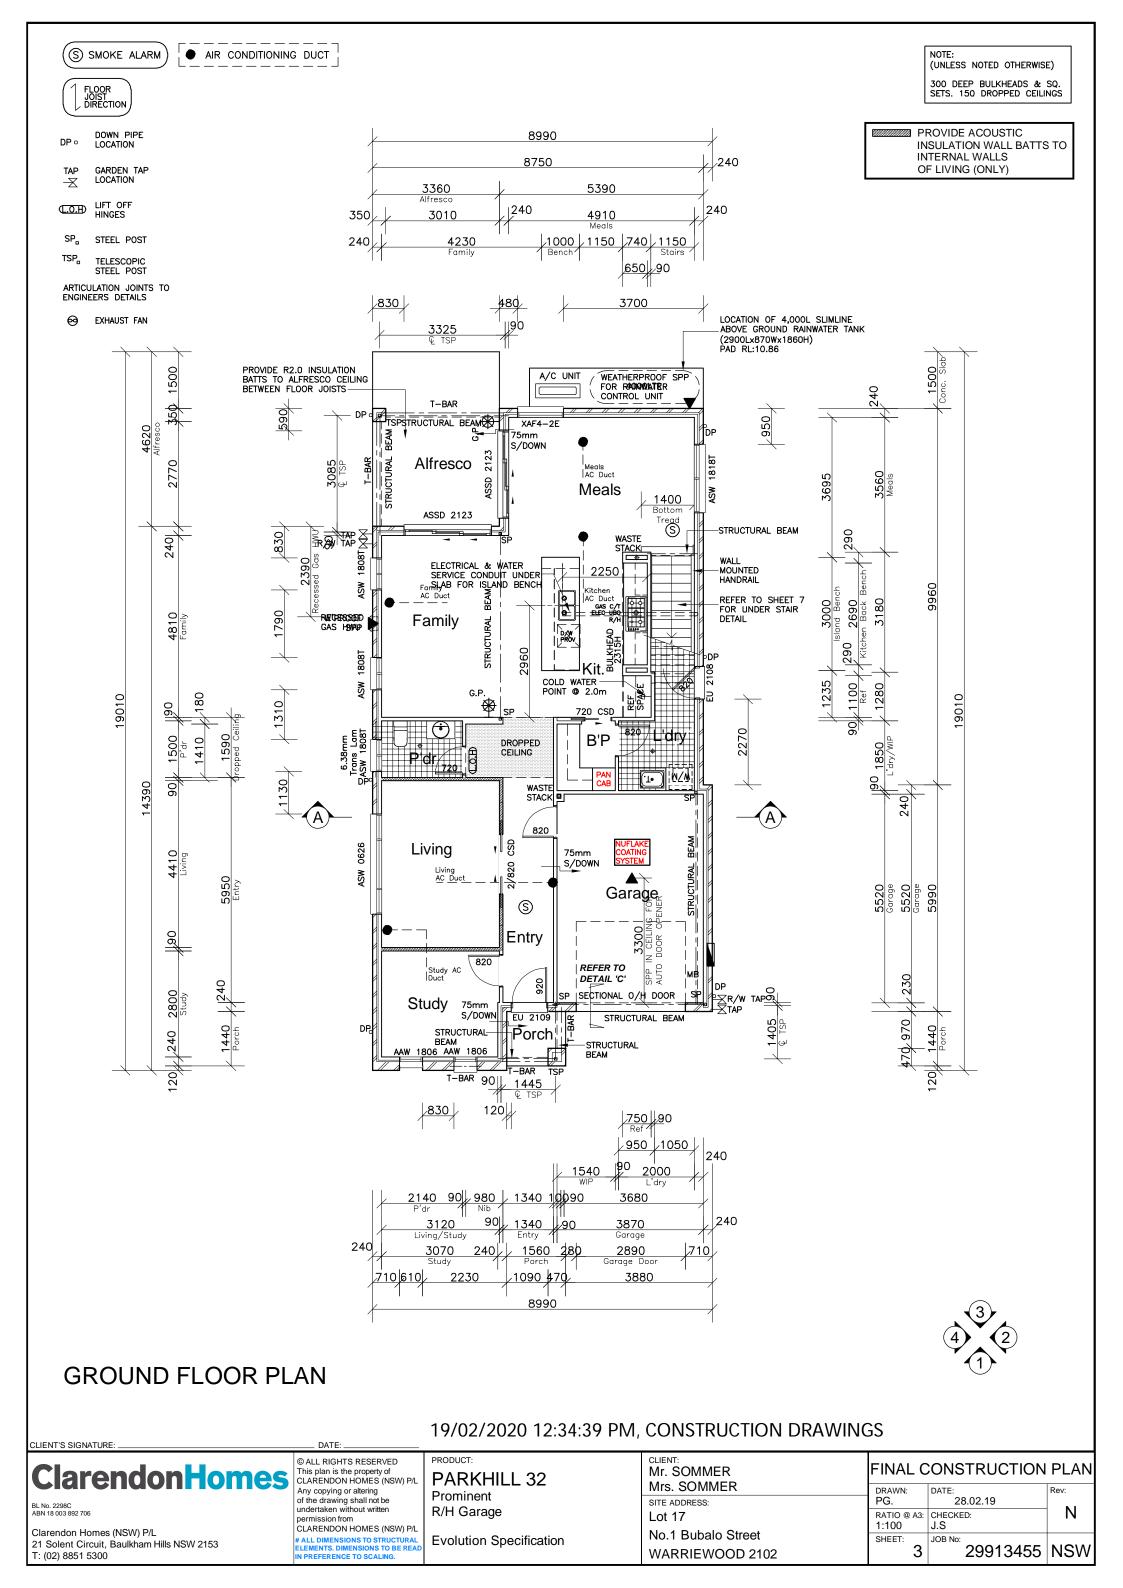

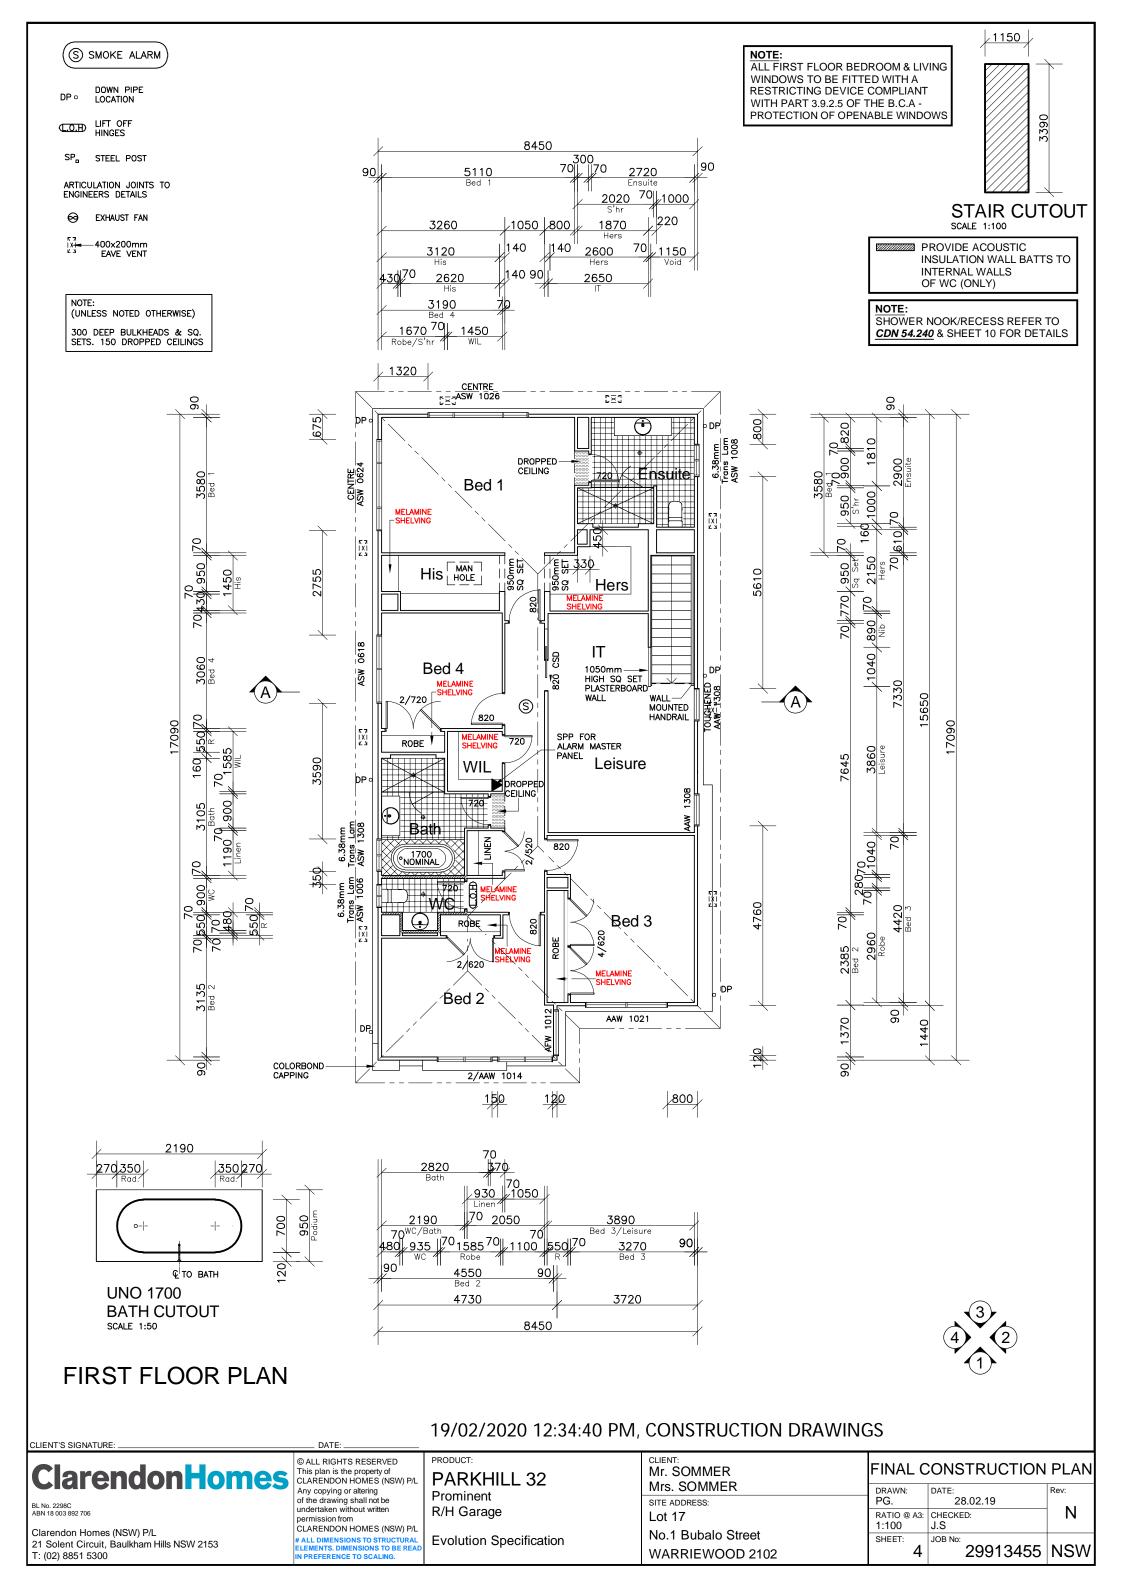

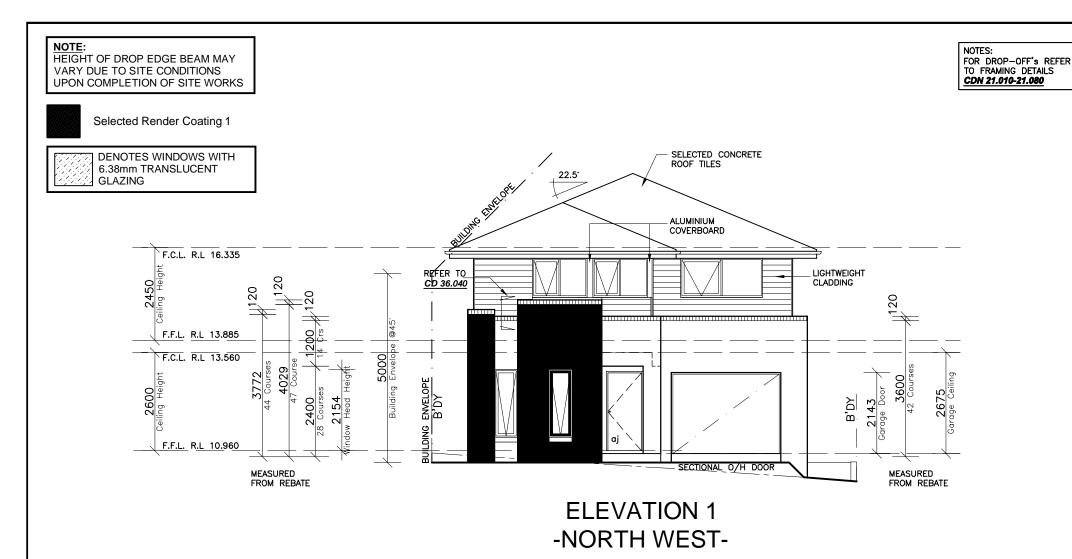

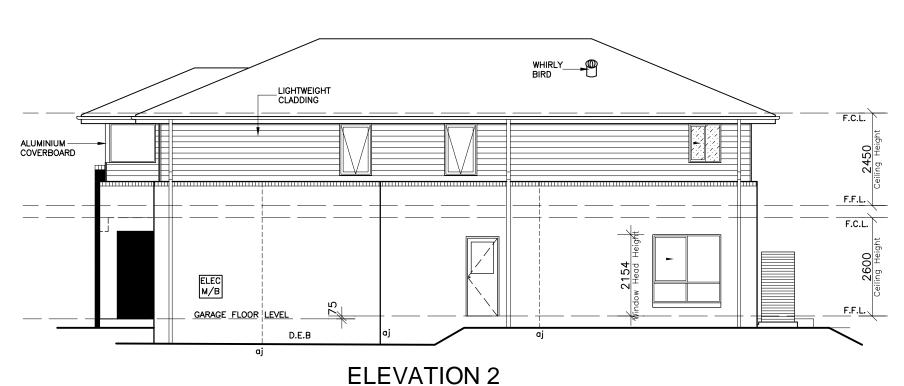

-SOUTH WEST

19/02/2020 12:34:41 PM, CONSTRUCTION DRAWINGS

ClarendonHomes

BL No. 2298C ABN 18 003 892 706

CLIENT'S SIGNATURE:

Clarendon Homes (NSW) P/L 21 Solent Circuit, Baulkham Hills NSW 2153 T: (02) 8851 5300 © ALL RIGHTS RESERVED
This plan is the property of
CLARENDON HOMES (NSW) P/L
Any copying or altering
of the drawing shall not be
undertaken without written
permission from
CLARENDON HOMES (NSW) P/L
ALL DIMENSIONS TO STRUCTURAL
ELEMENTS. DIMENSIONS TO BE REAE
IN PREFERENCE TO SCALING.

PRODUCT:
PARKHILL 32
Prominent
R/H Garage

Evolution Specification

CLIENT: FINAL CONSTRUCTION PLAN Mr. SOMMER Mrs. SOMMER DRAWN: DATE: PG. 28.02.19 SITE ADDRESS: Ν Lot 17 RATIO @ A3: CHECKED: 1:100 J.S No.1 Bubalo Street SHEET: JOB No: 29913455 NSW WARRIEWOOD 2102

NOTE: HEIGHT OF DROP EDGE BEAM MAY VARY DUE TO SITE CONDITIONS UPON COMPLETION OF SITE WORKS Selected Render Coating 1 **DENOTES WINDOWS WITH** 6.38mm TRANSLUCENT **GLAZING** F.C.L. R.L 16.335 LIGHTWEIGHT CLADDING F.F.L. R.L 13.885 EXCLUSION ZONE F.C.L. R.L 13.560 BUILDING ENVELOPE B'DY


'n

LOCATION OF 4,000L SLIMLINE ABOVE GROUND RAINWATER TANK (2900Lx870Wx1860H)
PAD RL:10.86

NOTES: FOR DROP-OFF'S REFER TO FRAMING DETAILS CDN 21.010-21.080

F.F.L. R.L 10.960

MEASURED FROM SLAB

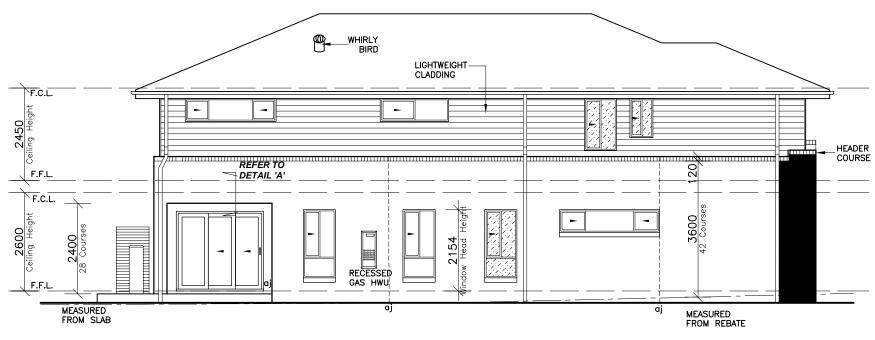

ELEVATION 3

-SOUTH EAST-

ELEVATION 4 -NORTH EAST-

19/02/2020 12:34:44 PM, CONSTRUCTION DRAWINGS

Clarendon Homes

CLIENT'S SIGNATURE:


Clarendon Homes (NSW) P/L 21 Solent Circuit, Baulkham Hills NSW 2153 T: (02) 8851 5300


© ALL RIGHTS RESERVED This plan is the property of CLARENDON HOMES (NSW) P/L Any copying or altering of the drawing shall not be undertaken without written nermission from CLARENDON HOMES (NSW) P/L # ALL DIMENSIONS TO STRUCTURAL ELEMENTS. DIMENSIONS TO BE REAI IN PREFERENCE TO SCALING.


PRODUCT: PARKHILL 32 Prominent R/H Garage

CLIENT: Mr. SOMMER Mrs. SOMMER SITE ADDRESS: Lot 17 No.1 Bubalo Street **Evolution Specification** WARRIEWOOD 2102


FINAL CONSTRUCTION PLAN DRAWN: DATE: PG. 28.02.19 Ν RATIO @ A3: CHECKED: 1:100 J.S SHEET: JOB No: 29913455 NSW

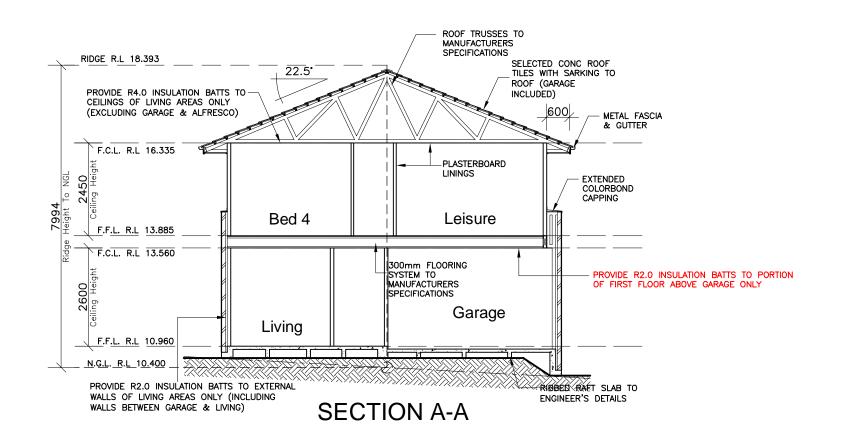

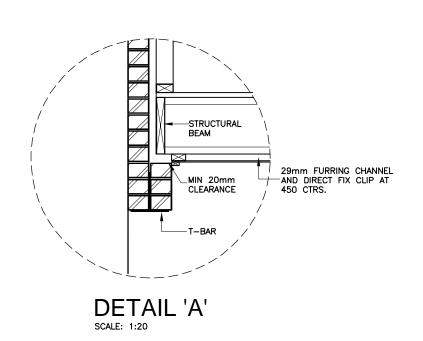

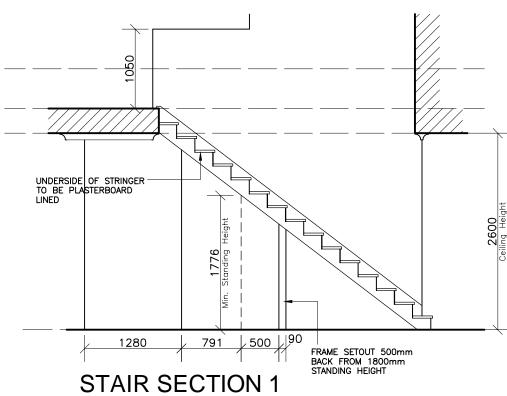

SCALE 1:50

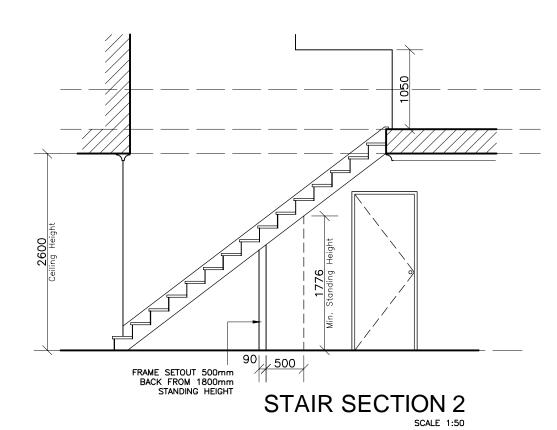

19/02/2020 12:34:45 PM, CONSTRUCTION DRAWINGS

Clarendon Homes

CLIENT'S SIGNATURE:

Clarendon Homes (NSW) P/L 21 Solent Circuit, Baulkham Hills NSW 2153 T: (02) 8851 5300

© ALL RIGHTS RESERVED This plan is the property of CLARENDON HOMES (NSW) P/L Any copying or altering of the drawing shall not be undertaken without written permission from CLARENDON HOMES (NSW) P/L # ALL DIMENSIONS TO STRUCTURAL ELEMENTS. DIMENSIONS TO BE REAI N PREFERENCE TO SCALING.

PRODUCT: PARKHILL 32 Prominent R/H Garage **Evolution Specification**

CLIENT: FINAL CONSTRUCTION PLAN Mr. SOMMER Mrs. SOMMER DRAWN: DATE: PG. 28.02.19 SITE ADDRESS: Ν Lot 17 RATIO @ A3: CHECKED: 1:100 J.S No.1 Bubalo Street SHEET: JOB No: 29913455 NSW WARRIEWOOD 2102




NOTE: FOR SAFETY REASONS CLARENDON RESIDENTIAL DOES NOT RECOMMEND PROVISION FOR LIGHT FITTINGS IN CEILINGS ABOVE DOUBLE STOREY VOIDS

NOTE: PROVIDE S9071 PREMIER LED DOWN LIGHTS. INSULATION TO BE LAID OVER THE APPROVED DOWN LIGHTS AS PER MANUFACTURERS **GUIDELINES**

| Electrical Legend- Standard items: | | Electrical Legend- Extra over items: | |
|---------------------------------------|----|---|----|
| SINGLE POWER POINT (SPP) | 0 | AIR CONDITIONING | 1 |
| DOUBLE POWER POINT (DPP) | 24 | GAS POINT | 1 |
| CEILING LIGHT OUTLET | 25 | AUTO DR SINGLE POWER POINT | 1 |
| EXT.WALL MOUNTED LIGHT POINT | 1 | ALARM SINGLE POWER POINT | 1 |
| EXT. WEATHERPROOF DPP | 1 | INTERCOM SINGLE POWER POINT | 0 |
| SMOKE DETECTOR | 3 | VACUUM SINGLE POWER POINT | 0 |
| EXHAUST FAN | 0 | SPA SINGLE POWER POINT | 0 |
| 2-WAY SWITCH | 1 | DOWN LIGHT | 10 |
| D/W SINGLE POWER POINT | 1 | INT.WALL MOUNTED LIGHT | 1 |
| REF. SINGLE POWER POINT | 1 | EXT. WEATHERPROOF SPP | 2 |
| M/W DOUBLE POWER POINT | 1 | CEILING FAN | 1 |
| R/H SINGLE POWER POINT | 1 | | |
| GAS C/T or UPRIGHT SPP | 1 | | |
| UBO SINGLE POWER POINT | 1 | | |
| OVEN ISOLATOR SWITCH | 1 | | |
| W/M DOUBLE POWER POINT | 1 | | |
| T.V. POINT | 2 | | |
| PHONE POINT | 2 | | |

EXHAUST FAN

| | | WEATHERPROOF FOR RAINWATER CONTROL UNIT | |
|-----|--|---|----------|
| III | ELECTRICAL & WATER SERVICE CONDUIT UNDER SIJAB FOR ISLAND BENCH Duct G.P. | | S |
| | - Living | | |
| | Living AC Duet Study AC Duet | 3300 SPP IN CEILING FOR AUTO DOOR OPENER | |

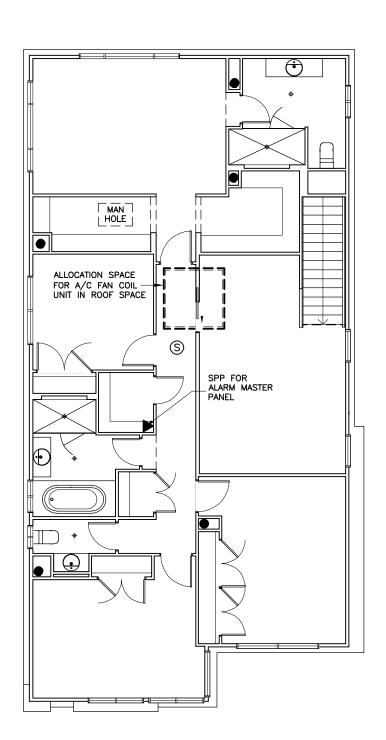

GROUND FLOOR ELECTRICAL LAYOUT

FIRST FLOOR **ELECTRICAL LAYOUT**

19/02/2020 12:34:46 PM, CONSTRUCTION DRAWINGS

Clarendon Homes

Clarendon Homes (NSW) P/L 21 Solent Circuit, Baulkham Hills NSW 2153

CLIENT'S SIGNATURE:


T: (02) 8851 5300


© ALL RIGHTS RESERVED This plan is the property of CLARENDON HOMES (NSW) P/L Any copying or altering of the drawing shall not be undertaken without written permission from CLARENDON HOMES (NSW) P/L # ALL DIMENSIONS TO STRUCTURAL ELEMENTS. DIMENSIONS TO BE REAL IN PREFERENCE TO SCALING.

PRODUCT: PARKHILL 32 Prominent R/H Garage

Evolution Specification


CLIENT: FINAL CONSTRUCTION PLAN Mr. SOMMER Mrs. SOMMER DRAWN: DATE: PG. 28.02.19 SITE ADDRESS: Ν Lot 17 RATIO @ A3: CHECKED: 1:100 J.S No.1 Bubalo Street SHEET: JOB No: 29913455 NSW WARRIEWOOD 2102

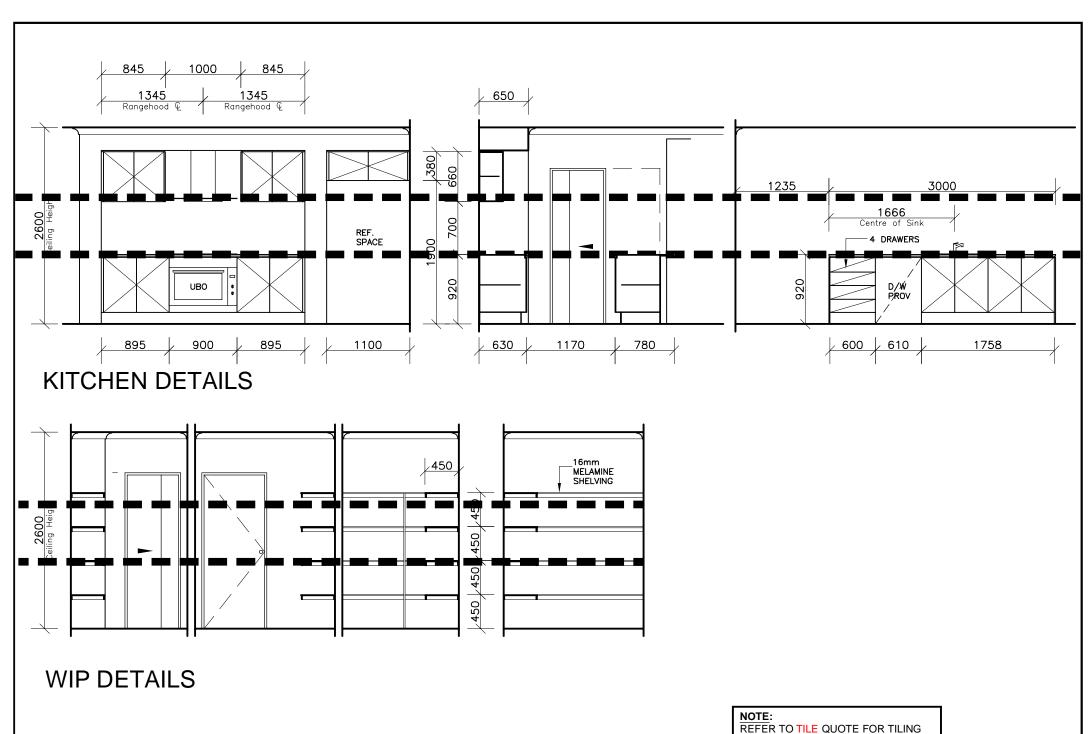

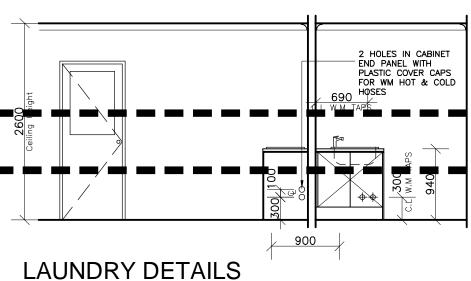

REFER TO TILE QUOTE FOR TILING LAYOUT

NOTE: REFER TO YOUR HOME KITCHEN DRAWINGS AND QUOTE

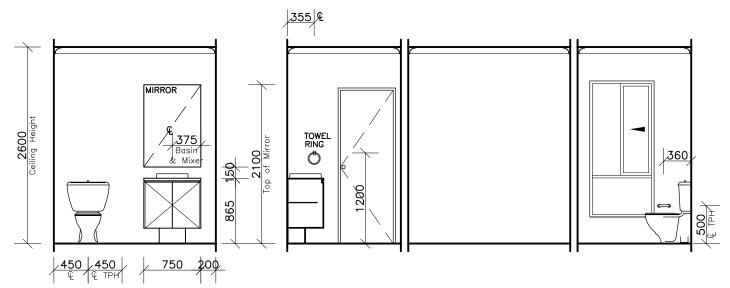

POWDER ROOM DETAILS

1. ALL PLUMBING SETOUT DIMENSIONS ARE FROM THE TIMBER FRAME

2. INTERNAL ELEVATIONS ARE INDICATIVE ONLY. ALL CUPBOARD DIMENSIONS TO BE SITE MEASURED

19/02/2020 12:34:47 PM, CONSTRUCTION DRAWINGS

Clarendon Homes

CLIENT'S SIGNATURE:


Clarendon Homes (NSW) P/L 21 Solent Circuit, Baulkham Hills NSW 2153 T: (02) 8851 5300


© ALL RIGHTS RESERVED This plan is the property of CLARENDON HOMES (NSW) P/L Any copying or altering of the drawing shall not be undertaken without written nermission from CLARENDON HOMES (NSW) P/L # ALL DIMENSIONS TO STRUCTURAL ELEMENTS. DIMENSIONS TO BE REAL IN PREFERENCE TO SCALING.

PRODUCT: PARKHILL 32 Prominent R/H Garage

Evolution Specification

| IIII COMMILIN | FINAL CONSTRUCTION PLAI | | | |
|--------------------|-------------------------|-----------------|------|--|
| Mrs. SOMMER | DRAWN: | DATE: | Rev: | |
| SITE ADDRESS: | PG. | 28.02.19 | | |
| Lot 17 | RATIO @ A3: 1:50 | CHECKED: J.S | N | |
| No.1 Bubalo Street | SHEET: | JOB No: | | |
| WARRIEWOOD 2102 | 9 | 29913455 | NSW | |

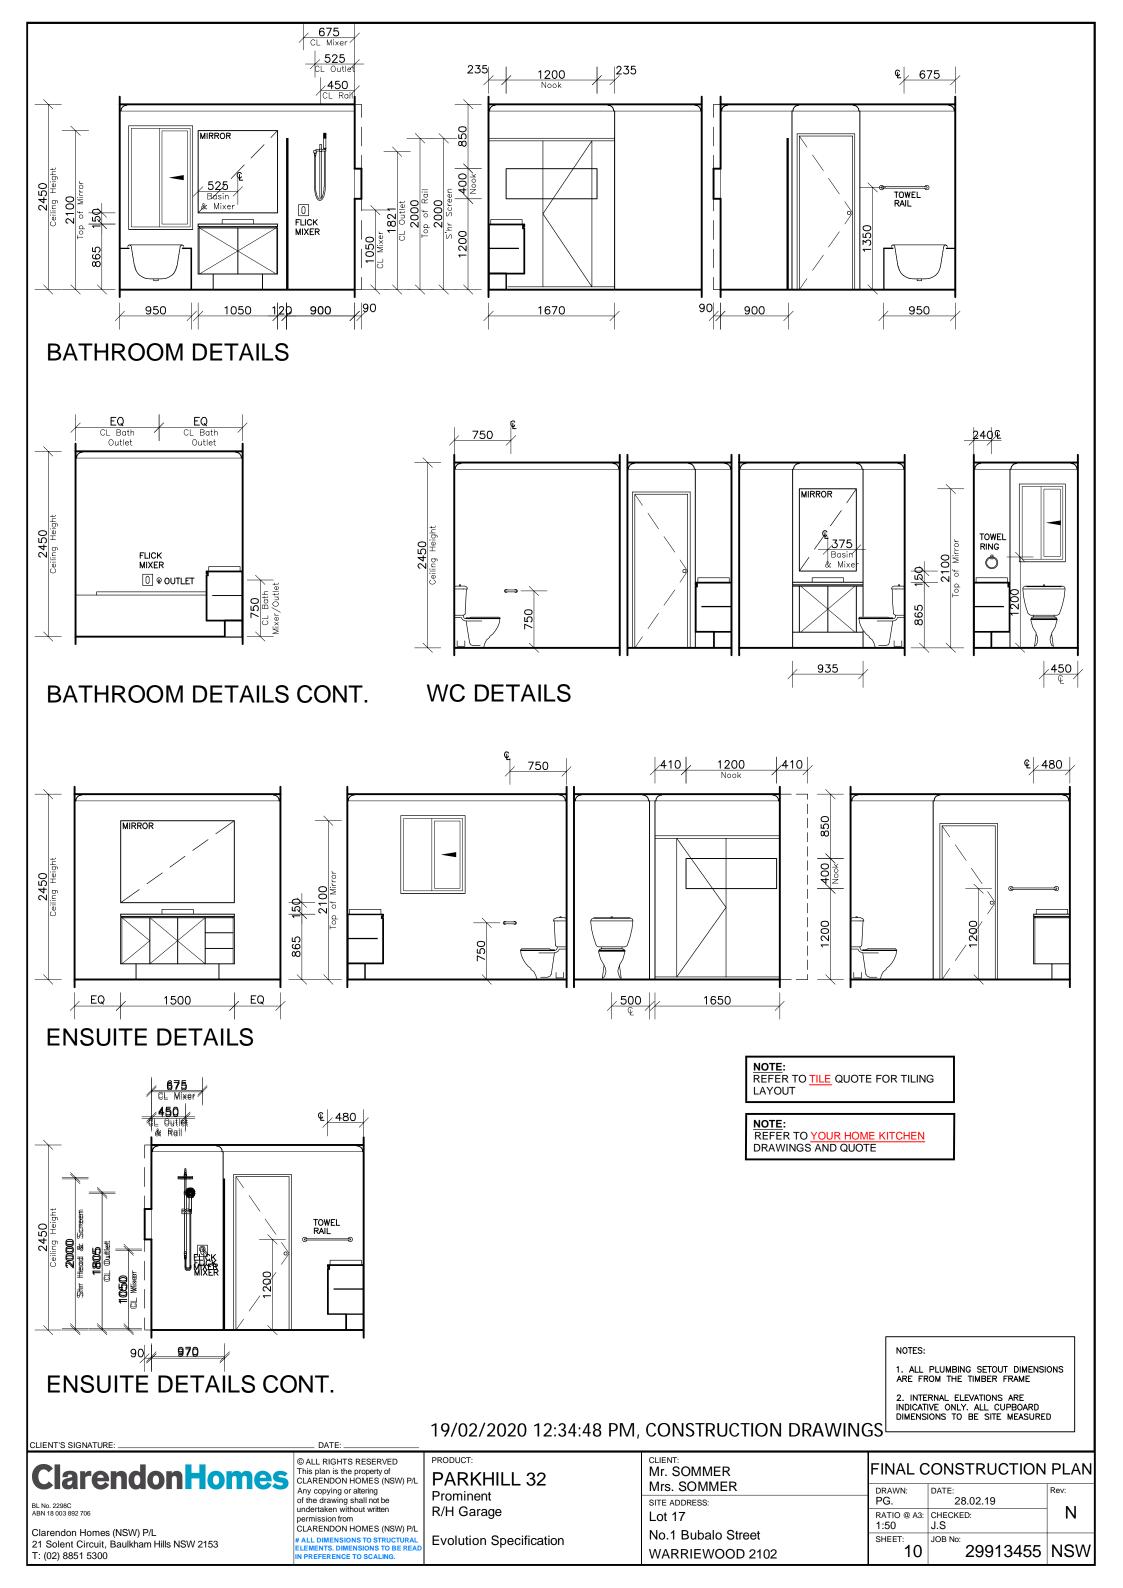


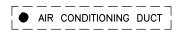



STEEL POST

TSP_o TELESCOPIC STEEL POST

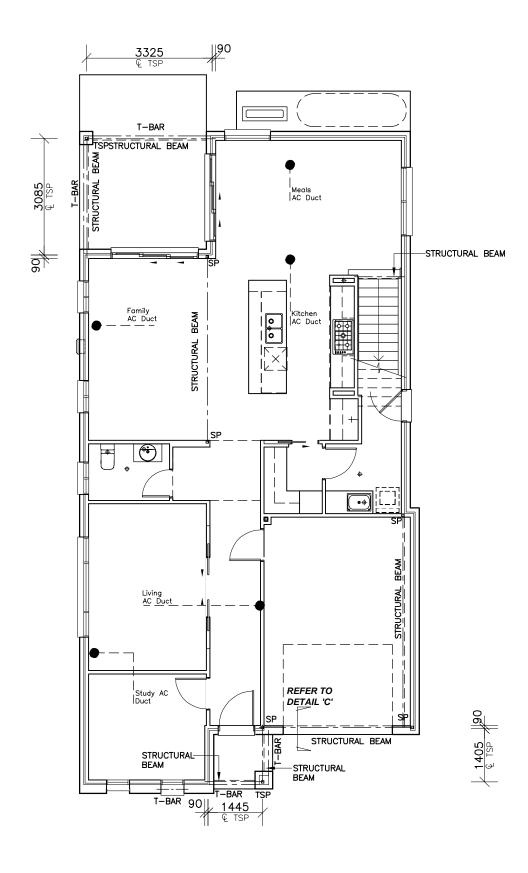

STEEL PLAN

19/02/2020 12:34:49 PM, CONSTRUCTION DRAWINGS

CLIENT'S SIGNATURE: **Clarendon Homes**

Clarendon Homes (NSW) P/L 21 Solent Circuit, Baulkham Hills NSW 2153 T: (02) 8851 5300

© ALL RIGHTS RESERVED This plan is the property of CLARENDON HOMES (NSW) P/L Any copying or altering of the drawing shall not be undertaken without written permission from CLARENDON HOMES (NSW) P/L # ALL DIMENSIONS TO STRUCTURAL ELEMENTS. DIMENSIONS TO BE REAL IN PREFERENCE TO SCALING.

DATE:


PRODUCT: PARKHILL 32 Prominent R/H Garage

Evolution Specification

CLIENT: Mr. SOMMER FINAL CONSTRUCTION PLAN Mrs. SOMMER DRAWN: DATE: PG. 28.02.19 SITE ADDRESS: Ν RATIO @ A3: CHECKED: Lot 17 J.S 1:100 No.1 Bubalo Street SHEET: JOB No: 29913455 NSW WARRIEWOOD 2102

DP • DOWN PIPE LOCATION

TAP GARDEN TAP LOCATION

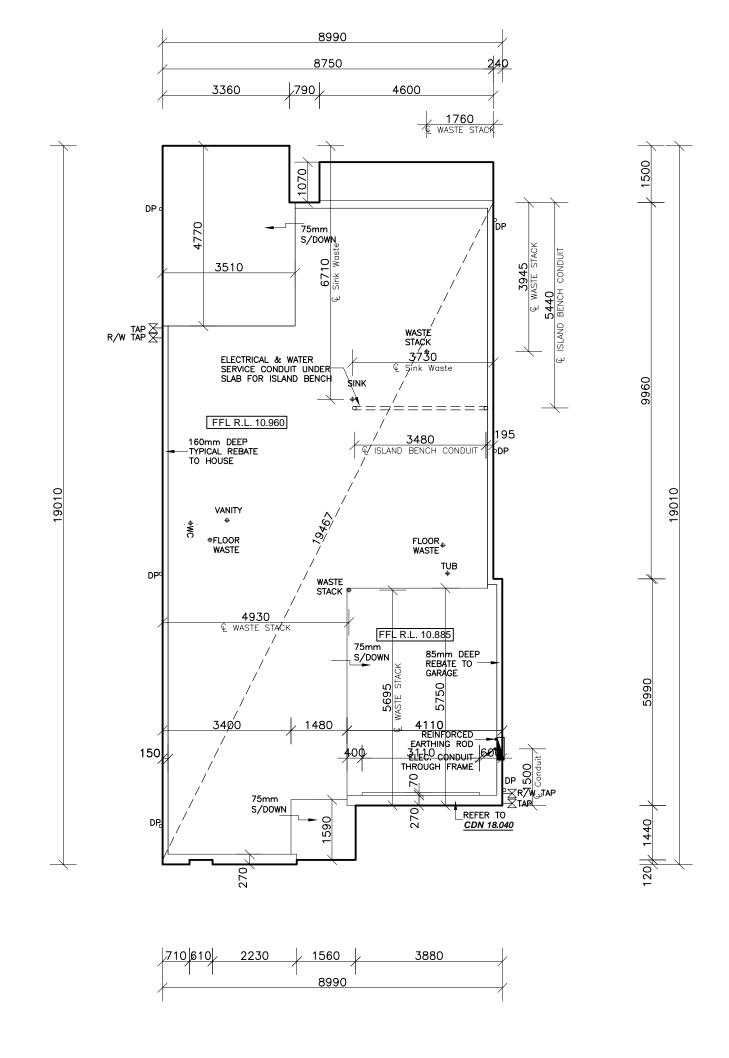

SLAB PLAN

CLIENT'S SIGNATURE:

19/02/2020 12:34:50 PM, CONSTRUCTION DRAWINGS

ClarendonHomes

ABN 18 003 892 706

Clarendon Homes (NSW) P/L
21 Solent Circuit, Baulkham Hills NSW 2153
T: (02) 8851 5300


© ALL RIGHTS RESERVED
This plan is the property of
CLARENDON HOMES (NSW) P/L
Any copying or altering
of the drawing shall not be
undertaken without written
permission from
CLARENDON HOMES (NSW) P/L
ALL DIMENSIONS TO STRUCTURAL
ELEMENTS, DIMENSIONS TO BE REAL
IN PREFERENCE TO SCALING.


DATE:

PARKHILL 32
Prominent
R/H Garage

Evolution Specification

CLIENT: FINAL CONSTRUCTION PLAN Mr. SOMMER Mrs. SOMMER DRAWN: DATE: PG. 28.02.19 SITE ADDRESS: Ν Lot 17 RATIO @ A3: CHECKED: J.S 1:100 No.1 Bubalo Street SHEET: JOB No: 29913455 NSW WARRIEWOOD 2102

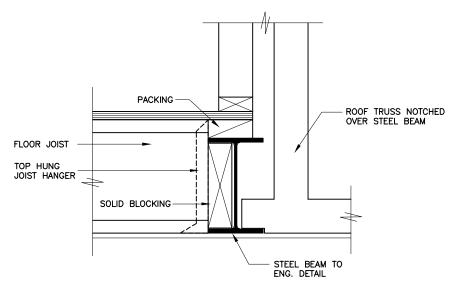


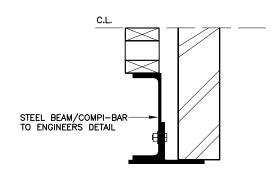

TYPICAL DETAIL
GENERIC STEEL BEAM SHOWN FOR
ILLUSTRATION PURPOSES ONLY.
REFER TO ENGINEERS DETAILS

DETAIL 'B' (CDN 27.020) TYPICAL DETAIL
GENERIC STEEL BEAM SHOWN FOR
ILLUSTRATION PURPOSES ONLY.
REFER TO ENGINEERS DETAILS

DETAIL 'C' (CDN 27.050)

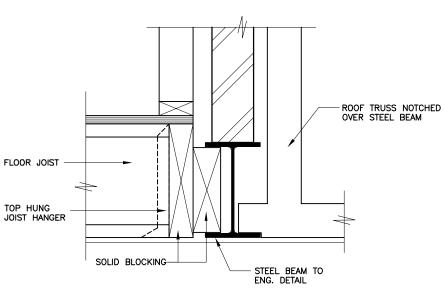

TYPICAL DETAIL
GENERIC STEEL BEAM SHOWN FOR
ILLUSTRATION PURPOSES ONLY.
REFER TO ENGINEERS DETAILS

DETAIL 'D' (CDN 27.010)

19/02/2020 12:34:51 PM, CONSTRUCTION DRAWINGS

ClarendonHomes

BL No. 2298C ABN 18 003 892 706

CLIENT'S SIGNATURE:


Clarendon Homes (NSW) P/L 21 Solent Circuit, Baulkham Hills NSW 2153 T: (02) 8851 5300 © ALL RIGHTS RESERVED
This plan is the property of
CLARENDON HOMES (NSW) P/L
Any copying or altering
of the drawing shall not be
undertaken without written
permission from
CLARENDON HOMES (NSW) P/L
ALL DIMENSIONS TO STRUCTURAL
ELEMENTS. DIMENSIONS TO STRUCTURAL
IN PREFERENCE TO SCALING.

DATE:

PRODUCT:
PARKHILL 32
Facade
R/H Garage

Evolution Specification

CLIENT: FINAL CONSTRUCTION PLAN Mr. SOMMER Mrs. SOMMER DRAWN: DATE: PG. 28.02.19 SITE ADDRESS: Ν RATIO @ A3: CHECKED: Lot 17 1:10 J.S No.1 Bubalo Street SHEET: JOB No: 29913455 XXX WARRIEWOOD 2102

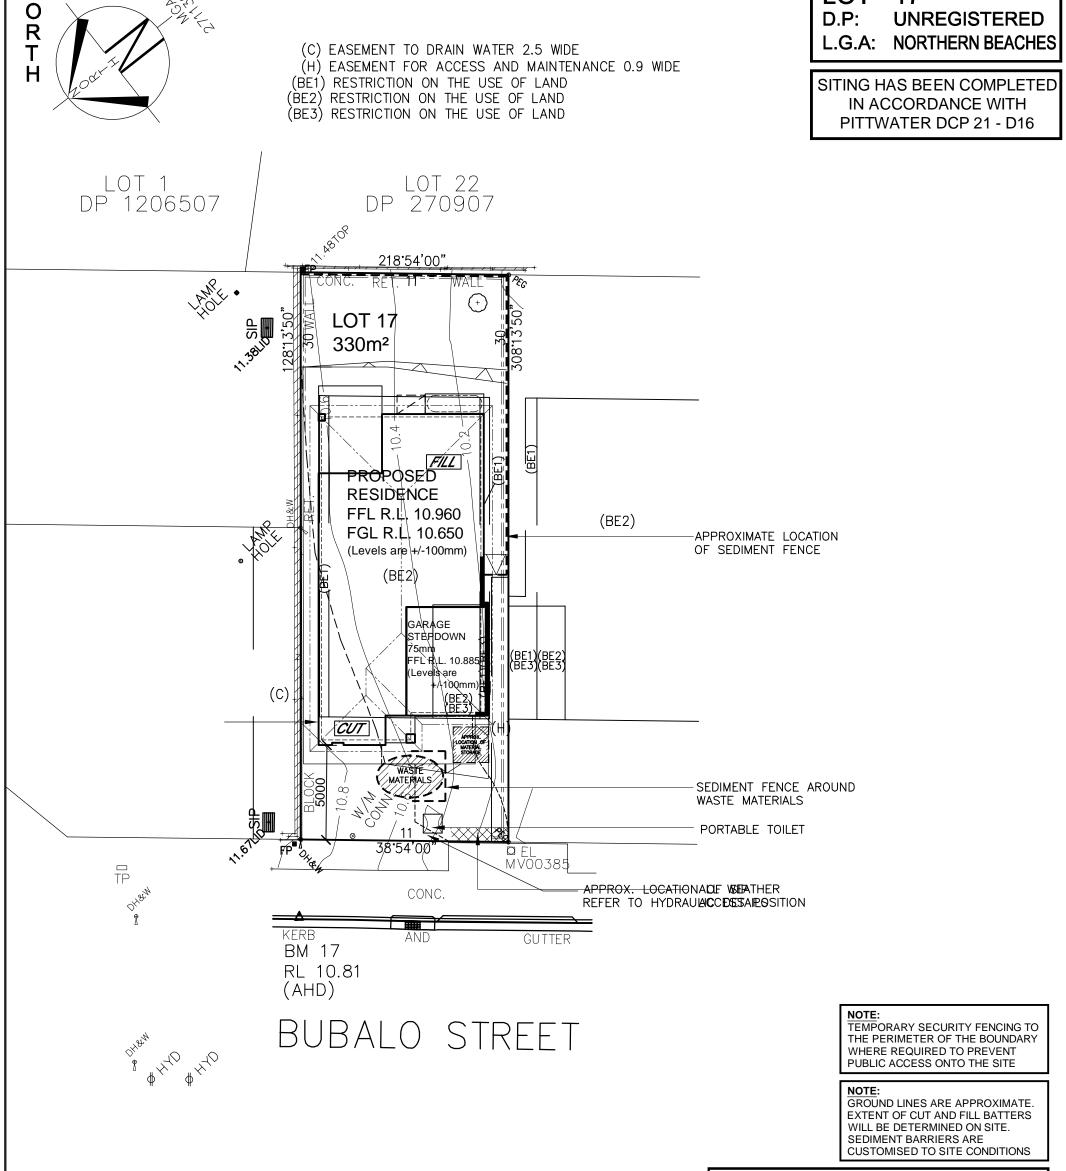

CONSTRUCTION MANAGEMENT PLAN **EROSION AND SEDIMENT CONTROL PLAN**

SEDIMENT CONTROL NOTES (SUITALE FRAGE PAGE)

SEDIMENT FENCE

i. ALL DISTURBED AREAS SHALL BE REVEGITATED AS SOON AS THE RELEVANT SOIL AND TOPSOIL STOCKPILES SHALL BE LOCATED AWAY FROM DR CONCENTRATE. ALL ROADS AND FOOTPATHS TO BE SWEPT DAILY.

LOT

17

7. FILTER SHALL BE CONSTRUCTED BY STRETCHING A FILTER FABRIC (PROPEX OR POST AT 3.0m CENTRES. FABRIC SHALL BE BURIED 150mm ALONG ITS LOWER EL . DUST PREVENTION MEASURES TO BE MAINTAINED AT ALL TIMES.

19/02/2020 12:34:52 PM, CONSTRUCTION DRAWINGS

Clarendon Homes

CLIENT'S SIGNATURE:

Ν


Clarendon Homes (NSW) P/L 21 Solent Circuit, Baulkham Hills NSW 2153 T: (02) 8851 5300

© ALL RIGHTS RESERVED This plan is the property of CLARENDON HOMES (NSW) P/L Any copying or altering of the drawing shall not be undertaken without written nermission from CLARENDON HOMES (NSW) P/L ALL DIMENSIONS TO STRUCTURAL ELEMENTS. DIMENSIONS TO BE REA IN PREFERENCE TO SCALING.

PRODUCT: PARKHILL 32 Prominent R/H Garage

Evolution Specification

CLIENT: FINAL CONSTRUCTION PLAN Mr. SOMMER Mrs. SOMMER DRAWN: DATE: 28.02.19 PG. SITE ADDRESS: Ν RATIO @ A3: CHECKED: Lot 17 1:200 J.S No.1 Bubalo Street SHEET: JOB No: 29913455 NSW WARRIEWOOD 2102

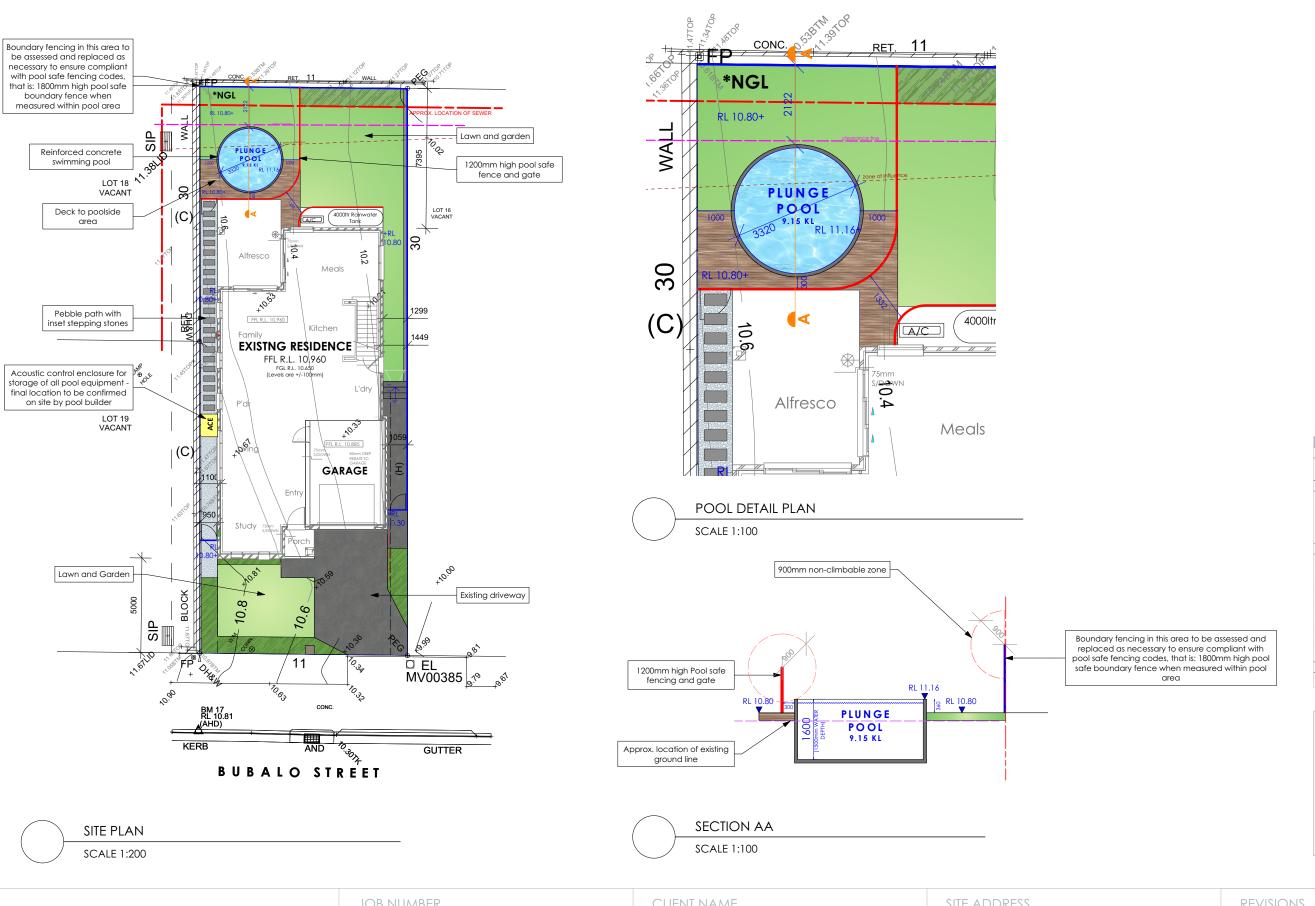

LEGEND

| | Coloured Concrete | | | |
|------|-------------------------------|--|--|--|
| | Decking | | | |
| | Pebble Mulch | | | |
| | Lawn | | | |
| | Gardens | | | |
| | 1800mm High Boundary Fencing | | | |
| | 1200mm High Pool Safe Fencing | | | |
| *NGL | Natural Ground Level | | | |

NOTE: The swimming pool fence will be provided in accordance with A\$1926.1-2012 and AS1926.2-2007 and the Swimming Pools Act 1992

| SITE CALCULATIONS m2 OT AREA 330 sq m | | |
|---------------------------------------|------------|-------|
| SITE COVERAGE | 000 34111 | |
| HOUSE FOOTPRINT | 153.6 sq m | |
| TOTAL | 153.6 sq m | 46.55 |
| HARDSCAPE AREAS | | |
| DRIVEWAY AREA | 30.7 sq m | |
| CROSSOVER | 0 sq m | |
| CONCRETE PATHS | 27.1 sq m | |
| DECKING | 15.6 sq m | |
| TOTAL (exc. crossover) | 73.4 sq m | 22.25 |
| FRONT LANDSCAPED AREA | | |
| LAWN AREAS | 25.9 sq m | |
| GARDEN AREAS | 13.3 sq m | |
| PEBBLE/GRAVEL AREAS | 0 sq m | |
| MULCH AREAS | 0 sq m | |
| REAR LANDSCAPED AREA | | |
| LAWN AREAS | 58.3 sq m | |
| GARDEN AREAS | 5.7 sq m | |
| PEBBLE/GRAVEL AREAS | 0 sq m | |
| MULCH AREAS | 18.2 sq m | |
| | 121.4 sq m | 36.77 |

General Notes:

- See Architects drawings for site levels, setbacks and extent of cut and fill.
 All civil, structural and hydraulic work
- associated with this project shall be to consulting engineer's details.
- Exact location of site boundaries are to be confirmed on site prior to commencement of
- 4. This plan is conceptual only and not for construction purposes.
 5. Any existing trees are to be protected in accordance with Councils Tree Preservation



| JOB NUMBER | | CLIENT NAME | SITE ADDRESS |
|--------------------------------|---------------|------------------|--|
| 1903 | | Mr & Mrs Sommer | 1 Bubalo Street Warriewood NSW 2102 |
| DRAWING POOL DESIGN/ SITE PLAN | SHEET 1 of 1 | CLIENT SIGNATURE | SCALE 1:100/1:200 @ A3 |

| revisions | | | | | |
|-----------|-----------------|----------|--|--|--|
| issue | description | date | | | |
| Α | SUBMISSION PLAN | 05.05.20 | | | |
| | | | | | |
| | | | | | |
| | | | | | |
| | | | | | |