BOVILL HOUSE 13 VIRGINIA PLACE, FORESTVILLE NSW 2087 LOT 7 DP 30924

ISSUED FOR DEVELOPMENT APPLICATION

Drawing Index					
Drawing ID	Drawing Name	Published			
A.01	COVER PAGE	\boxtimes			
A.02	SURVEY	\boxtimes			
A.03	EXISTING PLAN 1:200	\boxtimes			
A.04	EXISTING ELEVATIONS	\boxtimes			
A.05	EXISTING PHOTOGRAPHS	\boxtimes			
A.06	DEMOLITION & WASTE MGMT	\boxtimes			
A.07	PROPOSED PLAN 1:200	\boxtimes			
A.08	PROPOSED FLOORPLAN 1:100	\boxtimes			
A.09	PROPOSED ELEVATIONS	\boxtimes			
A.10	PROPOSED ROOF PLAN 1:100	\boxtimes			
A.11	SHADOW DIAGRAMS	\boxtimes			
A.12	BASIX REQUIREMENTS	\boxtimes			
A.13	NOTIFICATION PLANS				



PROJECT

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ARCHITECT
LANCE WORKSHOP
80 FINDLAY AVENUE
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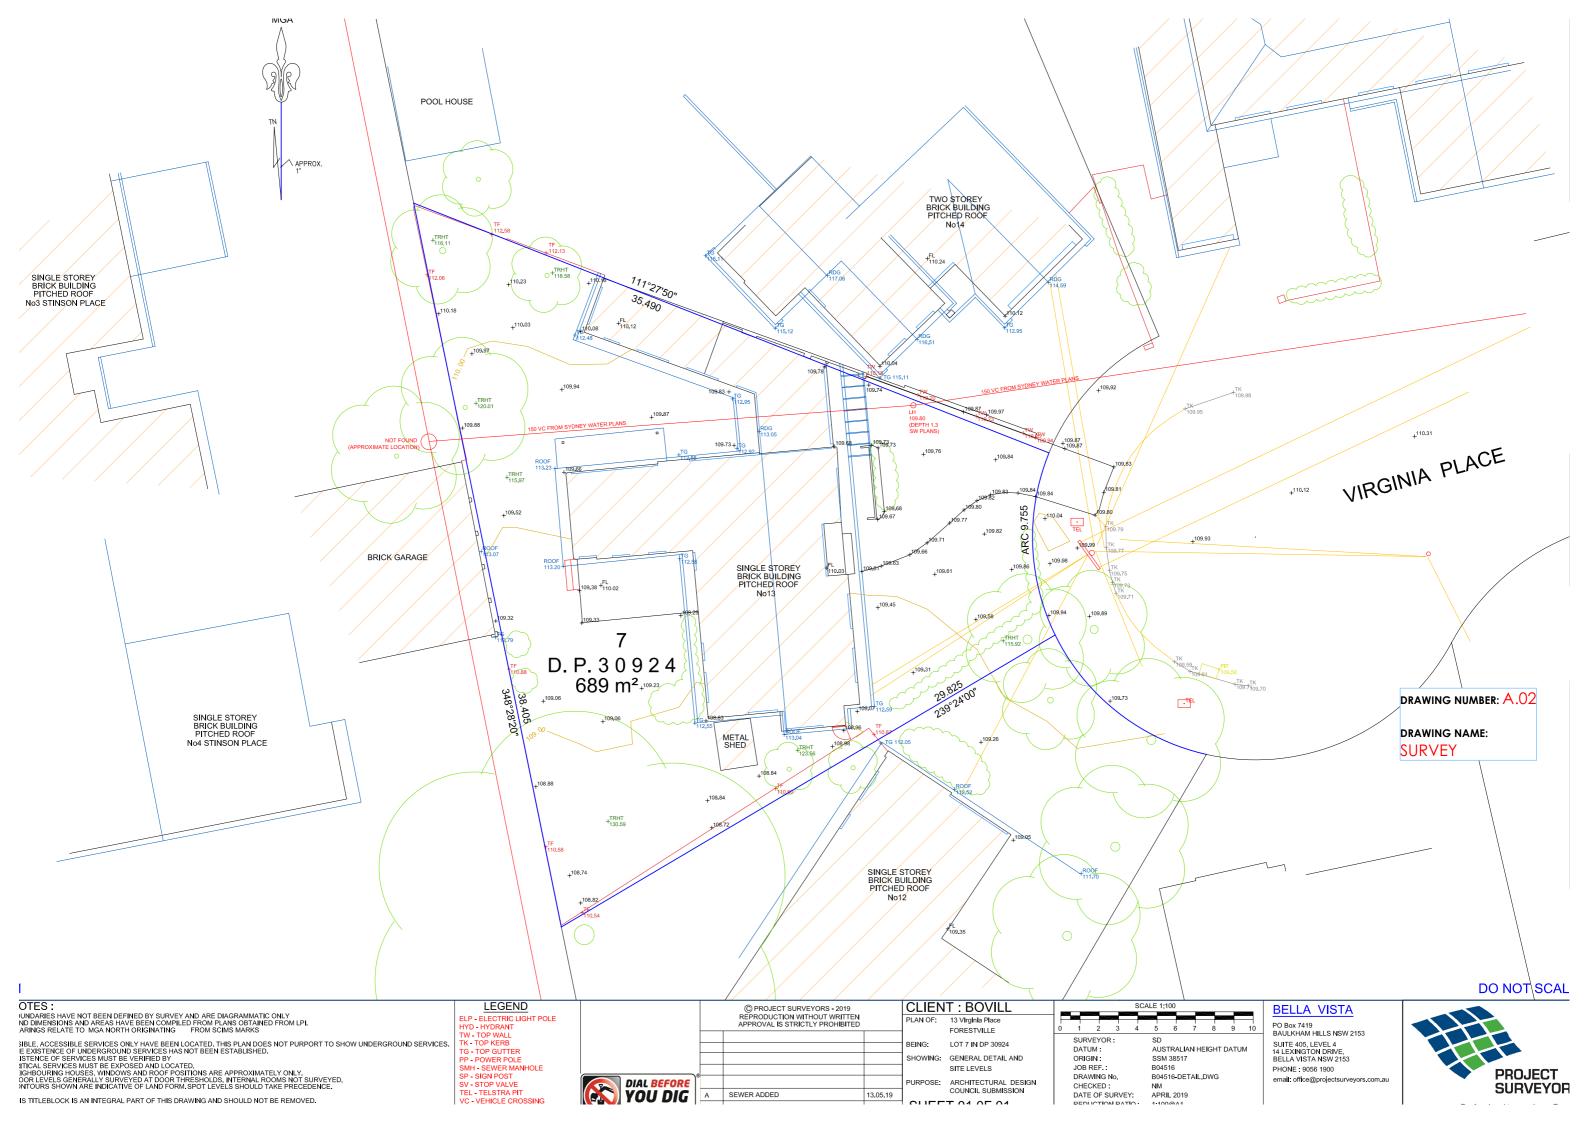
DRAWING NUMBER: A.01

DRAWING NAME: **COVER PAGE**

SCALE

DATE 7/01/2020







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DRAWING NUMBER: A.03

DRAWING NAME: **EXISTING PLAN 1:200**

SCALE 1:200 @ A3

DATE 7/01/2020








STORE ROOM

1:100

West Elevation - Existing

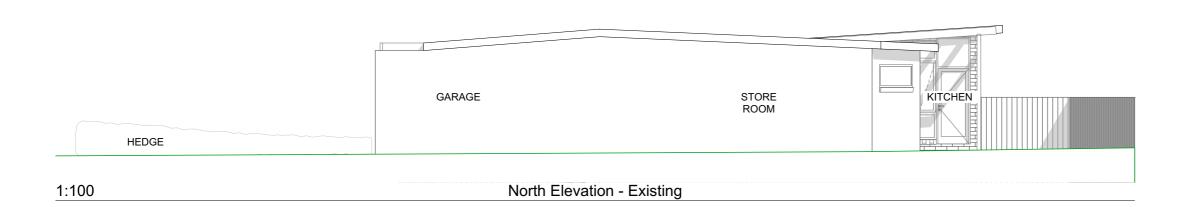



NOTE BOUNDARY FENCES NOT SHOWN WHERE THEY WOULD OBSTRUCT THE ELEVATION VIEW.

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DRAWING NUMBER: A.04

DRAWING NAME:
EXISTING ELEVATIONS

SCALE 1:100 @ A3

DATE 7/01/2020





Rear deck viewed from the south



Kitchen viewed from the north

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DRAWING NUMBER: A.05

DRAWING NAME: **EXISTING PHOTOGRAPHS**

SCALE

DATE 7/01/2020







PROPOSED FLOOR PLAN 1:200


LANDSCAPED OPEN SPACE


 $94.0\text{m}^2 + 135.6\text{m}^2 + 85.5\text{m}^2 = 315.1 \text{ m}^2$ Site area = $689\text{m}^2 \times 40\% = 275.6\text{m}^2$ Landscaped open space exceed by 39.5m²

Therefore the minimum Landscaped Open Space area is 45.7%

PRIVATE OPEN SPACE

Rear deck area = 77.12m²

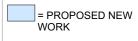

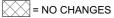

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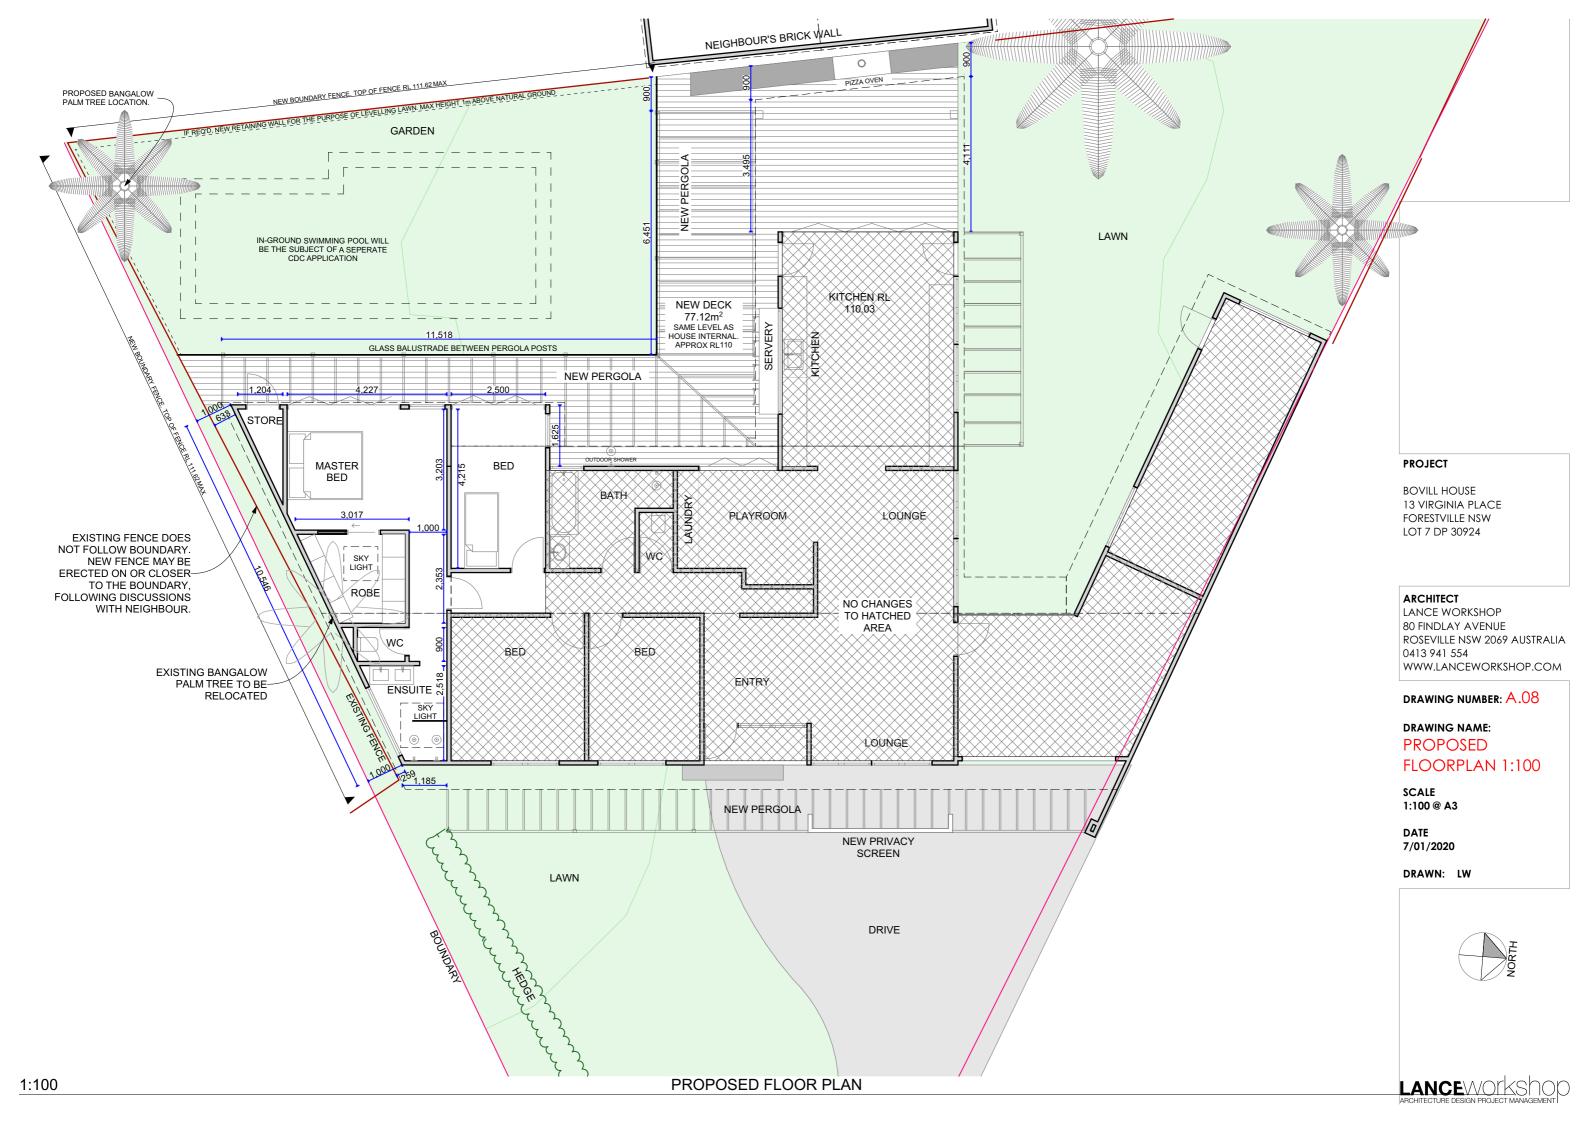
DRAWING NAME: PROPOSED PLAN 1:200


SCALE 1:200 @ A3

DATE 7/01/2020









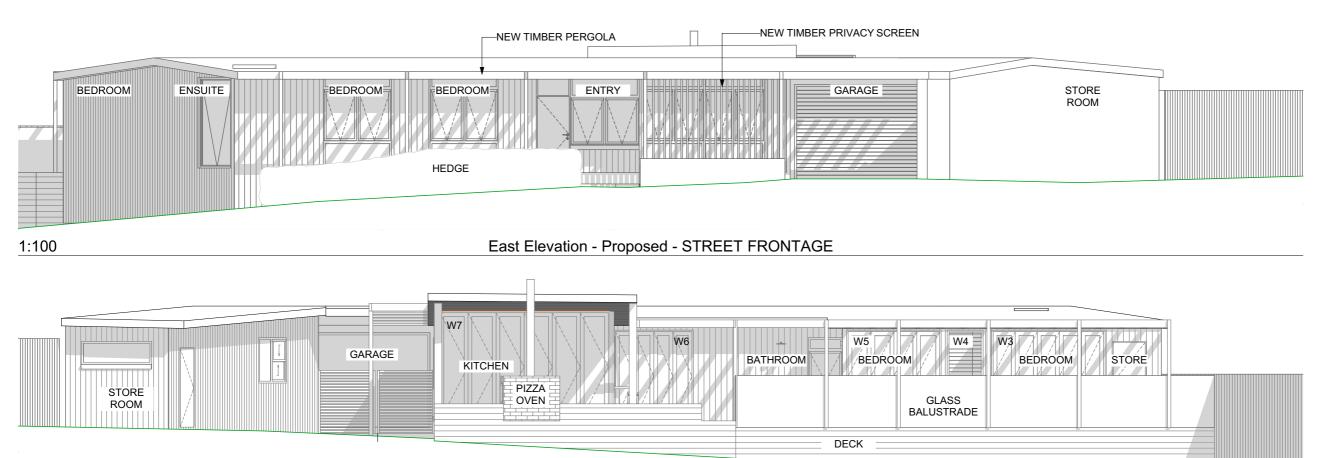

West Elevation - Proposed

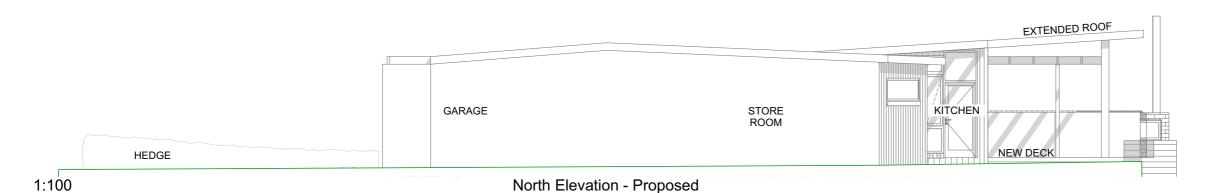

1:100

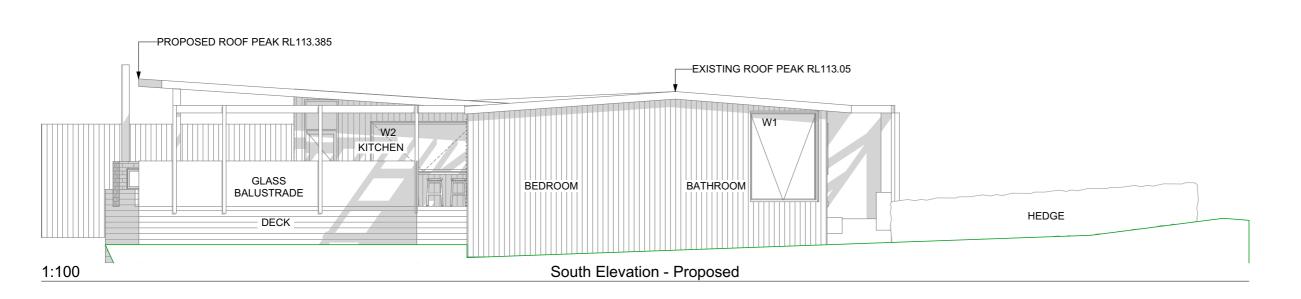

EXTERIOR FINISHES

- Existing exterior pale brick walls to be clad in weatherboard-style sheet cladding.
- New areas of roof are to match existing
- Exterior paint will be ***** colour
- New pergola will be painted timber in **** colour
- New decks will be natural hardwood
- Existing garage & store room are to remain unchanged

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DRAWING NUMBER: A.09


DRAWING NAME:
PROPOSED
ELEVATIONS


SCALE 1:100 @ A3

DATE 7/01/2020






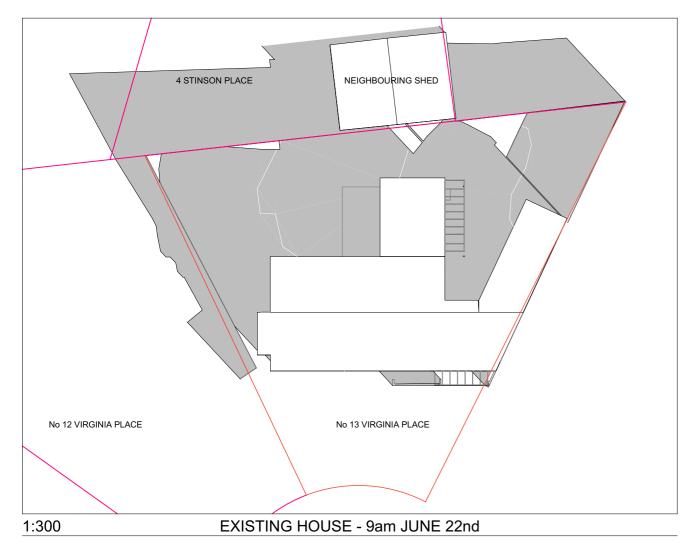

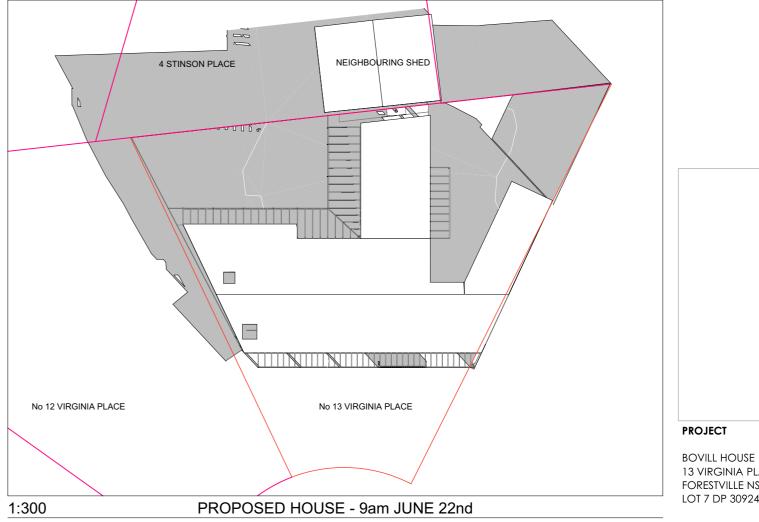

13 VIRGINIA PLACE FORESTVILLE NSW LOT 7 DP 30924

4 STINSON PLACE NEIGHBOURING SHED No 12 VIRGINIA PLACE No 13 VIRGINIA PLACE 11:0100 EXISTING HOUSE - 3pm JUNE 22nd 1:300

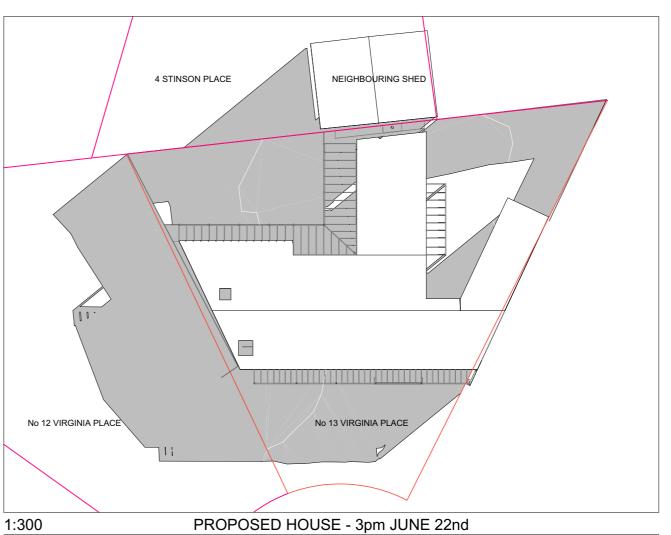

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DRAWING NUMBER: A.11

DRAWING NAME: SHADOW DIAGRAMS

SCALE 1:300 @ A3

DATE 7/01/2020





BASIX CERTIFICATE NUMBER A367125

Project address					
Project name	Bovill house				
Street address	13 Virginia Place Forestville 2067				
Local Government Area	Northern Beaches Council				
Plan type and number	Deposited Plan 30924				
Lot number	7				
Section number					

Project type					
Dwelling type	Separate dwelling house				
Type of alteration and addition	My renovation work is valued at \$50,000 or more, and does not include a pool (and/or spa).				

Fixtures and systems

Lighting

The applicant must ensure a minimum of 40% of new or altered light fixtures are fitted with fluorescent, compact fluorescent, or light-emitting-diode (LED) lamps.

Fixtures

The applicant must ensure new or altered showerheads have a flow rate no greater than 9 litres per minute or a 3 star water rating.

The applicant must ensure new or altered toilets have a flow rate no greater than 4 litres per average flush or a minimum 3 star water rating.

The applicant must ensure new or altered taps have a flow rate no greater than 9 litres per minute or minimum 3 star water rating.

Construction	Additional insulation required (R-value)	Other specifications
suspended floor with enclosed subfloor: framed (R0.7).	R0.60 (down) (or R1.30 including construction)	
external wall: framed (weatherboard, fibro, metal clad)	R1.30 (or R1.70 including construction)	
raked ceiling, pitched/skillion roof: framed	ceiling: R2.24 (up), roof: foil backed blanket (55 mm)	medium (solar absorptance 0.475 - 0.70)

Windows and glazed doors glazing requirements						
inc. fram			dowing	ng Shading device	Frame and glass type	
	glass inc. frame (m2)	Height (m)	Distance (m)			
W1	S	4.65	1.8	0.9	none	improved aluminium, single clear, (U-value: 6.44, SHGC: 0.75)
W2	S	3.7	0	0	eave/verandah/pergola/balcony >=600 mm	improved aluminium, single clear, (U-value: 6.44, SHGC: 0.75)
W3	W	4.68	0	0	eave/verandah/pergola/balcony >=900 mm	improved aluminium, single clear, (U-value: 6.44, SHGC: 0.75)
W4	W	1.95	0	0	eave/verandah/pergola/balcony	improved aluminium, single clear, (U-value:

Glazing requirements						
Window / door	Window / door Orientation Area of	Area of	Overshadowing		Shading device	Frame and glass type
no.		glass inc. frame (m2)	Height (m)	Distance (m)		
					>=900 mm	6.44, SHGC: 0.75)
W5	W	3.9	0	0	eave/verandah/pergola/balcony >=900 mm	improved aluminium, single clear, (U-value: 6.44, SHGC: 0.75)
W6	W	3.1	0	0	eave/verandah/pergola/balcony >=900 mm	improved aluminium, single clear, (U-value: 6.44, SHGC: 0.75)
W7	W	8.9	0	0	eave/verandah/pergola/balcony >=900 mm	improved aluminium, single clear, (U-value: 6.44, SHGC: 0.75)

Skylights glazing requirements

Skylight number	Area of glazing inc. frame (m2)	Shading device	Frame and glass type
S1	0.8	no shading	timber, double clear/air fill, (or U-value: 4.3, SHGC: 0.5)
S2	1.35		timber, low-E internal/argon fill/clear external, (or U-value: 2.5, SHGC: 0.456)

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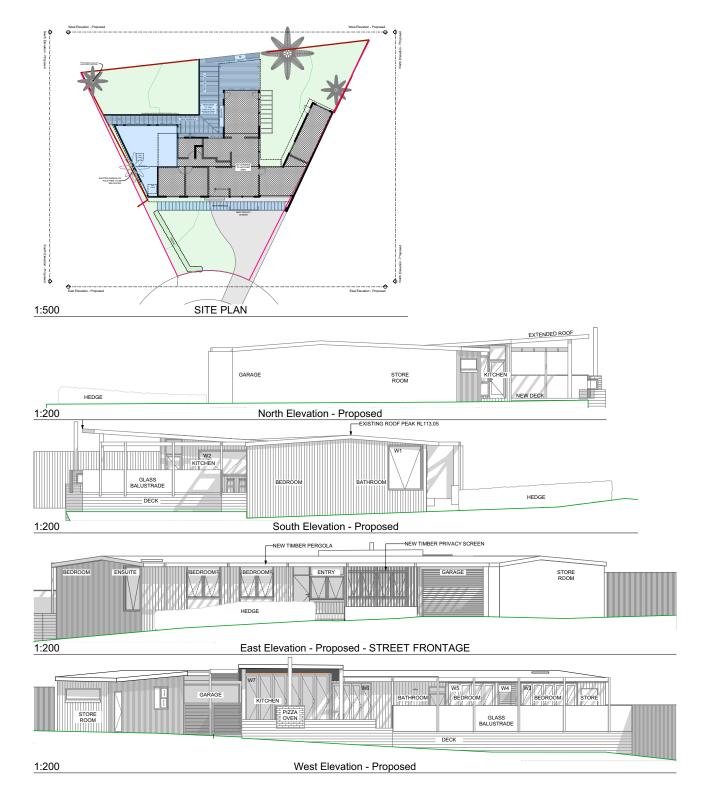
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DRAWING NAME:
BASIX REQUIREMENTS


SCALE

DATE 7/01/2020







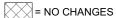

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DRAWING NUMBER: A.13

DRAWING NAME:

NOTIFICATION PLANS

SCALE 1:500, 1:200 @ A4

DATE 7/01/2020



