ITEM DETAILS	DEVELOPMENT APPLICATION				
ADDRESS	14 ERNEST STREET BALGOWLAH HEIGHTS NSW 2093				
LOT & DP	LOT 15A DP31138	11377 2075			
LOCAL GOVERNMENT AREA	NORTHERN BEACHES COUNCIL (MANLY)				
SITE AREA	875.3m <sup>2</sup>				
FRONTAGE	15.24m				
CONTROLS	PERMISSABLE / REQUIRED	EXISTING	PROPOSED	COMPLIANCE	
LEP					
LAND ZONING	R2-LOW DENSITY RESIDENTIAL	R2	R2	YES	
MINIMUM LOT SIZE	500m <sup>2</sup>	875.3m <sup>2</sup>	UNCHANGED	YES	
FLOOR SPACE RATIO	0.45 : 1 (393.9m <sup>2</sup> )	0.16 : 1 (142.4m <sup>2</sup> )		YES	
MAXIMUM BUILDING HEIGHT	8.5m	6.1m		YES	
HAZARDS					
	NOT IDENTIFIED				
DCP					
RESIDENTIAL OPEN SPACE	AREA OS3				
TOTAL OPEN SPACE (TOS)	55% (481.4m <sup>2</sup> )	50.4% (441.5m <sup>2</sup> )		YES	
LANDSCAPE AREA	35% OF TOS (168.5m <sup>2</sup> )	84.1% (405.1m <sup>2</sup> )		YES	
OPEN SPACE ABOVE GROUND	MAX. 40% OF TOS (192.6m <sup>2</sup> )	6.4% (30.9m <sup>2</sup> )		YES	
PRINCIPAL PRIVATE OPEN SPACE	18m <sup>2</sup>	28.9m <sup>2</sup>		YES	
FRONT SETBACK	PREVAILING BUILDING LINE 12.8m	10.6m		YES	
REAR SETBACK	8.0m	28.8m		YES	
SIDE SETBACKS	1/3 WALL HEIGHT (SEE DRAWINGS)			YES	
PARKING SPACES	REQUIRED: 1	1	2	YES	



# **DEVELOPMENT APPLICATION MARTIN RESIDENCE**

	DRG #	DRAWING NAME	REVISION	S
000 F	Preliminaries			
DA	000	COVER PAGE	01	
DA	001	SITE ANALYSIS	01	
DA	002	SITE PLAN	01	
010 C	emolition Pl	ans		
DA	011	DEMOLITION PLAN - LOWER GROUND FLOOR	01	
DA	012	DEMOLITION PLAN - GROUND FLOOR	01	
DA	013	DEMOLITION PLAN - EXISTING ROOF	01	
100 G	GA Plans			
DA	101	FLOOR PLAN - LOWER GROUND FLOOR	01	
DA	102	FLOOR PLAN - GROUND FLOOR	01	
DA	103	FLOOR PLAN - FIRST FLOOR	01	
DA	104	FLOOR PLAN - ROOF	01	
300 E	levations			
DA	301	ELEVATIONS - SHEET 1	01	
DA	302	ELEVATIONS - SHEET 2	01	
350 S	ections			
DA	351	SECTIONS - SHEET 1	01	
DA	352	SECTIONS - SHEET 2	01	
DA	353	SECTIONS - SHEET 3	01	
750 N	liscellaneou	s Drawings		
DA	751	SUN SHADOW DIAGRAMS - SHEET 1	01	1
DA	752	SUN SHADOW DIAGRAMS - SHEET 2	01	
DA	753	SUN SHADOW DIAGRAMS - SHEET 3	01	
DA	754	SUN SHADOW DIAGRAM - NEIGHBOURS	01	
DA	755	FINISHES SAMPLE BOARD	01	
DA	756	BASIX COMMITMENTS	01	
DA	757	3D BUILDING CONTROL VIEWS	01	
DA	758	NOTIFICATION	01	

	K		μ 1 1 1 1 1 1 1 1 1 1
_ 24 THE BOULE LEWISHAM e. kieran@3dh	NSW	2049 m.au	

Status SKETCH DESIGN

14 ERNEST STREET

Drawing Title COVER PAGE

BALGOWLAH HEIGHTS, NSW 209





STREETSCAPE VIEW OF 14 ERNEST STREET FROM THE WEST

GENERAL NOTES:			DRAWING NOTES
Do not scale from this drawing. Use figured			
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PRIOR TO USE FOR BUILDING CONSTRUCTION THE BUILDER MUST ENSURE THEY ARE IN			
POSSESSION OF A CC AND ALL OTHER	01 DEVELOPMENT APPLICATION	03/12/21	
REQUIRED COUNCIL APPROVALS	Rev Change Name	Date	



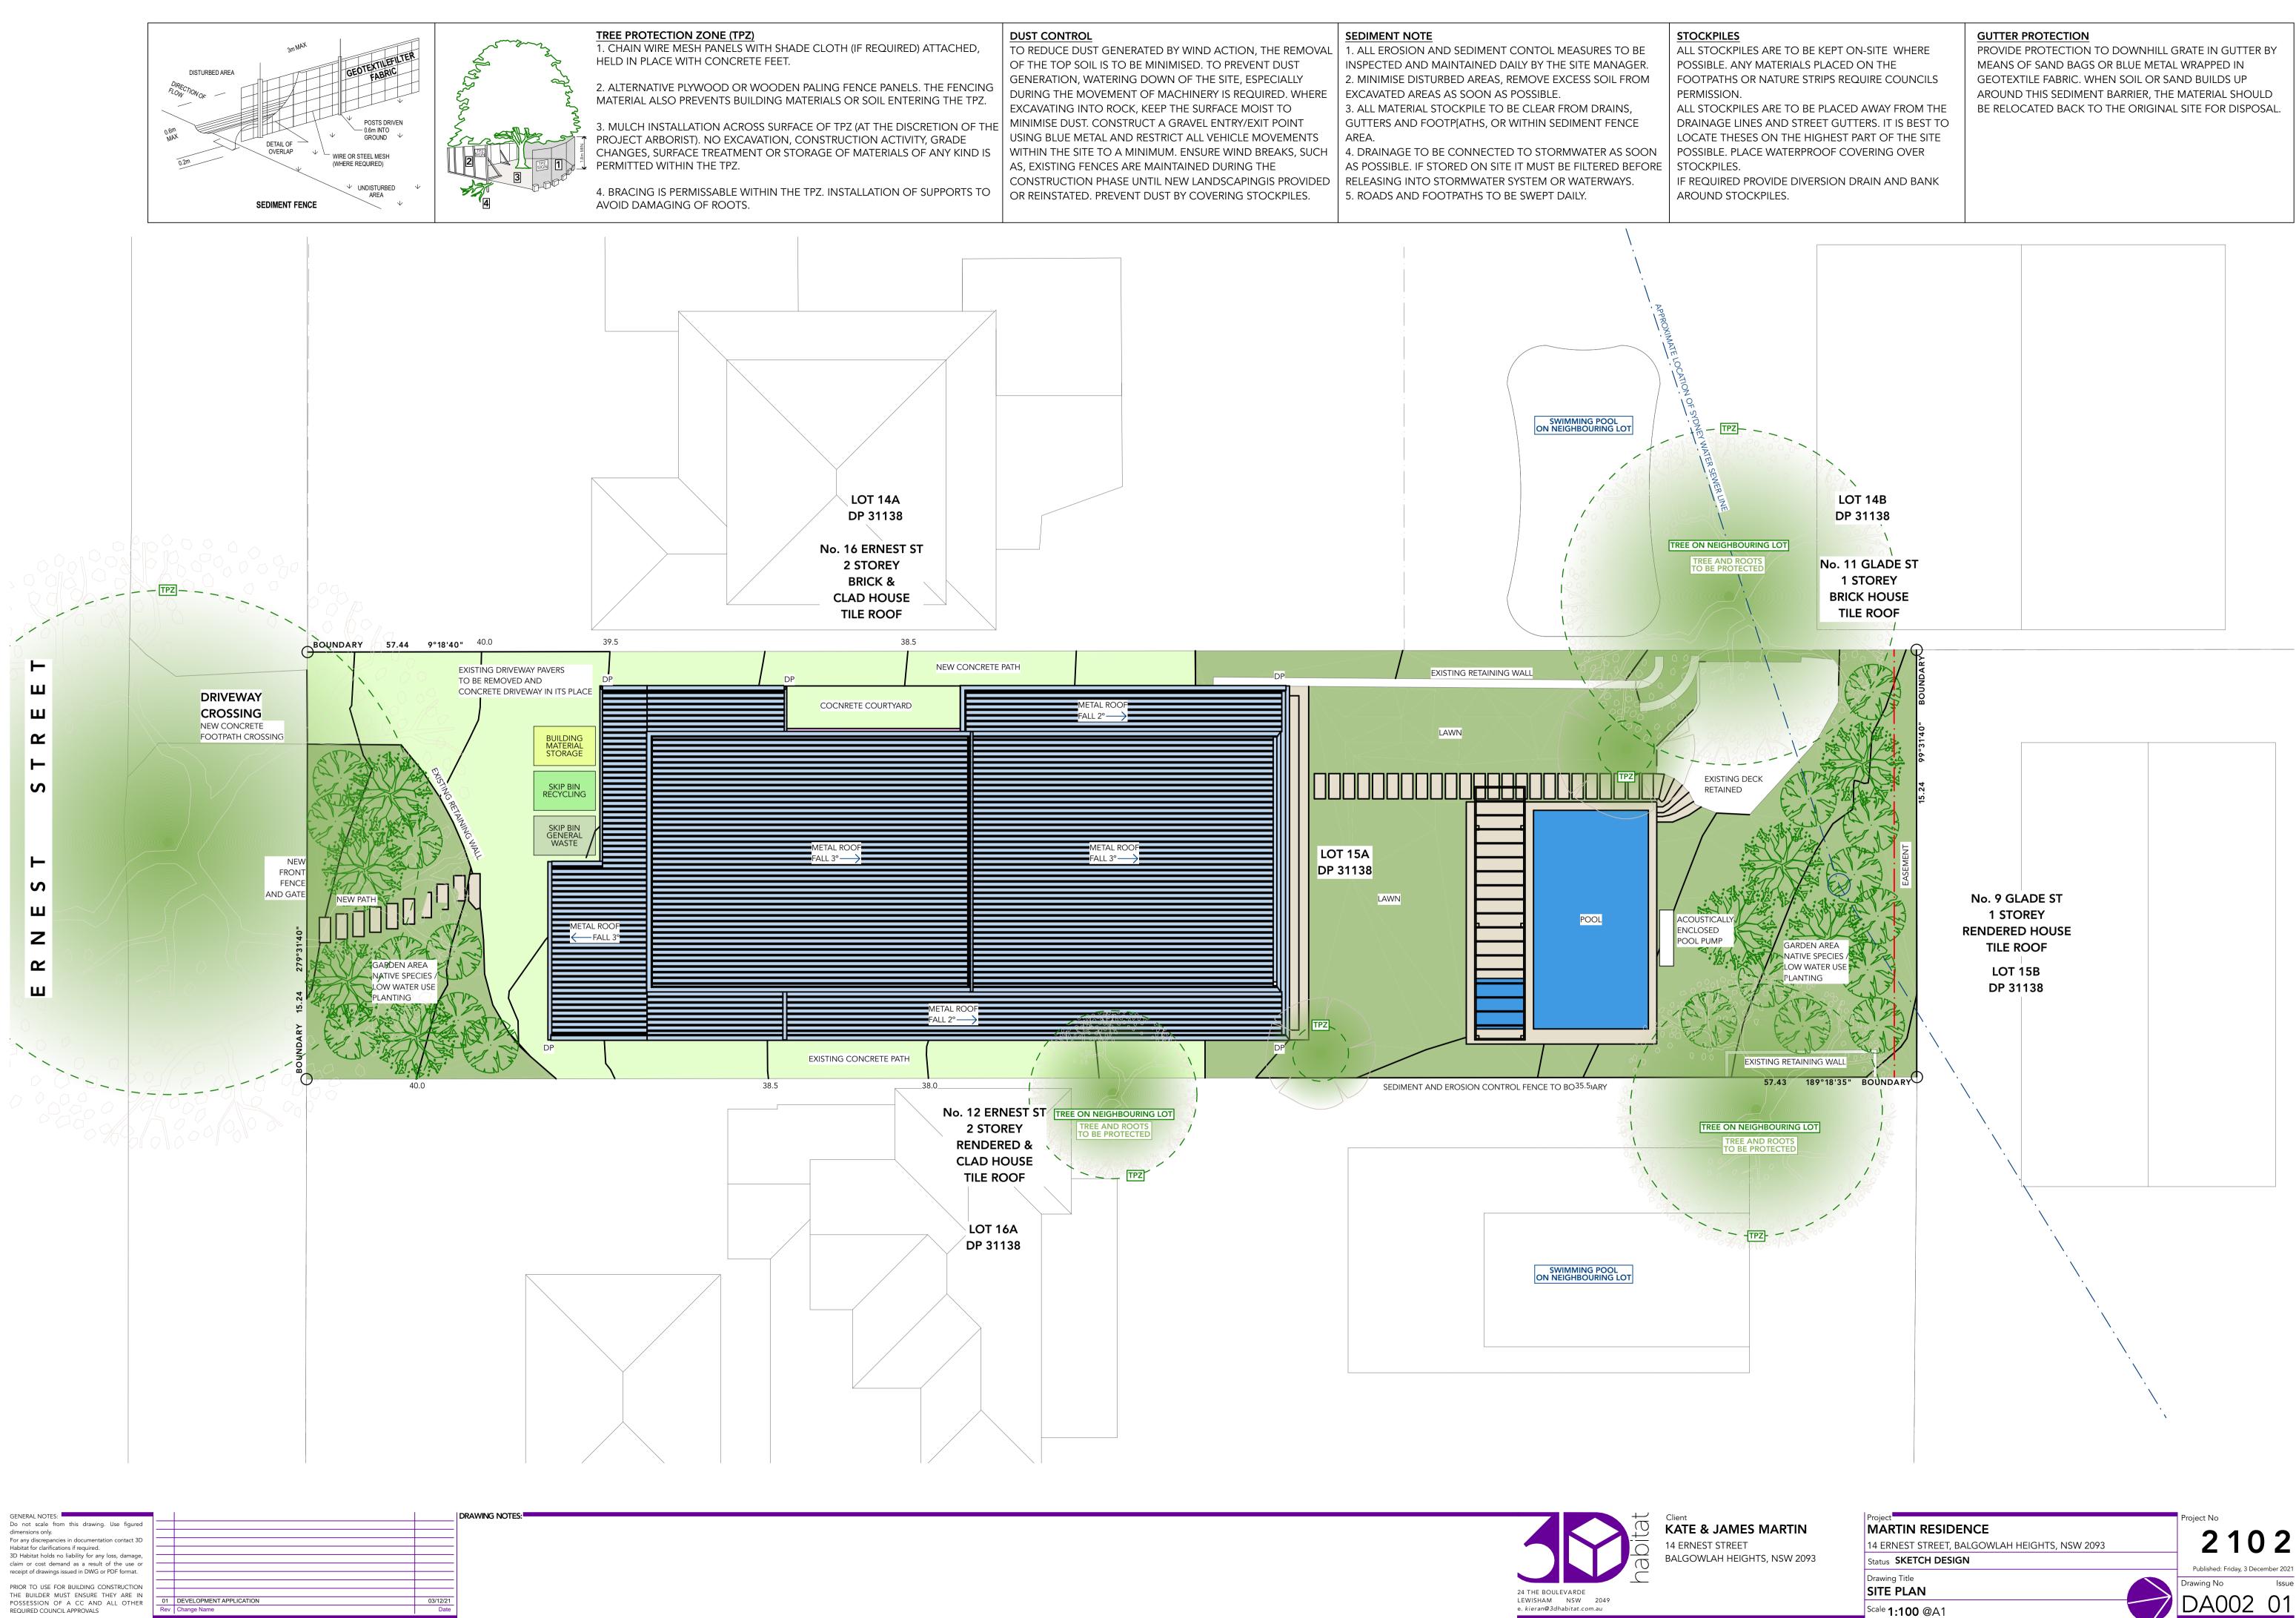
STREETSCAPE VIEW OF 14 ERNEST STREET FROM THE EAST




Client 14 ERNEST STREET BALGOWLAH HEIGHTS, NSW 2093

ct No MARTIN RESIDENCE 14 ERNEST STREET, BALGOWLAH HEIGHTS, NSW 2093 Status SKETCH DESIGN Drawing Title Drawing No SITE ANALYSIS <sup>Scale</sup> @A1






REQUIRED COUNCIL APPROVALS

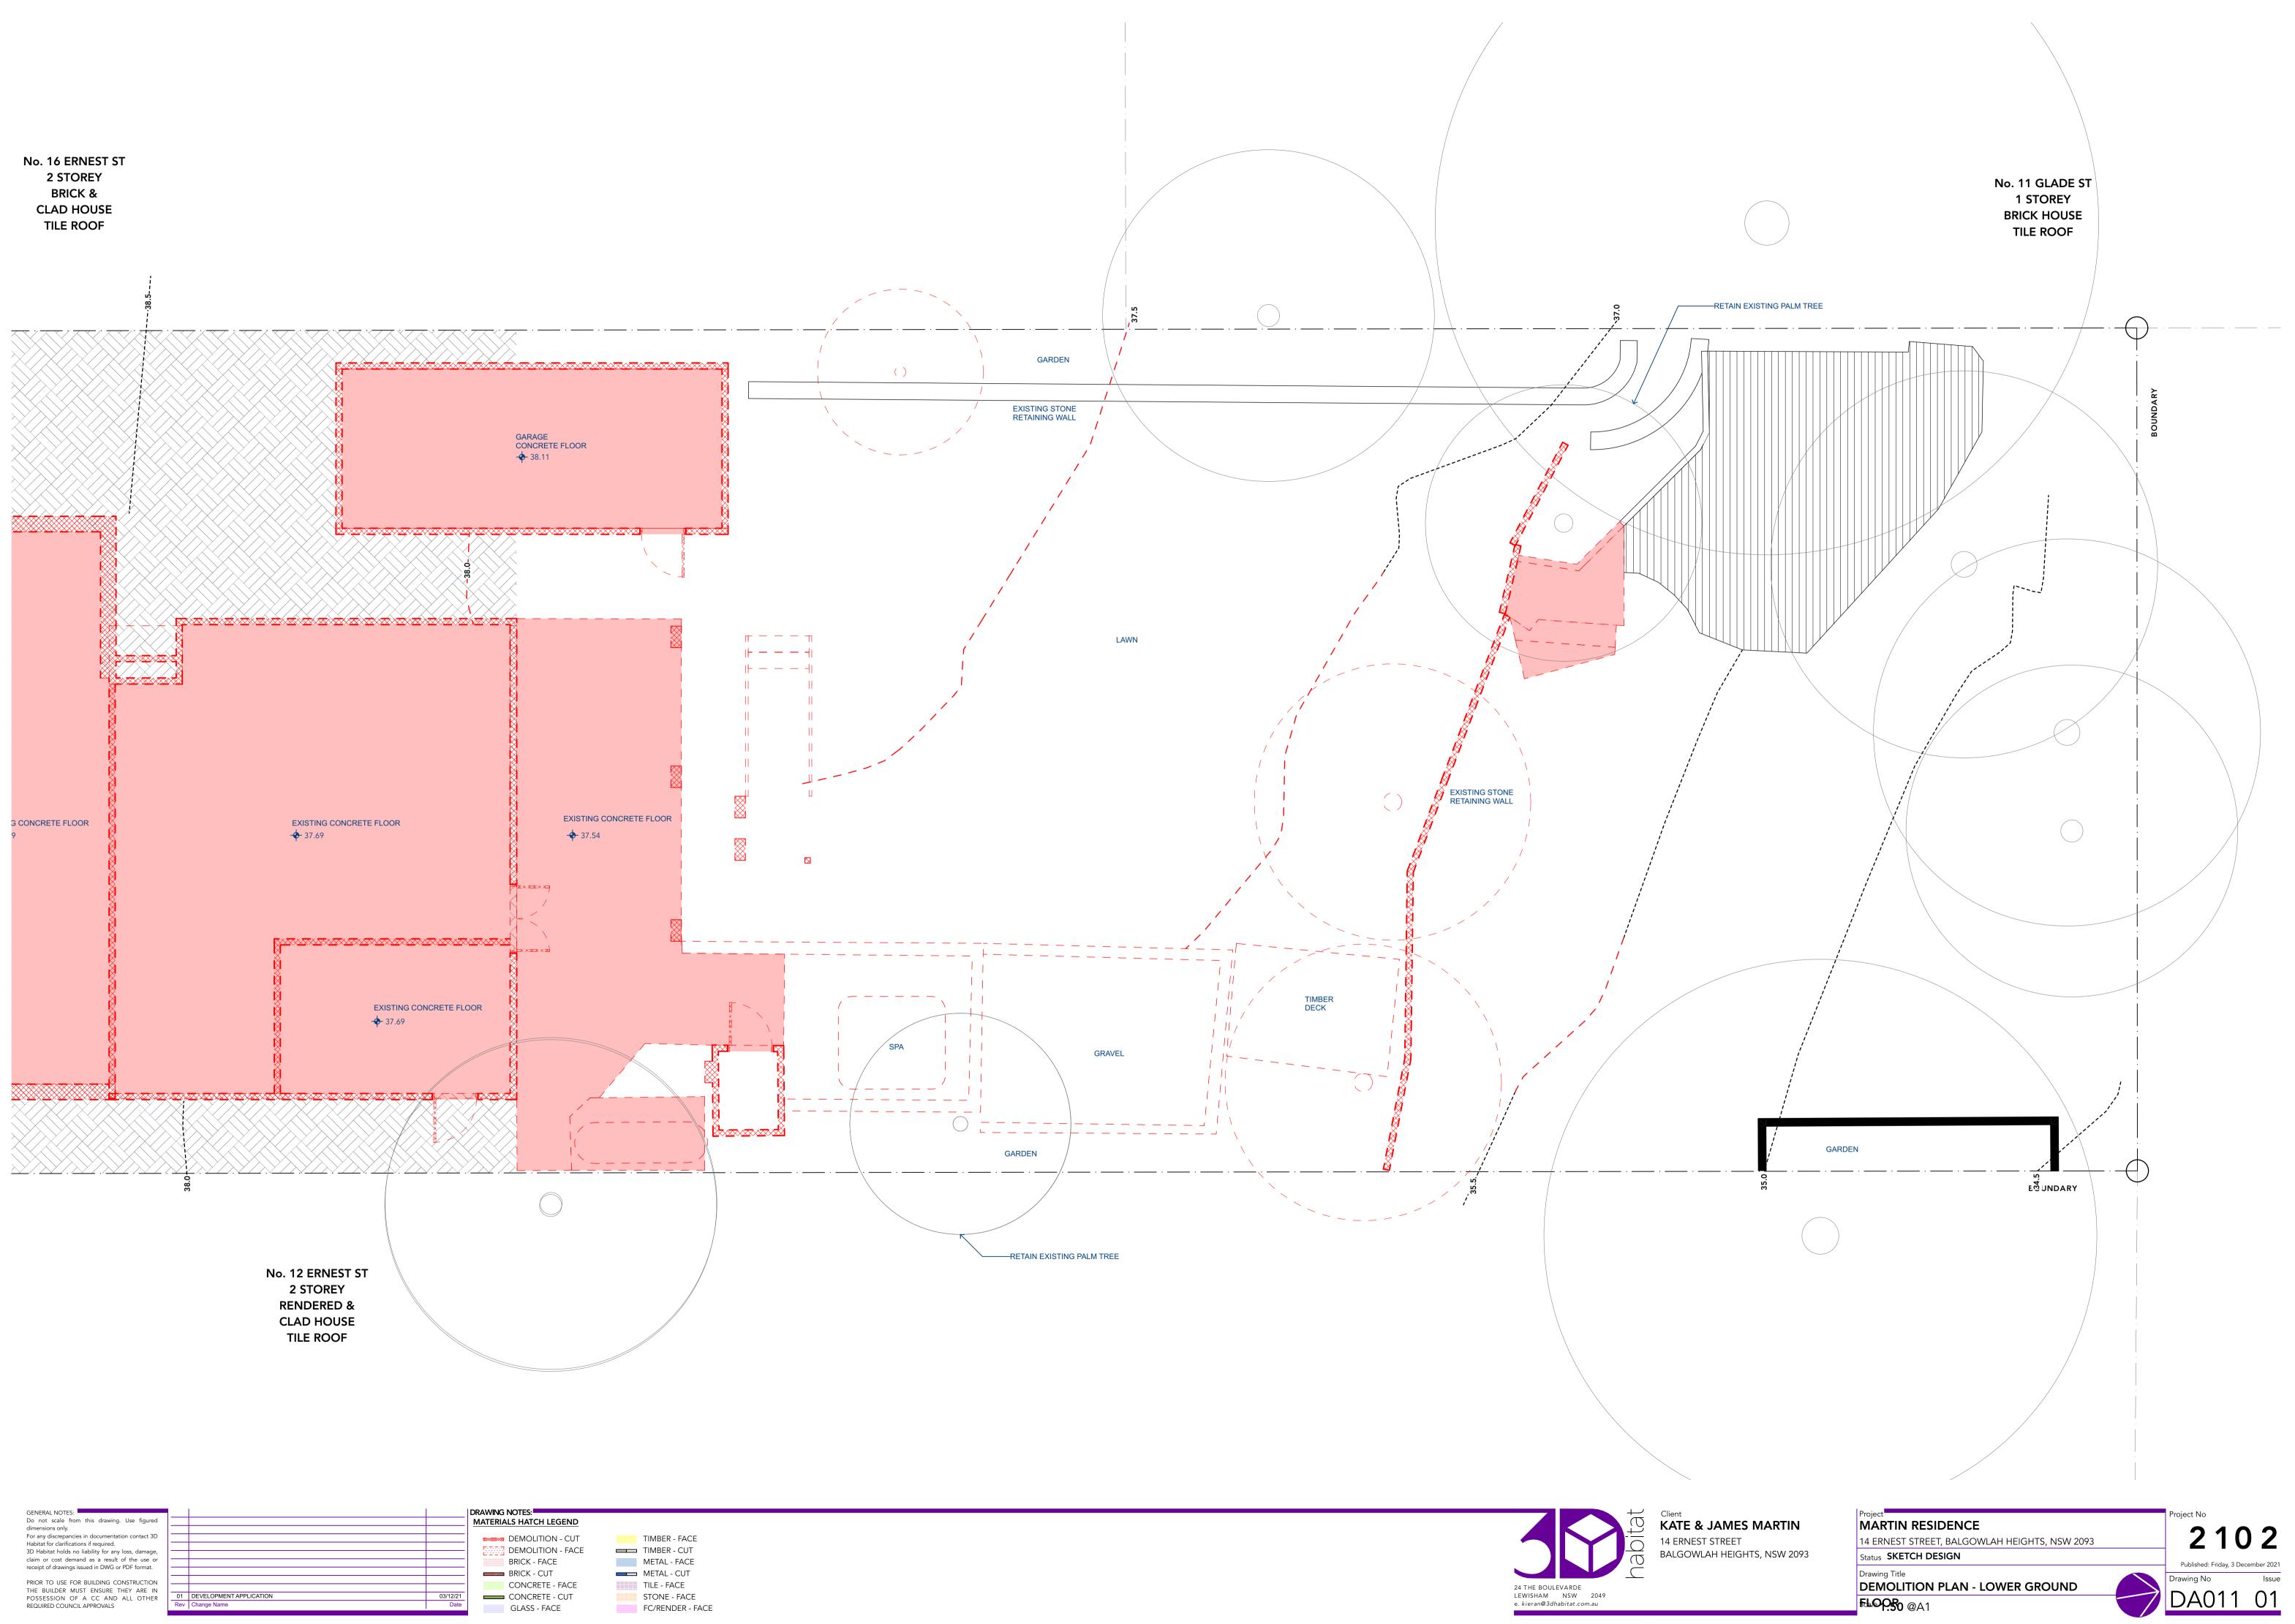



pt of drawings issued in DwG or PDF format.	
R TO USE FOR BUILDING CONSTRUCTION	
BUILDER MUST ENSURE THEY ARE IN	
SESSION OF A CC AND ALL OTHER	




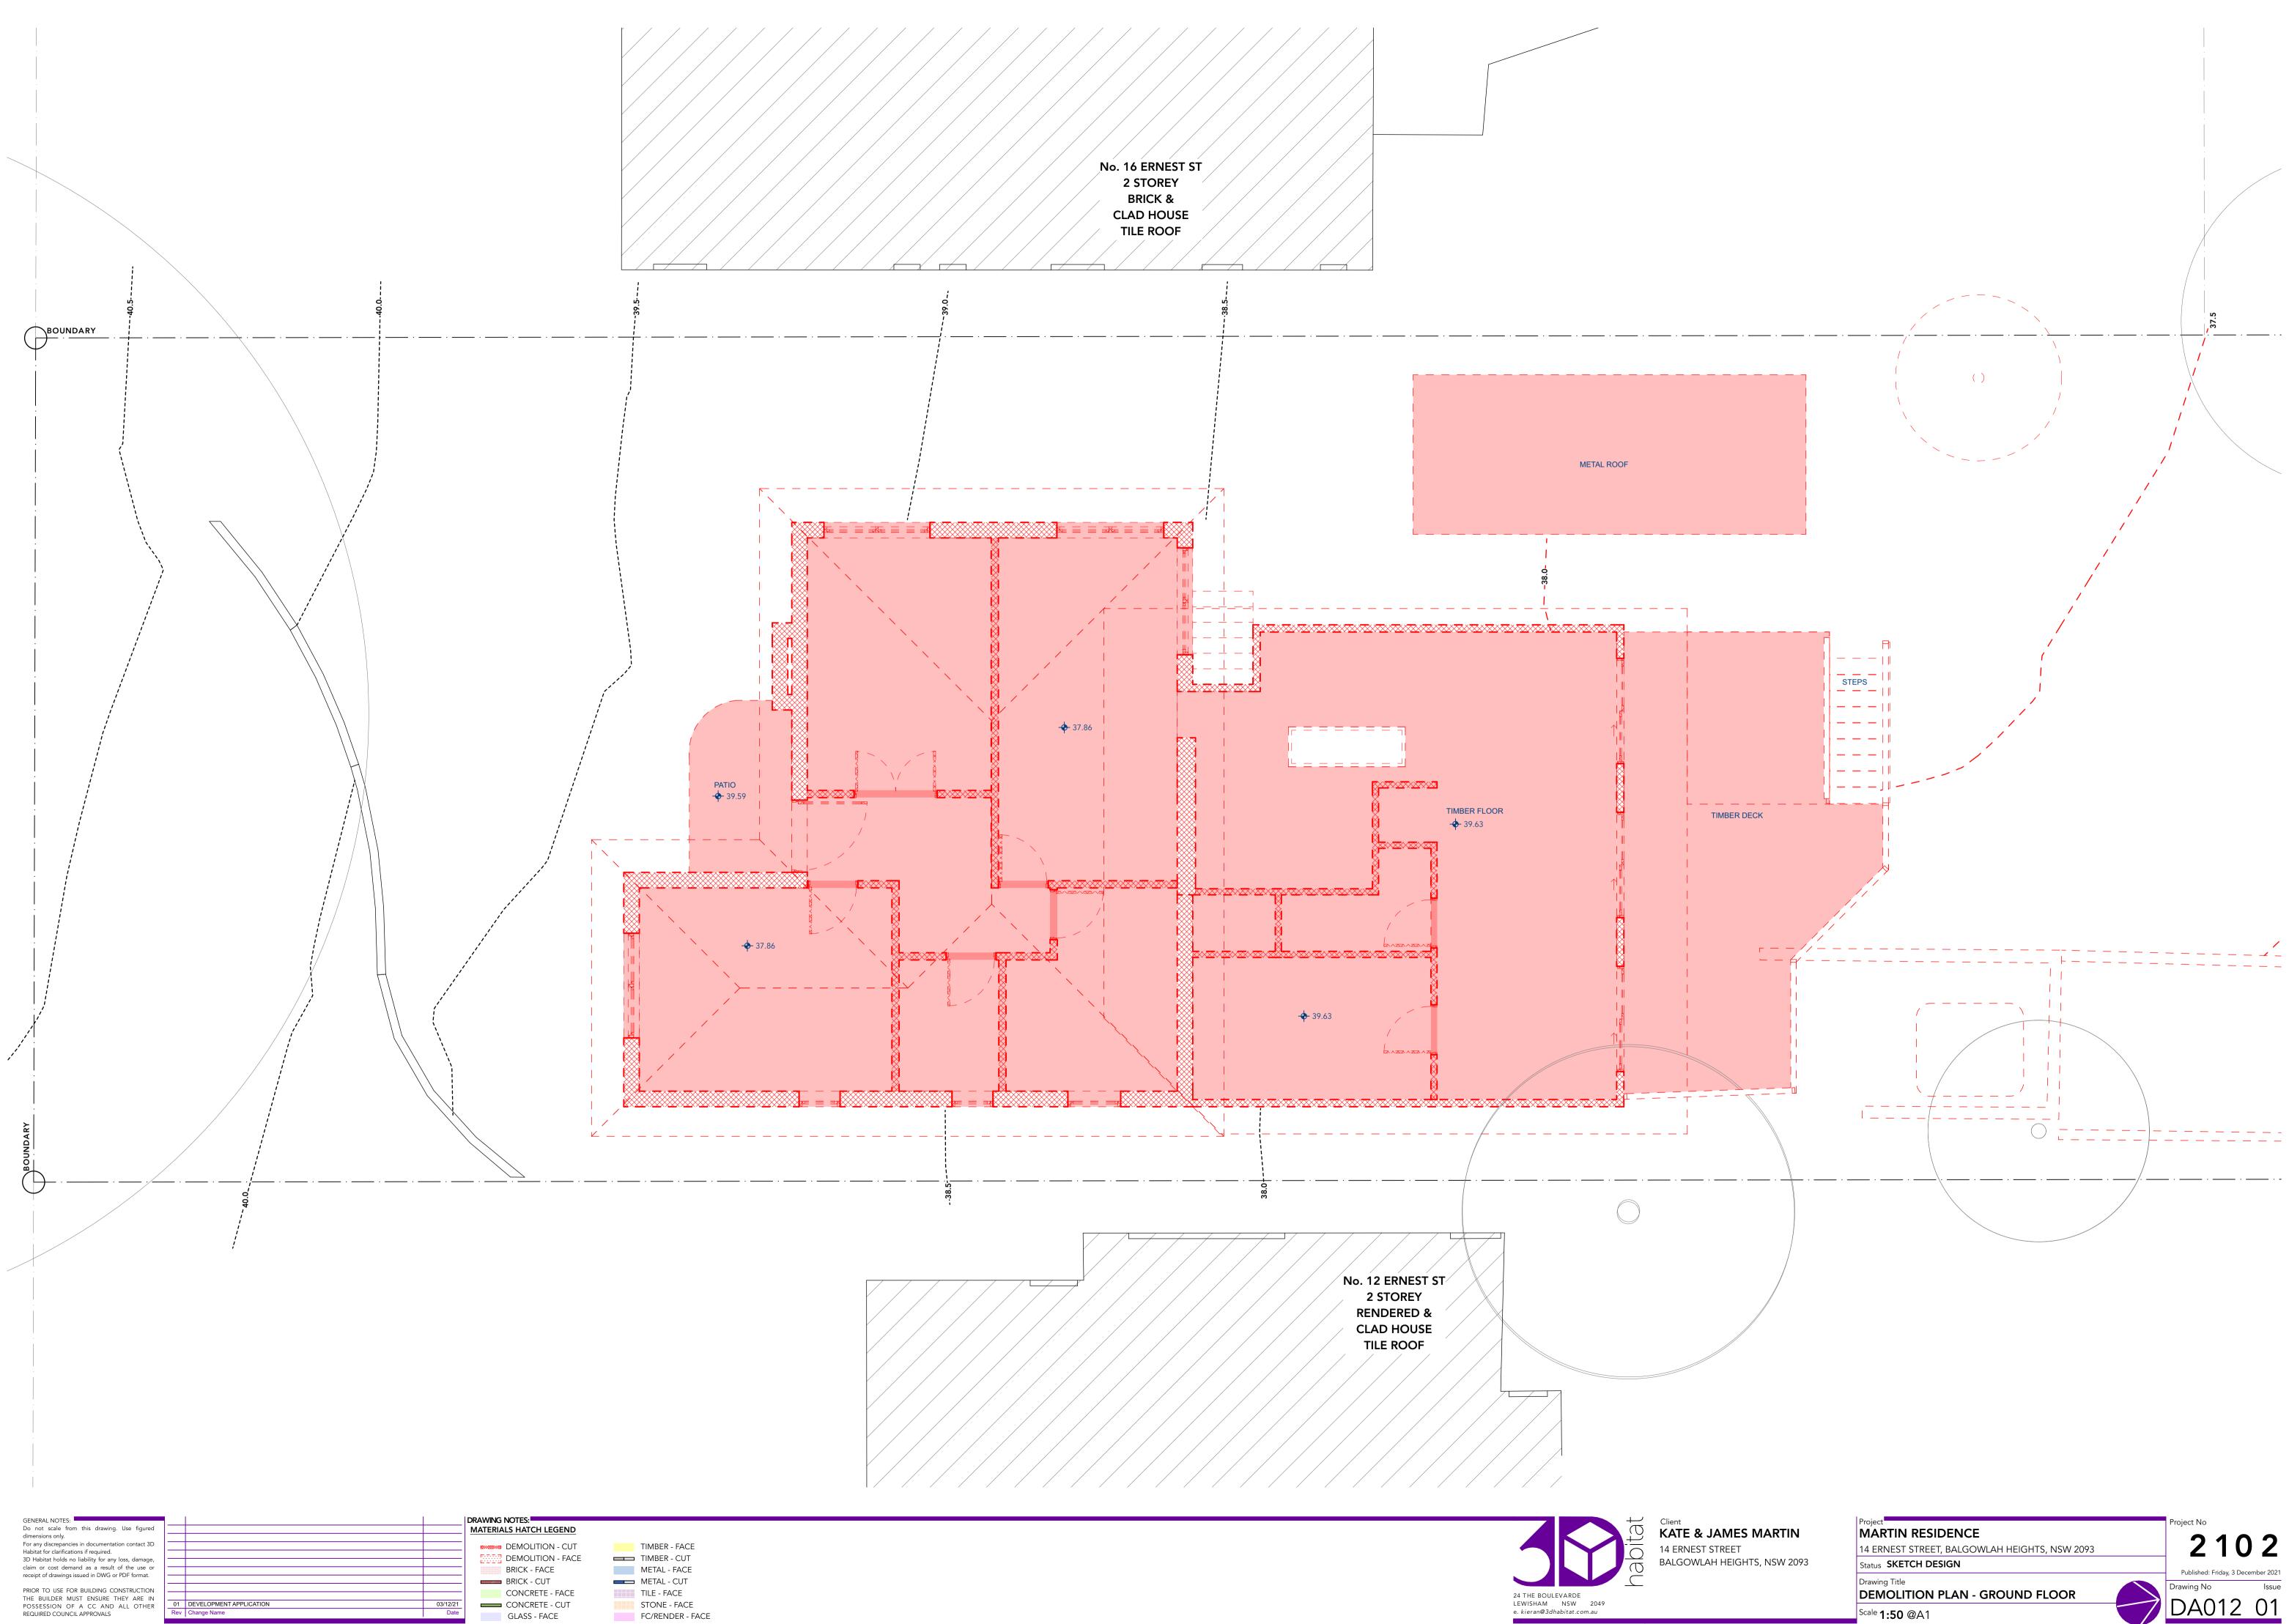

OPMENT APPLICATION	03/12/21
Name	Date

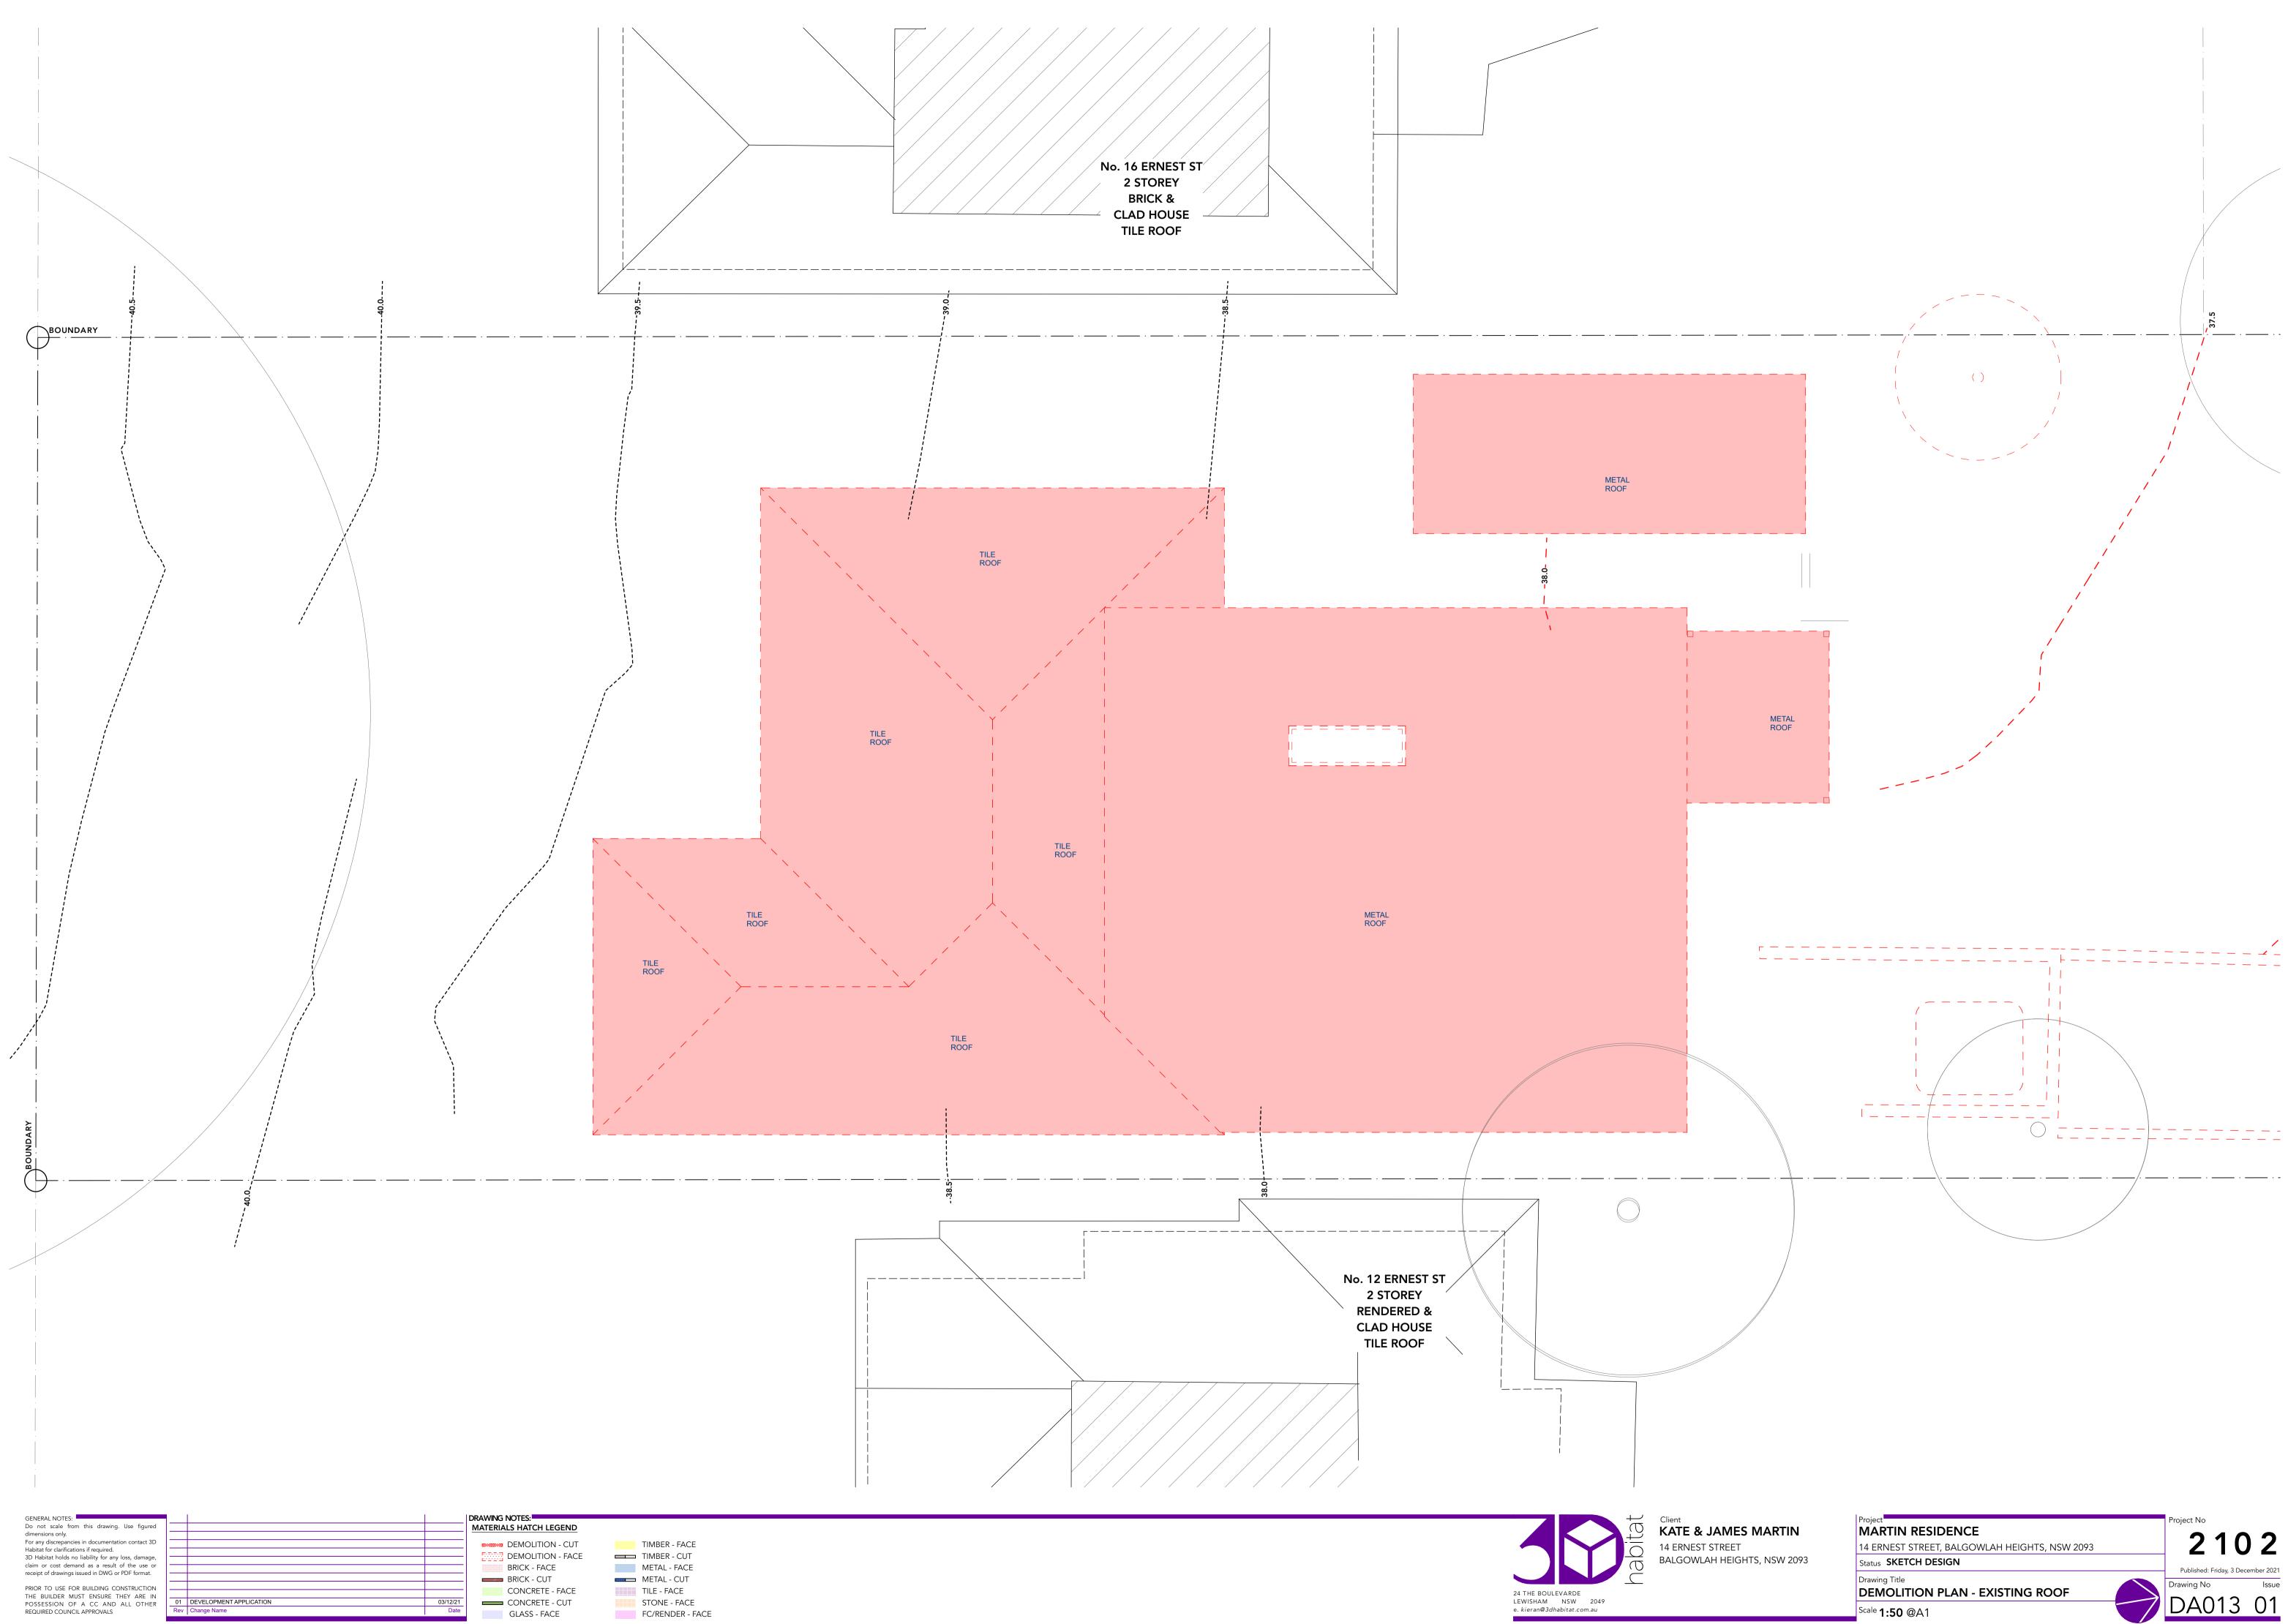

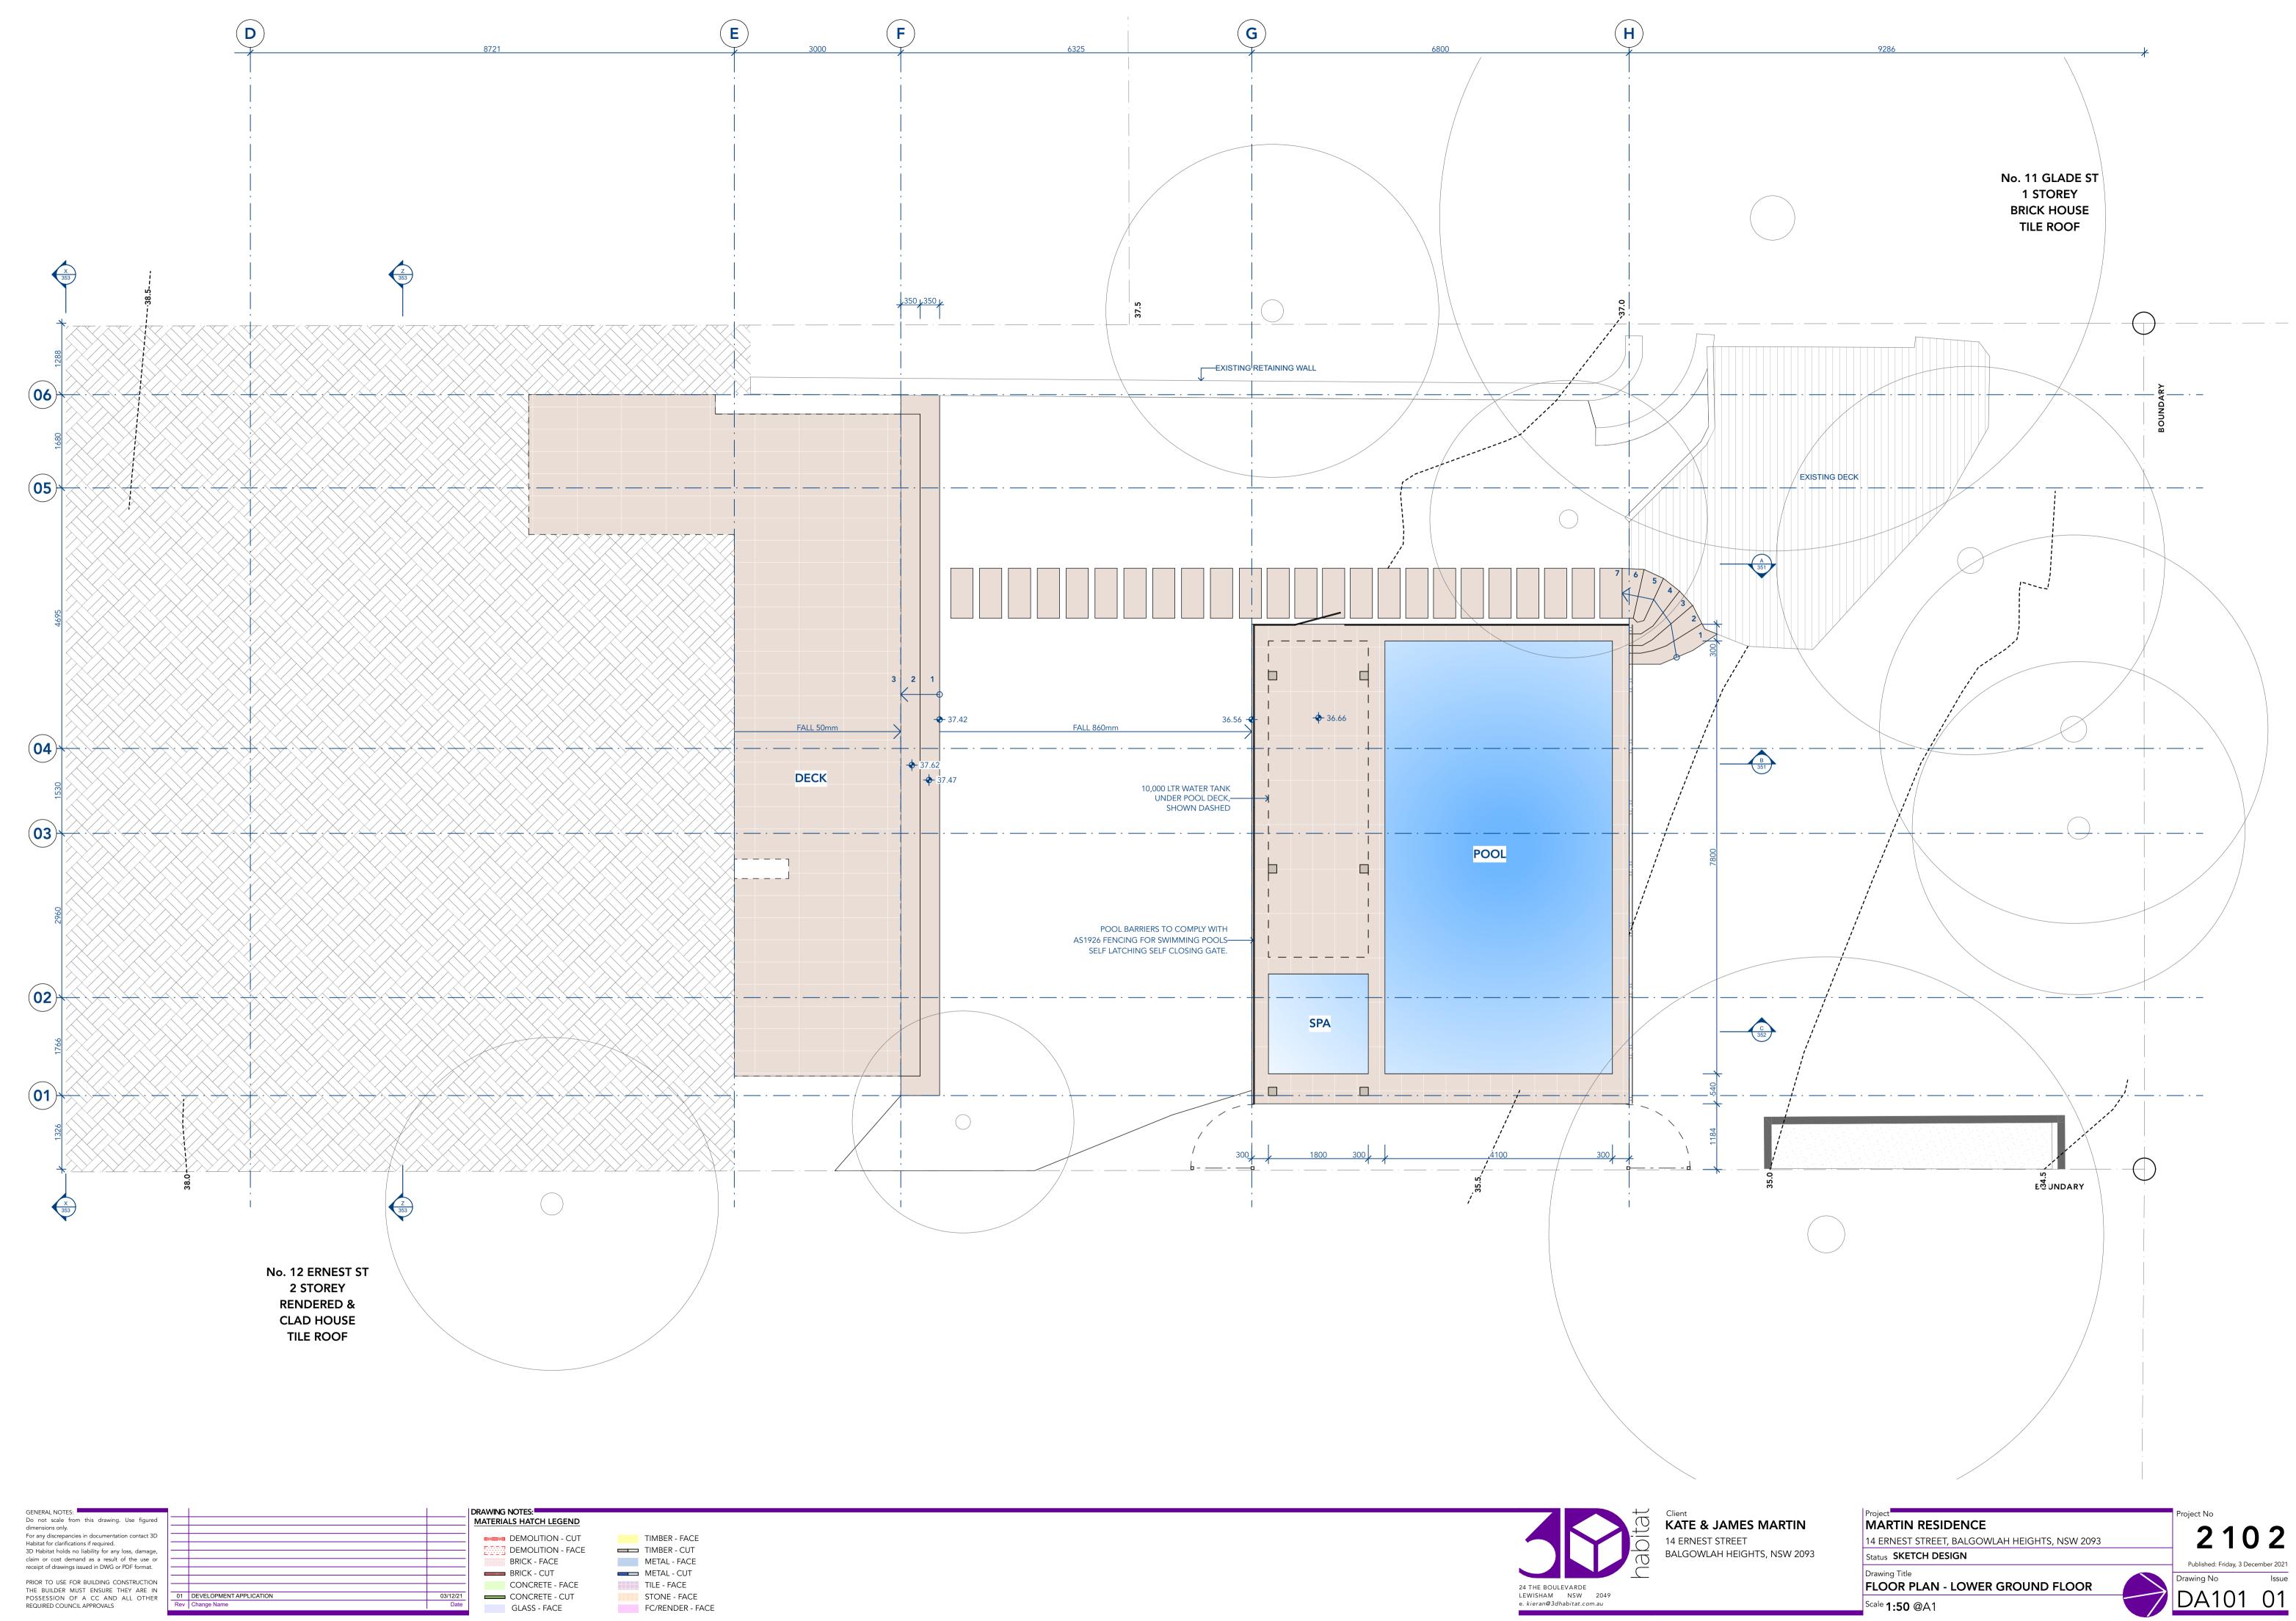

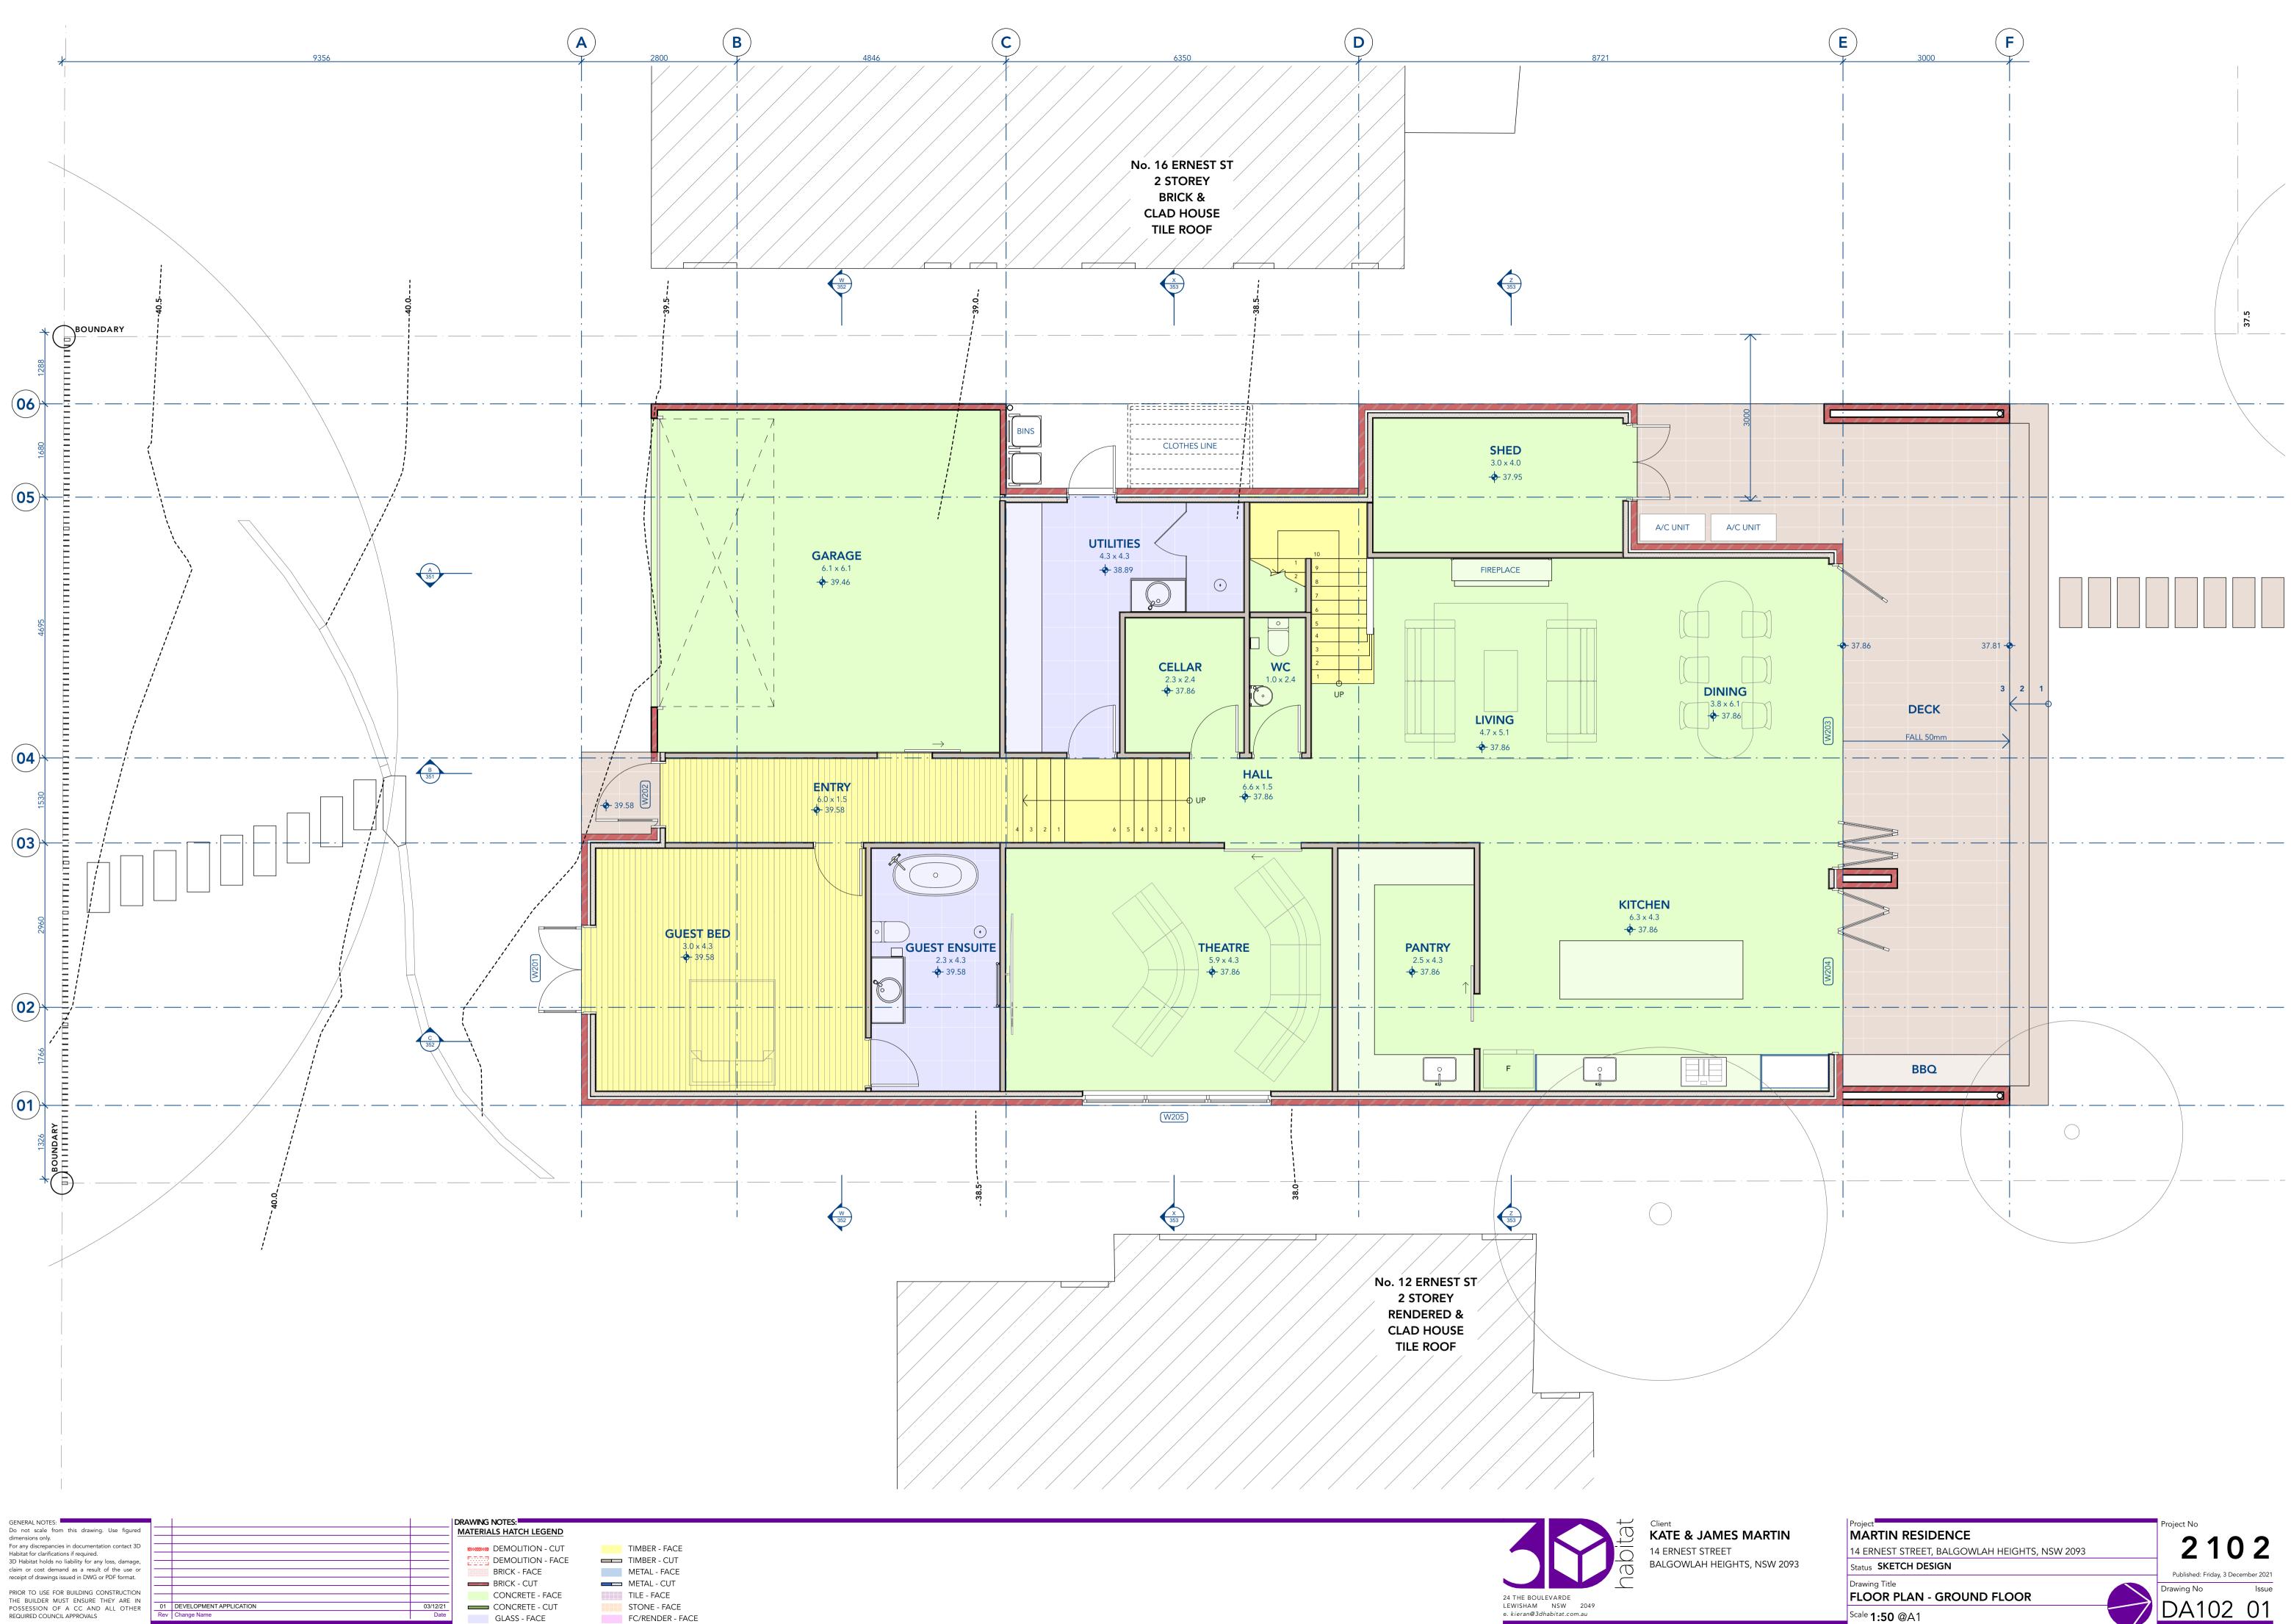

PRIOR TO USE FOR BUILDING CONSTRUCTION THE BUILDER MUST ENSURE THEY ARE IN POSSESSION OF A CC AND ALL OTHER REQUIRED COUNCIL APPROVALS

03/12/21 Date

CONCRETE - FACE CONCRETE - CUT GLASS - FACE

TILE - FACE STONE - FACE FC/RENDER - FACE

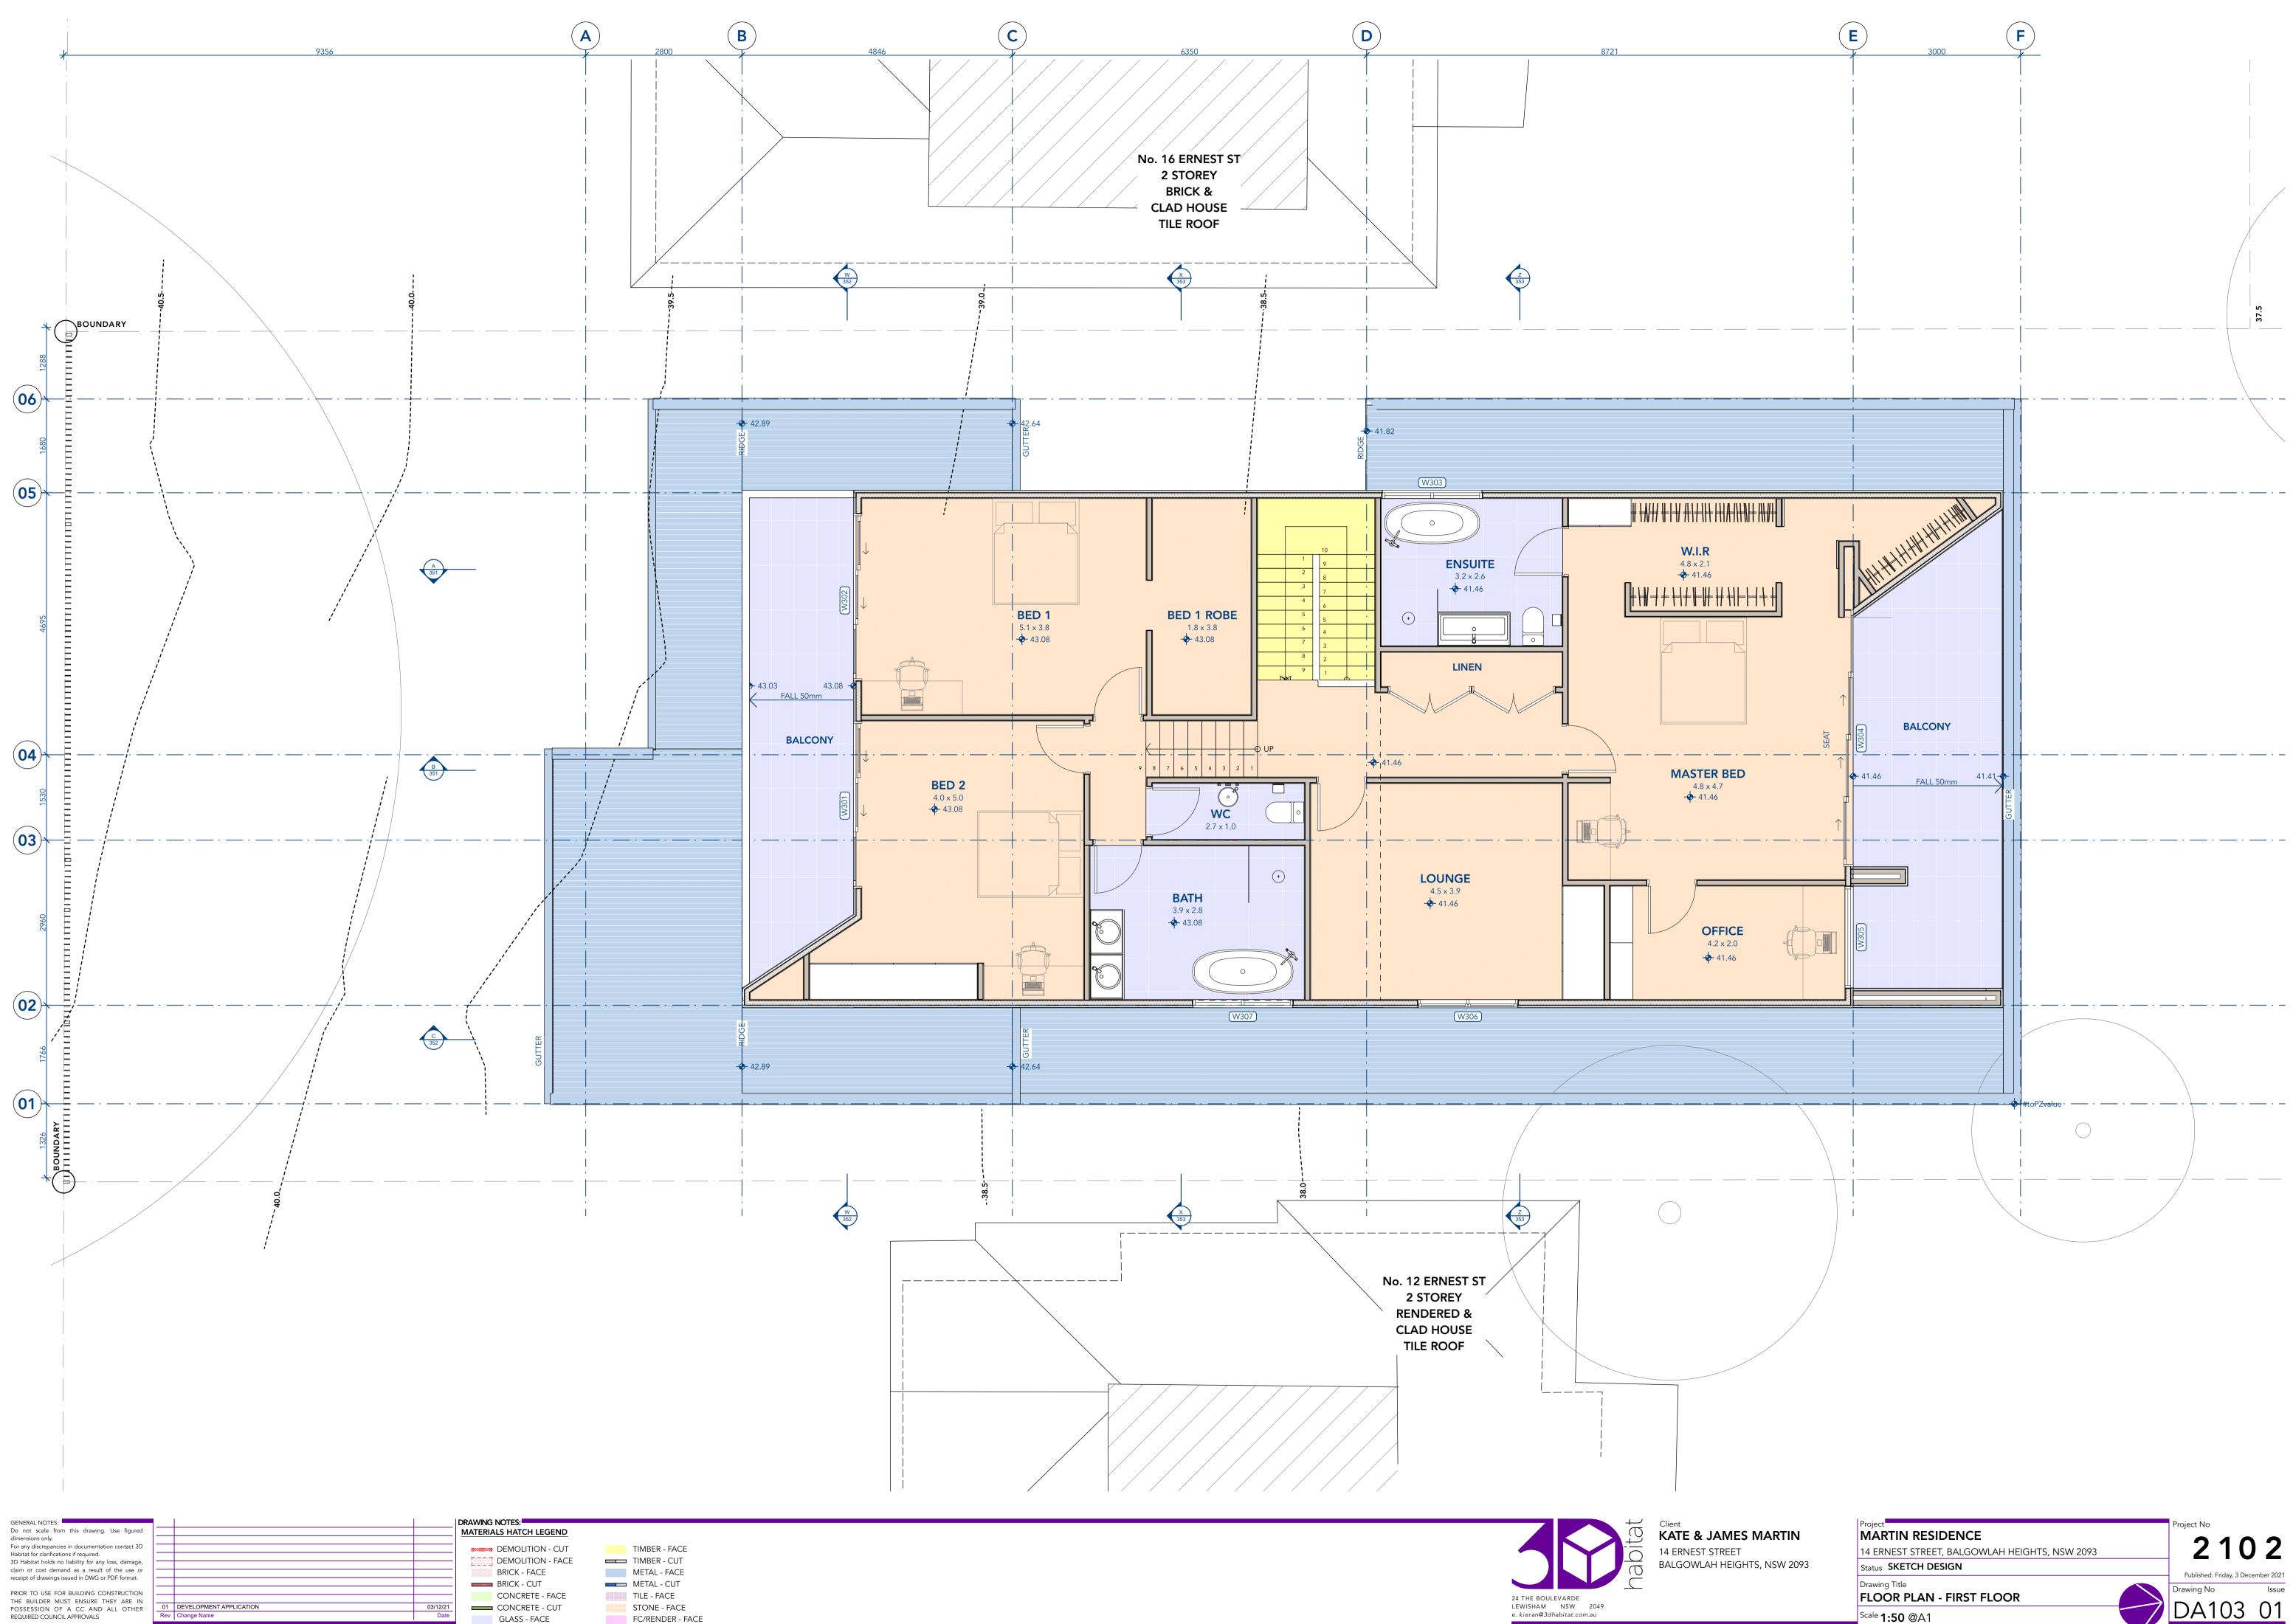
24 THE BOULEVARDE

LEWISHAM NSW 2049

e. kieran@3dhabitat.com.au

FLOOR PLAN - GROUND FLOOR

<sup>Scale</sup> **1:50** @A1



03/12/21 Date

CONCRETE - CUT GLASS - FACE

STONE - FACE FC/RENDER - FACE

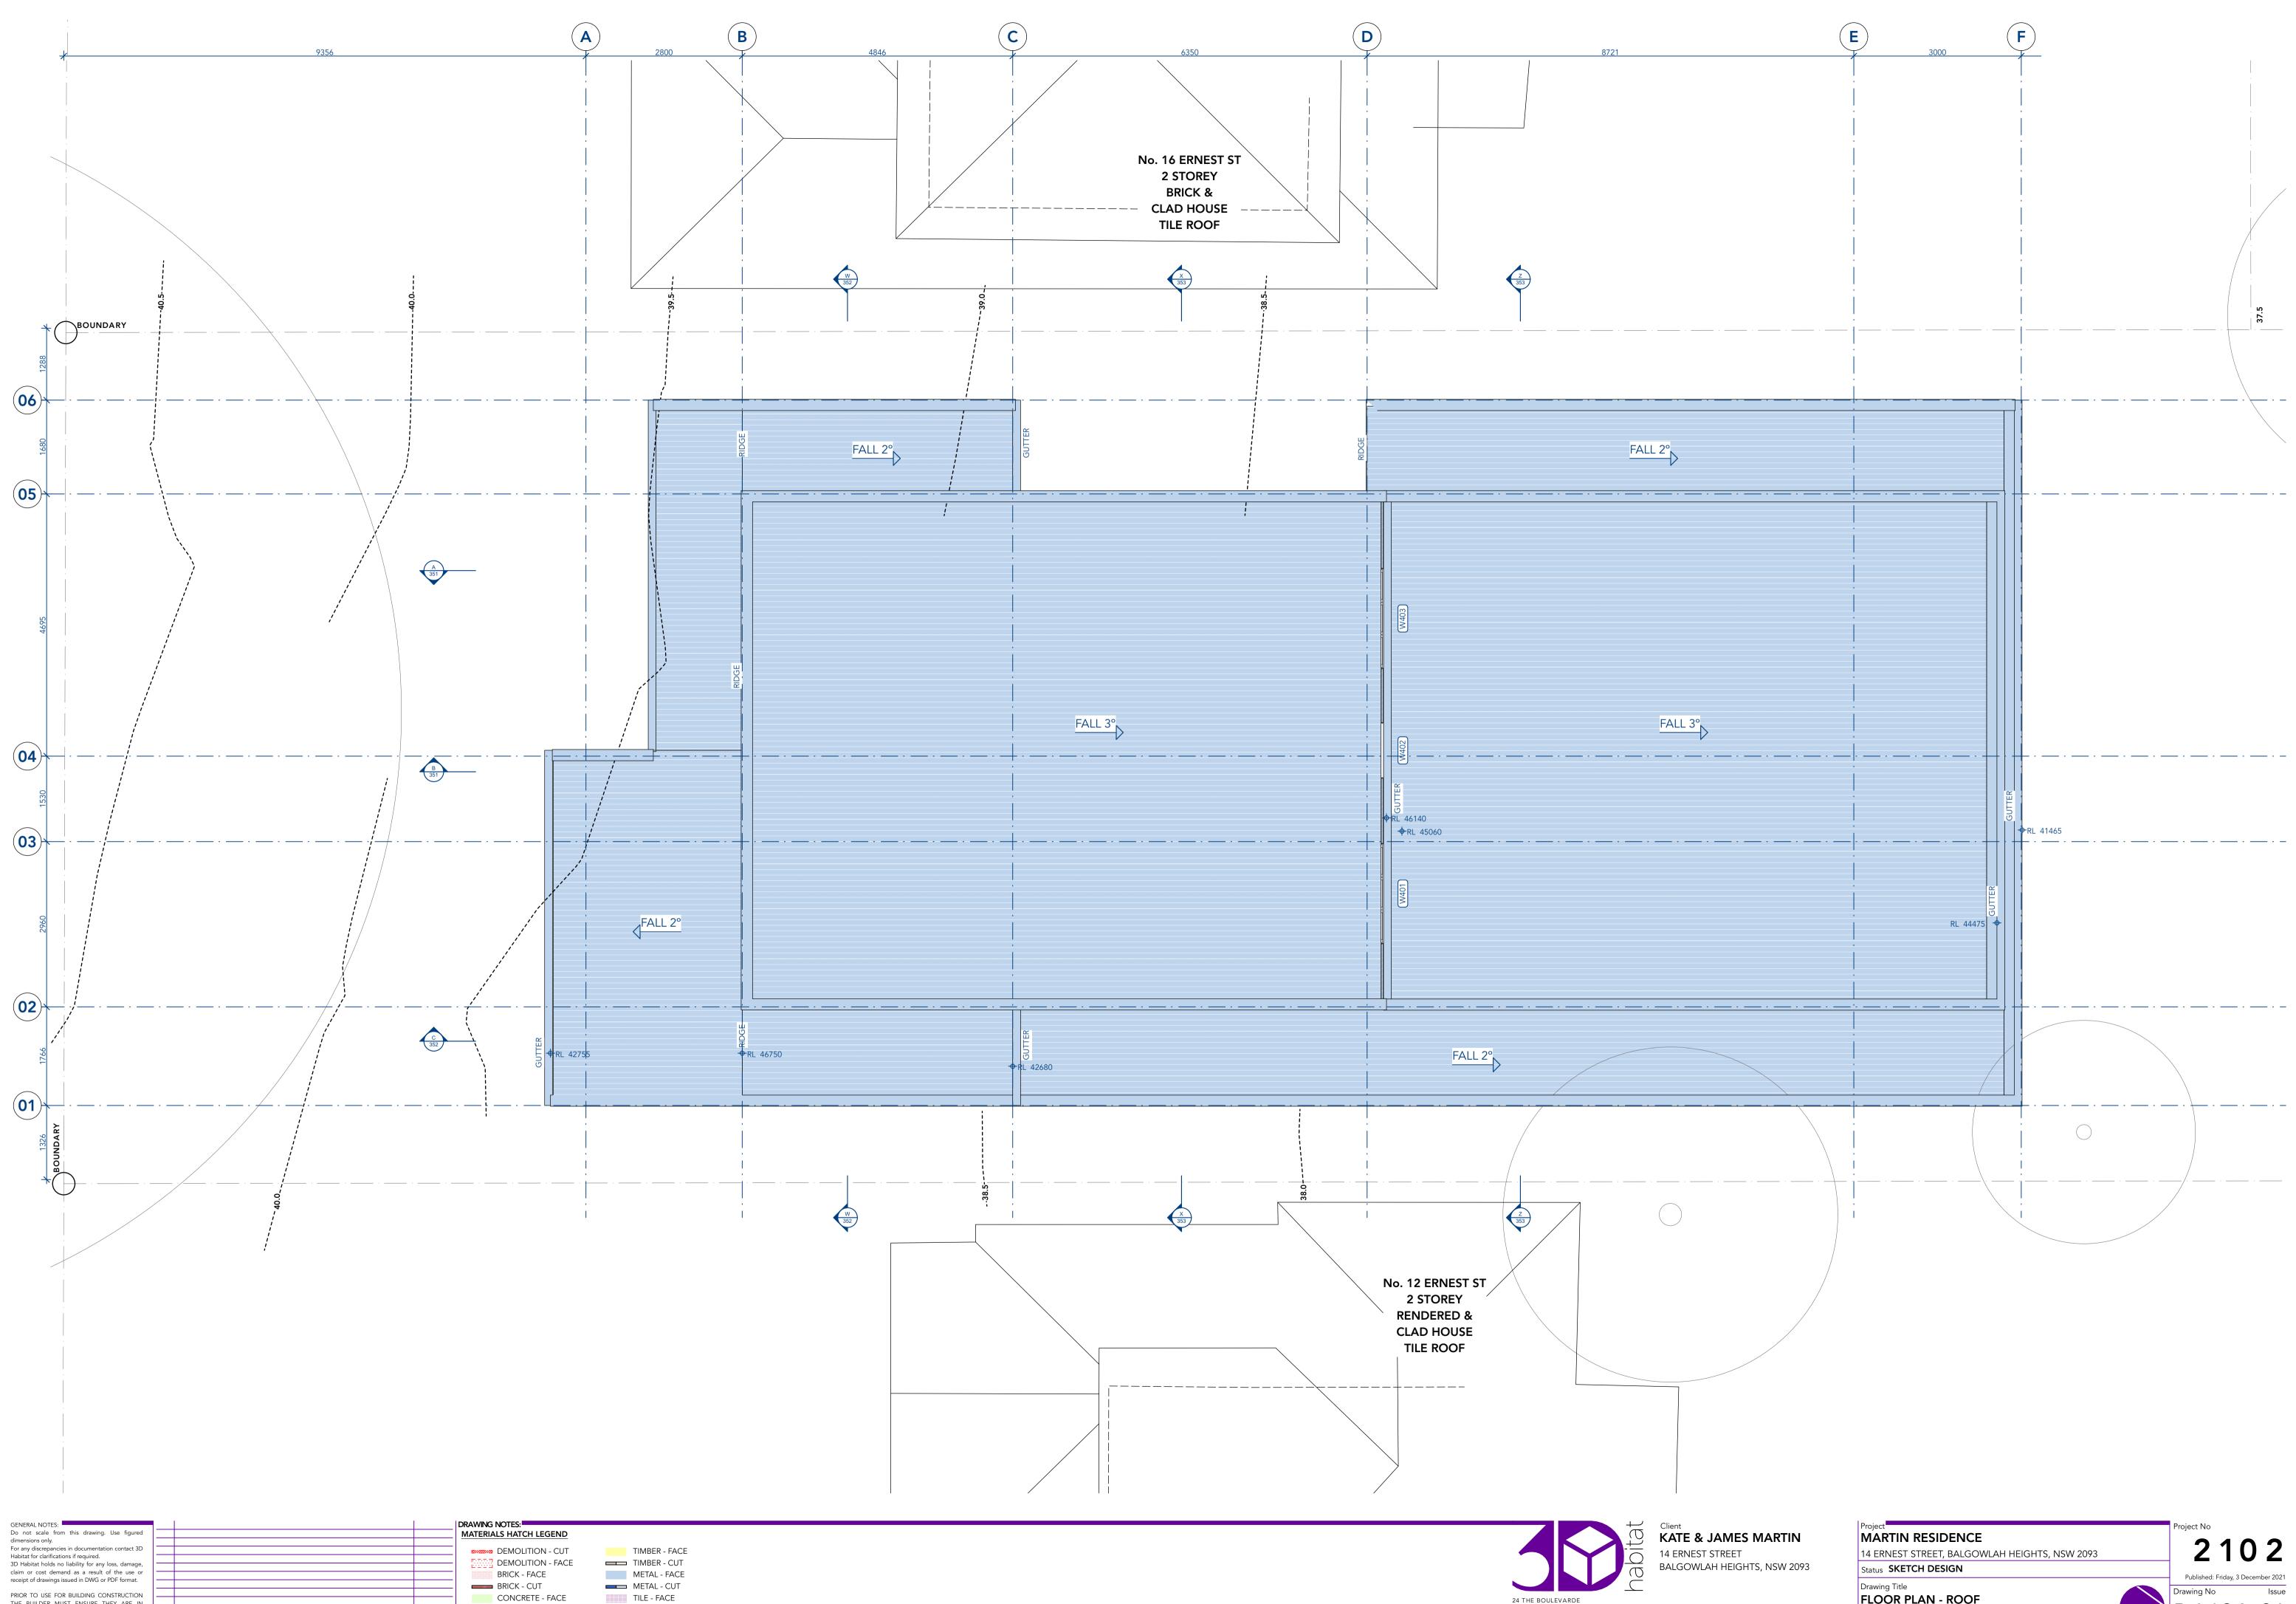
LEWISHAM NSW 2049

e. kieran@3dhabitat.com.au

FLOOR PLAN - FIRST FLOOR

Drawing No Issue

<sup>Scale</sup> **1:50** @A1



PRIOR TO USE FOR BUILDING CONSTRUCTION THE BUILDER MUST ENSURE THEY ARE IN POSSESSION OF A CC AND ALL OTHER REQUIRED COUNCIL APPROVALS REV Change Name

03/12/21 Date

TILE - FACE STONE - FACE FC/RENDER - FACE

CONCRETE - CUT

GLASS - FACE

LEWISHAM NSW 2049 e. kieran@3dhabitat.com.au

Drawing Title FLOOR PLAN - ROOF

Drawing No Issue

<sup>Scale</sup> **1:50** @A1



PRIOR TO USE FOR BUILDING CONSTRUCTION THE BUILDER MUST ENSURE THEY ARE IN POSSESSION OF A CC AND ALL OTHER REQUIRED COUNCIL APPROVALS

03/12/21 Date

BRICK - CUT CONCRETE - FACE CONCRETE - CUT GLASS - FACE

METAL - CUT TILE - FACE STONE - FACE FC/RENDER - FACE

16 ERNEST ST	

S	Μ	ART	IN
iΗ	τs,	NSW	2093

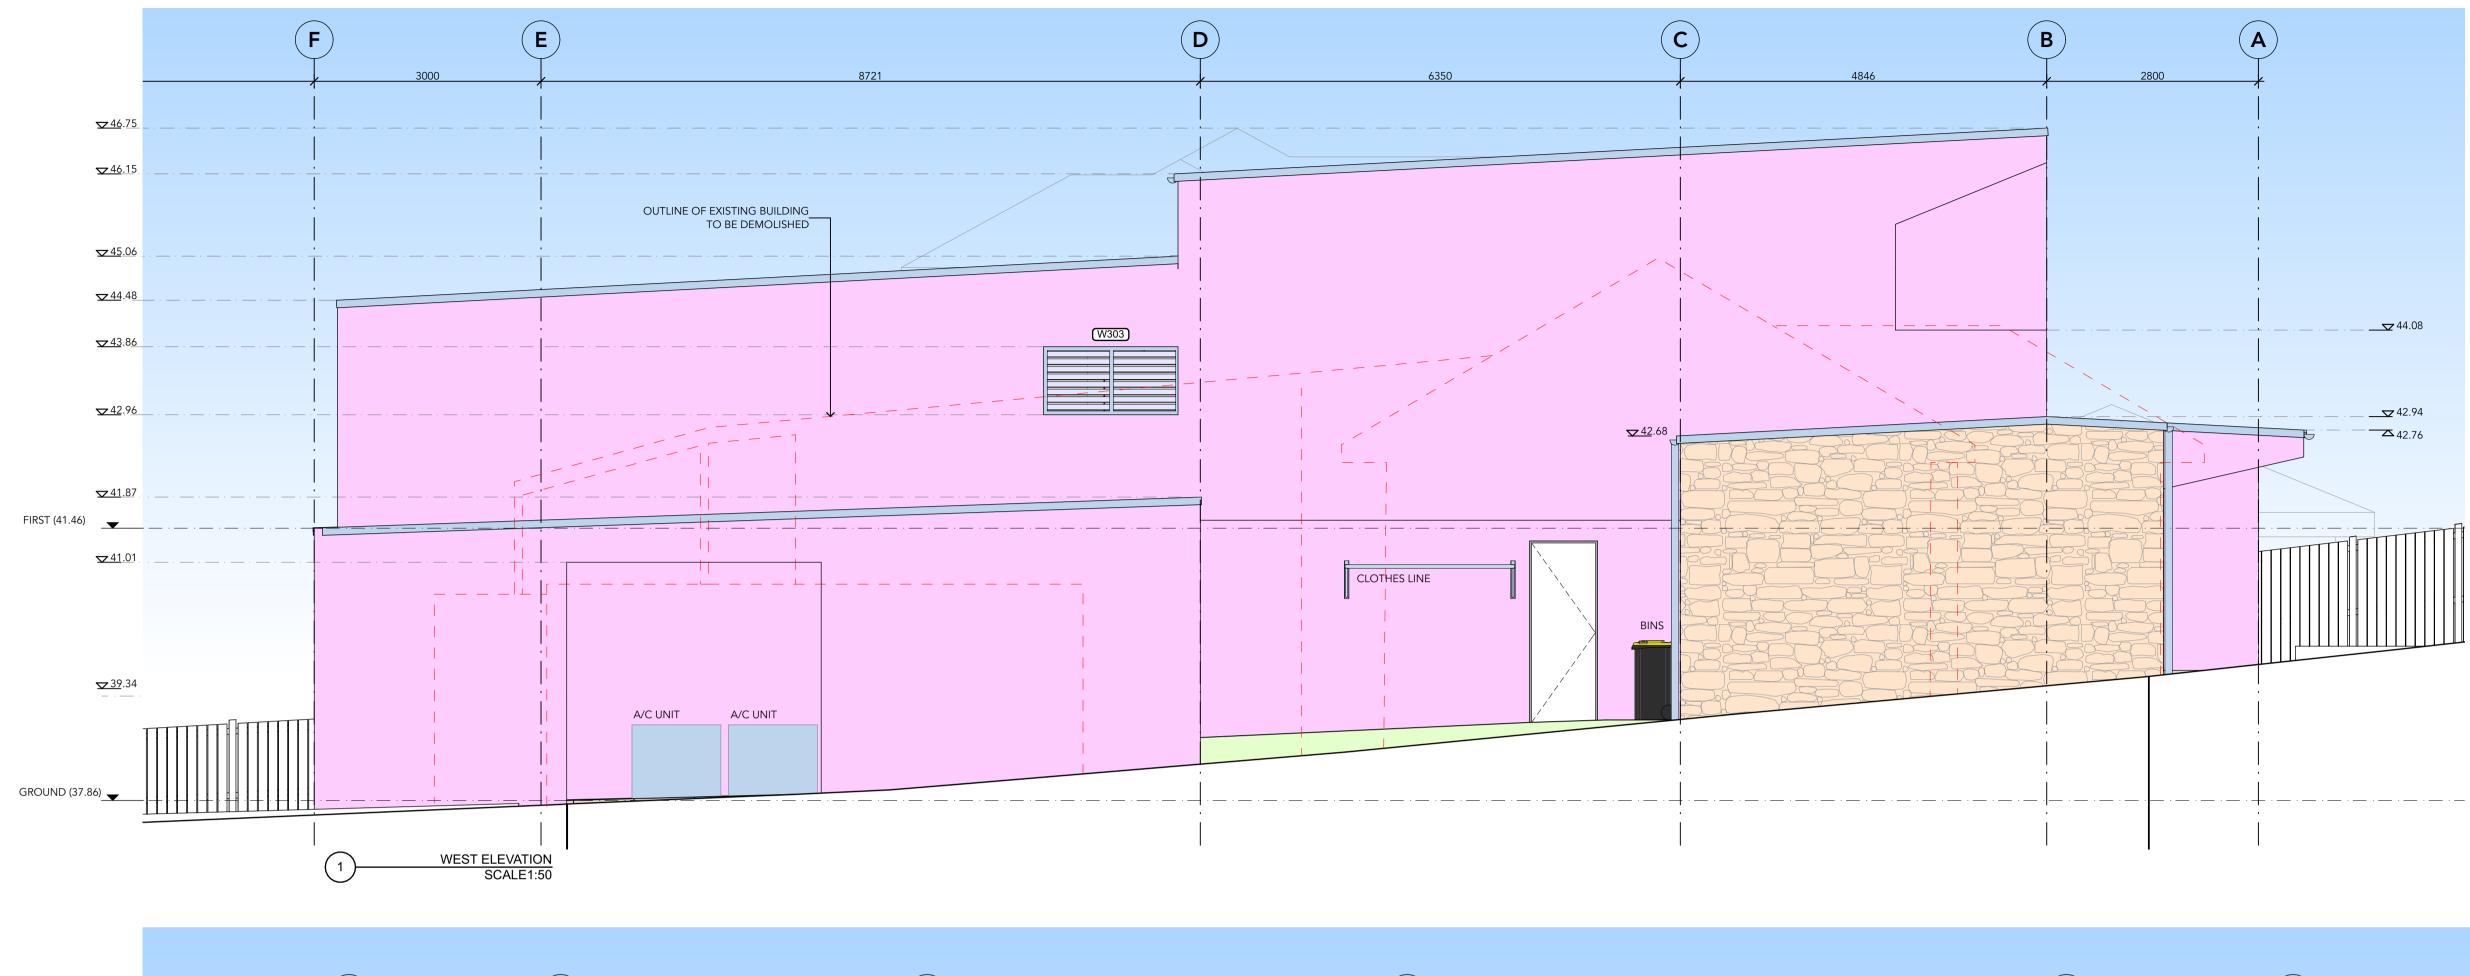
24 THE BOULEVARDE

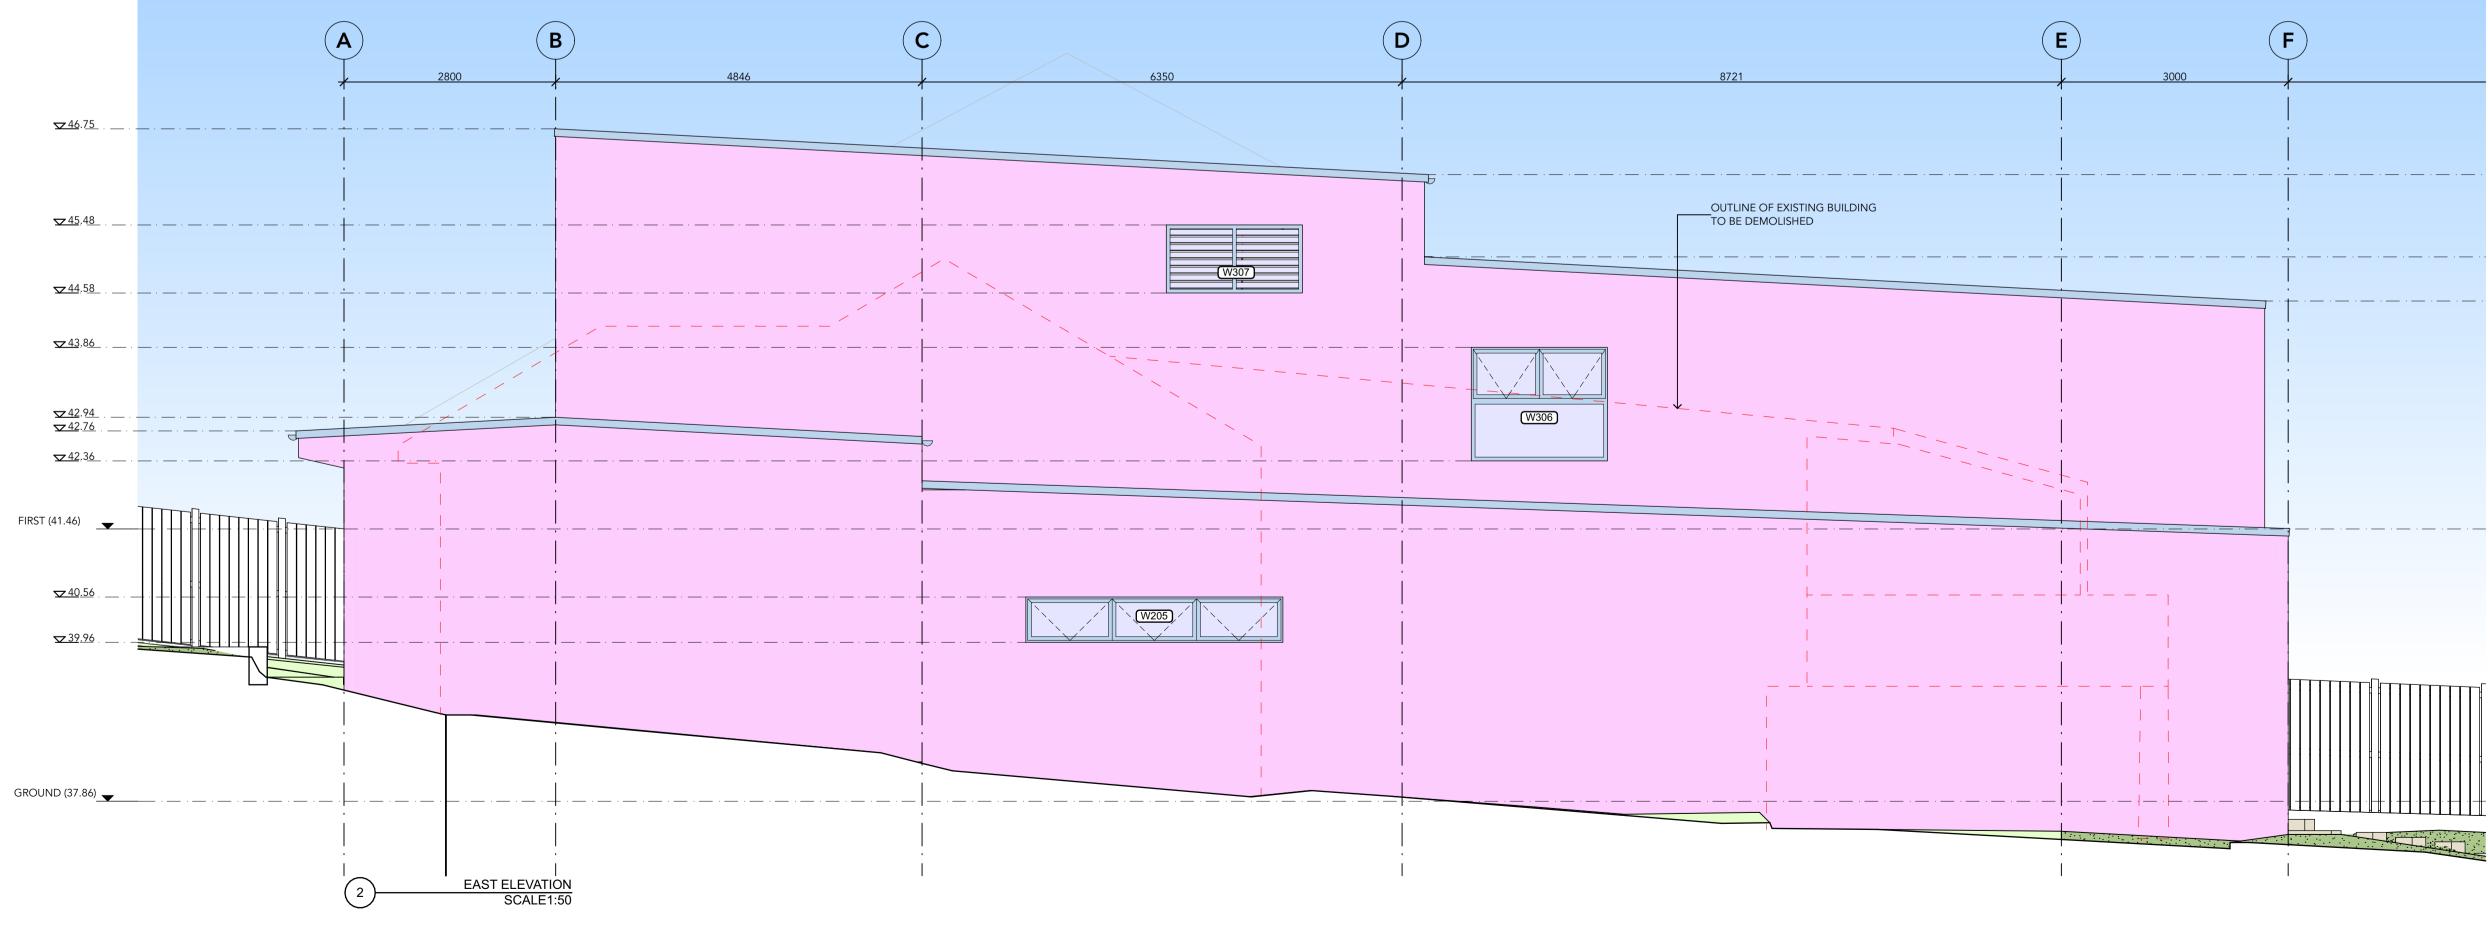
LEWISHAM NSW 2049

e. kieran@3dhabitat.com.au

Project
MARTIN RESIDENCE
14 ERNEST STREET, BALGOWLAH HEIGHTS, NSW 2093
Status SKETCH DESIGN
Drawing Title
ELEVATIONS - SHEET 1
Scale @A1







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receipt of drawings issued in DWG or PDF format. PRIOR TO USE FOR BUILDING CONSTRUCTION THE BUILDER MUST ENSURE THEY ARE IN POSSESSION OF A CC AND ALL OTHER REQUIRED COUNCIL APPROVALS	01         DEVELOPMENT APPLICATION           Rev         Change Name	03/12/21 Date	BRICK - CUT CONCRETE - FACE CONCRETE - CUT GLASS - FACE	METAL - CUT TILE - FACE STONE - FACE FC/RENDER - FACE



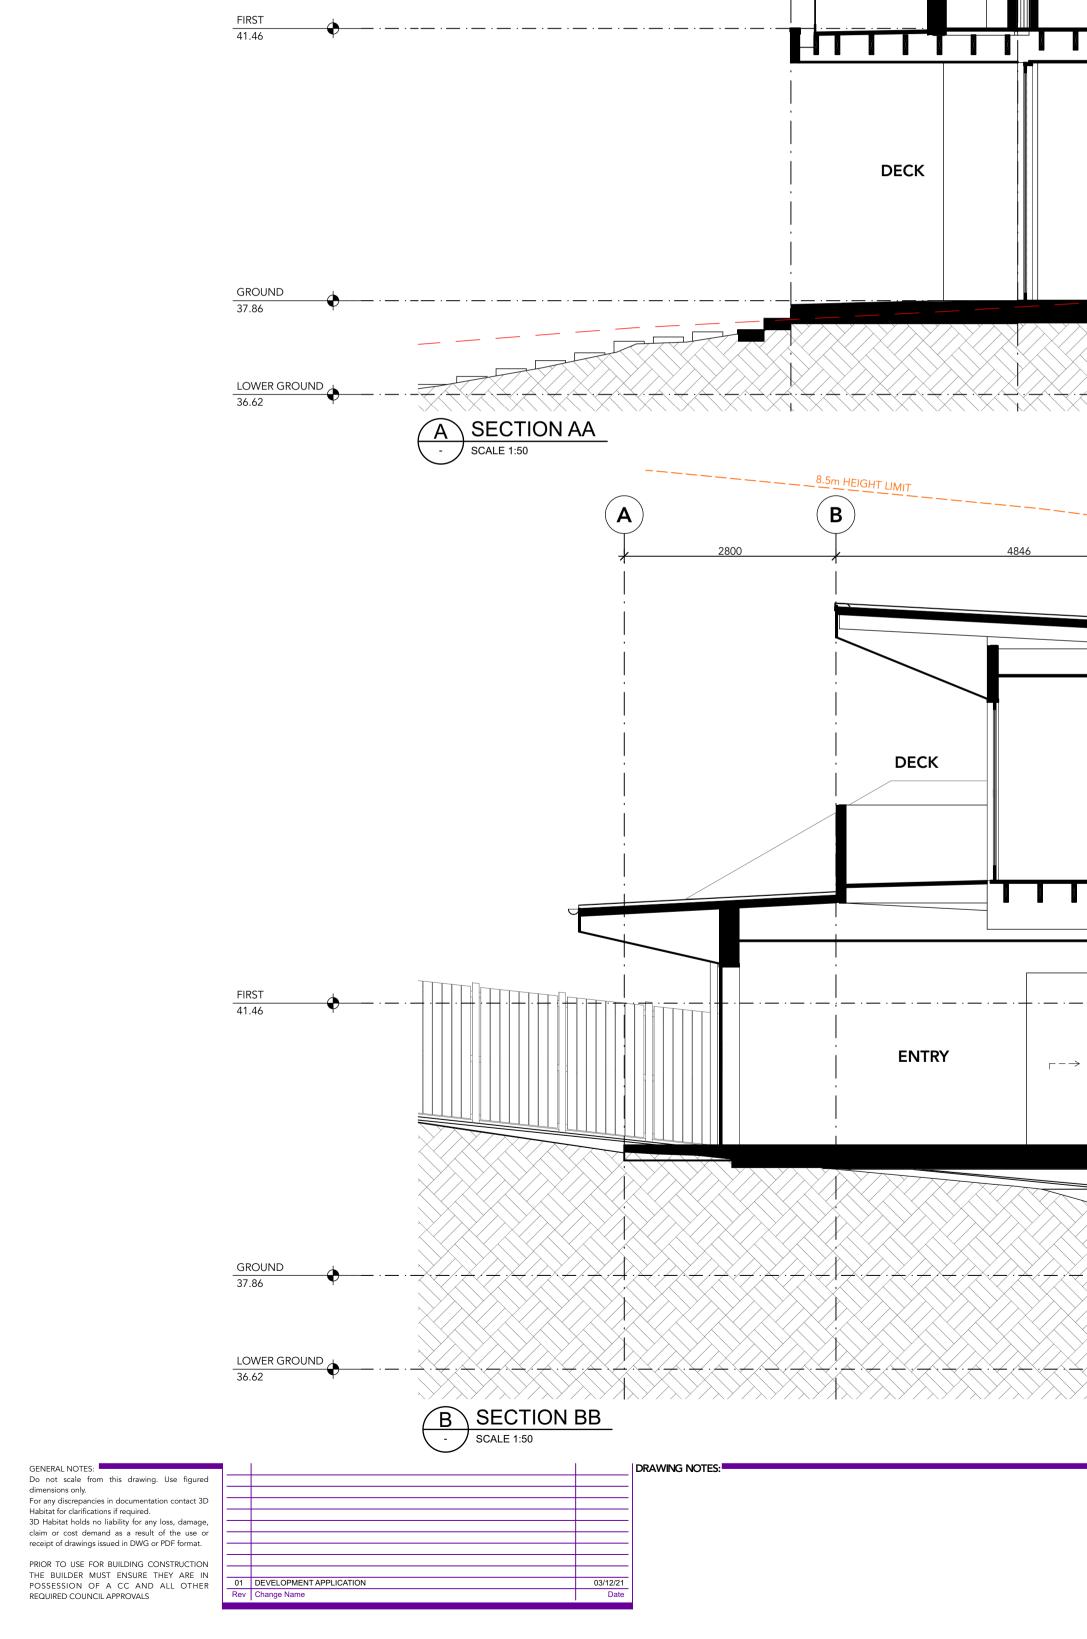
Client KATE & JAMES MARTIN 14 ERNEST STREET BALGOWLAH HEIGHTS, NSW 2093

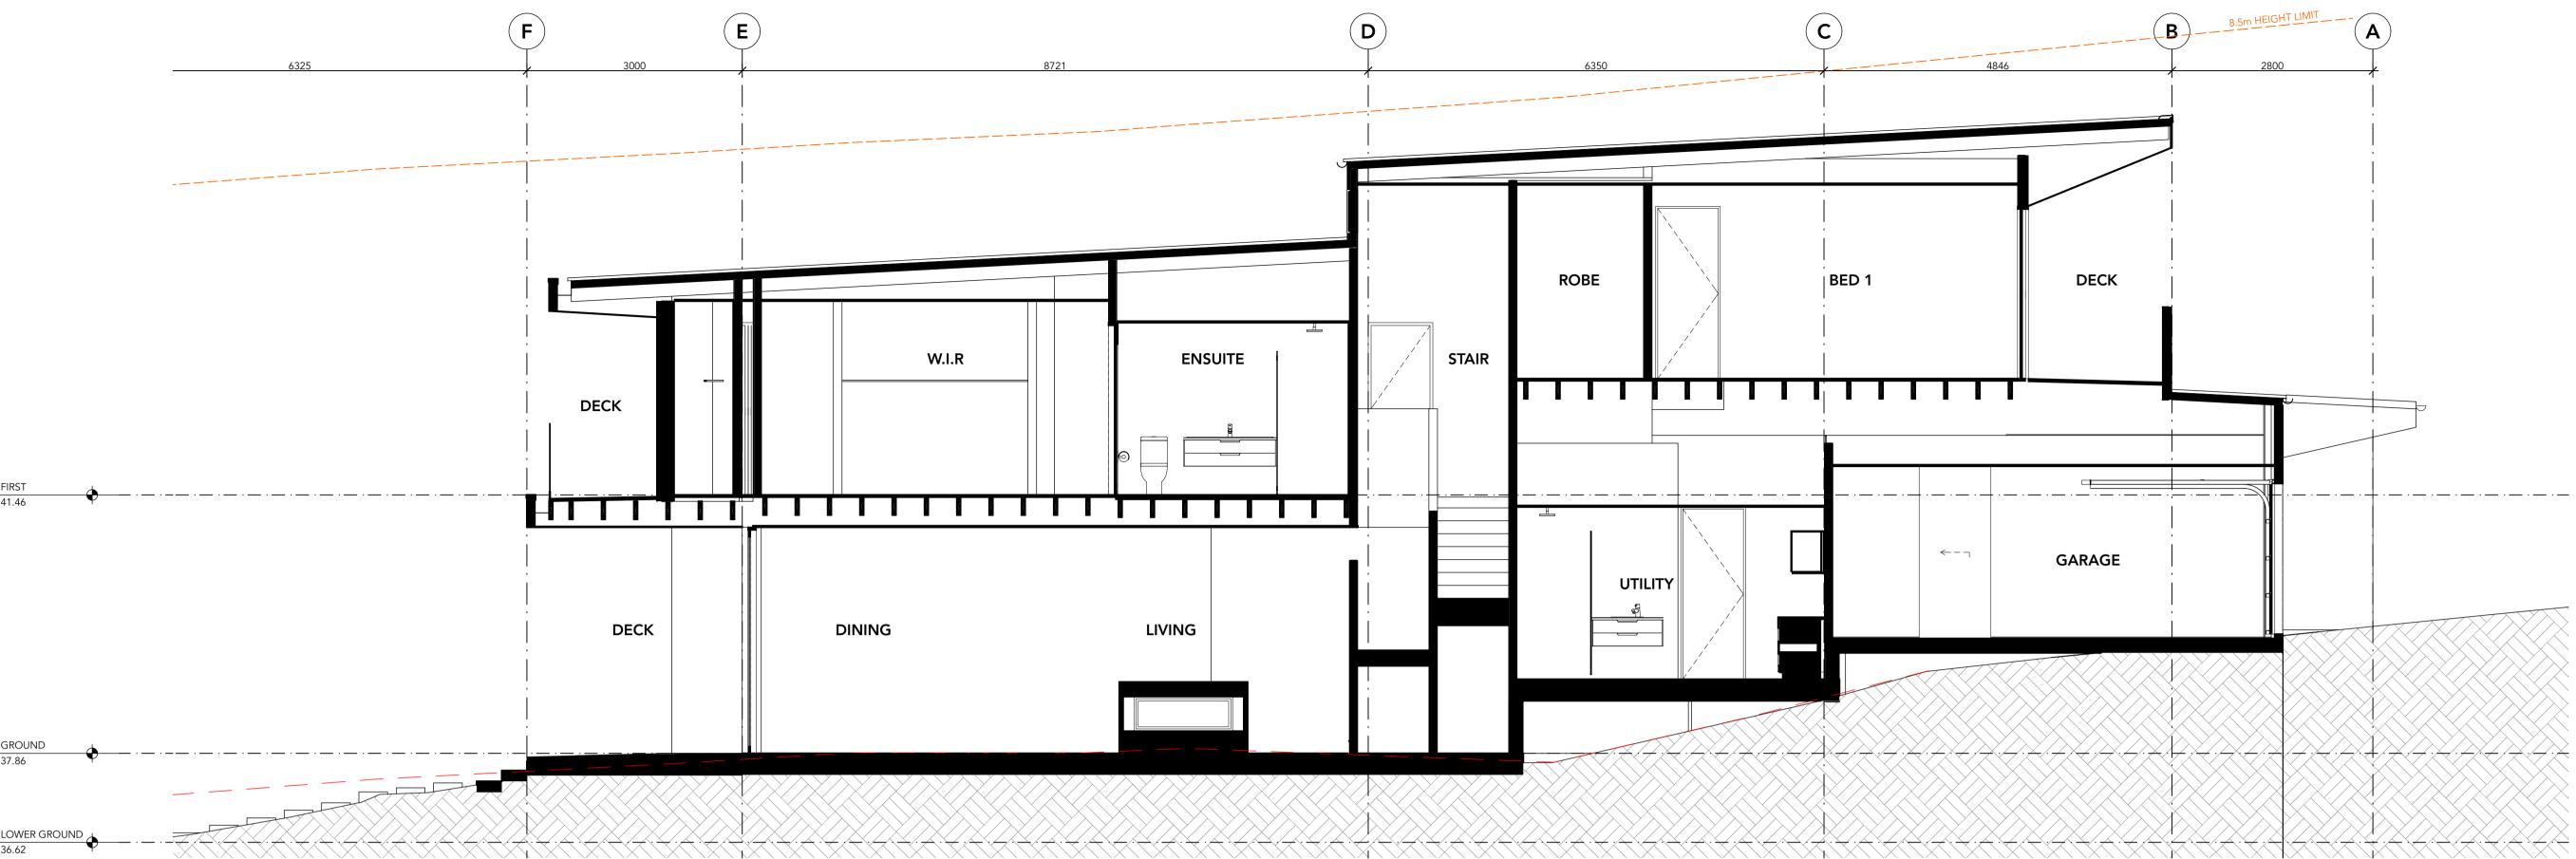


MARTIN RESIDENCE 14 ERNEST STREET, BALGOWLAH HEIGHTS, NSW 2093 Status SKETCH DESIGN Drawing Title ELEVATIONS - SHEET 2

<sup>Scale</sup> @A1

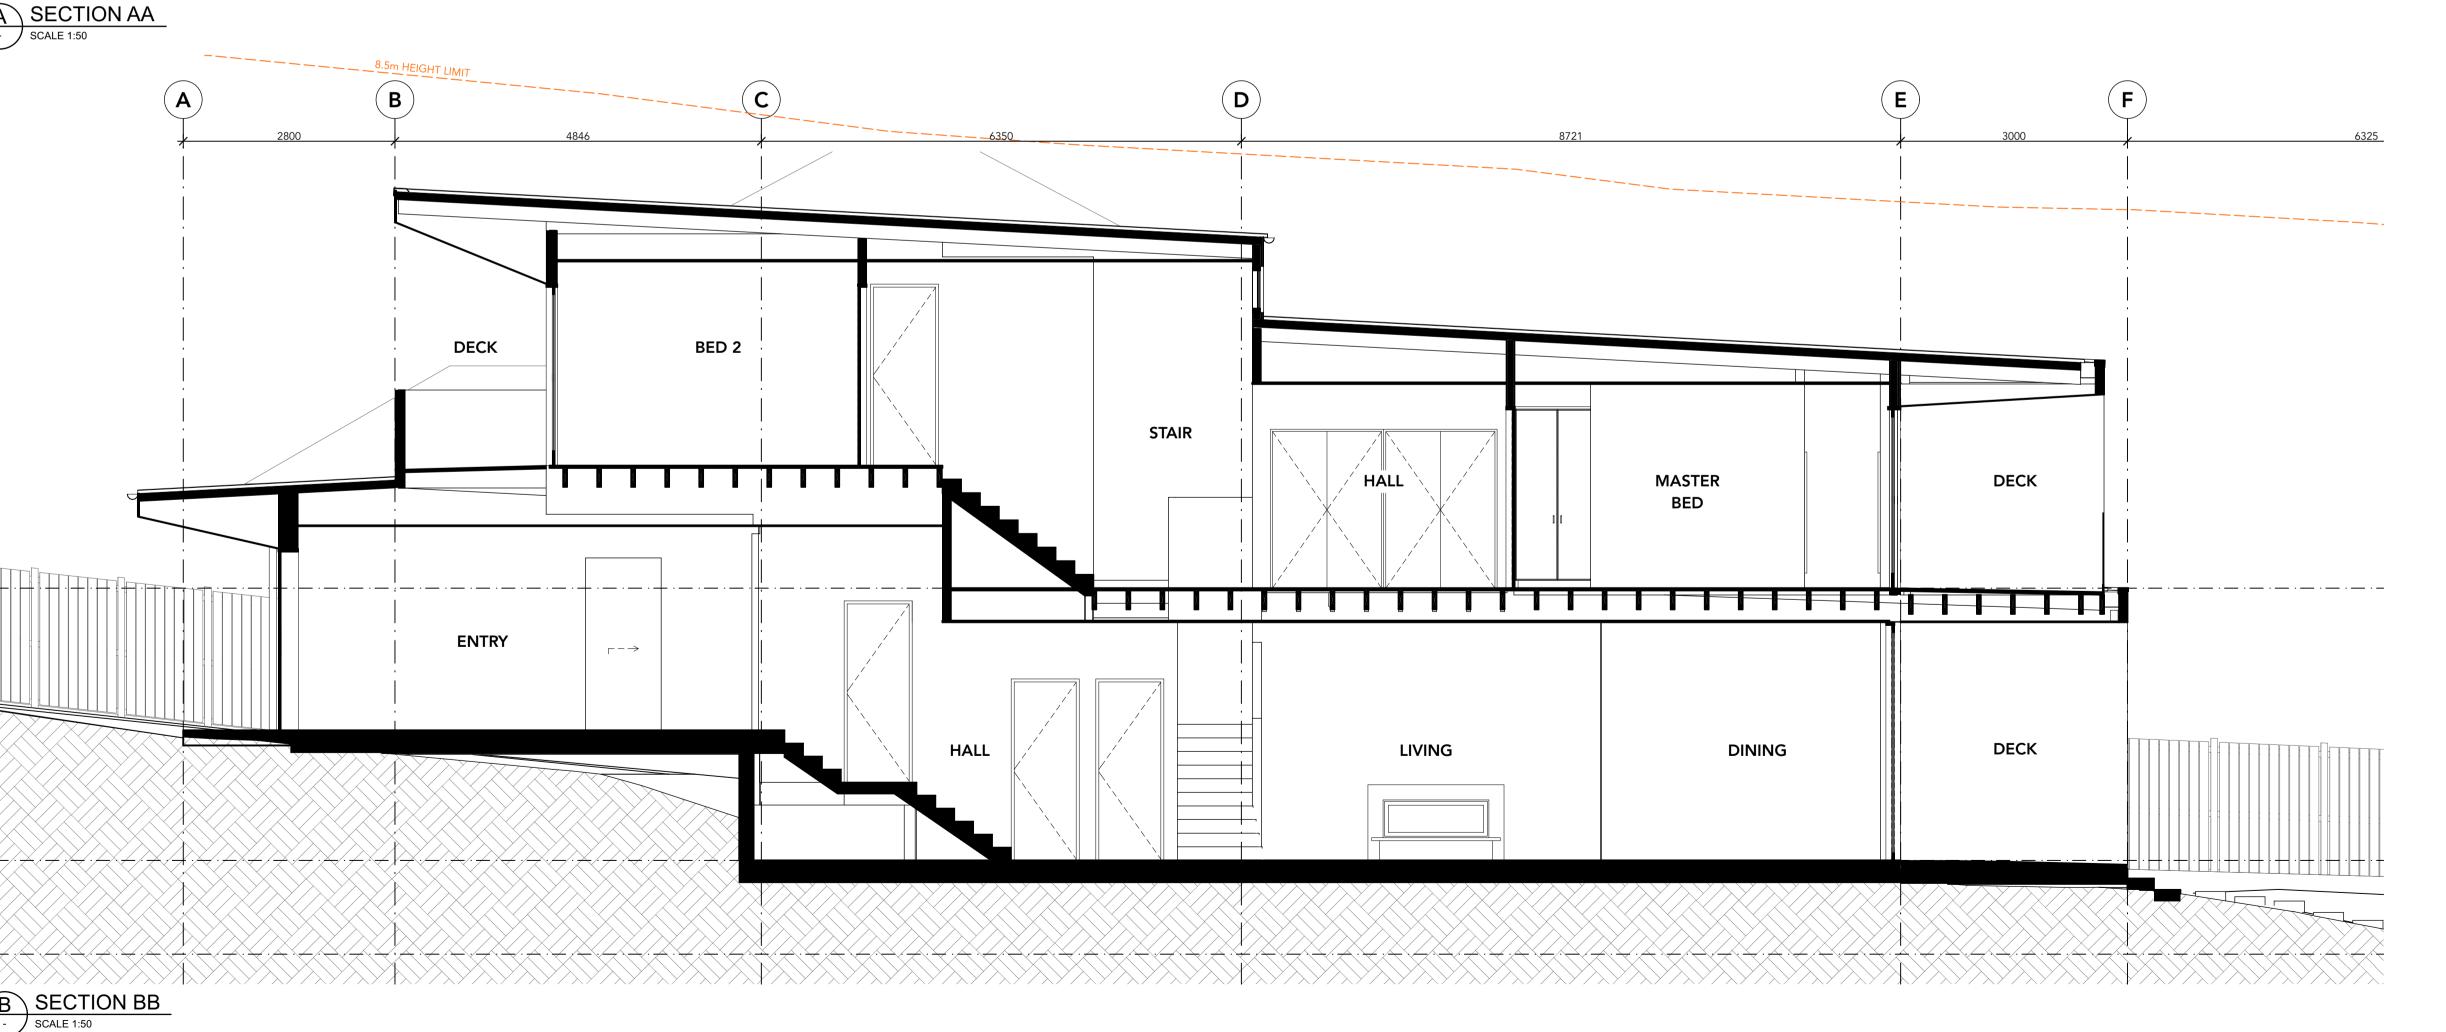













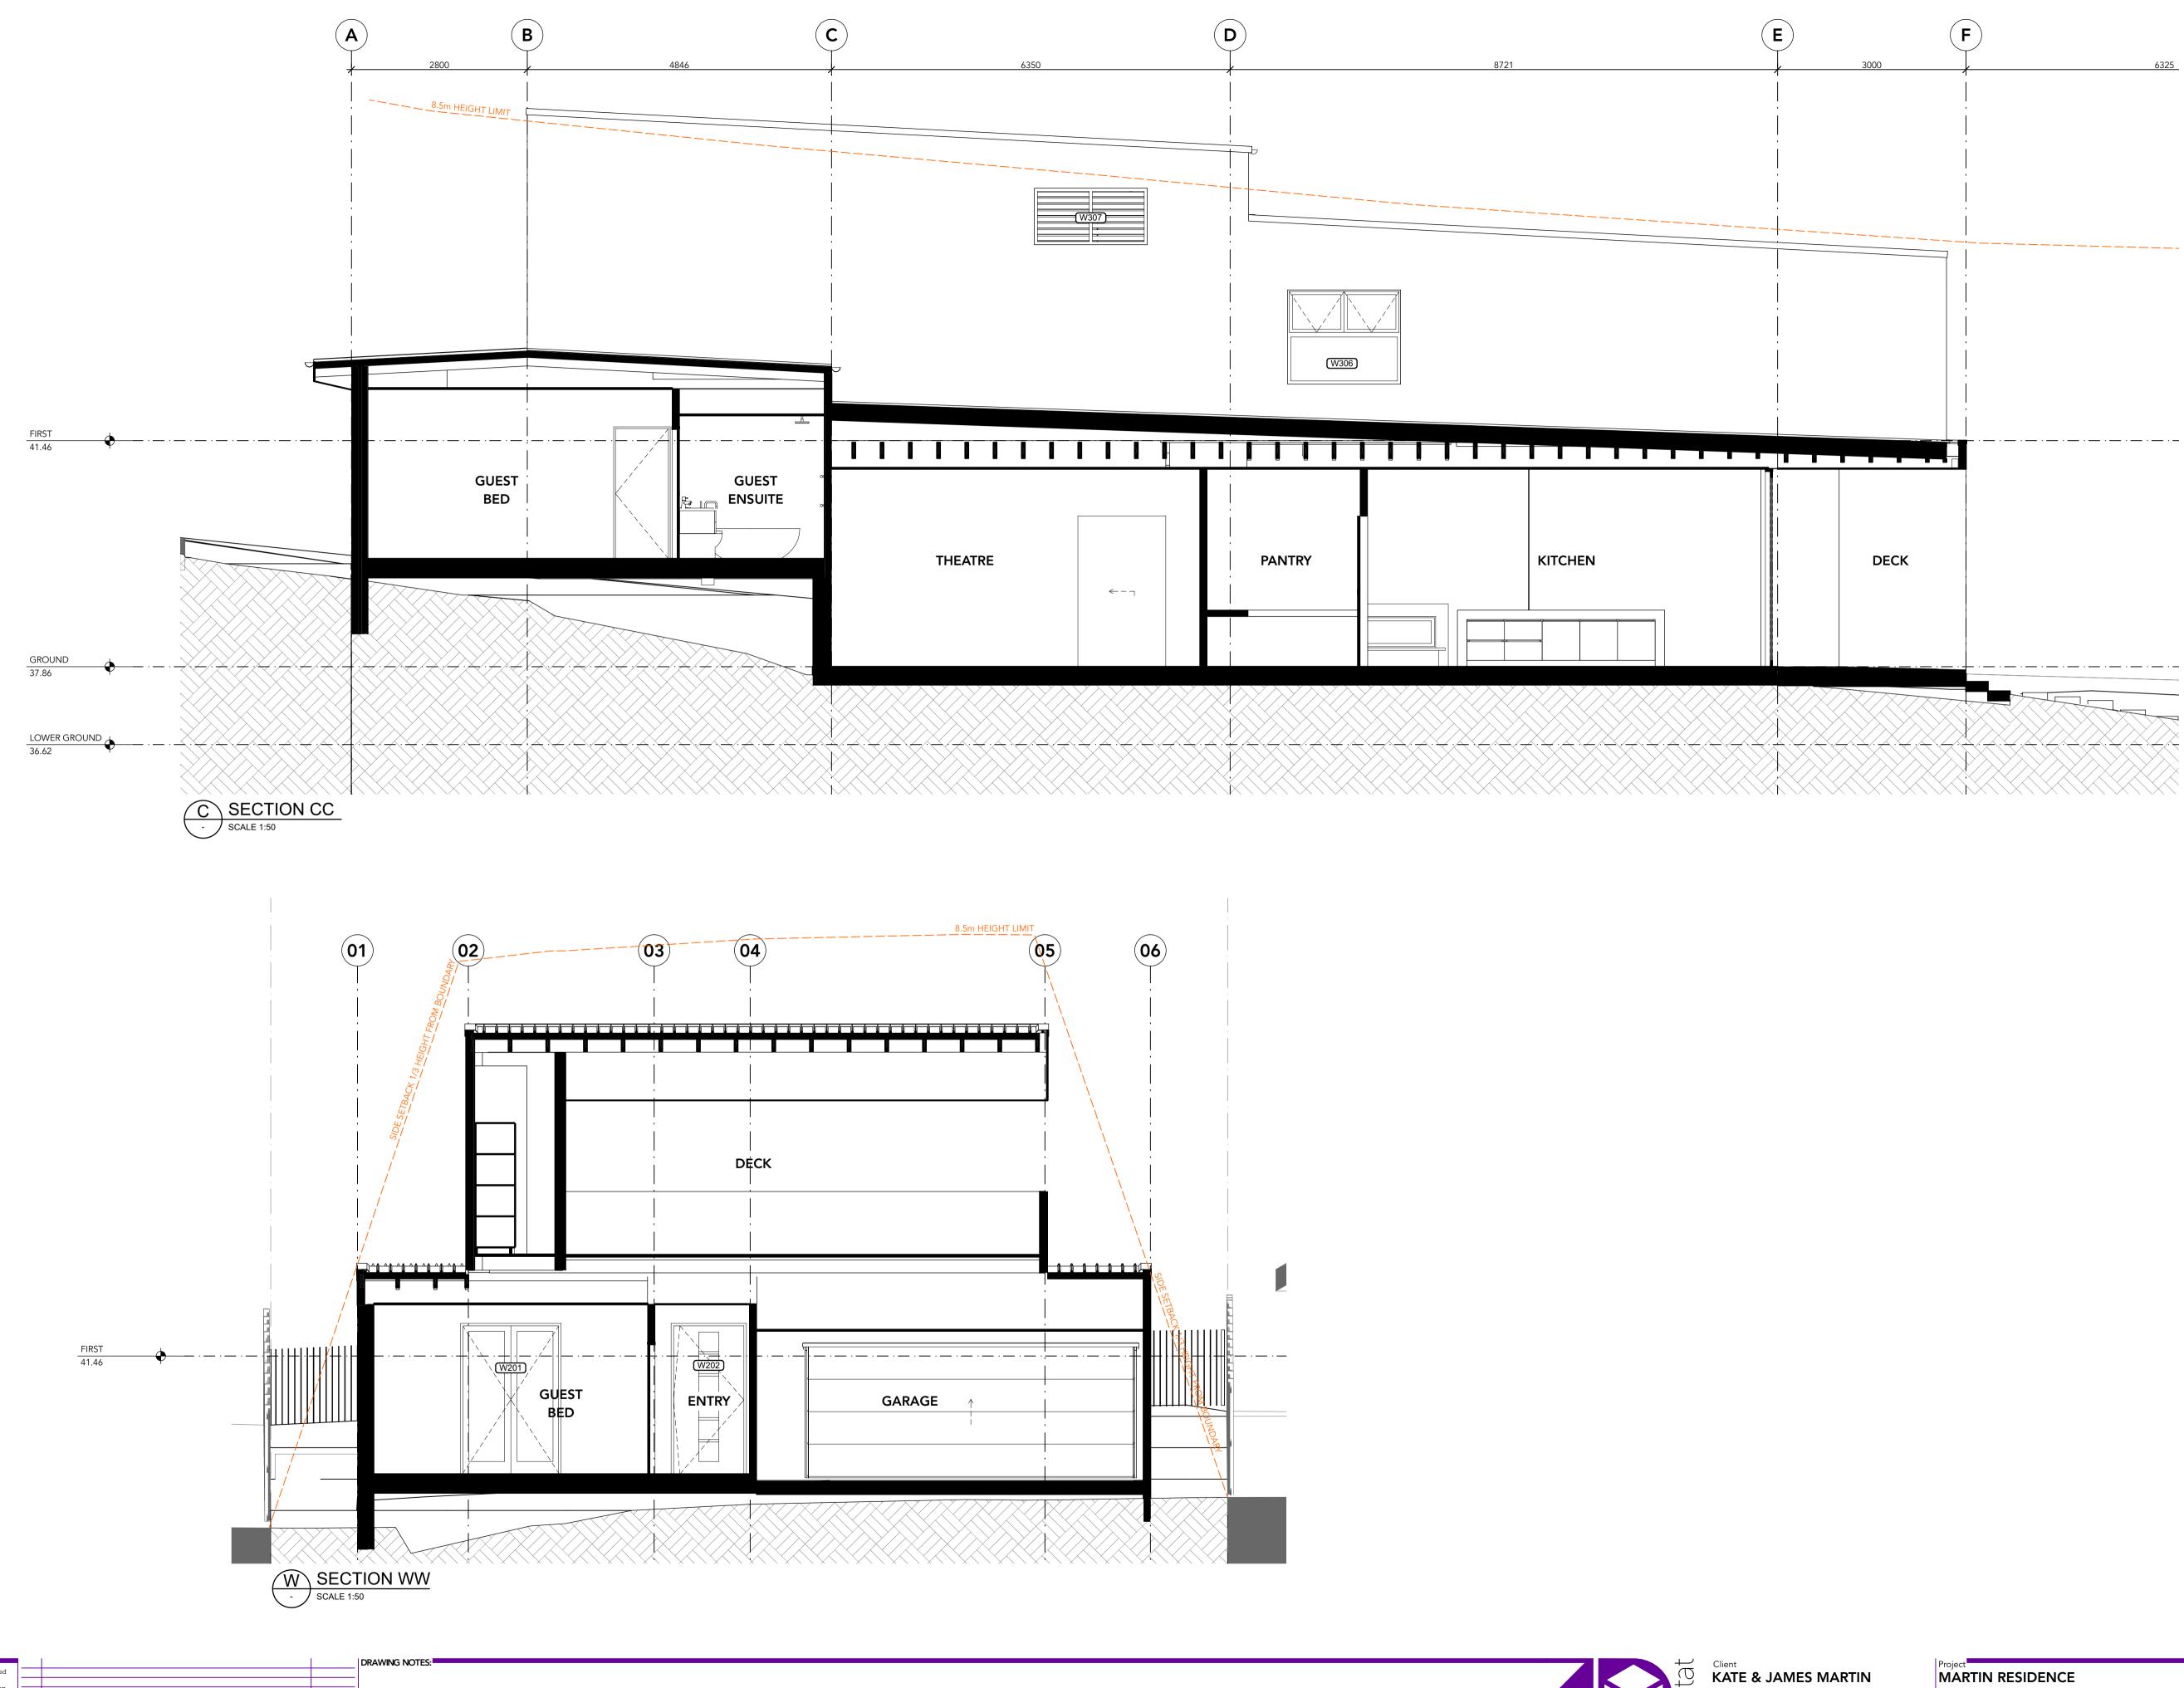Project MARTIN RESIDENCE 14 ERNEST STREET, BALGOWLAH HEIGHTS, NSW 2093 Status SKETCH DESIGN Drawing Title SECTIONS - SHEET 1 Scale 1:50 @A1





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POSSESSION OF A CC AND ALL OTHER	01	DEVELOPMENT APF
REQUIRED COUNCIL APPROVALS	Rev	Change Name

GENERAL NOTES:

PLICATION 03/12/21 Date



14 ERNEST STREET BALGOWLAH HEIGHTS, NSW 2093

14 ERNEST STREET, BALGOWLAH HEIGHTS, NSW 2093 Status SKETCH DESIGN Drawing Title SECTIONS - SHEET 2 <sup>Scale</sup> **1:50** @A1





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GENERAL NOTES:

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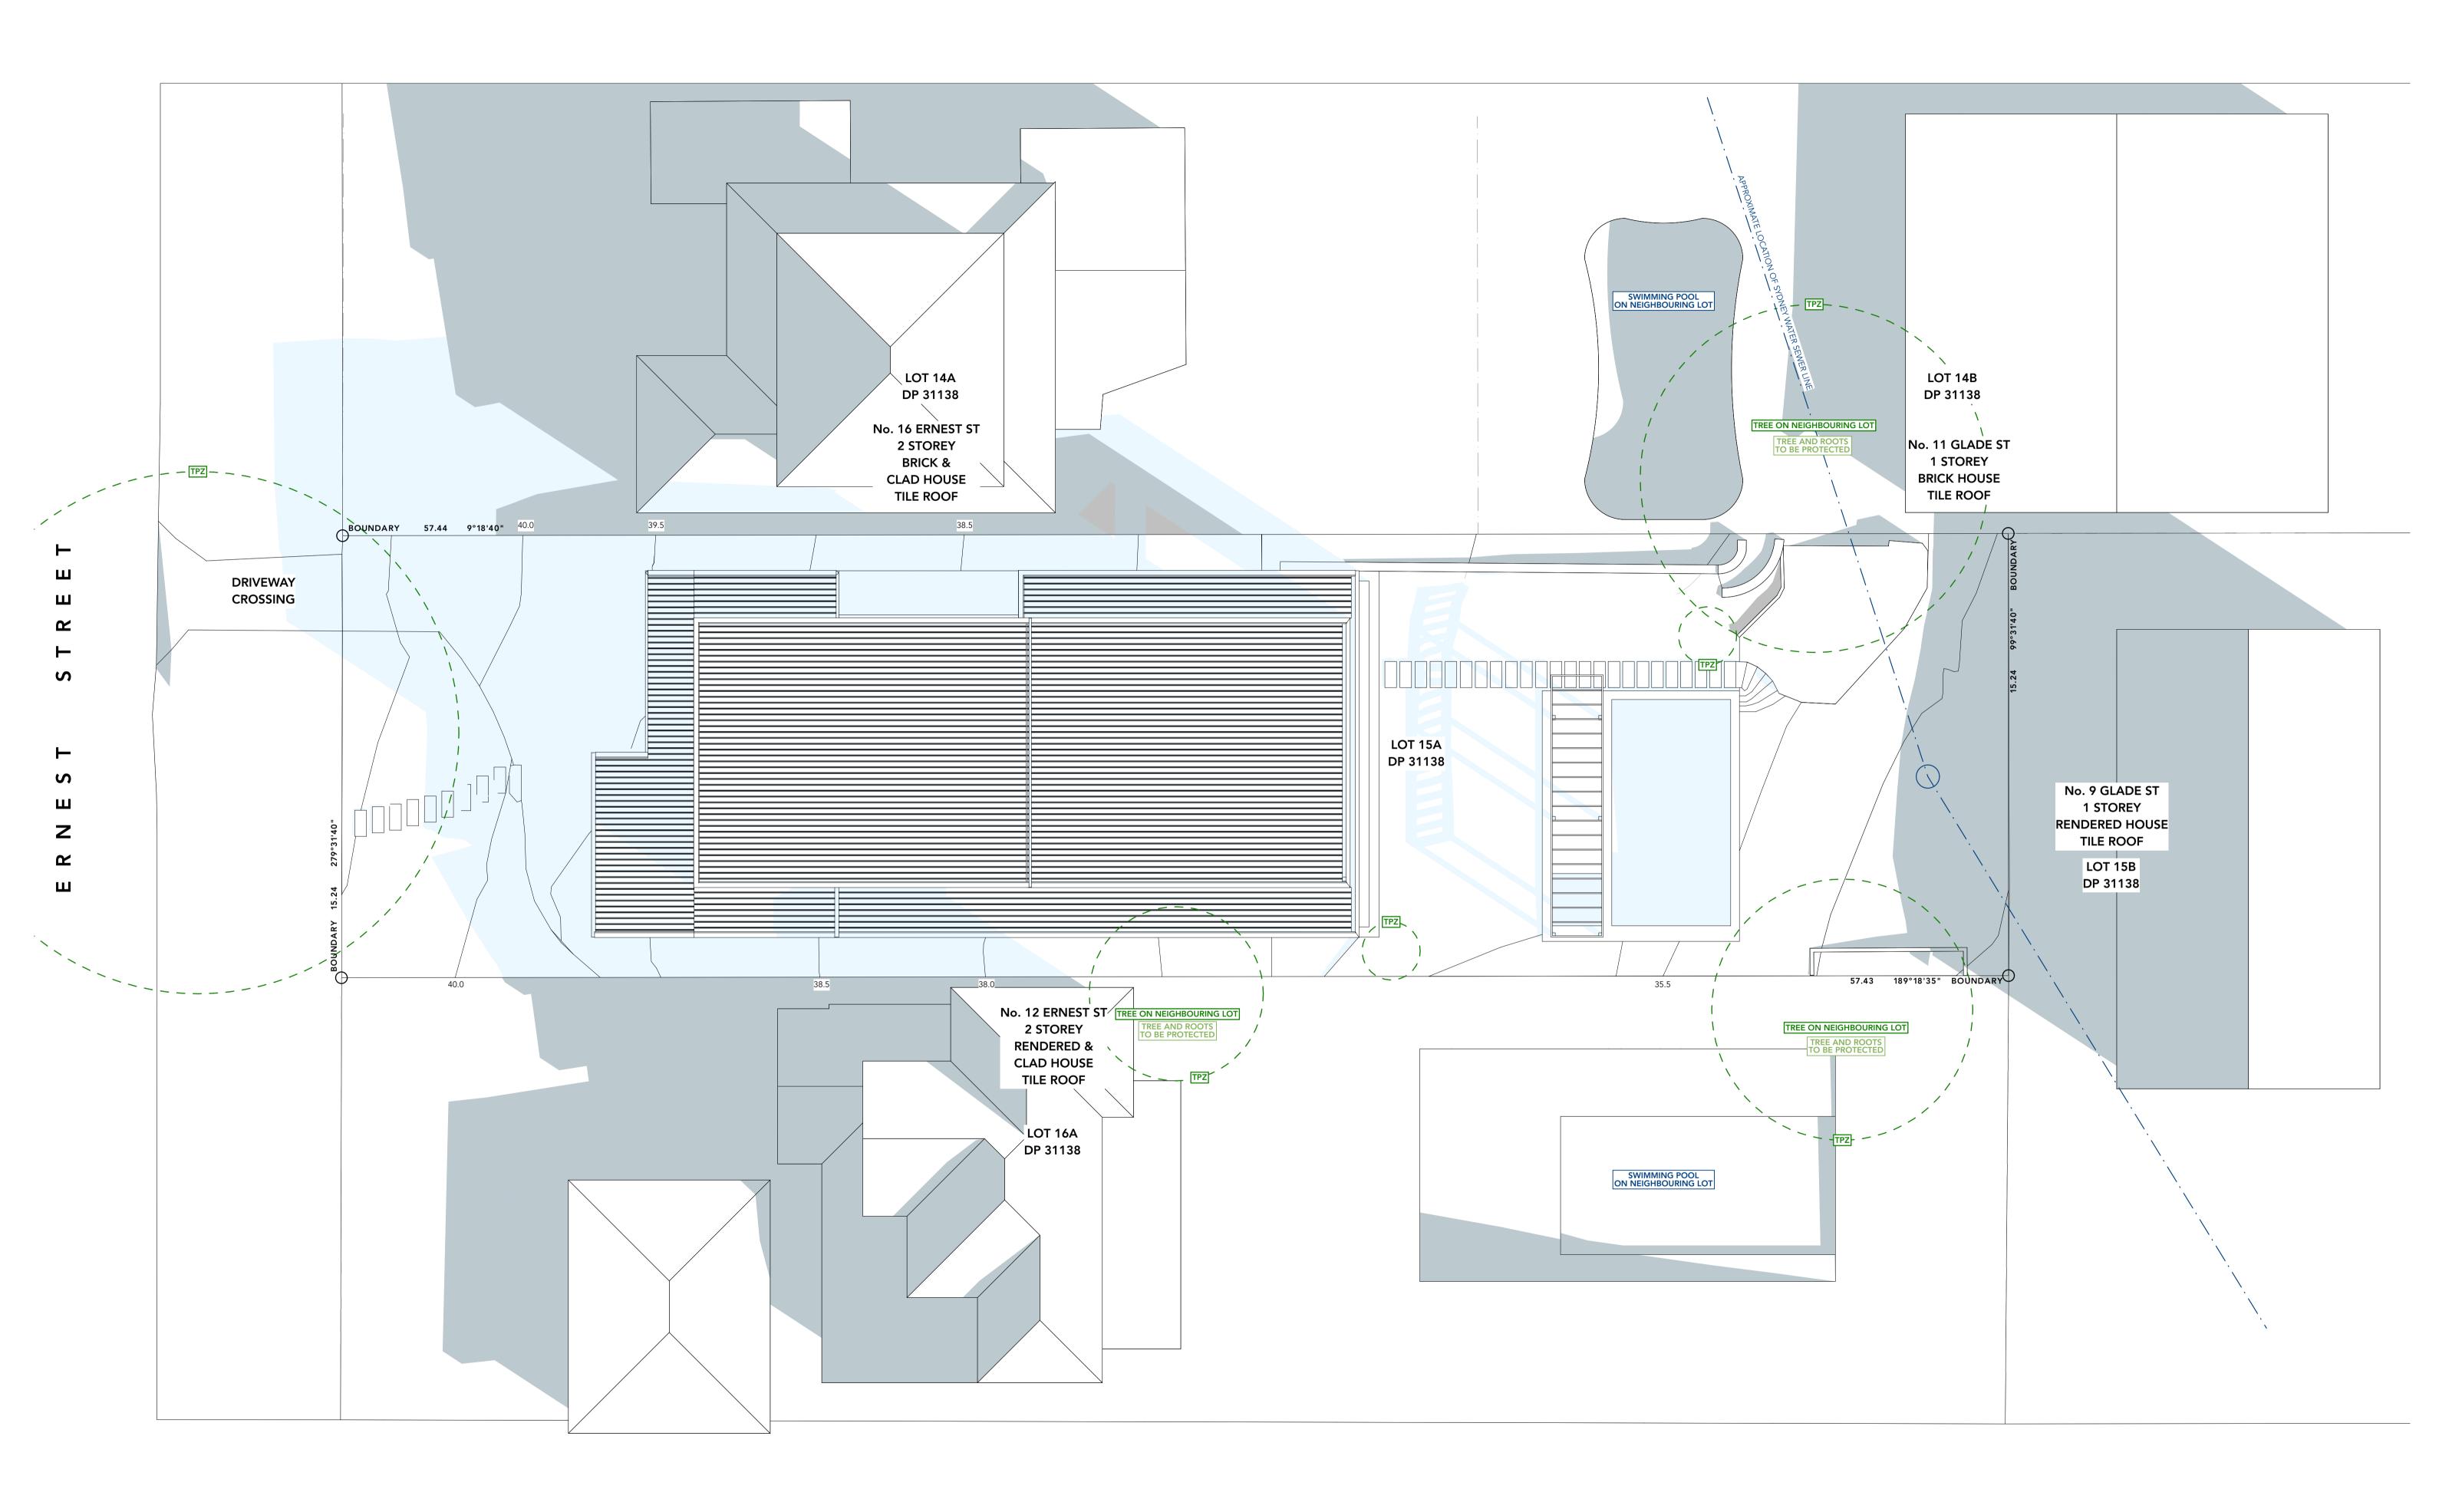
03/12/21 Date



Client KATE & JAMES MARTIN 14 ERNEST STREET BALGOWLAH HEIGHTS, NSW 2093

MARTIN RESIDENCE 14 ERNEST STREET, BALGOWLAH HEIGHTS, NSW 2093 Status SKETCH DESIGN Drawing Title **SECTIONS - SHEET 3** <sup>Scale</sup> **1:50** @A1





GENERAL NOTES:		DRAWIN	G NOTES:
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PRIOR TO USE FOR BUILDING CONSTRUCTION			
THE BUILDER MUST ENSURE THEY ARE IN			
POSSESSION OF A CC AND ALL OTHER	01 DEVELOPMENT APPLICATION	03/12/21	
REQUIRED COUNCIL APPROVALS	Rev Change Name	Date	NEW SHADOWS



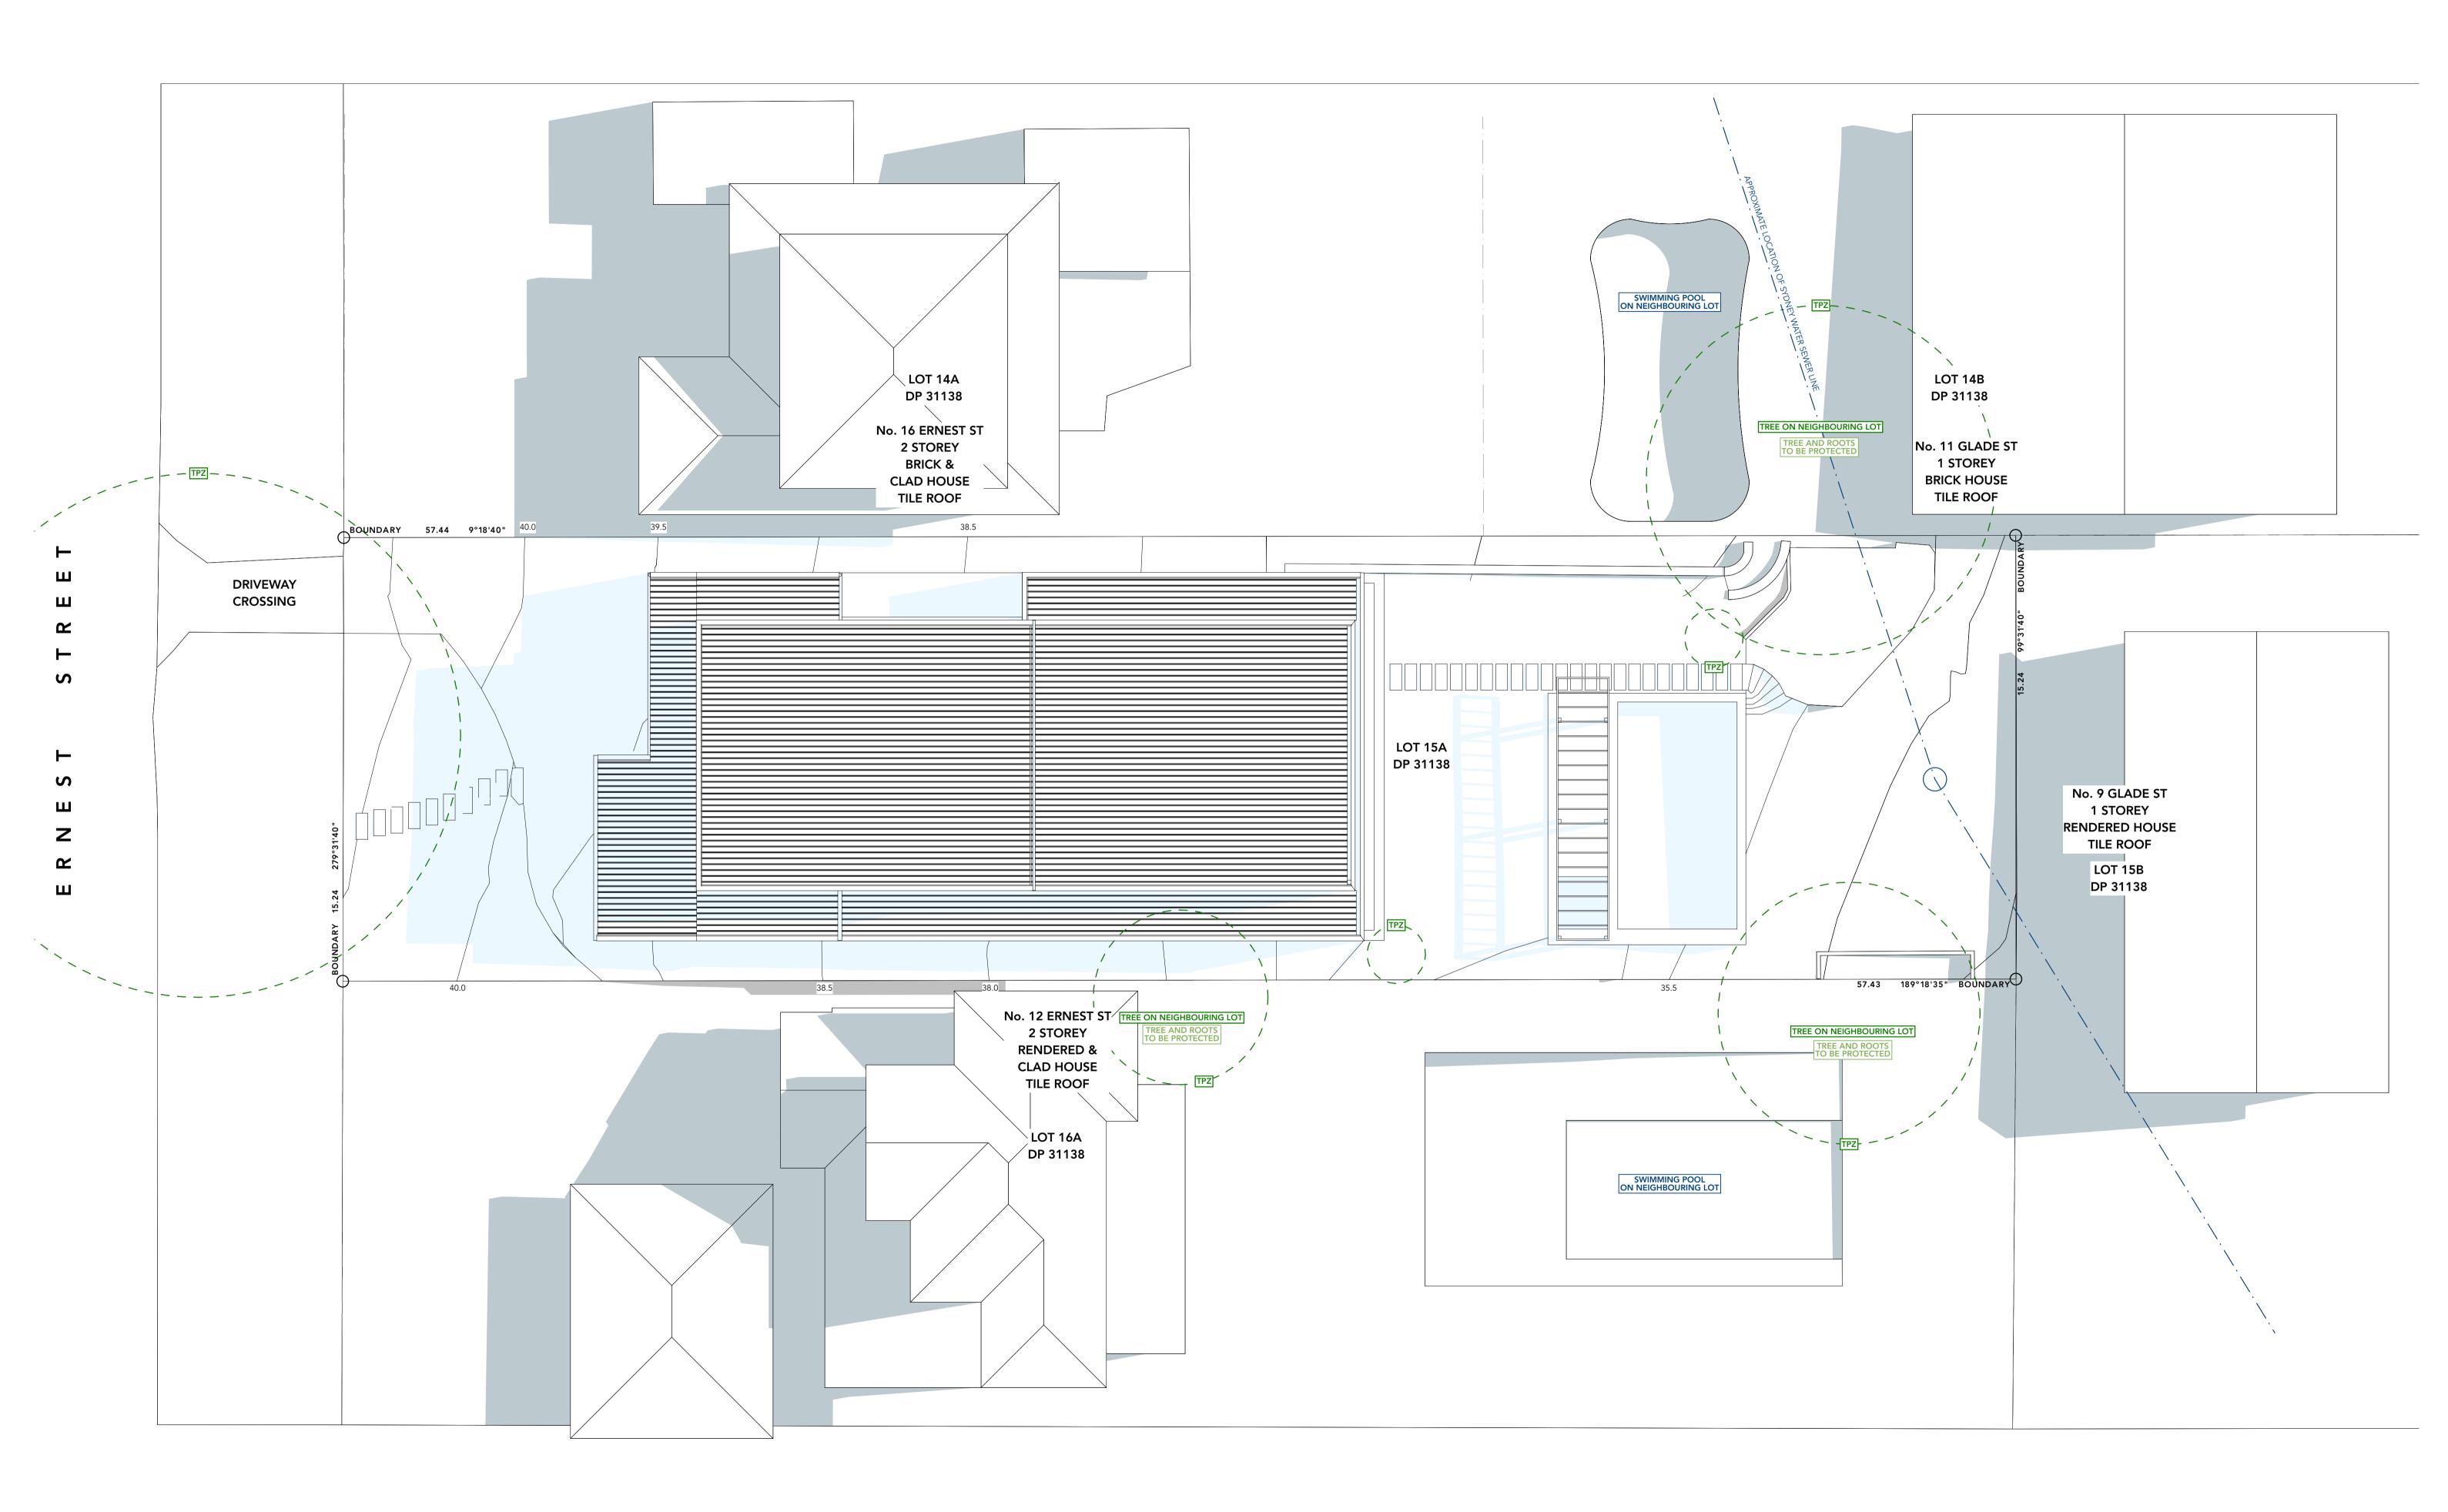
14 ERNEST STREET BALGOWLAH HEIGHTS, NSW 2093



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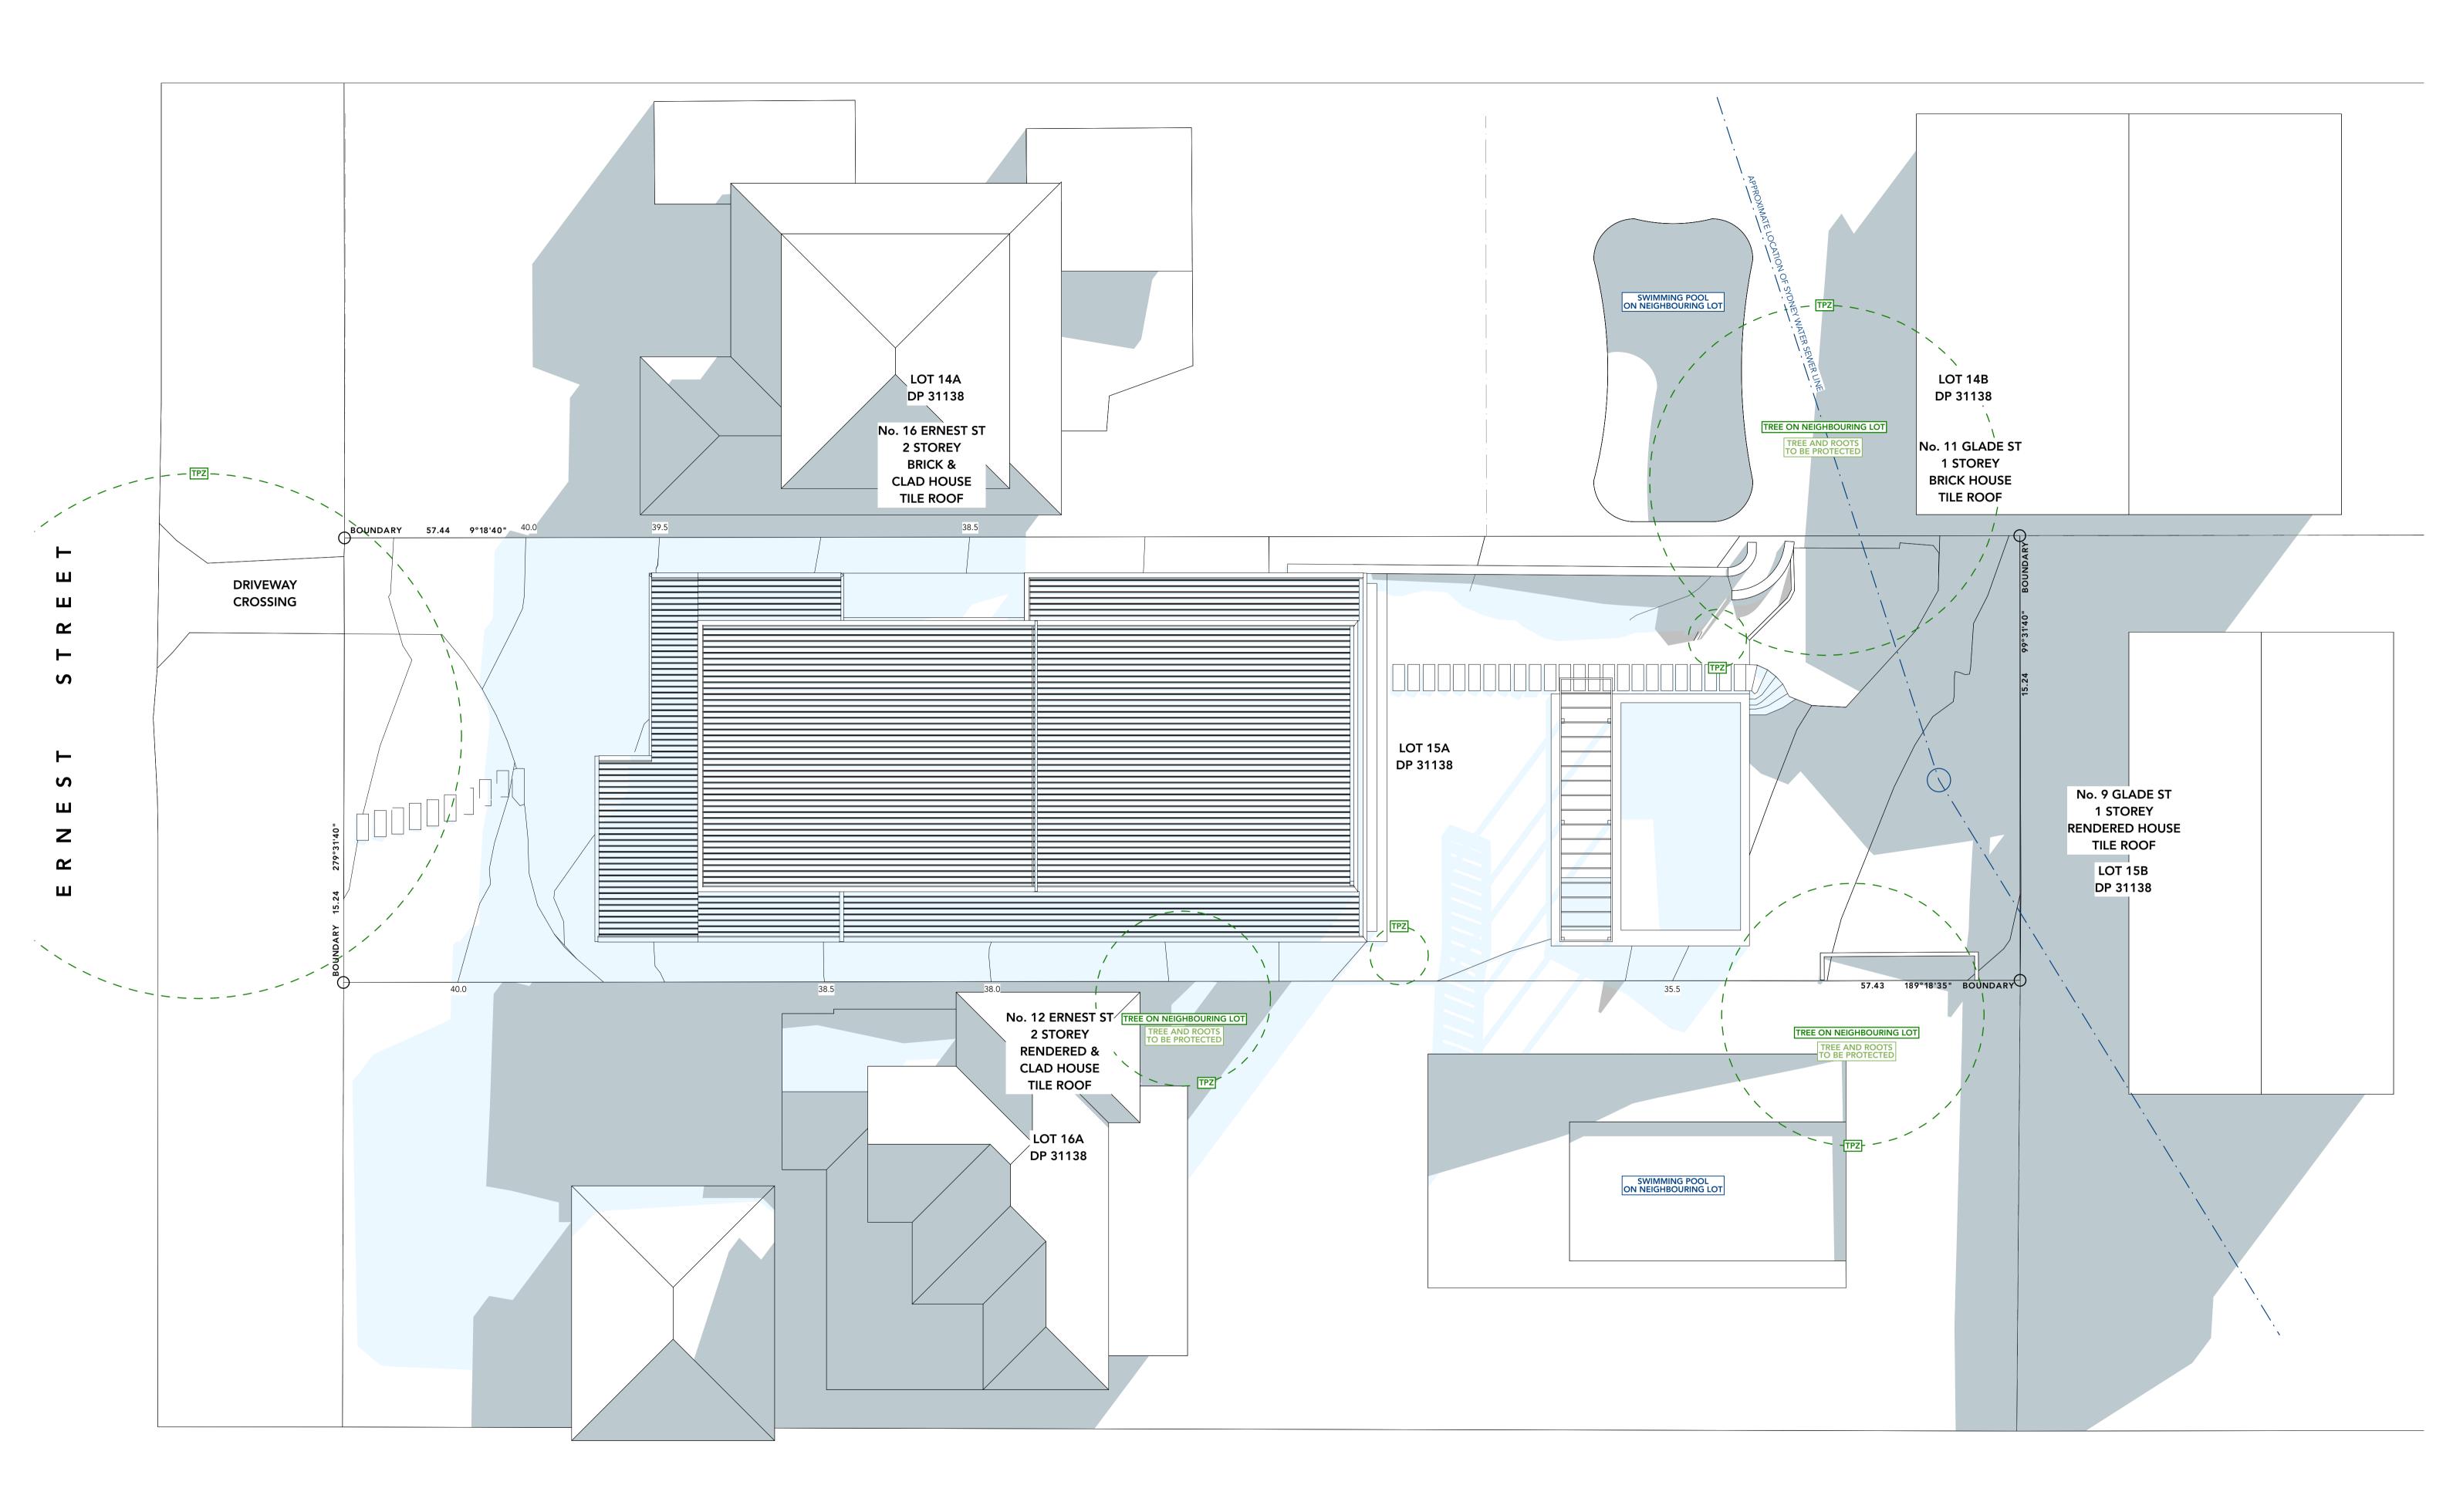




GENERAL NOTES:		DRA	AWING NOTES:
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dimensions only.			
For any discrepancies in documentation contact 3D			EXISTING SHADOWS REMOVED
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receipt of drawings issued in DWG or PDF format.			EXISTING SHADOWS REMAINING
PRIOR TO USE FOR BUILDING CONSTRUCTION			
THE BUILDER MUST ENSURE THEY ARE IN			
POSSESSION OF A CC AND ALL OTHER	01 DEVELOPMENT APPLICATION	03/12/21	
REQUIRED COUNCIL APPROVALS	Rev Change Name	Date	NEW SHADOWS







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receipt of drawings issued in DWG or PDF format.			EXISTING SHADOWS REMAINING
PRIOR TO USE FOR BUILDING CONSTRUCTION			
THE BUILDER MUST ENSURE THEY ARE IN POSSESSION OF A CC AND ALL OTHER	01 DEVELOPMENT APPLICATION	03/12/21	
REQUIRED COUNCIL APPROVALS	Rev Change Name	Date	NEW SHADOWS



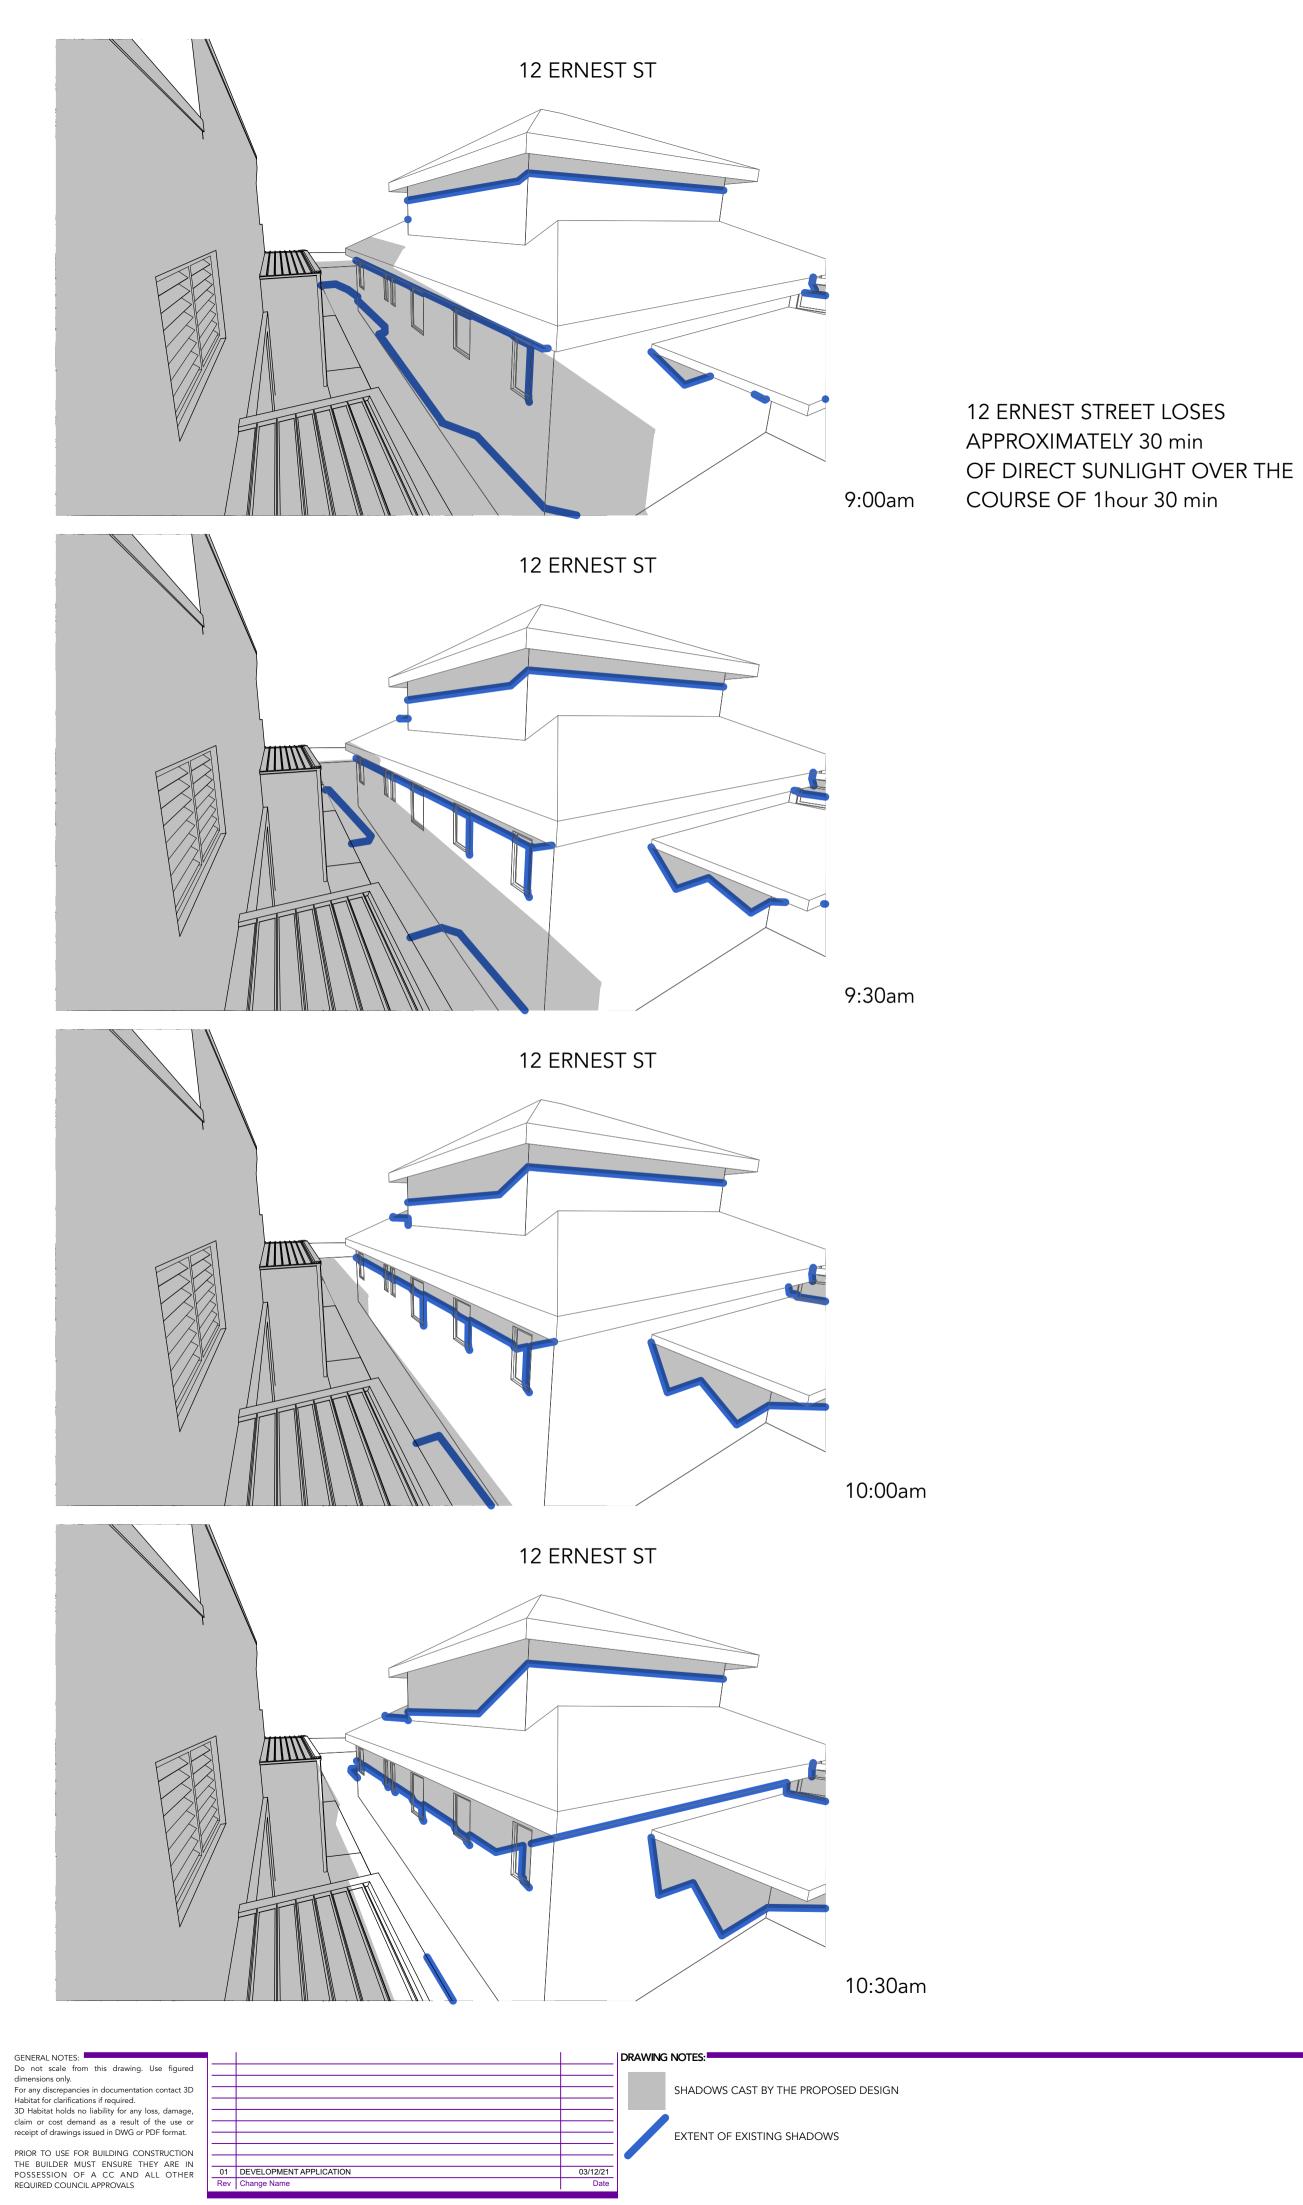
14 ERNEST STREET BALGOWLAH HEIGHTS, NSW 2093

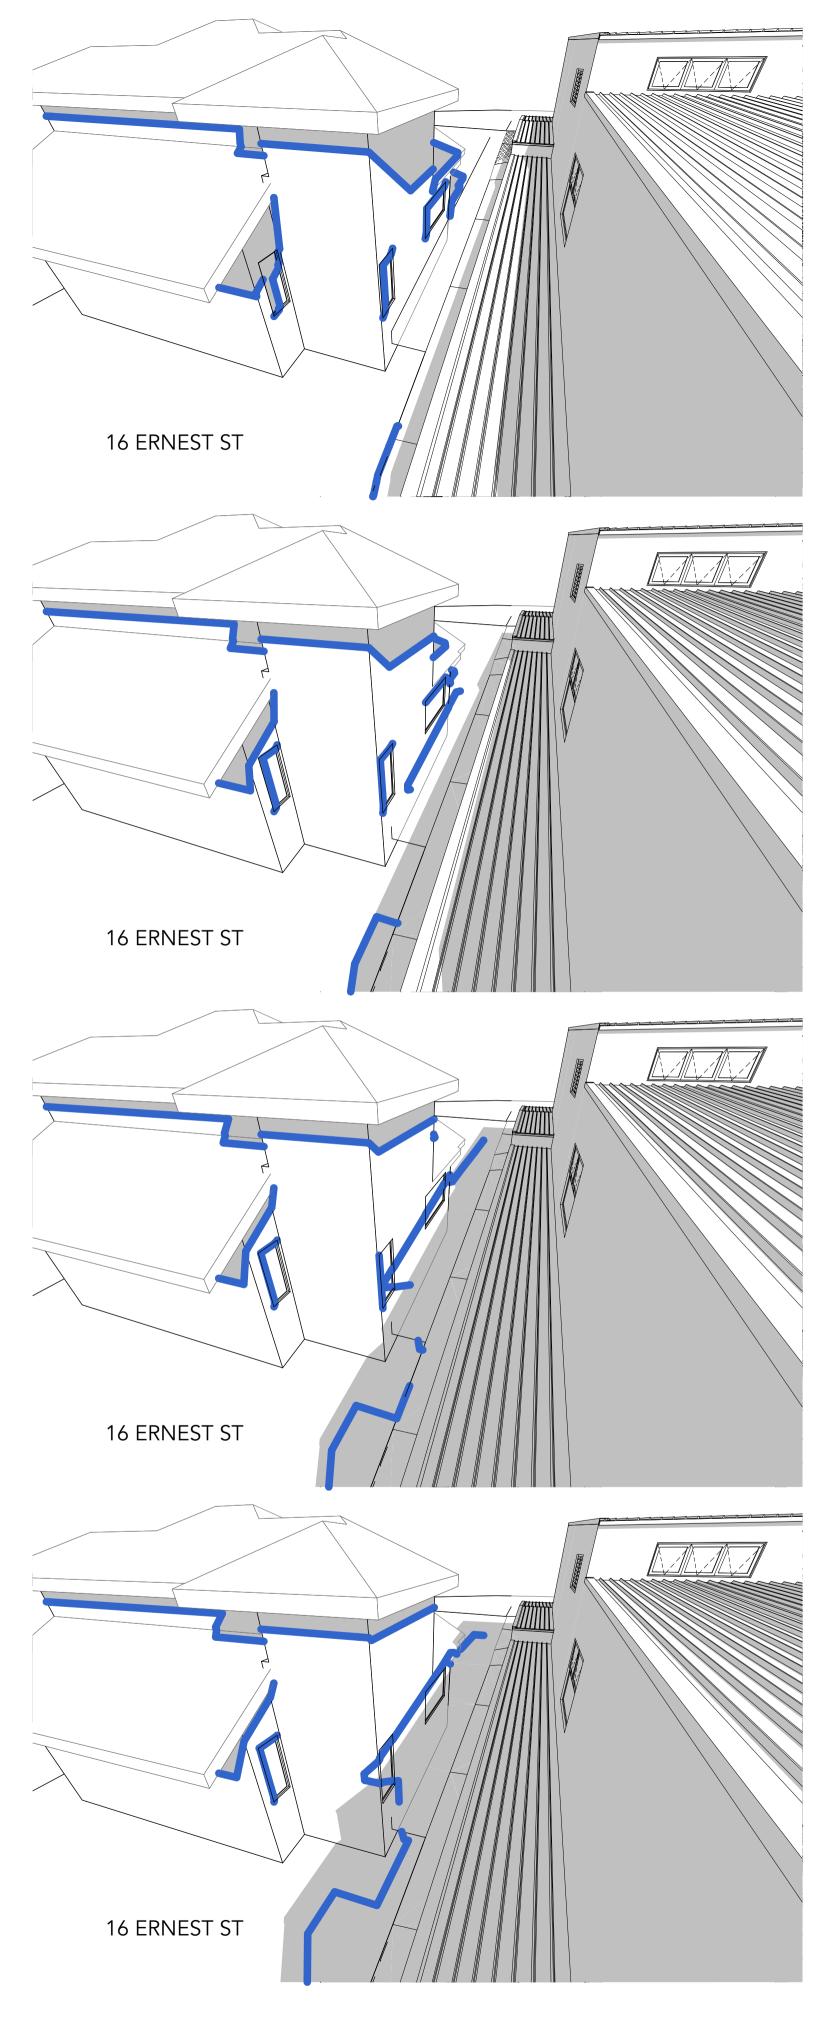


MARTIN RESIDENCE 14 ERNEST STREET, BALGOWLAH HEIGHTS, NSW 2093 Status SKETCH DESIGN Drawing Title

SUN SHADOW DIAGRAMS - SHEET 3 <sup>Scale</sup> 1:100 @A1









Client KATE & JAMES MARTIN 14 ERNEST STREET BALGOWLAH HEIGHTS, NSW 2093

# 16 ERNEST STREET GAINS 12:00pm ADDITIONAL SOLAR ACCESS

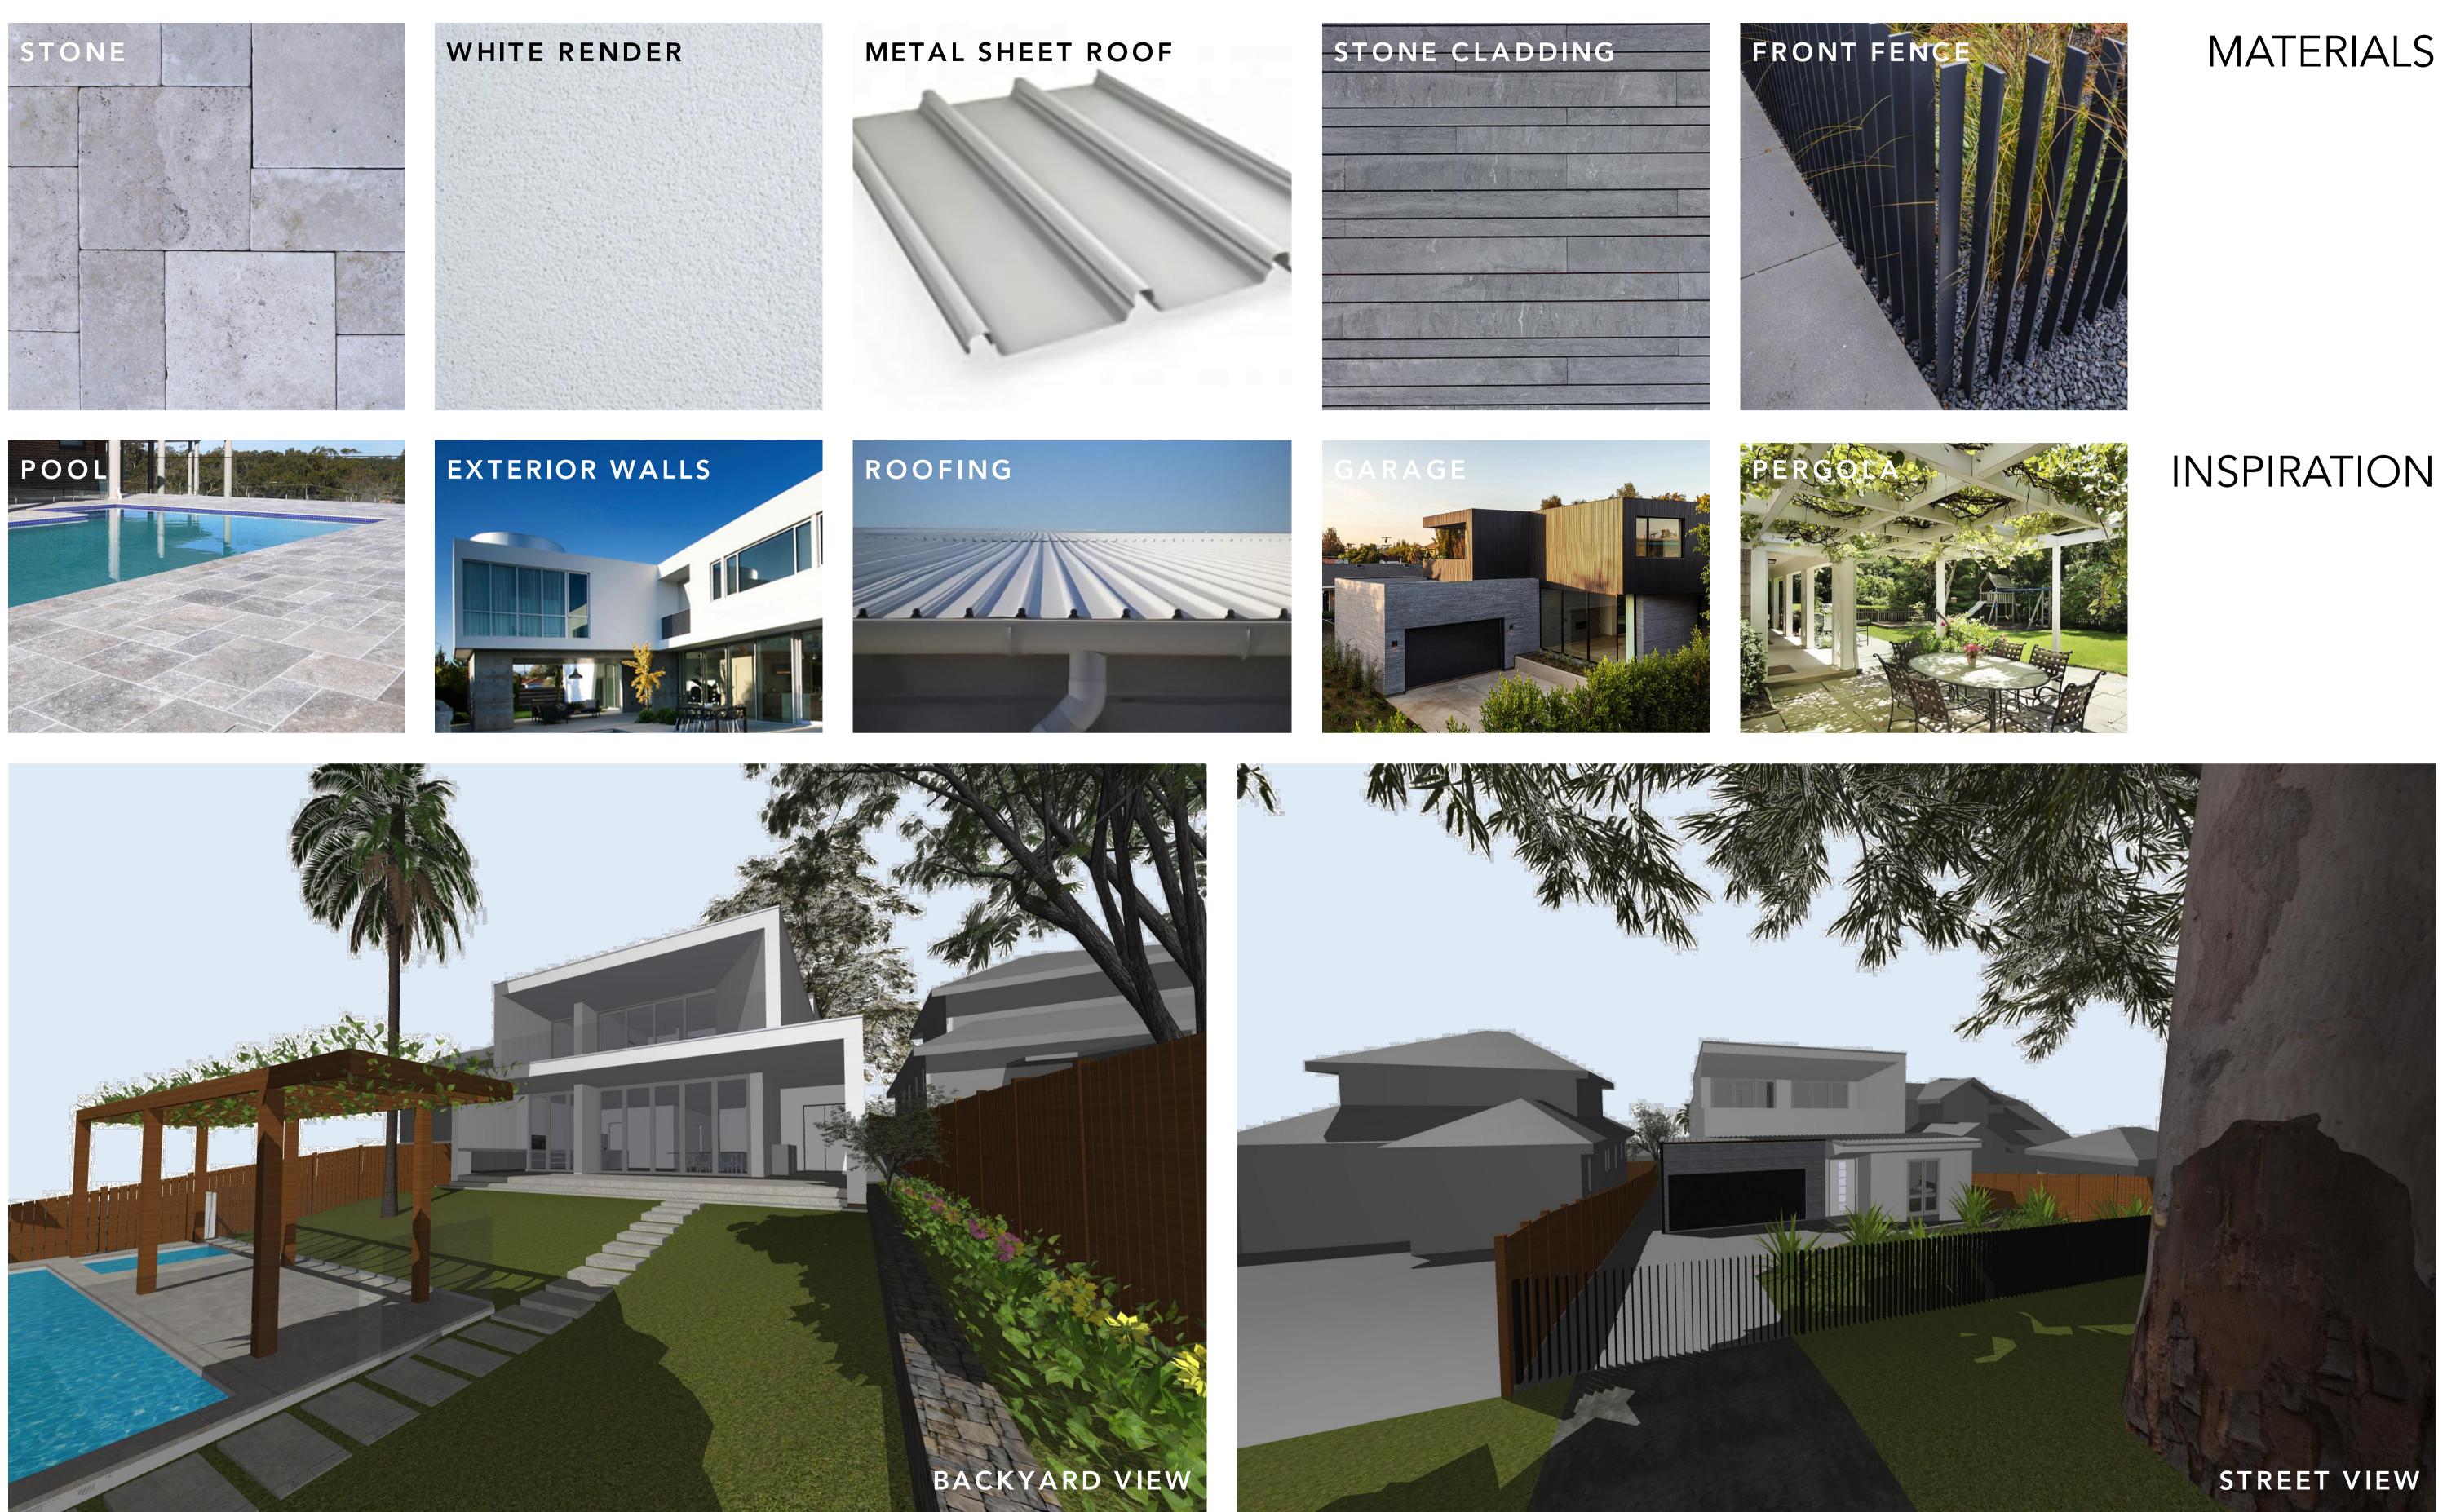
# 12:30pm

1:00pm

1:30pm

MARTIN RESIDENCE 14 ERNEST STREET, BALGOWLAH HEIGHTS, NSW 2093 Status SKETCH DESIGN Drawing Title SUN SHADOW DIAGRAM - NEIGHBOURS <sup>Scale</sup> @A1





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PRIOR TO USE FOR BUILDING CONSTRUCTION	
THE BUILDER MUST ENSURE THEY ARE IN	
POSSESSION OF A CC AND ALL OTHER	01 DEVELOPMENT APPLICATION
REQUIRED COUNCIL APPROVALS	Rev Change Name

DRAWING NOTES:		











Client KATE & JAMES MARTIN 14 ERNEST STREET BALGOWLAH HEIGHTS, NSW 2093





**BASIX**<sup>°</sup>Certificate

Building Sustainability Index www.basix.nsw.gov.au

Single Dwelling Certificate number: 1260066S

Secretarv

NSW | Planning, Industry & Environment

This certificate confirms that the proposed development will meet the NSW government's requirements for sustainability, if it is built in accordance with the commitments set out below. Terms used in this certificate, or in the commitments, have the meaning given by the document entitled "BASIX Definitions" dated 10/09/2020 published by the Department. This document is available at www.basix.nsw.gov.au

Date of issue: Friday, 03 December 2021 To be valid, this certificate must be lodged within 3 months of the date of issue.

2102_Martin
14 Ernest Street Balgowlah Heights 2093
Northern Beaches Council
deposited 31138
15A
-
separate dwelling house
4
V 45 Target 40
V Pass Target Pass
V 81 Target 50

Project address
Project name
Street address
Local Government Area
Plan type and plan number
Lot no.
Section no.
Project type
Project type
No. of bedrooms
Site details
Site area (m <sup>2</sup> )
Roof area (m <sup>2</sup> )
Conditioned floor area (m2)
Unconditioned floor area (n
Total area of garden and la

BASIX Planning, Industry & Environment www.basix.nsw.

page 1/10

page 4/10

Vater Commitments	Show on DA plans	Show on CC/CDC plans & specs	Certifier check
he swimming pool must have a pool cover.		~	
he swimming pool must be outdoors.	✓	~	
Dutdoor Spa	· · ·		
he spa must not have a volume greater than 3.7 kilolitres.	✓	~	
he spa must have a spa cover.		~	
he spa must be shaded.	~	~	

BASIX Planning, Industry & Environment www.basix.nsw.gov.au Version: 3.0 / DARWINIA\_3\_18\_5 Certificate No.: 1260066S Friday, 03 December 2021

Certificate Prepared by Name / Company Name: 3D Habitat ABN (if applicable): 22183198234

BASIX Planning, Industry & Environment www.basix.nsw.gov.au Version: 3.0 / DARWINIA\_3\_18\_5 Certificate No.: 1260066S Friday, 03 December 2021

Window/glazed door no.	Maximum height (mm)	Maximum width (mm)	Туре	Shading Device (Dimension within 10%)	Overshadowing
W402	600	1000	aluminium, single, clear	none	not overshadowed
W403	600	1800	aluminium, single, clear	none	not overshadowed
East facing					
W205	600	3400	aluminium, single, clear	none	>4 m high, 2-5 m away
W306	1500	1800	aluminium, single, clear	none	not overshadowed
W307	900	1800	aluminium, single, clear	none	not overshadowed
South facing				·	
W201	2400	1600	aluminium, single, clear	none	not overshadowed
W202	2400	1200	timber/UPVC/fibreglass, single, clear	none	not overshadowed
W301	2400	3000	aluminium, single, clear	eave 1800 mm, 0 mm above head of window or glazed door	not overshadowed
W302	2400	3000	aluminium, single, clear	eave 1800 mm, 0 mm above head of window or glazed door	not overshadowed
West facing					
W303	900	1800	aluminium, single, clear	none	not overshadowed
W302 West facing W303				window or glazed door	

Energy Commitments Hot water The applicant must install the following instantaneous with a performance of Cooling system The applicant must install the following ducting only; Energy rating: n/a The applicant must install the following ducting only; Energy rating: n/a Heating system The applicant must install the following heater; Energy rating: 5 Star The applicant must install the following ducting only; Energy rating: n/a Ventilation The applicant must install the following At least 1 Bathroom: individual fan, Kitchen: individual fan, ducted to fa Laundry: individual fan, ducted to fa Artificial lighting The applicant must ensure that the "p following rooms, and where the word light emitting diode (LED) lamps: at least 4 of the bedrooms / study at least 4 of the living / dining roo the kitchen; dedicated BASIX Planning, Industry & Environment www.basix.nsw.gov.au Version: 3.0 / DARWINIA\_3\_18\_5 Certificate No.: 1260066S Friday, 03 December 2021

BASIX	Planning, Industry & Environment	www.basix.nsw.gov.au	Version: 3.0 / DARWINIA_3_18_5	Certificate No.: 1260066S	Friday, 03 December 2021

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REQUIRED COUNCIL APPROVALS

01	DEVELOPMENT APPLICATION	03/12/21
Rev	Change Name	Date

RAWING NOTES:

In these commitments, "applicant" means the person carrying out the development. Commitments identified with a 🥥 in the "Show on DA plans" column must be shown on the plans accompanying the development application for the proposed development (if a development application is to be lodged for the proposed development). Commitments identified with a 🥪 in the "Show on CC/CDC plans and specs" column must be shown in the plans and specifications accompanying the application for a construction certificate / complying development certificate for the proposed development. Commitments identified with a 🥪 in the "Certifier check" column must be certified by a certifying authority as having been fulfilled, before a final occupation certificate(either interim or final) for the development may be issued.

page 7/10

# **Description of project**

	Assessor details and thermal	loads	
2102_Martin	Assessor number	n/a	
14 Ernest Street Balgowlah Heights 2093	Certificate number	n/a	
Northern Beaches Council	Climate zone	n/a	
Deposited Plan 31138	Area adjusted cooling load (MJ/m².year)	n/a	
15A	Area adjusted heating load (MJ/m <sup>2</sup> .year)	n/a	
-	Ceiling fan in at least one bedroom	n/a	
	Ceiling fan in at least one living room or other conditioned area	n/a	
separate dwelling house	Project score		
4	Project score		
	Water	45	Target 40
875	Thermal Comfort	V Pass	Target Pass
310		• • • • • • • • • • • • • • • • • • • •	raigett acc
260.0	Energy	<b>V</b> 81	Target 50
65.0			
325			

sw.gov.au	Version: 3.0 / DARWINIA_3_18_5	Certificate No.: 1260066S	Friday, 03 December 2021	page 2/10

General features         The dwelling must not have more than 2 storeys.       Image: Constraint open method welling must not exceed 300 square metres.         The conditioned floor area of the dwelling must not exceed 300 square metres.       Image: Constraint open method welling must not exceed 300 square metres.         The dwelling must not contain open method method area exceeding 25 square metres.       Image: Constraint open method welling must not exceed 300 square metres.	~
The conditioned floor area of the dwelling must not exceed 300 square metres.       Image: Conditional contain open mezzanine area exceeding 25 square metres.         The dwelling must not contain open mezzanine area exceeding 25 square metres.       Image: Conditional contain open mezzanine area exceeding 25 square metres.	- ×
The conditioned floor area of the dwelling must not exceed 300 square metres. The dwelling must not contain open mezzanine area exceeding 25 square metres.	- Č
The dwelling must not contain open mezzanine area exceeding 25 square metres.	✓
	<ul> <li>✓</li> </ul>
The dwelling must not contain third level habitable attic room.	~
Floor, walls and ceiling/roof	
The applicant must construct the floor(s), walls, and ceiling/roof of the dwelling in accordance with the specifications listed in the table below.	~
Construction Additional insulation required (R-Value) Other specifications	
floor - concrete slab on ground, 230 square metres nil	
floor - above habitable rooms or mezzanine, 95 square nil metres, framed	
metres, framed	
metres, framed	
metres, framed     inil       floor - suspended floor above garage, framed     nil	
metres, framed     nil       floor - suspended floor above garage, framed     nil       external wall - brick veneer     2.86 (or 3.40 including construction)       external wall - framed (weatherboard, fibre cement, metal)     3.00 (or 3.40 including construction)	

BASIX Planning, Industry & Environment www.basix.nsw.gov.au Version: 3.0 / DARWINIA\_3\_18\_5 Certificate No.: 1260066S Friday, 03 December 2021

	Show on DA plans	Show on CC/CDC plans & specs	Certifier check
wing hot water system in the development, or a system with a higher energy rating: gas of 5 stars.	~	~	~
wing cooling system, or a system with a higher energy rating, in at least 1 living area: airconditioning		<ul> <li></li> </ul>	~
wing cooling system, or a system with a higher energy rating, in at least 1 bedroom: airconditioning		~	~
wing heating system, or a system with a higher energy rating, in at least 1 living area: gas fixed flued		~	~
wing heating system, or a system with a higher energy rating, in at least 1 bedroom: airconditioning		~	~
wing exhaust systems in the development:			
n, ducted to façade or roof; Operation control: manual switch on/off		<b>_</b>	
façade or roof; Operation control: manual switch on/off			
façade or roof; Operation control: manual switch on/off		<b>v</b>	~
			1
e "primary type of artificial lighting" is fluorescent or light emitting diode (LED) lighting in each of the ord "dedicated" appears, the fittings for those lights must only be capable of accepting fluorescent or			
idy; dedicated			
		~	<b>~</b>
ooms; dedicated		~	~
		<b>~</b>	<ul> <li>Image: A set of the set of the</li></ul>

## Schedule of BASIX commitments

The commitments set out below regulate how the proposed development is to be carried out development certificate issued, for the proposed development, that BASIX commitments be

Water Commitments	Show on DA plans	Show on CC/CDC plans & specs	Certifie check
Landscape			
The applicant must plant indigenous or low water use species of vegetation throughout 250 square metres of the site.	~	<b>~</b>	
Fixtures			
The applicant must install showerheads with a minimum rating of 4 star (> 4.5 but <= 6 L/min plus spray force and/or coverage tests) in all showers in the development.		<b>~</b>	~
The applicant must install a toilet flushing system with a minimum rating of 5 star in each toilet in the development.		<b>~</b>	~
The applicant must install taps with a minimum rating of 5 star in the kitchen in the development.		<ul> <li>Image: A set of the set of the</li></ul>	
The applicant must install basin taps with a minimum rating of 5 star in each bathroom in the development.		<ul> <li>Image: A second s</li></ul>	
Alternative water			
Rainwater tank			
The applicant must install a rainwater tank of at least 10000 litres on the site. This rainwater tank must meet, and be installed in accordance with, the requirements of all applicable regulatory authorities.	~	<b>~</b>	~
The applicant must configure the rainwater tank to collect rain runoff from at least 300 square metres of the roof area of the development (excluding the area of the roof which drains to any stormwater tank or private dam).		<ul> <li></li> </ul>	~
The applicant must connect the rainwater tank to:			
all toilets in the development		<ul> <li>Image: A set of the set of the</li></ul>	~
<ul> <li>at least one outdoor tap in the development (Note: NSW Health does not recommend that rainwater be used for human consumption in areas with potable water supply.)</li> </ul>		<ul> <li>Image: A set of the set of the</li></ul>	~
Swimming pool			
The swimming pool must not have a volume greater than 48 kilolitres.	~	<ul> <li>Image: A set of the set of the</li></ul>	

Thermal Comfort Commitments						Show on CC/CDC plans & specs	Certifier check
Windows, glazed doo	ors and skylights						
			evices described in the table belo ons must be satisfied for each wi		~	<ul> <li></li> </ul>	~
he dwelling may have 1 skylight (<0.7 square metres) which is not listed in the table.					~	<ul> <li>Image: A set of the set of the</li></ul>	~
<ul><li>The following requirements must also be satisfied in relation to each window and glazed door:</li><li>For the following glass and frame types, the certifier check can be performed by visual inspection.</li></ul>					~	~	~
<ul> <li>For the following glass a</li> <li>Aluminium single cle</li> <li>Aluminium double (a)</li> </ul>	ar	ertifier check can be	e performed by visual inspection.				<b>~</b>
- Timber/uPVC/fibregl - Timber/uPVC/fibregl	0						
<ul> <li>Overshadowing building door, as specified in th</li> </ul>			stance from the centre and the b	ease of the window and glazed			
					•	•	•
Window/glazed door no.	Maximum height (mm)	Maximum width (mm)	Туре	Shading Device (Dimens 10%)	sion within	Overshadowing	
			Туре		sion within	Overshadowing	
Window/glazed door no. North facing W203			Type aluminium, single, clear		0 mm	Overshadowing not overshadowed	•
North facing	height (mm)	(mm)		10%) solid overhang 3000 mm, above head of window or	0 mm glazed 0 mm		
North facing W203	height (mm)	(mm) 6430	aluminium, single, clear	10%)         solid overhang 3000 mm, above head of window or door         solid overhang 3000 mm, above head of window or	0 mm glazed 0 mm glazed 0 mm	not overshadowed	
North facing W203 W204	height (mm)           3150           3150	(mm) 6430 2995	aluminium, single, clear aluminium, single, clear	10%)         solid overhang 3000 mm, above head of window or door         solid overhang 3000 mm, above head of window or door         solid overhang 3000 mm, above head of window or above head of window or	0 mm glazed 0 mm glazed 0 mm glazed 0 mm	not overshadowed	

page 5/10

page 8/10

Thermal Comfort Commitments						Show on CC/CDC plans & specs	Certifier check
Windows, glazed doo	ors and skyligh	ts					
The applicant must install the specifications listed in the table to the table to the table to the table table table to the table ta	ne windows, glazed able. Relevant over	doors and shading de shadowing specification	evices described in the table below ons must be satisfied for each win	v, in accordance with the dow and glazed door.	~	~	~
The dwelling may have 1 skylight (<0.7 square metres) which is not listed in the table.					~	<ul> <li>Image: A set of the set of the</li></ul>	~
The following requirements must also be satisfied in relation to each window and glazed door:					~	<ul> <li></li> </ul>	~
• For the following glass and frame types, the certifier check can be performed by visual inspection.							~
- Aluminium single cle	ar						
- Aluminium double (a	iir) clear						
- Timber/uPVC/fibreg	ass single clear						
- Timber/uPVC/fibreg	ass double (air) cle	ar					
			stance from the centre and the ba	se of the window and glazed			
door, as specified in th		column.			•	•	•
Window/glazed door no.	Maximum height (mm)	Maximum width (mm)	Туре	Shading Device (Dimens 10%)	sion within	Overshadowing	
North facing							_
North facing W203	3150	6430	aluminium, single, clear	solid overhang 3000 mm, above head of window or door		not overshadowed	
	3150 3150	6430 2995	aluminium, single, clear aluminium, single, clear	above head of window or	glazed 0 mm	not overshadowed	
W203				above head of window or door solid overhang 3000 mm, above head of window or	glazed 0 mm glazed 0 mm		
W203	3150	2995	aluminium, single, clear	above head of window or door solid overhang 3000 mm, above head of window or door solid overhang 3000 mm, above head of window or	glazed 0 mm glazed 0 mm glazed 0 mm	not overshadowed	

Energy Commitments	Show on DA plans	Show on CC/CDC plans & specs	Certifier check
all bathrooms/toilets; dedicated		~	~
the laundry; dedicated			
all hallways; dedicated		<u> </u>	
Natural lighting			
The applicant must install a window and/or skylight in the kitchen of the dwelling for natural lighting.	~	~	~
The applicant must install a window and/or skylight in 2 bathroom(s)/toilet(s) in the development for natural lighting.	~	<ul> <li>Image: A set of the set of the</li></ul>	~
Swimming pool			
The applicant must install the following heating system for the swimming pool in the development (or alternatively must not install any heating system for the swimming pool): solar (gas boosted)		~	
The applicant must install a timer for the swimming pool pump in the development.		<b>~</b>	
Outdoor spa			
The applicant must install the following heating system for the spa in the development (or alternatively must not install any heating system for the spa): solar (gas boosted)		~	
The applicant must install a timer for the spa pump in the development.		<ul> <li>Image: A set of the set of the</li></ul>	
Alternative energy			
The applicant must install a photovoltaic system with the capacity to generate at least 5 peak kilowatts of electricity as part of the development. The applicant must connect this system to the development's electrical system.	~	<b>~</b>	~
Other			
The applicant must install an induction cooktop & electric oven in the kitchen of the dwelling.		<b>~</b>	
The applicant must construct each refrigerator space in the development so that it is "well ventilated", as defined in the BASIX definitions.		<ul> <li></li> </ul>	
The applicant must install a fixed outdoor clothes drying line as part of the development.			



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but. It is a condition of any developm be complied with.	nent consent	t granted, or complyin	g



MARTIN RESIDENCE 14 ERNEST STREET, BALGOWLAH HEIGHTS, NSW 2093 Status SKETCH DESIGN Drawing Title BASIX COMMITMENTS Scale @A1

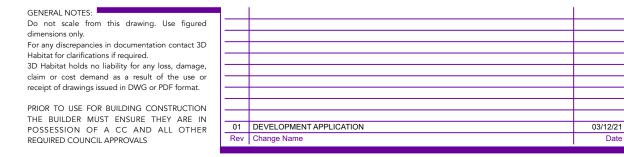









3D BUILDING CONTROLS NORTH EAST



DRAWING NOTES:

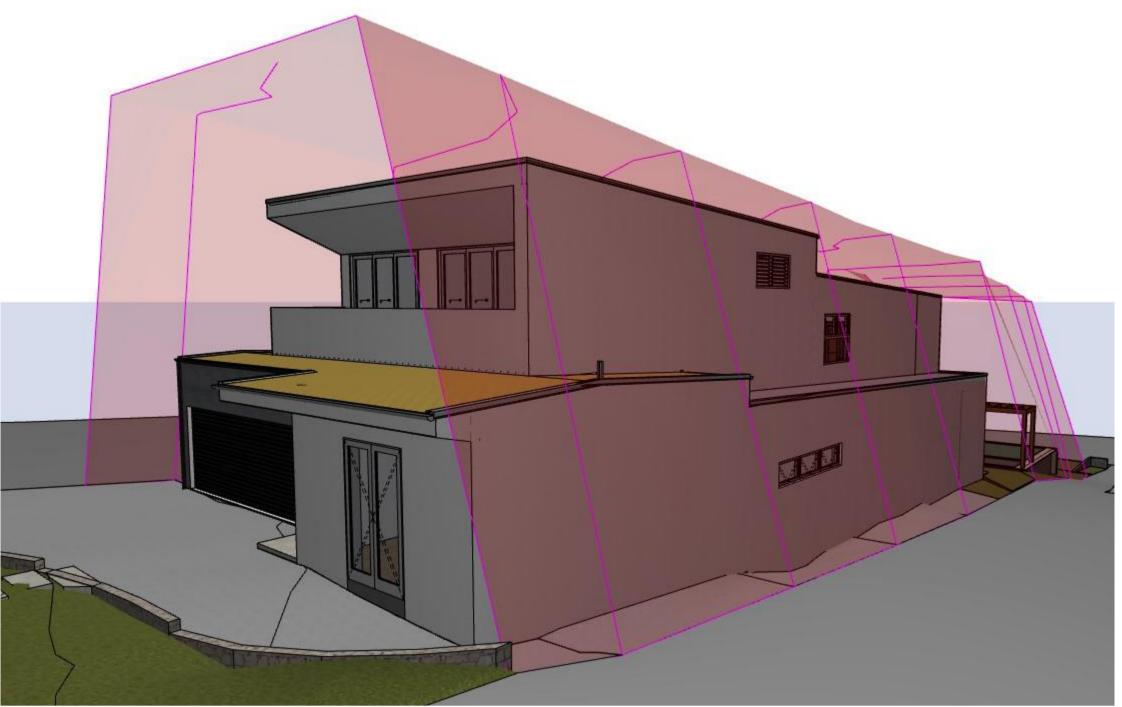



3D BUILDING CONTROLS SOUTH EAST



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Project MARTIN RESIDENCE

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Drawing Title NOTIFICATION

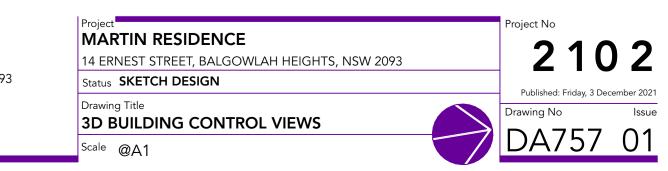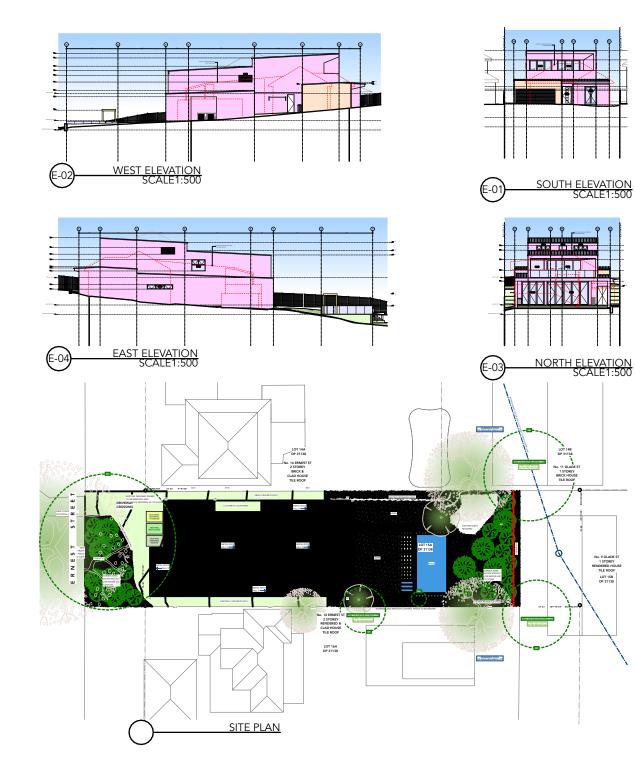