NICK KARAHALIOS - ARCHITECTURAL DRAFTING SERVICES

513 Bourke Street, Surry Hills, NSW 2010 - Email: nick@nkdrafting.com.au - Telephone: (02) 9360 5121 - Mobile: 0407 360512

PROPOSED ALTERATIONS AND ADDITIONS TO THE EXISTING DWELLING 52 INNES ROAD, MANLY VALE

DRAWING SCHEDULE

SHEET 01 - SITE PLAN AND SITE ANALYSIS PLAN

SHEET 02 - EXISTING PLAN GROUND AND FIRST FLOOR

SHEET 03 - DEMOLITION PLAN GROUND AND FIRST FLOOR FLOOR

SHEET 04 - PROPOSED PLAN GROUND AND FIRST FLOOR

SHEET 05 - SECTION A-A AND EAST ELEVATION

SHEET 06 - WEST, SOUTH, NORTH ELEVATIONS

SHEET 07 - LANDSCAPE AREA AND OPEN SPACE PLAN

SHEET 08 - EROSION AND SEDIMENT CONTROL PLAN SHEET 09 - ROOF AND STORMWATER PLAN

SHEET 10 - BASIX COMMITMENTS

DEVELOPMENT APPLICATION PLAN JUNE 2021




LOCATION PLAN

EXISTING ROOF TILES TO BE REMOVED AND REPLACED WITH NEW CORRUGATED COLORBOND METAL ROOF ROOF GUTTER AND DOWNPIPES INDICATES EXISTING FIRST FLOOR WINDOWS TO BE REPLACED TO BE UPGRADED INDICATES EXISTING GROUND FLOOR WINDOWS TO BE REPLACED 5200 LOT 12 DP 10207 EXISTING PROPOSED DECK 40.235 Δ K 0 α * TWO STOREY F/C CLAD HOUSE No.52 LOT 13 DP 10207 490.4m² S Ш Z Z BM NAIL IN KERB RL 19.03 A.H.D 40.235 TWO STOREY RENDERED HOUSE No.54


SITE PLAN AND SITE ANALYSIS PLAN SCALE 1: 200



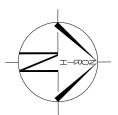

SCALE 1:200 @ A3								
	1:200 (1:200 @ A3						

AMEN	NDMENTS:	PROJECT:		FOR:	TTL 4 COL O4	1DE C111DC	NUDATE	PREPARED BY:	
	DESCRIPTION		PROPOSED ALTERATIONS AND ADDITIONS	^	EIL & COLON	MBE CAMBO		NICK KARAHALIOS ARCHITECTURAL DRAFTING SERVICES 513 BOURKE STREET, SURRY HILLS 2010 MOBILE - 0407 360512 EMAIL - nick@nkdrafting.com.au	
A	DEVELOPMENT APPLICATION		TO THE EXISTING DWELLING	DATE	DRAWN BY	JOB No.	SHEET No.		
		LOCATION:	52 INNES ROAD, MANLY VALE	JUNE 2021	NICK. K	211699		NOTE: THIS DRAWING IS THE COPYRIGHT OF NICK KARAHALIOS ARCHITECTURAL DRAFTING SERVICES AND SHALL NOT BE REPRODUCED IN PART OR WHOLE WITHOUT THEIR WRITTEN APPROVAL	

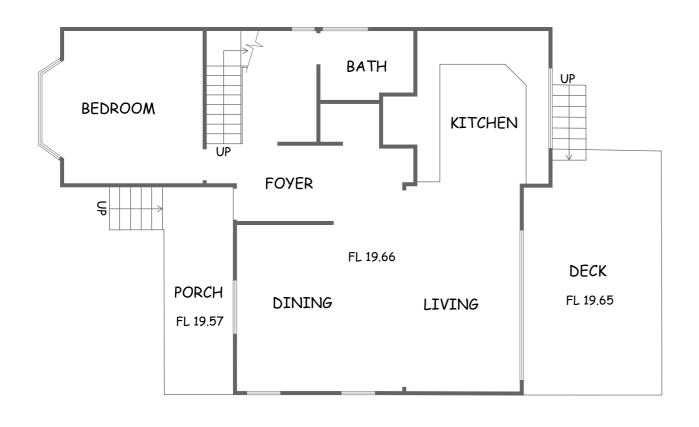




EXISTING GROUND FLOOR PLAN

SCALE 1: 100


EXISTING FIRST FLOOR PLAN SCALE 1: 100



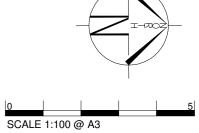

AMENDMENTS: ISSUE DESCRIPTION A DEVELOPMENT APPLICATION	PROJECT:	PROPOSED ALTERATIONS AND ADDITIONS TO THE EXISTING DWELLING	FOR:	EIL & COLON	NBE CAMBO	DURNE	PREPARED BY: NICK KARAHALIOS ARCHITECTURAL DRAFTING SERVICE 513 BOURKE STREET, SURRY HILLS 2010
A DEVELOPMENT APPLICATION			DATE	DRAWN BY	JOB No.	SHEET No.	MOBILE - 0407 360512 EMAIL - nick@nkdrafting.com.au
	LOCATION:	52 INNES ROAD, MANLY VALE	JUNE 2021	NICK. K	211699	02	NOTE: THIS DRAWING IS THE COPYRIGHT OF NICK KARAHALIOS ARCHITECTURAL DRAFTING SERVICES AND SHALL NOT BE REPRODUCED IN PART OR WHOLE WITHOUT THEIR WRITTEN APPROVAL

INDICATES EXISTING ROOF TILES TO BE REMOVED AND REPLACED WITH NEW CORRUGATED COLORBOND METAL ROOF EXISTING ROOF GUTTERS AND DOWNPIPES TO BE UPGRADED

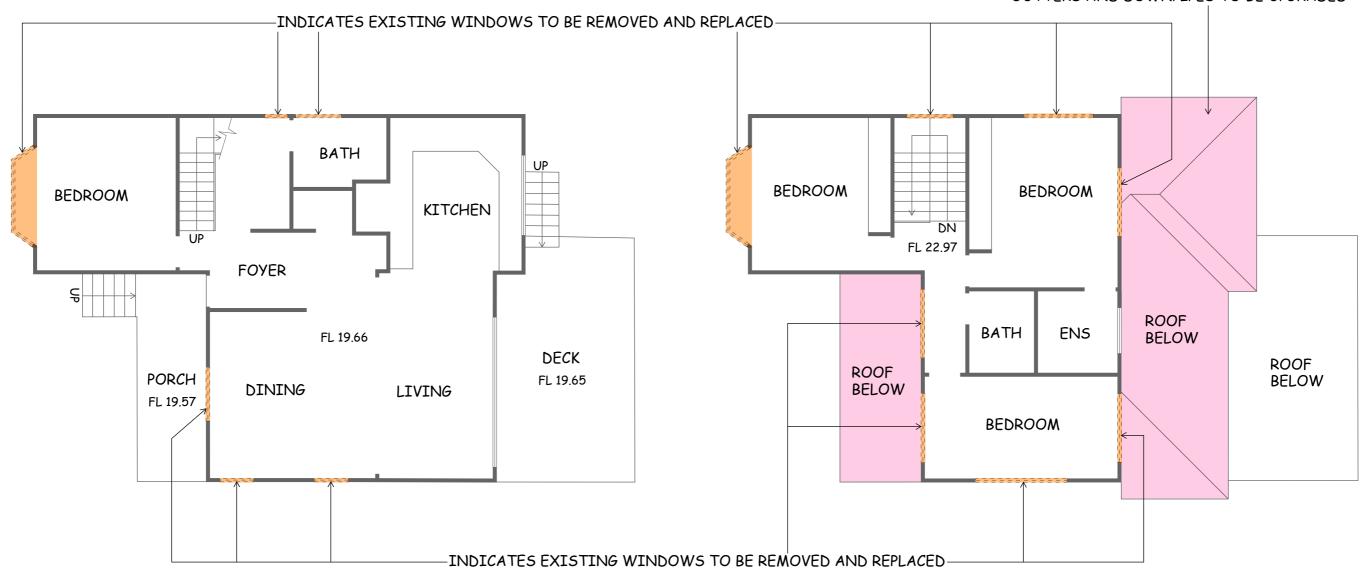

GROUND FLOOR DEMOLITION PLAN SCALE 1: 100

FIRST FLOOR DEMOLITION PLAN


SCALE 1:100

ALL DEMOLITION WORK IS TO COMPLY WITH AS2601 - 2001



0			5	
SCALE	1:100 @	A3		

ISSUE	DESCRIPTION	PROJECT:	PROPOSED ALTERATIONS AND ADDITIONS	NEIL & COLOMBE CAMBOURNE		URNE	PREPARED BY: NICK KARAHALIOS ARCHITECTURAL DRAFTING SERVICES 513 BOURKE STREET, SURRY HILLS 2010	
A	DEVELOPMENT APPLICATION		TO THE EXISTING DWELLING	DATE	DRAWN BY	JOB №.	SHEET No.	MOBILE - 0407 360512 EMAIL - nick@nkdrafting.com.au
		LOCATION:	52 INNES ROAD, MANLY VALE	JUNE 2021	NICK. K	211699	03	NOTE: THIS DRAWING IS THE COPYRIGHT OF NICK KARAHALIOS ARCHITECTURAL DRAFTING SERVICES AND SHALL NOT BE REPRODUCED IN PART OR WHOLE WITHOUT THEIR WRITTEN APPROVAL

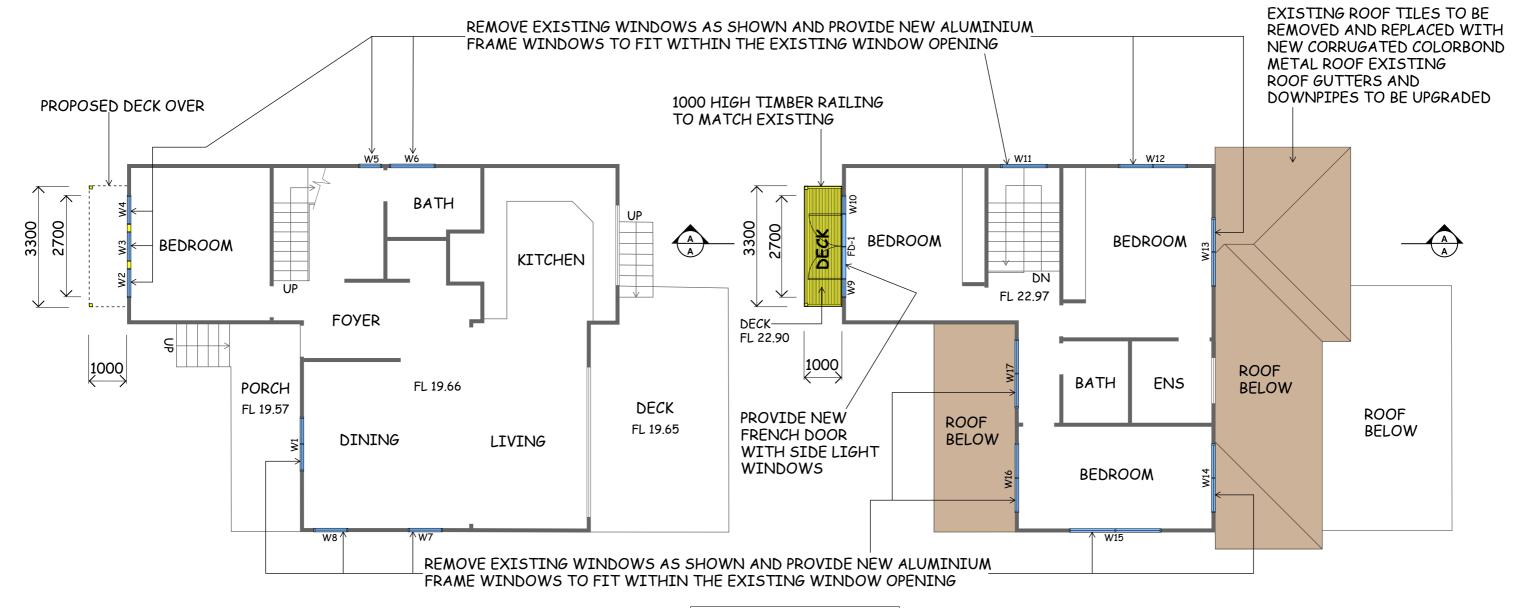

PROPOSED GROUND FLOOR PLAN

CALE 1 · 100

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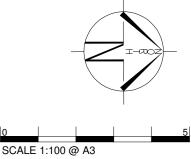
BEFORE YOU DIG

WINDOW W.1	No.	WIDTH	HEIGHT	NO	TCC
W.1				INO	TES
		1400	1300		
W.2		780	1800		
W.3		780	1800		
W.4		780	1800		
W.5		600	1200	TRANSLUC	ENT GLASS
W.6		1200	740	TRANSLUC	ENT GLASS
W.7		880	1300		
W.8		880	1300		
W.9		600	1800		
W.10		600	1800		
W.11		1200	2100	TRANSLUCE	NT GLASS
W.12		1810	600		
W.13		1810	1200		
W.14		1810	1200		
W.15		2420	1200		
W.16		1810	1200		
W.17		1810	1200		
		.===			
FD.1		1500	2150	EXISTING	


PROPOSED FIRST FLOOR PLAN


SCALE 1: 100


NOTE:
ALL DIMENTIONS AND LEVELS
TO BE CONFIRMED ON-SITE



AME	NDMENTS:	PROJECT:	ROJECT:					PREPARED BY:
	DESCRIPTION DEVELOPMENT APPLICATION		PROPOSED ALTERATIONS AND ADDITIONS TO THE EXISTING DWELLING	N	EIL & COLON	MBE CAMBO	NICK KARAHALIOS ARCHITECTURAL DRAFTING SERVICES 513 BOURKE STREET, SURRY HILLS 2010	
	DEVELOPMENT APPLICATION			DATE	DRAWN BY	JOB №.		MOBILE - 0407 360512 EMAIL - nick@nkdrafting.com.au
		LOCATION:	52 INNES ROAD, MANLY VALE	JUNE 2021	NICK. K	211699	04	NOTE: THIS DRAWING IS THE COPYRIGHT OF NICK KARAHALIOS ARCHITECTURAL DRAFTING SERVICES AND SHALL NOT BE REPRODUCED IN PART OR WHOLE WITHOUT THEIR WRITTEN APPROVAL

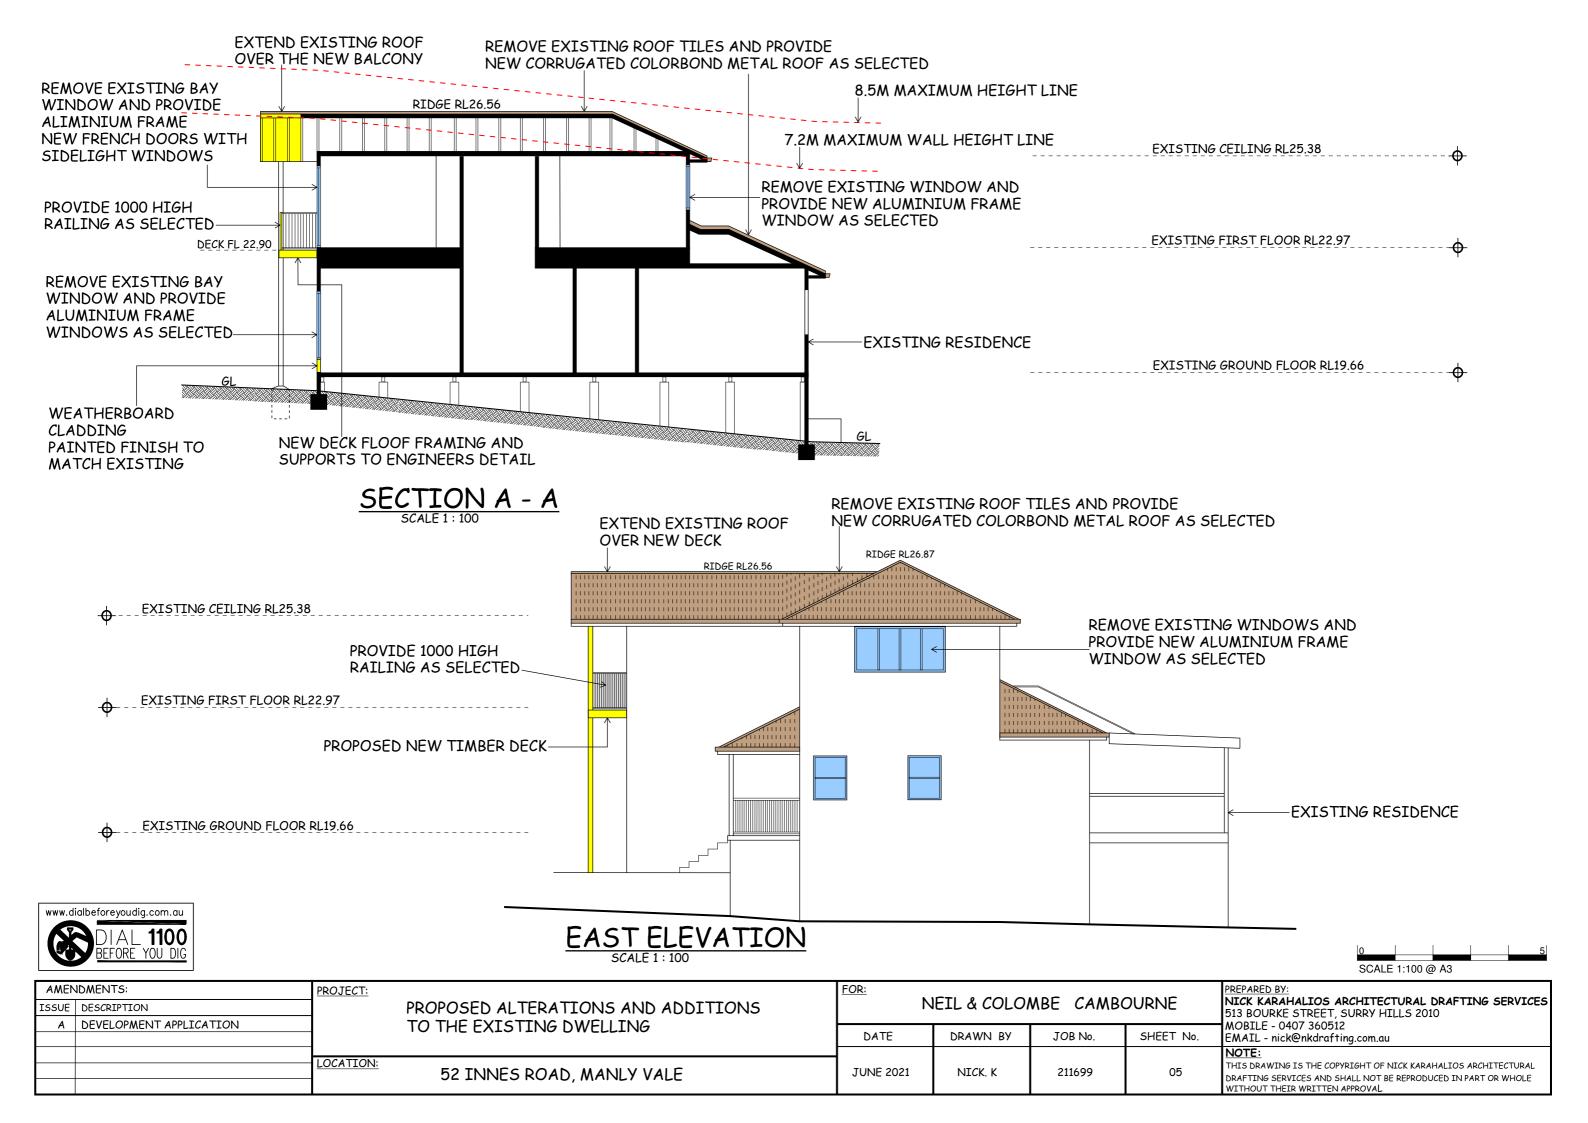

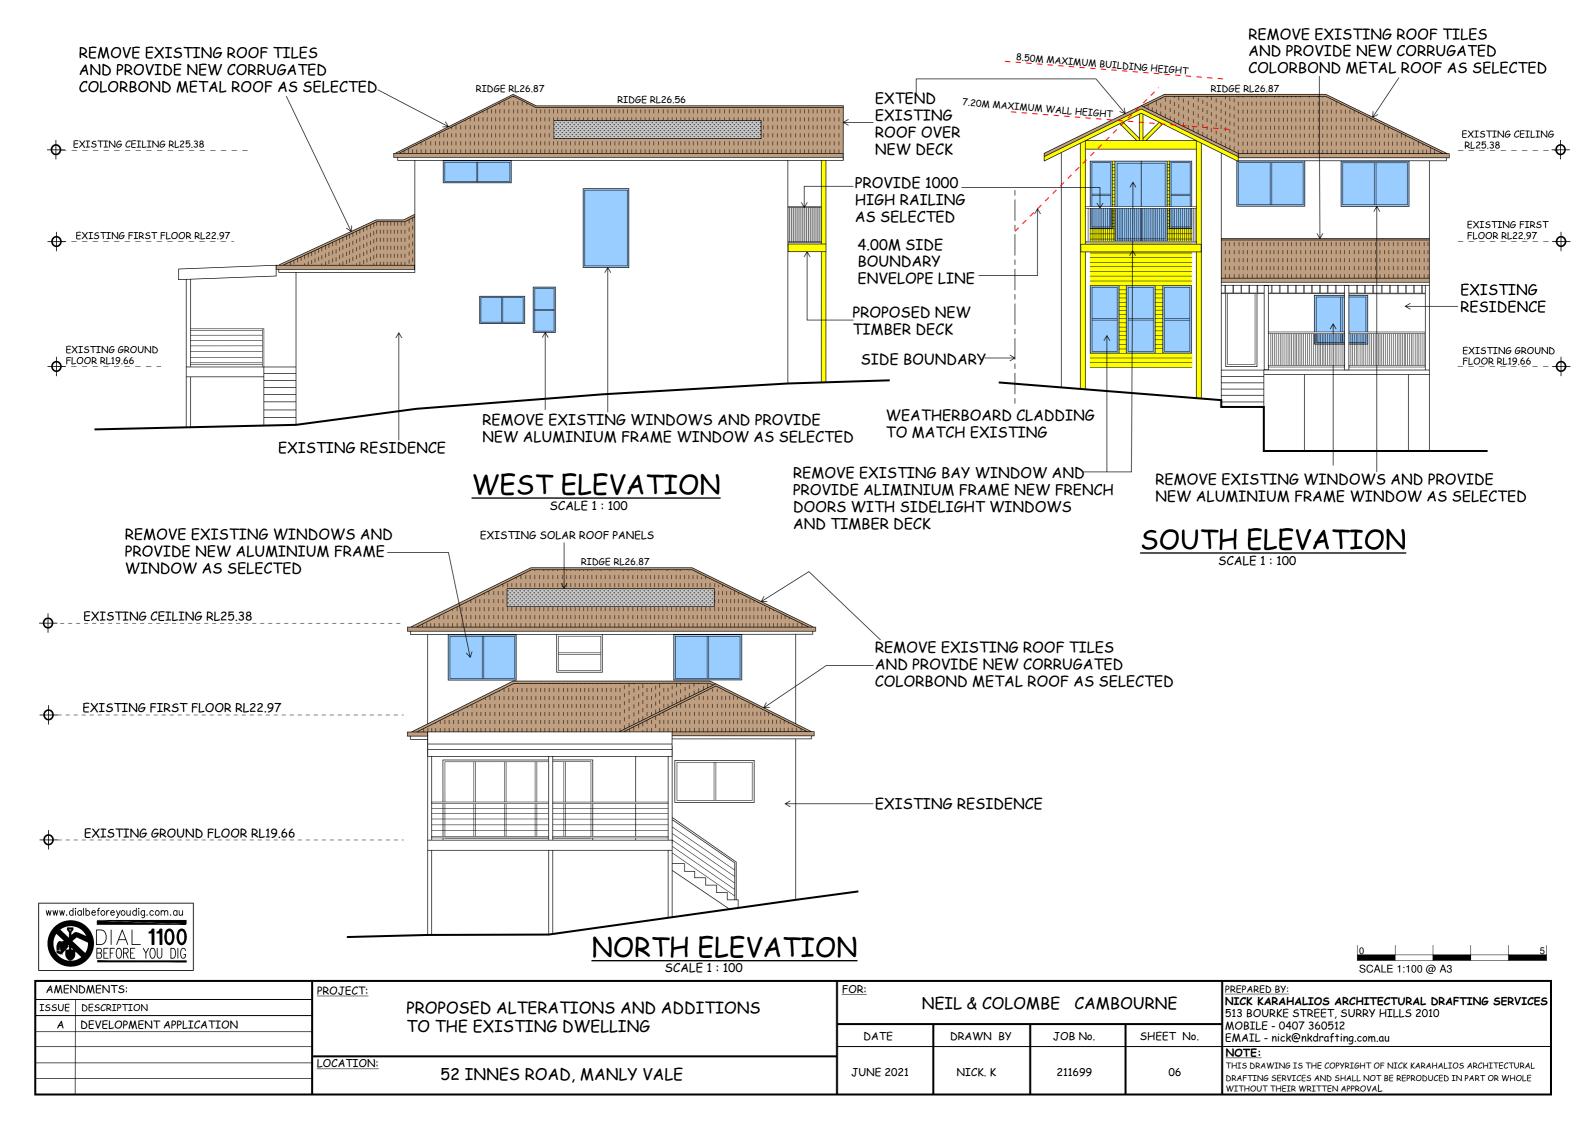

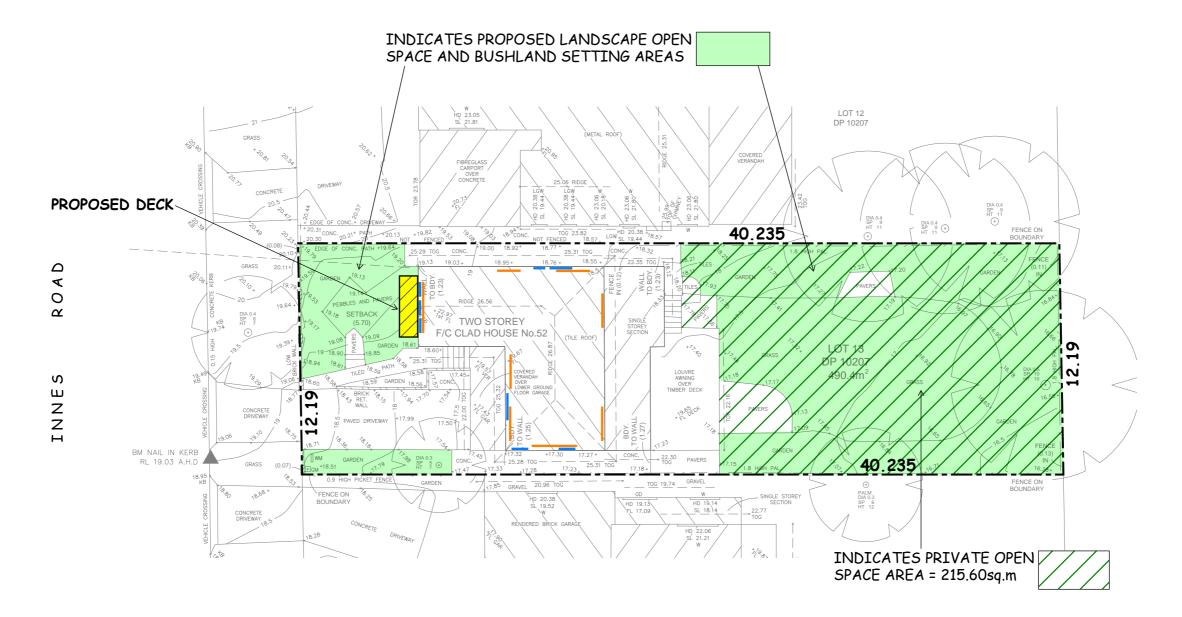


LANDSCAPE OPEN SPACE AND PRIVATE OPEN SPACE CALCULATION PLAN

CALCULATIONS

SITE AREA = 490.40sq.m

MINIMUM REQUIRED LANDSCAPED OPEN SPACE AND BUSHLAND SETTING 40% OF SITE AREA = 196.16sq.m


PROPOSED LANDSCAPED OPEN SPACE AND BUSHLAND SETTING = 244.60sq.m = 49.87%

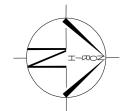



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SCALE	1:200 @	@ A3	

ISSUE	NDMENTS: DESCRIPTION DEVELOPMENT APPLICATION	PROJECT:	PROPOSED ALTERATIONS AND ADDITIONS TO THE EXISTING DWELLING	NEIL & COLOMBE CAMBOURNE			PREPARED BY: NICK KARAHALIOS ARCHITECTURAL DRAFTING SERVICES 513 BOURKE STREET, SURRY HILLS 2010	
A	DEVELOPMENT APPLICATION			DATE	DRAWN BY	JOB No.	SHEET No.	MOBILE - 0407 360512 EMAIL - nick@nkdrafting.com.au
		LOCATION:	52 INNES ROAD, MANLY VALE	JUNE 2021	NICK. K	211699	07	NOTE: THIS DRAWING IS THE COPYRIGHT OF NICK KARAHALIOS ARCHITECTURAL DRAFTING SERVICES AND SHALL NOT BE REPRODUCED IN PART OR WHOLE WITHOUT THEIR WRITTEN APPROVAL

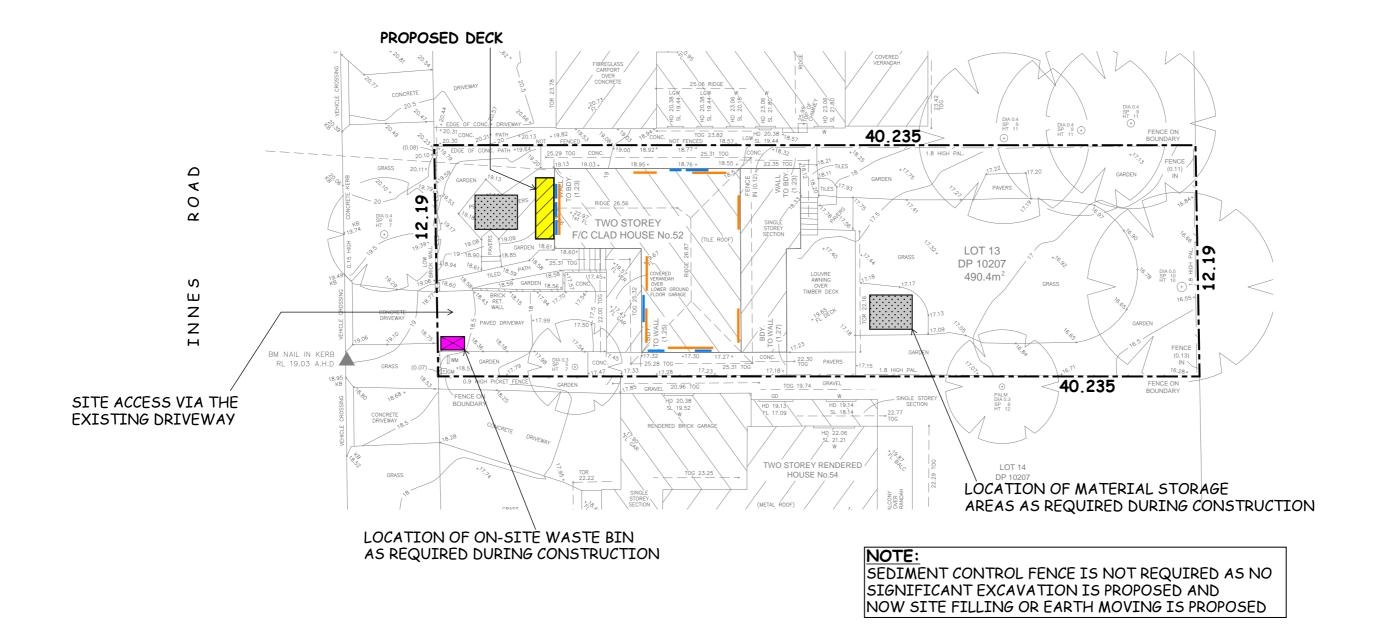


EROSION AND SEDIMENT CONTROL PLAN SCALE 1: 200





AMENDMENTS: ISSUE DESCRIPTION A DEVELOPMENT APPLICATION	PROJECT:	PROPOSED ALTERATIONS AND ADDITIONS TO THE EXISTING DWELLING	FOR:	NEIL & COLO	OMBE CAMI	PREPARED BY: NICK KARAHALIOS ARCHITECTURAL DRAFTING SERVICES 513 BOURKE STREET, SURRY HILLS 2010	
A DEVELOPMENT APPLICATION			DATE	DRAWN BY	JOB No.	SHEET No.	MOBILE - 0407 360512 EMAIL - nick@nkdrafting.com.au
	LOCATION:	52 INNES ROAD, MANLY VALE	JUNE 2021	NICK. K	211699	08	NOTE: THIS DRAWING IS THE COPYRIGHT OF NICK KARAHALIOS ARCHITECTURAL DRAFTING SERVICES AND SHALL NOT BE REPRODUCED IN PART OR WHOLE WITHOUT THEIR WRITTEN APPROVAL

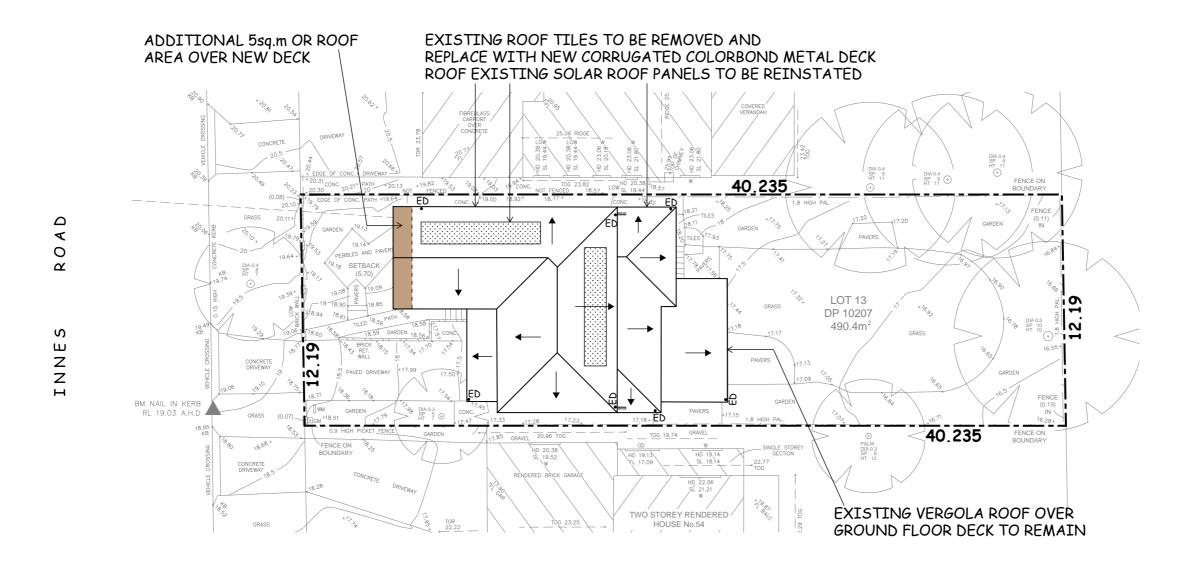

NOTE:

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ALL NEW WORKS TO BE IN ACCORDANCE WITH AS3500-2003 NATIONAL PLUMBING DRAINAGE CODE PART 3 - STORMWATER


PLAN LEGEND:

ED - DENOTES EXISTING DOWNPIPE INDICATES ROOF FALL

NOTE:

THE EXISTING STORMWATER SYSTEM IS TO REMAIN THE DRAINAGE CONTRACTOR IS TO ENSURE THE EXISTING STORMWATER SYSTEM IS CLEAR OF BLOCKAGES AND IN GOOD WORKING ORDER OR REPLACE/REPAIR AS REQUIRED

ROOF AND STORMWATER PLAN SCALE 1: 200

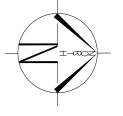

0			5
SCALE	1:200 @	⊋ A3	

AMENDMENTS:	PROJECT:		FOR:				PREPARED BY:	
ISSUE DESCRIPTION		PROPOSED ALTERATIONS AND ADDITIONS		NEIL & COLOMBE CAMBOURNE NICK KARAHALIOS ARCHITECTURAL DRAFTING				
A DEVELOPMENT APPLICATION		TO THE EXISTING DWELLING	DATE	DRAWN BY	JOB №.	SHEET No.	MOBILE - 0407 360512 EMAIL - nick@nkdrafting.com.au	
	LOCATION:	52 INNES ROAD, MANLY VALE	TUB 15 0004	NICK. K	211699	09	NOTE: THIS DRAWING IS THE COPYRIGHT OF NICK KARAHALIOS ARCHITECTURAL	
			JUNE 2021				DRAFTING SERVICES AND SHALL NOT BE REPRODUCED IN PART OR WHOLE WITHOUT THEIR WRITTEN APPROVAL	



Building Sustainability Index www.basix.nsw.gov.au

Alterations and Additions

Certificate number: A420280

This certificate confirms that the proposed development will meet the NSW government's requirements for sustainability, if it is built in accordance with the commitments set out below. Terms used in this certificate, or in the commitments, have the meaning given by the document entitled "BASIX Alterations and Additions Definitions" dated 06/10/2017 published by the Department. This document is available at www.basix.nsw.gov.au

Secretary
Date of issue: Tuesday, 15, June 2021
To be valid, this certificate must be lodged within 3 months of the date of issue.

Planning, Industry & Environment


Windows and glazed doors glazing requirements


O	Project address	
proje	Project name	CAMBOURNE
.[2]	Street address	52 Innes Road Manly Vale 2093
ĭ	Local Government Area	Northern Beaches Council
Q	Plan type and number	Deposited Plan 10207
	Lot number	13
of	Section number	
	Project type	
.0	Dwelling type	Separate dwelling house
escription	Type of alteration and addition	My renovation work is valued at \$50,000 or more, and does not include a pool (and/or spa).
Ö	,	
43		
61.0		
Oe		
De		

Window / door	Orientation	Area of glass inc. frame (m2)	Overshadowing		Shading device	Frame and glass type
no.			Height (m)	Distance (m)		
W1	S	1.82	0	0	eave/verandah/pergola/balcony >=900 mm	improved aluminium, single pyrolytic low-e, (U-value: 4.48, SHGC: 0.46)
W2	S	1.4	0	0	projection/height above sill ratio >=0.43	improved aluminium, single pyrolytic low-e, (U-value: 4.48, SHGC: 0.46)
W3	S	1.4	0	0	projection/height above sill ratio >=0.43	improved aluminium, single pyrolytic low-e, (U-value: 4.48, SHGC: 0.46)
W4	S	1.4	0	0	projection/height above sill ratio >=0.43	improved aluminium, single pyrolytic low-e, (U-value: 4.48, SHGC: 0.46)
W5	W	72	0	0	external louvre/blind (adjustable)	standard aluminium, single pyrolytic low-e, (U-value: 5.7, SHGC: 0.47)
W6	W	88	0	0	external louvre/blind (adjustable)	standard aluminium, single pyrolytic low-e, (U-value: 5.7, SHGC: 0.47)
W7	Е	1.14	0	0	external louvre/blind (adjustable)	improved aluminium, single pyrolytic low-e, (U-value: 4.48, SHGC: 0.46)
W8	Е	1.14	0	0	external louvre/blind (adjustable)	improved aluminium, single pyrolytic low-e, (U-value: 4.48, SHGC: 0.46)
W9	S	1.08	0	0	eave/verandah/pergola/balcony >=900 mm	improved aluminium, single pyrolytic low-e, (U-value: 4.48, SHGC: 0.46)
W10	S	1.08	0	0	eave/verandah/pergola/balcony >=900 mm	improved aluminium, single pyrolytic low-e, (U-value: 4.48, SHGC: 0.46)
W11	W	2.52	0	0	projection/height above sill ratio >=0.43	improved aluminium, single pyrolytic low-e, (U-value: 4.48, SHGC: 0.46)
W12	W	1.08	0	0	eave/verandah/pergola/balcony >=600 mm	improved aluminium, single pyrolytic low-e, (U-value: 4.48, SHGC: 0.46)
W13	N	2.17	0	0	eave/verandah/pergola/balcony >=600 mm	improved aluminium, single pyrolytic low-e, (U-value: 4.48, SHGC: 0.46)
W14	N	2.17	0	0	eave/verandah/pergola/balcony >=600 mm	improved aluminium, single pyrolytic low-e, (U-value: 4.48, SHGC: 0.46)
W15	E	2.9	0	0	eave/verandah/pergola/balcony >=600 mm	improved aluminium, single pyrolytic low-e, (U-value: 4.48, SHGC: 0.46)
W16	S	2.17	0	0	eave/verandah/pergola/balcony >=600 mm	improved aluminium, single pyrolytic low-e, (U-value: 4.48, SHGC: 0.46)
W17	S	2.17	0	0	eave/verandah/pergola/balcony >=600 mm	improved aluminium, single pyrolytic low-e, (U-value: 4.48, SHGC: 0.46)
FD1	S	3.22	0	0	eave/verandah/pergola/balcony >=900 mm	improved aluminium, single pyrolytic low-e, (U-value: 4.48, SHGC: 0.46)



AMENDMENTS:		PROJECT:		
ISSUE	DESCRIPTION		PROPOSED ALTERATIONS AND ADDITIONS	
Α	DEVELOPMENT APPLICATION		TO THE EXISTING DWELLING	
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		LOCATION:		
		200/(120/4	52 INNES ROAD, MANLY VALE	
			, l	

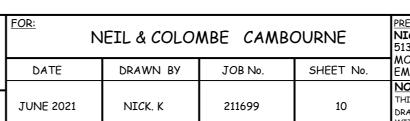

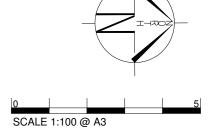

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PREPARED BY: NICK KARAHALIOS ARCHITECTURAL DRAFTING SERVICES 513 BOUNKE STREET, SURRY HILLS 2010
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