
# **Drawing Register**

lssue Date day 1 month 12

year 21

| Document Distribution: | DA |
|------------------------|----|
| Client                 | 1  |
| Structural Engineer    |    |
| Hydraulic Engineer     |    |
| Landsc. Consultant     |    |
| Approval Authority     | 1  |
| Landsc. Consultant     | 1  |

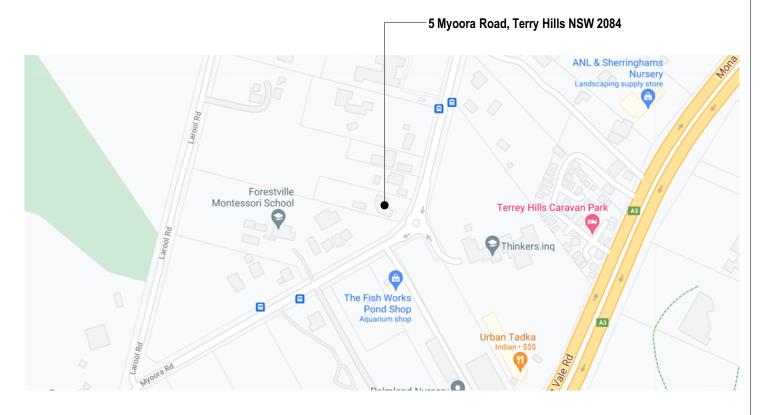

## **LOCATION PLAN (NTS)**

(Source Google maps)

#### **GENERAL BUILDING SPECIFICATION**

- All general construction to conform to the current BCA and Local Govt conditions of Development Consent.
- Demolition works to be carried out in accordance with AS 2601.
- All masonry work in accordance with AS 3700.
- Termite protection to be installed in accordance with AS 3660.1 and the current BCA.
- All roof water and storm-water runoff to be connected to a Council approved system of collection and/or disposal.
- All carpentry work to conform to AS1684 for Light Timber Framing.
- All sewer waste to be connected to the existing mains service in accordance with AS 3500.
- All pre-fabricated timber trusses and frames to utilize sustainable plantation timbers installed to the manufacturer's detail and specification.
- All concrete slabs, retaining walls, structural steel, foundations and footings to be designed & specified by the consulting structural engineer and built strictly in accordance with such details, as approved.
- Plumbing services to be carried out only by licenced tradespersons and in accordance with AS 3500.3.2, AS 3500.2.2, AS 3500.1.2, AG 601 and other associated standards and codes.
- All electrical services to be installed by licenced electricians and in accordance with AS3000. Telecommunications cabling to be installed in accordance with AS/ACIF S009:2000 and associated standards and guidelines. Upgrade safety switches & smoke alarms as required to meet relevant standards.
- All measurements shown and scheduled are nominal. The contractor shall check all measurements on site before ordering materials and check any anomalies with Cadence & Co Small Works Department before proceeding.
- All insulation to be provided and installed in accordance with AS4859.1, AS3999 (bulk insul'n), AS1904 (foil insul'n) and associated standards and codes.
- Proposed RL's shown on drawings are to be FINISHED LEVELS. Builder to provide set down's and allowances to accommodate finished levels.



#### CADENCE & CO DESIGN


Suite 7, 287 Mona Vale Rd, Terrey Hills, NSW, 2084, P 94501950

ABN: 12 168 714 752 Nominated Architect: Sam Samarghandi NSW ARB 9112 Copyright © CADENCE & CO DESIGN PTY LTD

| ı | C REVISION: |         | REVISION NOTE:<br>Client Review |
|---|-------------|---------|---------------------------------|
|   | D           | 30/8/21 | DA 95% complete                 |
|   | E           | 1/12/21 | DA Submission                   |
|   |             |         |                                 |

| CLIENT:   |  |
|---|--|
| David Cussen  |  |
| DDRESS:  Myoora Road, Terrey Hills NSW 2084  Being LOT 1 IN DP 525554 |  |

| DRAWING:    |             | DRAWN:      | SHEET NO   |
|-------------|-------------|-------------|------------|
| DRAWING RE  | JE          | DA00        |            |
| PROJECT:    |             | CHKD:       | SCALE @ A3 |
| New Shed    |             |             | 1:500      |
| PROJECT NO: | ISSUE TYPE: | ISSUE DATE: | REVISION   |
| CUS0821     | DA          | 1/12/21     | E          |

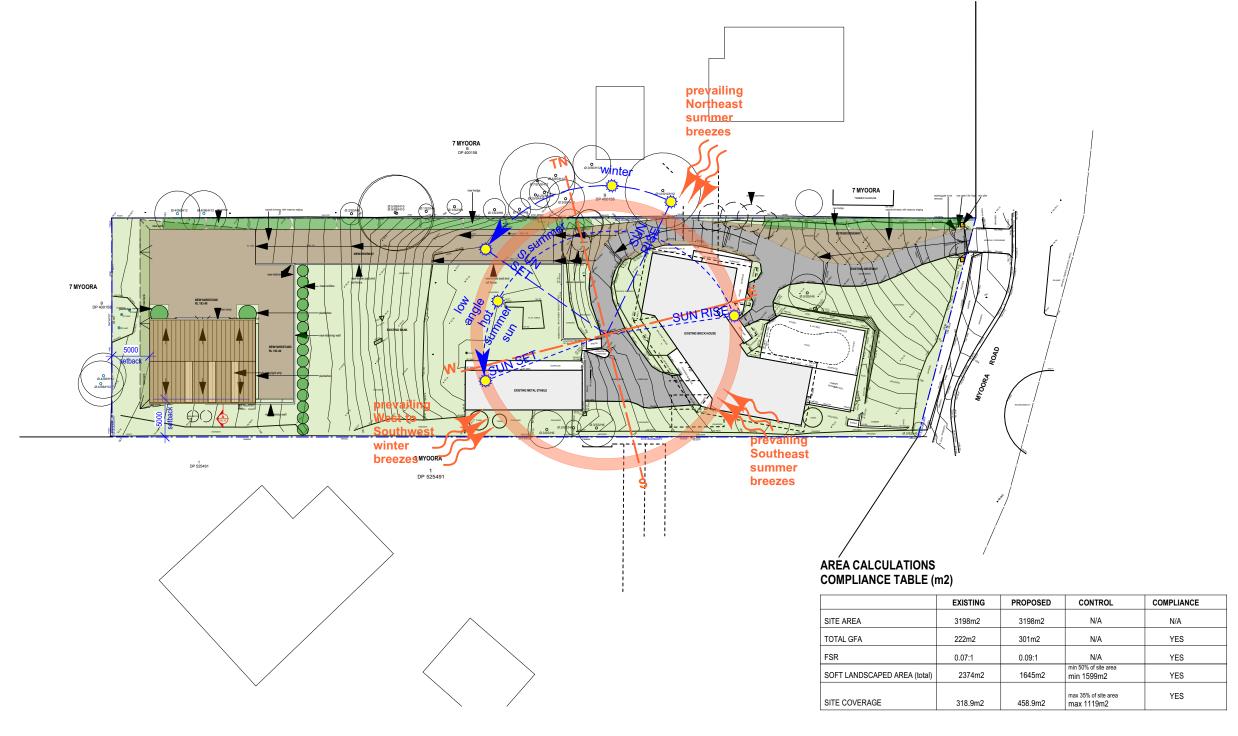

1 SITE PLAN/ SITE ANALYSIS/ ROOF PLAN SCALE 1:500 @ A3



# CADENCE & CO DESIGN

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 REVISION:
 DATE:
 REVISION NOTE:

 C
 19/8/21
 Client Review

 D
 30/8/21
 DA 95% complete

 E
 1/12/21
 DA Submission

ALUMINUM WINDOW/DOOR
TIMBER BALUSTRADE BAL FZ
CELING
CERAMIC TILE
CLEAR ROOF SHEETING
EXISTING
FRIDGE
FRIDGE
FIRE CEMENT
FINSHED FLOOR LEVEL
NEW GRATED DRAIN
METAL ROOF SHEETING
METAL WALL CALDNING



David Cussen


ADDRESS:
5 Myoora Road, Terrey Hills NSW 2084
Being LOT 1 IN DP 525554


DRAWING:
SITE PLAN / SITE ANALYSIS / ROOF PLAN
JE


PROJECT:
New Shed
PROJECT NO:
ISSUE TYPE:
CUS0821


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1:500
1/12/21

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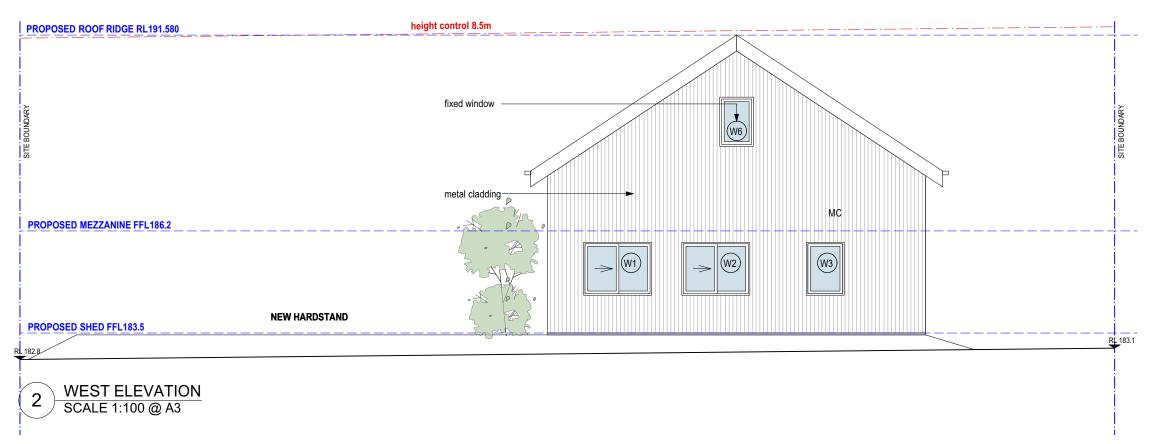


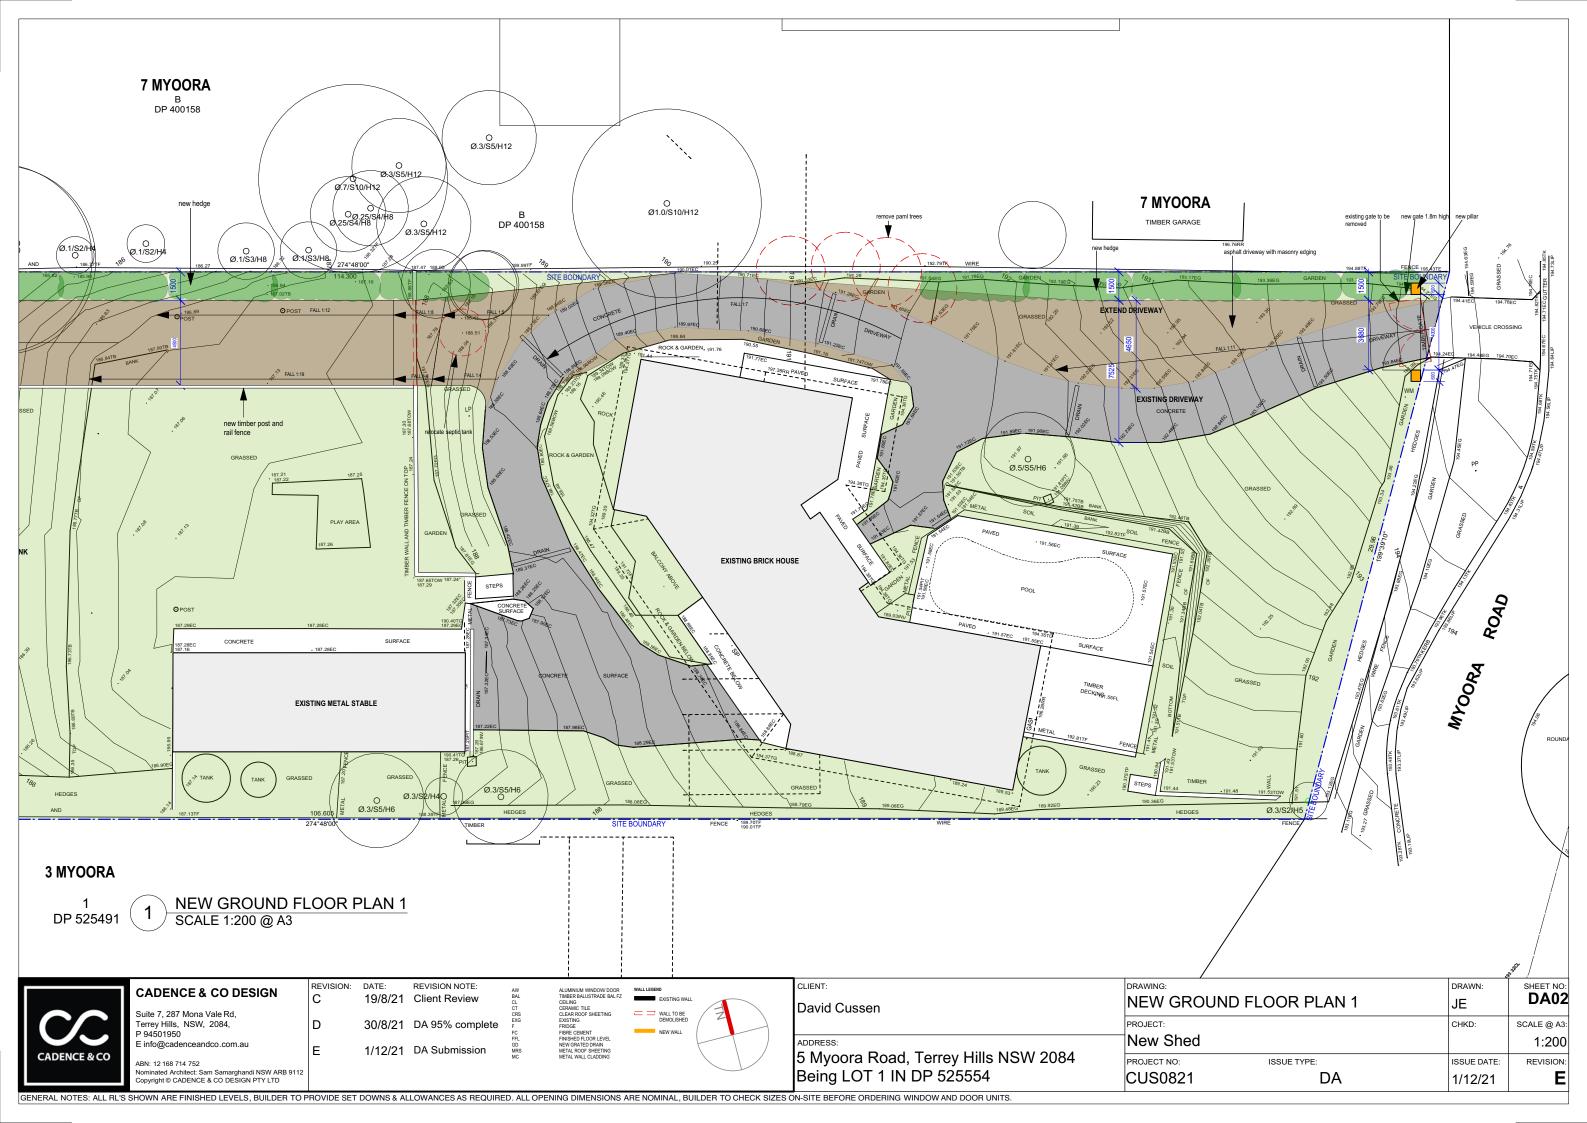

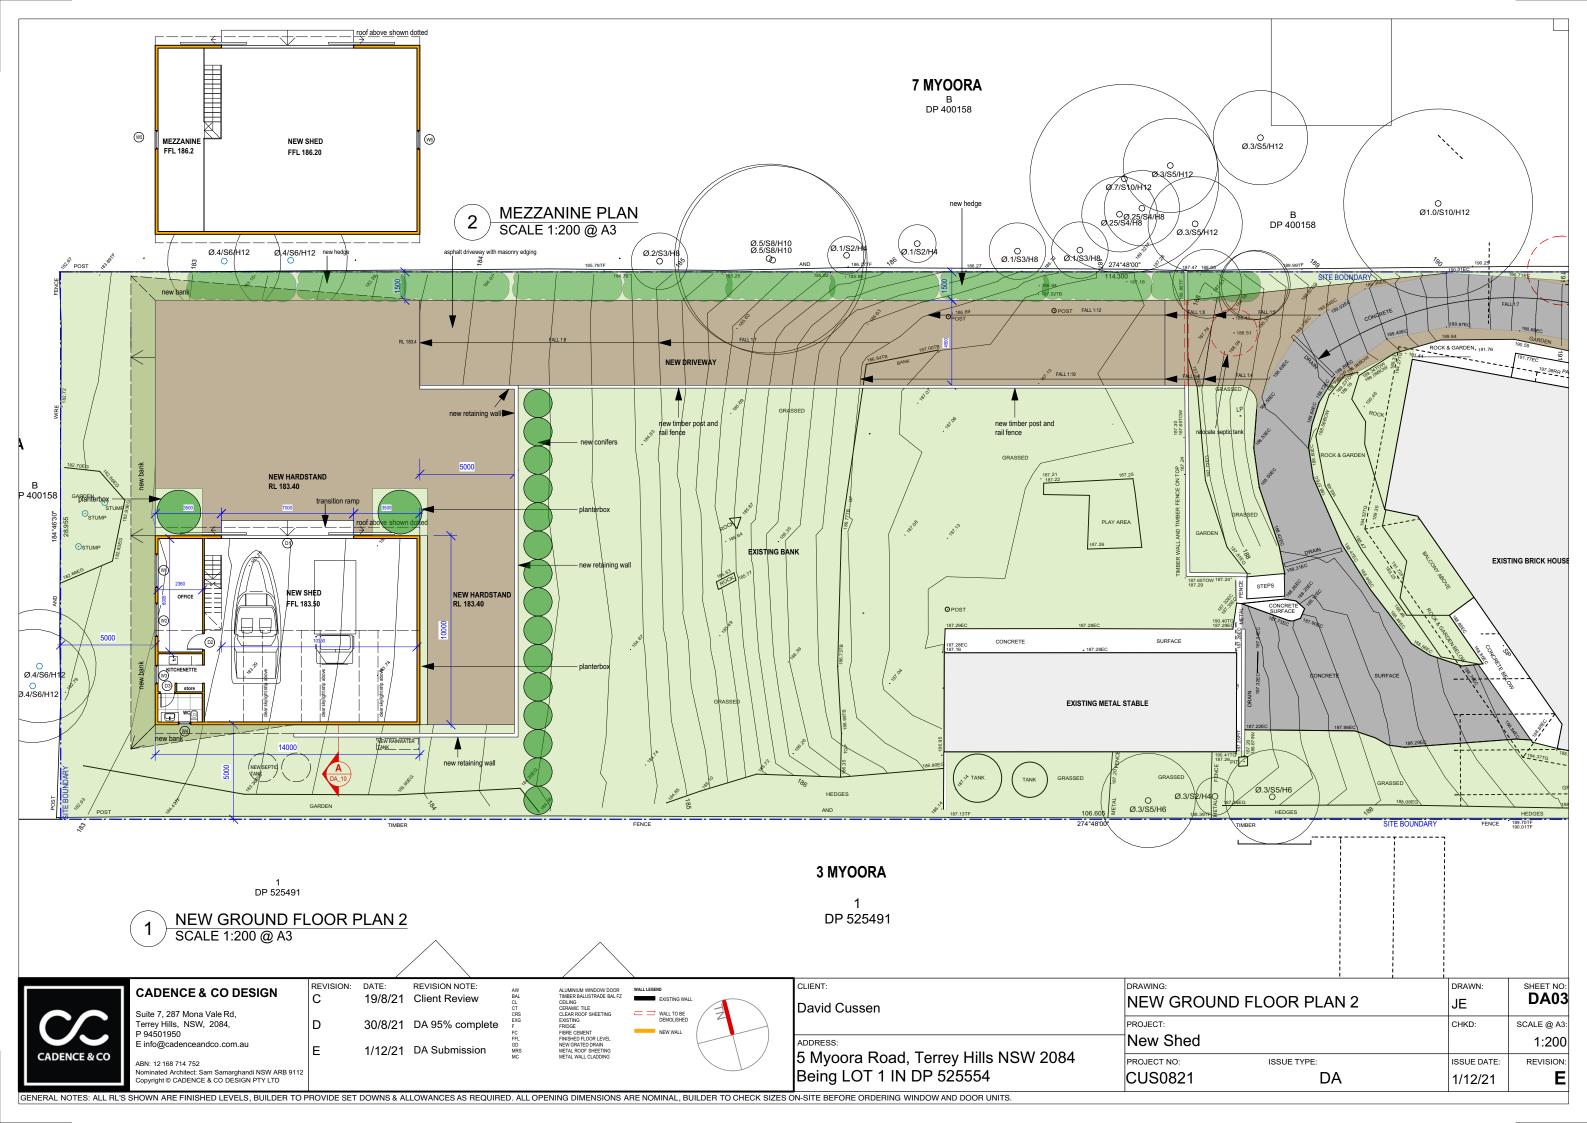

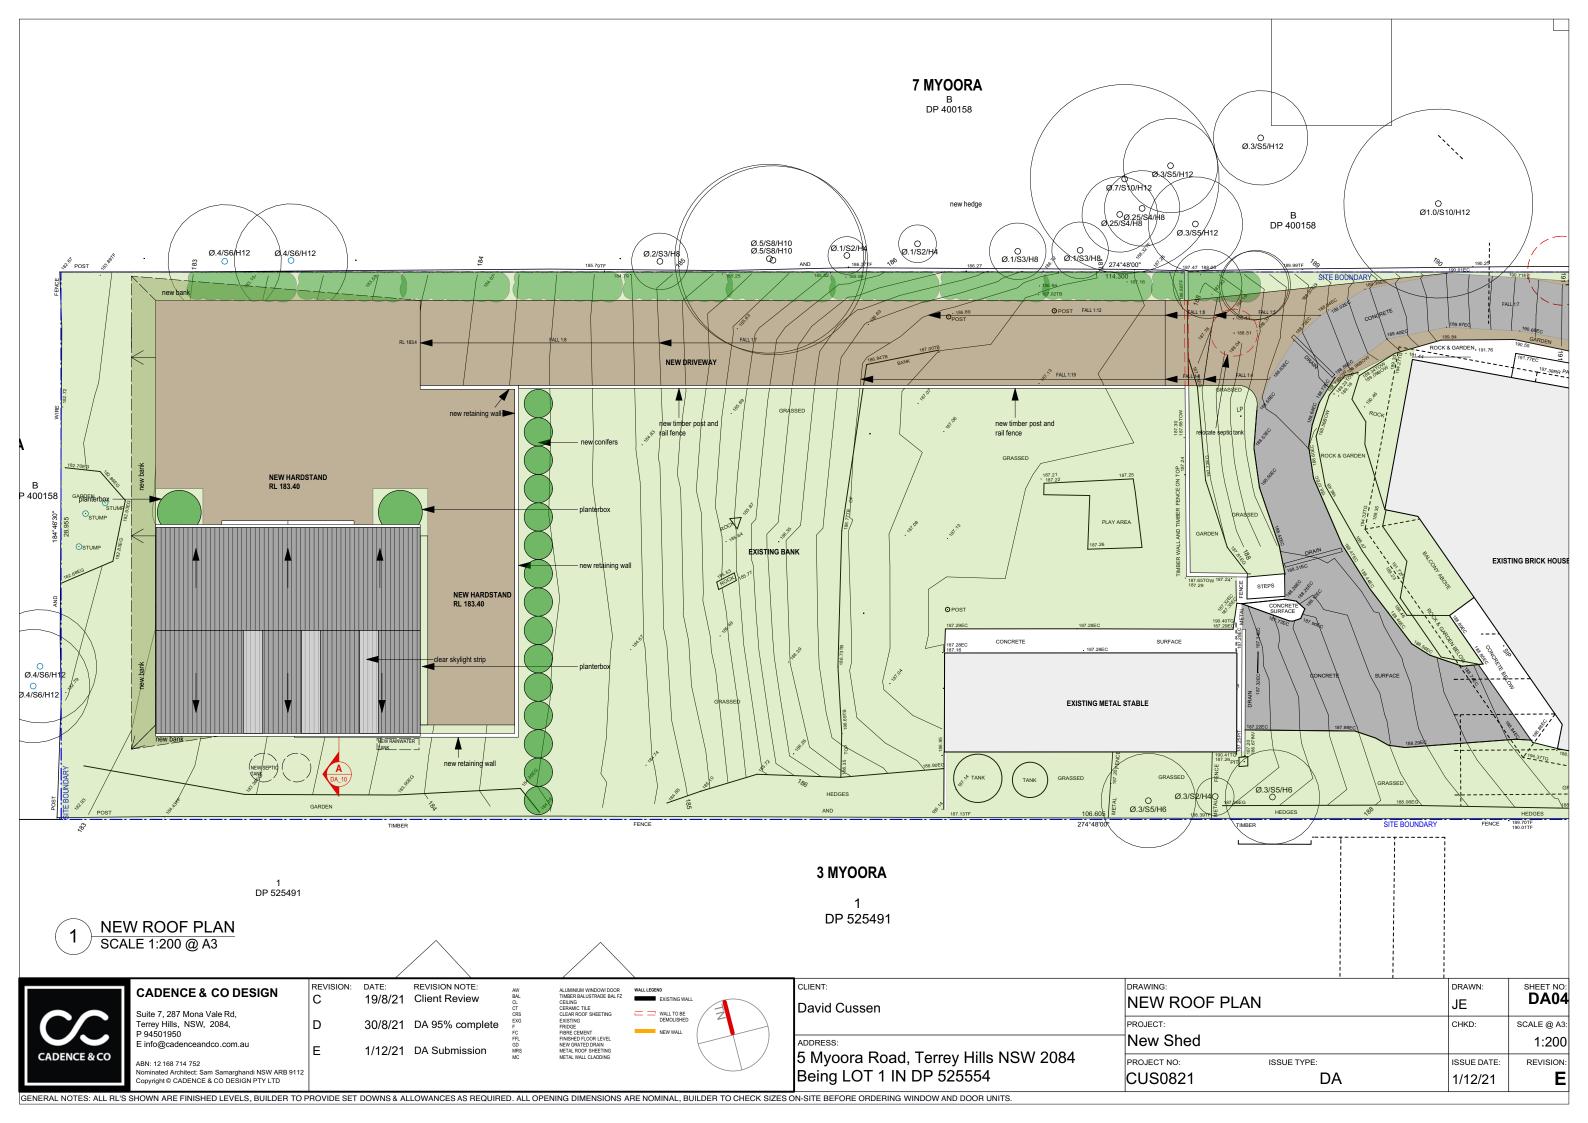

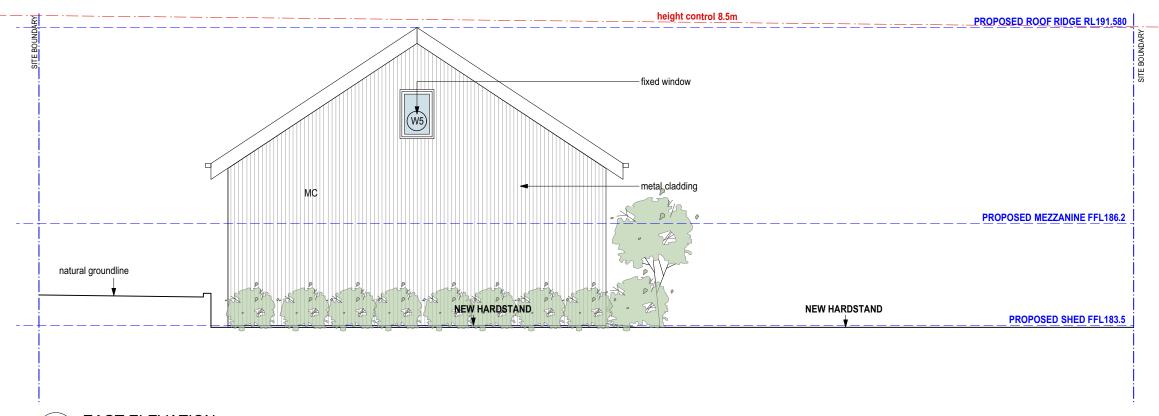1 EAST ELEVATION SCALE 1:100 @ A3





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|-----------|------------------|---------------------------------|
| D         | 30/8/21          | DA 95% complete                 |
| _         | 1/12/21          | DA Submission                   |

ALUMINIUM WINDOW/ DOOR TIMBER BALUSTRADE BAL FZ CELIND THE CLEAR ROOF SHEETING EXISTING FRIDGE FIBRE CEMENT FINISHED FLOOR LEVEL NEW GRATED DRAIN METAL ROOF SHEETING METAL ROOF SHEETING METAL ROOF SHEETING METAL WALL CLADDING




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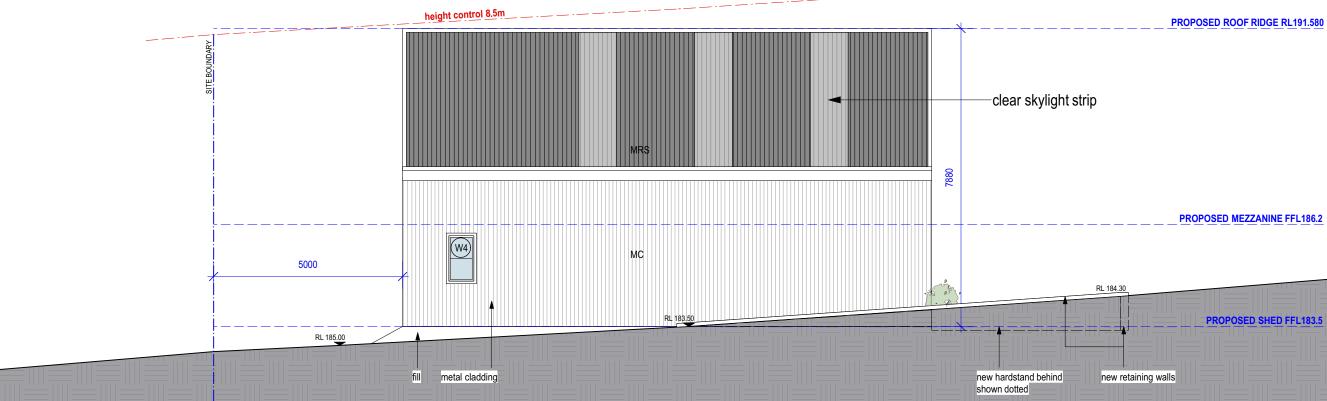
| CLIENT:      |
|--------------|
| David Cussen |
|              |
| ADDRESS:     |

ADDRESS:
5 Myoora Road, Terrey Hills NSW 2084
Being LOT 1 IN DP 525554

| RAWING:    |             | DRAWN:      | SHEET NO:   |
|------------|-------------|-------------|-------------|
| ELEVATIONS |             | JE          | DA05        |
| ROJECT:    |             | CHKD:       | SCALE @ A3: |
| New Shed   |             |             | 1:200       |
| ROJECT NO: | ISSUE TYPE: | ISSUE DATE: | REVISION:   |
| CUS0821    | DA          | 1/12/21     | E           |

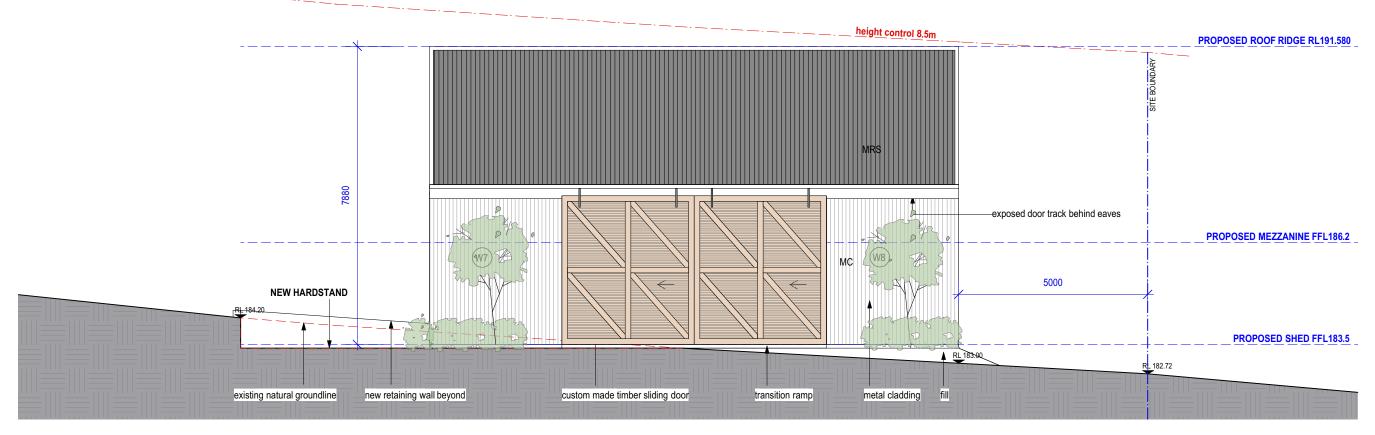

1 NORTH ELEVATION SCALE 1:100 @ A3



2 SOUTH ELEVATION SCALE 1:100 @ A3



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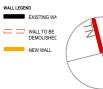
 REVISION:
 DATE:
 REVISION NOTE:

 C
 19/8/21
 Client Review

 D
 30/8/21
 DA 95% complete

 E
 1/12/21
 DA Submission

ALUMINIUM WINDOW/ DOOR
TIMBER BALUSTRADE BAL FZ
CEILING
CERAMIC TILE
CLEAR ROOF SHEETING
EXISTING
FRIDGE
FIRER CEMENT
FINISHED FLOOR LEVEL
NEW GRATED DAIN
METAL ROOF SHEETING
METAL WALL CLADDING
METAL WALL CLADDING




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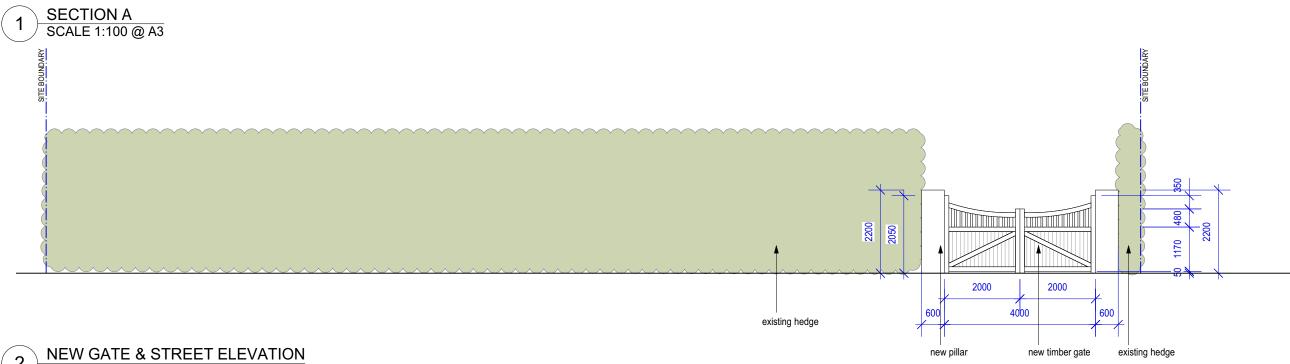
David Cussen

ADDRESS:

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Being LOT 1 IN DP 525554

| DRAWING:    |             | DRAWN:      | SHEET NO   |
|-------------|-------------|-------------|------------|
| ELEVATIONS  |             | JE          | DA06       |
| PROJECT:    |             | CHKD:       | SCALE @ A3 |
| New Shed    |             |             | 1:200      |
| PROJECT NO: | ISSUE TYPE: | ISSUE DATE: | REVISION   |
| CUS0821     | DA          | 1/12/21     | E          |



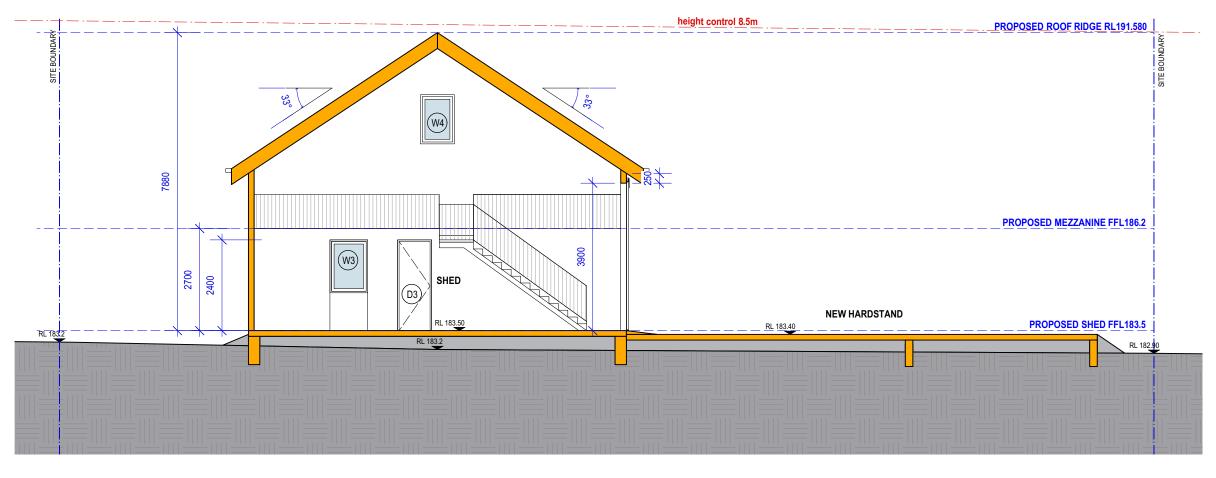

2 NEW GATE & STREET ELEVATION SCALE 1:100 @ A3




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|-----------|------------------|---------------------------------|
| D         | 30/8/21          | DA 95% complete                 |
| E         | 1/12/21          | DA Submission                   |

ALUMINIUM WINDOW DOOR TIMBER BALUSTRADE BALFZ CELLING CERAMIC TILE CLEAR ROOF SHEETING EXISTING FRIDGE FIBER CEMENT FINISHED FLOOR LEVEL NEW GRATED DRAIN METAR ROOF SHEETING METAR WALL CLADDING METAR WALL CLADDING




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David Cussen

ADDRESS:
5 Myoora Road, Terrey Hills NSW 2084
Being LOT 1 IN DP 525554
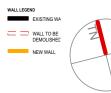
| DRAWING:    |             | DRAWN:      | SHEET NO   |
|-------------|-------------|-------------|------------|
| SECTION     |             | JE          | DA0        |
| PROJECT:    |             | CHKD:       | SCALE @ A3 |
| New Shed    |             |             | 1:200      |
| PROJECT NO: | ISSUE TYPE: | ISSUE DATE: | REVISION   |
| CUS0821     | DA          | 1/12/21     | E          |

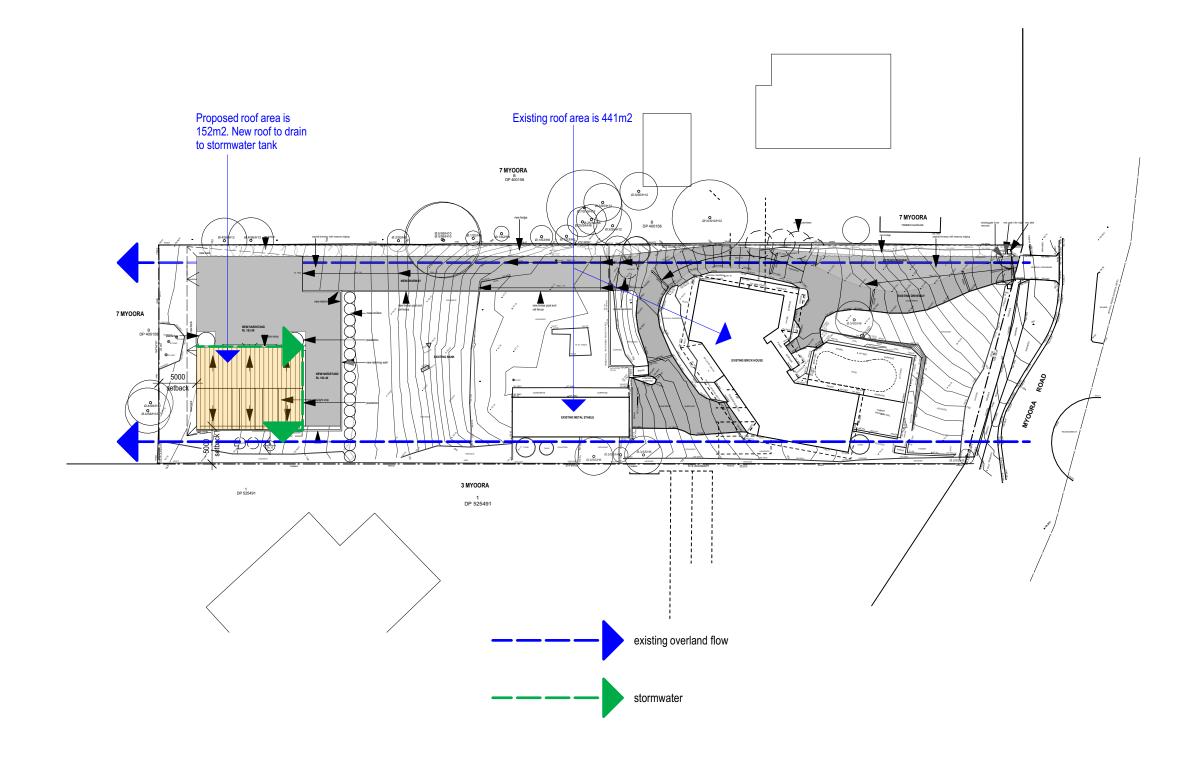

STORMWATER CONCEPT PLAN SCALE 1:500 @ A3



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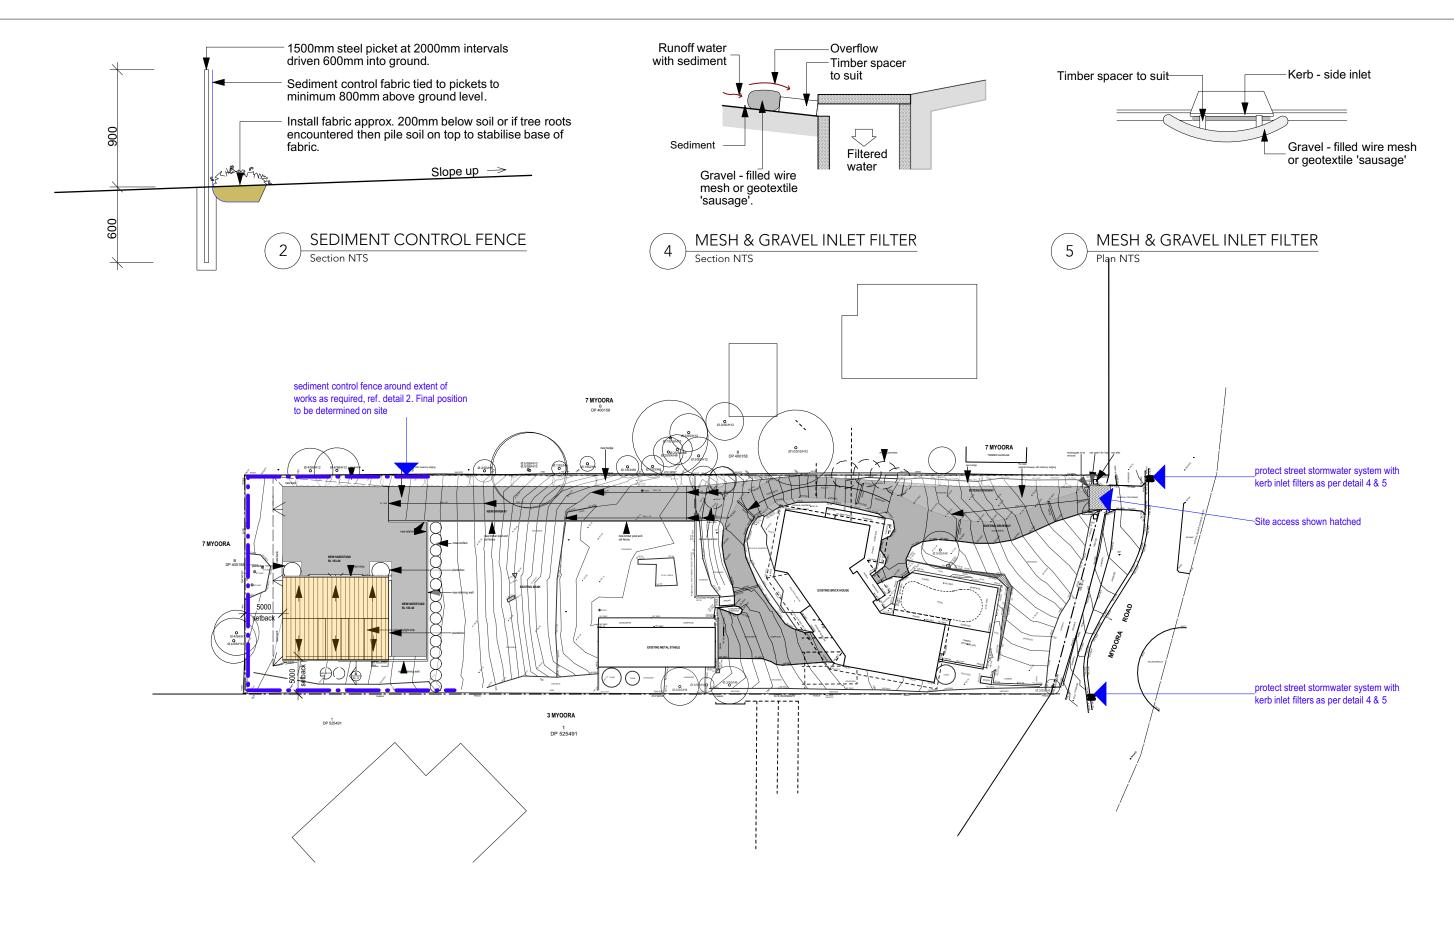
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|-----------|------------------|---------------------------------|
| D         | 30/8/21          | DA 95% comple                   |
| E         | 1/12/21          | DA Submission                   |



|       | CLIENT:   |
|-------|---|
| all Z | David Cussen  |
|       | ADDRESS: 5 Myoora Road, Terrey Hills Being LOT 1 IN DP 525554 |

| CLIENT:                              |   |
|--------------------------------------|---|
| David Cussen                         |   |
|                                      | Ì |
| ADDRESS:                             |   |
| 5 Myoora Road, Terrey Hills NSW 2084 | ŀ |

| DRAWING:    | DRAWN:      | SHEET NO |             |            |
|-------------|-------------|----------|-------------|------------|
| STORMWATER  | JE          | DAU      |             |            |
| PROJECT:    |             |          | CHKD:       | SCALE @ A3 |
| New Shed    |             |          |             | 1:500      |
| PROJECT NO: | ISSUE TYPE: |          | ISSUE DATE: | REVISION   |
| CUS0821     | DA          |          | 1/12/21     | Е          |








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REVISION NOTE: DATE: 19/8/21 Client Review 30/8/21 DA 95% complete E

1/12/21 DA Submission



| CLIENT:                              |
|--------------------------------------|
| David Cussen                         |
|                                      |
| ADDRESS:                             |
| 5 Myoora Road, Terrey Hills NSW 2084 |

Being LOT 1 IN DP 525554
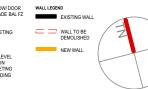
| DRAWING:    |                       | DRAWN:      | SHEET NO   |
|-------------|-----------------------|-------------|------------|
| EROSION &   | SEDIMENT CONTROL PLAN | JE          | DA09       |
| PROJECT:    |                       | CHKD:       | SCALE @ A3 |
| New Shed    |                       |             | 1:500      |
| PROJECT NO: | ISSUE TYPE:           | ISSUE DATE: | REVISION   |
| CUS0821     | DA                    | 1/12/21     | E          |

| WINDOW SCHEDULE            |                     |                    |                |               |             |                              | NOTES:  |
|----------------------------|---------------------|--------------------|----------------|---------------|-------------|------------------------------|---|
| ID Type                    | Opening Height (mm) | Opening Width (mm) | Unit Area (m2) | Glazing Type  | Head (nom.) | Comments                     | 1. All external glazing units to have aluminium powdercoat frames as selected. Owner to give final approval to external glazing units before ordering/ manufacture. |
| W1 sliding window          | 1400                | 1800               | 2.5            | low 'e' glass | 2400        | New window to office         | 2. All glazing to comply with Part 3.6 of the current BCA.  |
| W2 sliding window          | 1400                | 1800               | 2.5            | low 'e' glass | 2400        | New window to office         | 3. Dimensions given are nominal and to suit scheduled opening sizes - Contractor to check   |
| W3 awning window           | 1400                | 1000               | 1.4            | clear         | 2400        | New window to kitchenette    | all dimensions on site before ordering glazing units. Contact Cadence & Co - Small works  |
| W4 awning window           | 1200                | 660                | 0.8            | clear         | 2400        | New window to bathroom       | department if dimensions conflict. 4. Refer to Elevations for fixed/ openable sashes.   |
| W5 fixed window            | 1300                | 900                | 1.2            | clear         | 6240        | New highlight window to shed | 5. Internal door sizes generally as noted on plan, to be painted flush solid core doors unless  |
| W6 fixed window            | 1300                | 900                | 1.2            | clear         | 6240        | New highlight window to shed | noted otherwise.  |
| DOOR SCHEDULE              |                     |                    |                |               |             |                              | 6. Refer to current Basix certificate 7. Client to approve extent of insect screens. 8. Refer to Fire Report. Glazing to meet Bal rating, flame zone                |
| D1 barn style sliding door | 3800                | 7000               | N/A            | no glazing    | 3800        | New door shed                | o. Neigh to hire Neport. Glazing to meet bal fatting, fiame zone  |
| D2 hinged door             | 2400                | 900                | N/A            | no glazing    | 3800        | New door to office           |   |
| D3 hinged door             | 2100                | 800                | N/A            | no glazing    | 3800        | New door to bathroom         |   |



CADENCE & CO DESIGN

Suite 7, 287 Mona Vale Rd, Terrey Hills, NSW, 2084, P 94501950 E info@cadenceandco.com.au

ABN: 12 168 714 752 Nominated Architect: Sam Samarghandi NSW ARB 9112 Copyright © CADENCE & CO DESIGN PTY LTD


ALUMINIUM WINDOW DOOR TIMBER BALUSTRADE BALFZ CEILING CERAMIC TILE CLEAR ROOF SHEETING EXISTING FINDOE FIRE CEMENT FINISHED FLOOR LEVEL NEW GRATED DRAIN METAL ROOF SHEETING METAL MOOF SHEETING



David Cussen

ADDRESS:
5 Myoora Road, Terrey Hills NSW 2084
Being LOT 1 IN DP 525554

| DRAWING:    |              | DRAWN:     | SHEET NO:   |
|-------------|--------------|------------|-------------|
| DOOR & WIN  | DOW SCHEDULE | JE         | DA10        |
| PROJECT:    |              | CHKD:      | SCALE @ A3: |
| New Shed    |              |            | NTS         |
| PROJECT NO: | ISSUE TYPE:  | ISSUE DATE | : REVISION: |
| CUS0821     | DA           | 1/12/21    | E           |

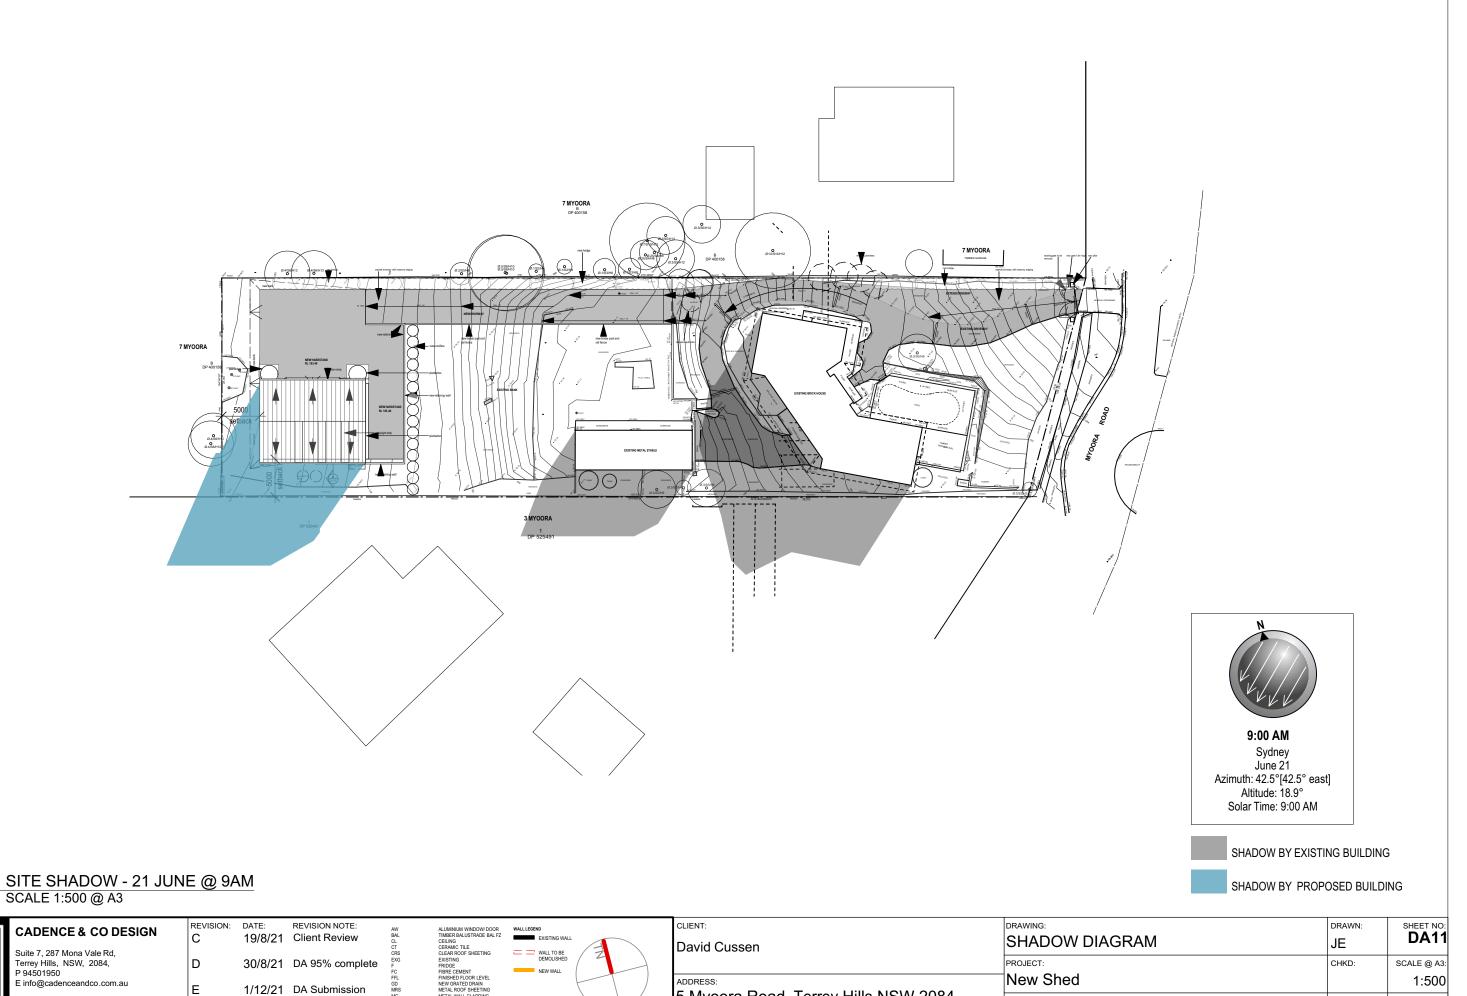

5 Myoora Road, Terrey Hills NSW 2084

Being LOT 1 IN DP 525554

PROJECT NO:

CUS0821

ISSUE TYPE:

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ISSUE DATE:

1/12/21


REVISION:

Ε

GENERAL NOTES: ALL RL'S SHOWN ARE FINISHED LEVELS, BUILDER TO PROVIDE SET DOWNS & ALLOWANCES AS REQUIRED. ALL OPENING DIMENSIONS ARE NOMINAL, BUILDER TO CHECK SIZES ON-SITE BEFORE ORDERING WINDOW AND DOOR UNITS.

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5 Myoora Road, Terrey Hills NSW 2084

Being LOT 1 IN DP 525554

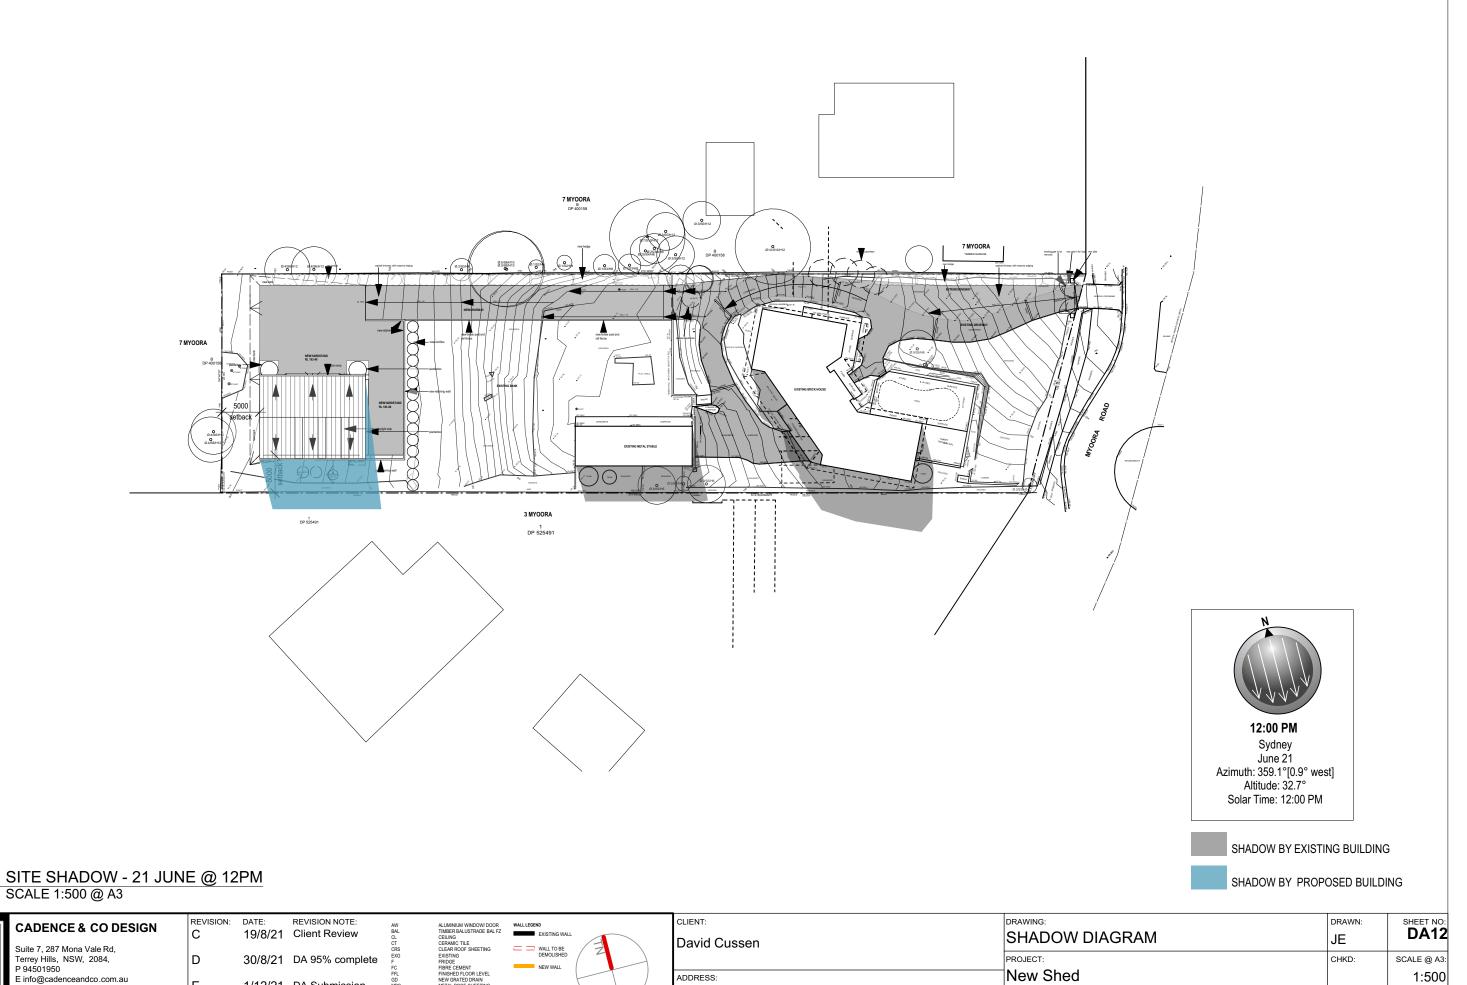PROJECT NO:

CUS0821

ISSUE TYPE:

DA

ISSUE DATE:

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REVISION:


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GENERAL NOTES: ALL RL'S SHOWN ARE FINISHED LEVELS, BUILDER TO PROVIDE SET DOWNS & ALLOWANCES AS REQUIRED. ALL OPENING DIMENSIONS ARE NOMINAL, BUILDER TO CHECK SIZES ON-SITE BEFORE ORDERING WINDOW AND DOOR UNITS.

1/12/21 DA Submission

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Being LOT 1 IN DP 525554

PROJECT NO:

CUS0821

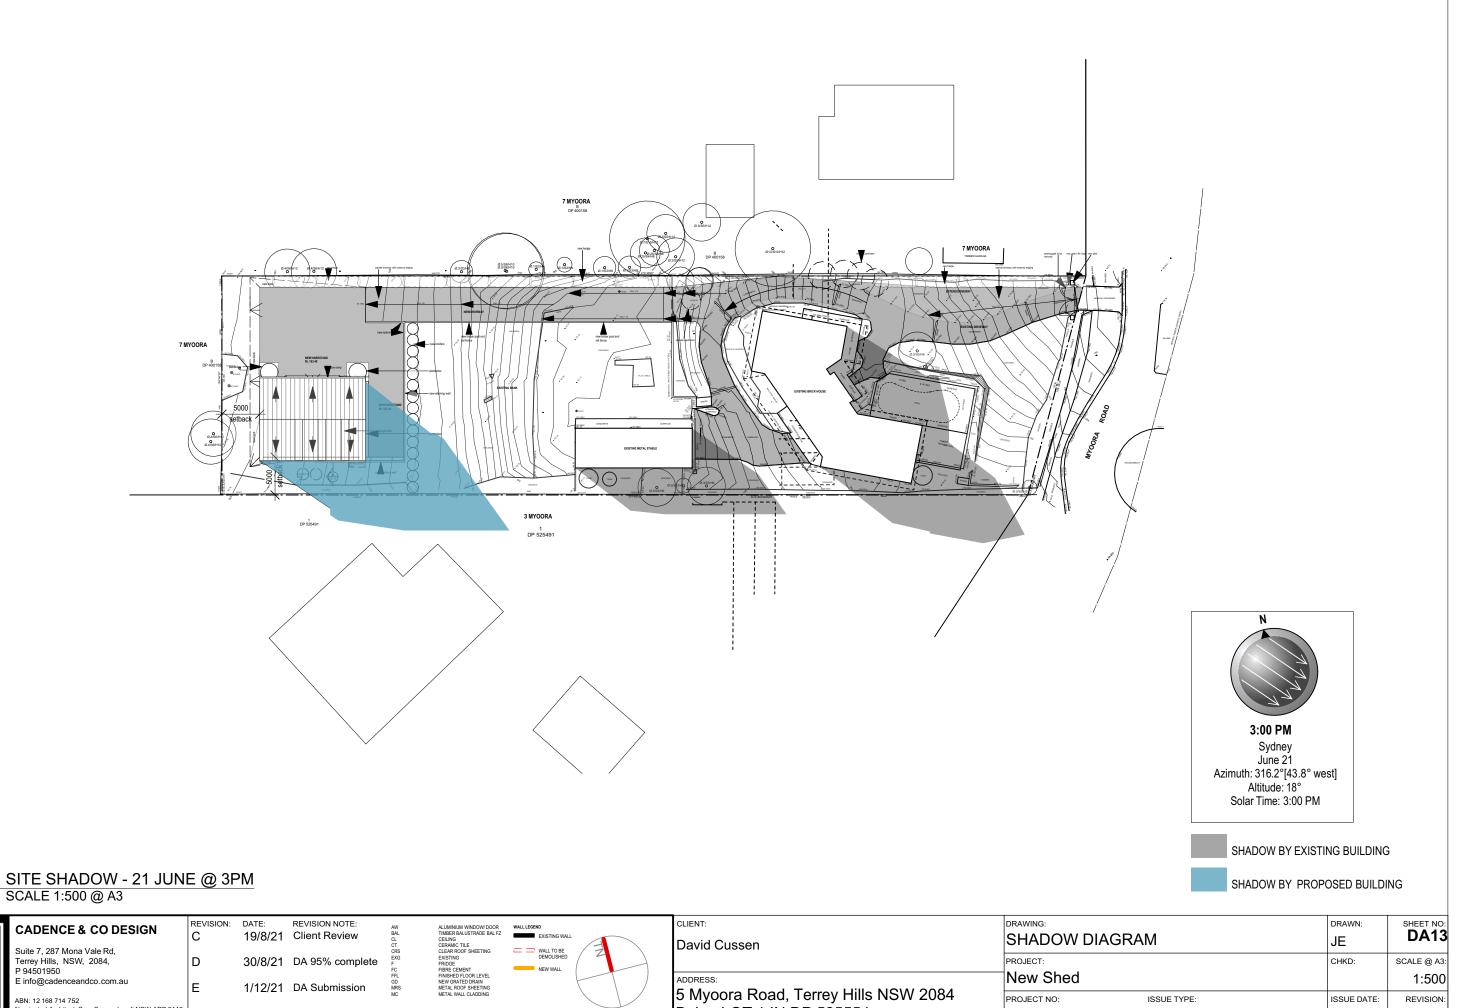ISSUE TYPE:

DA

ISSUE DATE:

1/12/21

REVISION:

Ε

GENERAL NOTES: ALL RL'S SHOWN ARE FINISHED LEVELS, BUILDER TO PROVIDE SET DOWNS & ALLOWANCES AS REQUIRED. ALL OPENING DIMENSIONS ARE NOMINAL, BUILDER TO CHECK SIZES ON-SITE BEFORE ORDERING WINDOW AND DOOR UNITS.

**CADENCE & CO** 


Nominated Architect: Sam Samarghandi NSW ARB 9112 Copyright © CADENCE & CO DESIGN PTY LTD





Dulux<sup>-</sup> C29 Colorbond® Monument®

Roof fascias & walls

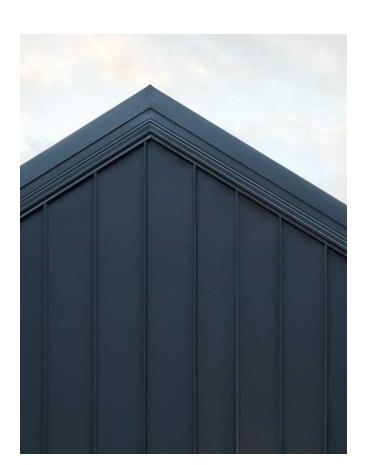

Metal wall cladding - profile tbc



Timber barn style sliding door



Aluminium powdercoat frame to windows



# CADENCE & CO DESIGN

Suite 7, 287 Mona Vale Rd, Terrey Hills, NSW, 2084, P 94501950

ominated Architect: Sam Samarghandi NSW ARB 9112 opyright © CADENCE & CO DESIGN PTY LTD

DATE: REVISION NOTE: 19/8/21 Client Review 30/8/21 DA 95% complete 1/12/21 DA Submission



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|   | Da   |
|   |      |
| ) | ADDI |
|   | 5 N  |

| CLIENT:      |  |  |
|--------------|--|--|
| David Cussen |  |  |

5 Myoora Road, Terrey Hills NSW 2084 Being LOT 1 IN DP 525554

| PRAWING:    |                      | DRAWN:      | SHEET NO   |
|-------------|----------------------|-------------|------------|
| EXTERNALI   | MATERIALS & FINISHES | JE          | DA14       |
| PROJECT:    |                      | CHKD:       | SCALE @ A3 |
| New Shed    |                      |             | NTS        |
| PROJECT NO: | ISSUE TYPE:          | ISSUE DATE: | REVISION   |
| CUS0821     | DA                   | 1/12/21     | E          |



Building Sustainability Index www.basix.nsw.gov.au

### Alterations and Additions

Certificate number: A429069\_02

This certificate confirms that the proposed development will meet the NSW government's requirements for sustainability, if it is built in accordance with the commitments set out below. Terms used in this certificate, or in the commitments, have the meaning given by the document entitled "BASIX Alterations and Additions Definitions" dated 06/10/2017 published by the Department. This document is available at www.basix.nsw.gov.au

#### Secreta

Date of issue: Wednesday, 01, December 2021
To be valid, this certificate must be lodged within 3 months of the date of issue.



project Project address Project name 5 Myoora Road\_02 Street address 5 Myoora Road Terry Hills 2084 Local Government Area Warringah Council Plan type and number Deposited Plan 525554 Lot number of Section number escription Project type Dwelling type Separate dwelling house My renovation work is valued at \$50,000 or more, and does not include a pool (and/or spa). Type of alteration and addition

page 1 / 6

| Certificate Prepared by (please complete before submitting to Council | or PCA |
|---|--------|
| Name / Company Name: Jane Anderson Architecture                       |        |
| ABN (if applicable): 79628347350                                      |        |

BASIX Certificate number: A429069\_02 page 2 / 6

Ď

| Tixtures and systems   | DA Plans | CC/CDC<br>Plans &<br>specs | Check |
|--|----------|----------------------------|-------|
| Lighting   |          |                            |       |
| The applicant must ensure a minimum of 40% of new or altered light fixtures are fitted with fluorescent, compact fluorescent, or light-emitting-diode (LED) lamps. |          | ~                          | ~     |
| Fixtures   |          |                            |       |
| The applicant must ensure new or altered showerheads have a flow rate no greater than 9 litres per minute or a 3 star water rating.                                |          | ~                          | ~     |
| The applicant must ensure new or altered toilets have a flow rate no greater than 4 litres per average flush or a minimum 3 star water rating.                     |          | ~                          | ~     |
| The applicant must ensure new or altered taps have a flow rate no greater than 9 litres per minute or minimum 3 star water rating.                                 |          | ~                          |       |

BASIX Certificate number: A429069\_02 page 3 / 6

| Construction  | Show on<br>DA Plans                             | Show on<br>CC/CDC<br>Plans &<br>specs  | Certifier<br>Check |   |          |
|---|---|--|--------------------|---|----------|
| Insulation requirements                                 |   |  |                    |   |          |
|   | ation is not required where the area of new con | ofs) in accordance with the specifications listed in instruction is less than 2m2, b) insulation specified | ~                  | ~ | <b>V</b> |
| Construction  | Additional insulation required (R-value)        | Other specifications   |                    |   |          |
| concrete slab on ground floor.                          | nil   |  |                    |   |          |
| external wall: framed (weatherboard, fibro, metal clad) | R1.30 (or R1.70 including construction)         |  |                    |   |          |

BASIX Certificate number: A429069\_02 page 4 / 6

| Glazing req                     | uirements                        |                               |                           |                            |   |  | Show on<br>DA Plans | Show on<br>CC/CDC<br>Plans &<br>specs | Certifier<br>Check |
|---------------------------------|----------------------------------|-------------------------------|---------------------------|----------------------------|---|--|---------------------|---------------------------------------|--------------------|
| Vindows an                      | d glazed do                      | ors                           |                           |                            |   |  |                     | 100                                   |                    |
|                                 |                                  |                               |                           |                            | shading devices, in accordance with or each window and glazed door. | the specifications listed in the table below.  | ~                   | ~                                     | ~                  |
| The following                   | requirements                     | must also                     | be satisfi                | ed in relatio              | n to each window and glazed door:                                   |  |                     | ~                                     | 1                  |
| have a U-valu                   | e and a Solar                    | Heat Gair                     | Coefficie                 | ent (SHGC)                 |   | d glass may either match the description, or, e below. Total system U-values and SHGCs   |                     | <b>✓</b>                              | ~                  |
| have a U-valu<br>must be calcu  | e and a Solar<br>lated in accord | Heat Gair<br>dance with       | n Coefficie<br>n National | ent (SHGC)<br>Fenestration | no greater than that listed in the tabl                             | ar glazing, or toned/air gap/clear glazing must<br>e below. Total system U-values and SHGCs<br>. The description is provided for information |                     | ~                                     | ~                  |
|                                 |                                  |                               |                           |                            | of each eave, pergola, verandah, balathan 2400 mm above the sill.   | cony or awning must be no more than 500 mm   | <b>V</b>            | <b>V</b>                              | ~                  |
| Pergolas with                   | polycarbonate                    | e roof or si                  | imilar tran               | slucent mat                | terial must have a shading coefficien                               | t of less than 0.35.   |                     | ~                                     | 1                  |
|                                 |                                  |                               |                           |                            | ne window or glazed door above whitens must not be more than 50 mm. | ch they are situated, unless the pergola also  |                     | ~                                     | ~                  |
| Overshadowir<br>specified in th |                                  |                               |                           |                            |   | the base of the window and glazed door, as   | ~                   | ~                                     | ~                  |
| Windows a                       | nd glazed                        | doors g                       | lazing r                  | equireme                   | ents  | 8 2  |                     |                                       |                    |
| Window / doo<br>no.             | r Orientation                    | Area of glass inc. frame (m2) | Oversha<br>Height<br>(m)  | Distance<br>(m)            | Shading device  | Frame and glass type   |                     |                                       |                    |
| W1                              | W                                | 1.2                           | 0                         | 0                          | eave/verandah/pergola/balcony<br>>=450 mm                           | standard aluminium, single pyrolytic low-e, (U-value: 5.7, SHGC: 0.47)   |                     |                                       |                    |
| W2                              | w                                | 1.2                           | 0                         | 0                          | eave/verandah/pergola/balcony<br>>=450 mm                           | standard aluminium, single pyrolytic low-e, (U-value: 5.7, SHGC: 0.47)   |                     |                                       |                    |

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| Glazing requ  | irements    |                                |               |                 |                |  | Show on<br>DA Plans | Show on<br>CC/CDC<br>Plans &<br>specs | Certifier<br>Check |
|---------------|-------------|--------------------------------|---------------|-----------------|----------------|--|---------------------|---------------------------------------|--------------------|
| Window / door | Orientation | Area of                        | Oversha       | adowing         | Shading device | Frame and glass type   |                     |                                       |                    |
| no.           |             | glass<br>inc.<br>frame<br>(m2) | Height<br>(m) | Distance<br>(m) | _              |  |                     |                                       |                    |
| W3            | W           | 0.9                            | 11            | 6               | none           | standard aluminium, single clear, (or U-value: 7.63, SHGC: 0.75) | ]                   |                                       |                    |
| W4            | S           | 0.8                            | 0             | 0               | none           | standard aluminium, single clear, (or U-value: 7.63, SHGC: 0.75) |                     |                                       |                    |
| W5            | W           | 0.8                            | 11            | 6               | none           | standard aluminium, single clear, (or U-value: 7.63, SHGC: 0.75) |                     |                                       |                    |
| W6            | E           | 8.0                            | 0             | 0               | none           | standard aluminium, single clear, (or U-value: 7.63, SHGC: 0.75) |                     |                                       |                    |

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ABN: 12 168 714 752 Nominated Architect: Sam Samarghandi NSW ARB 9112

REVISION: DATE: REVISION NOTE: C 19/8/21 Client Review

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30/8/21 DA 95% complete

1/12/21 DA Submission



| au  | CLIENT:                              |
|-----|--------------------------------------|
| 200 | David Cussen                         |
|     |                                      |
|     | ADDRESS:                             |
|     | 5 Myoora Road, Terrey Hills NSW 2084 |
|     | Being Lot Mode 525554                |

| DRAWING:    |             |                    | DRAWN:                  | SHEET NO:     |
|-------------|-------------|--------------------|-------------------------|---------------|
| BASIX CERT  | TIFICATE    |                    | JE                      | DA15          |
| PROJECT:    |             |                    | CHKD:                   | SCALE @ A3    |
| New Shed    |             |                    |                         | NTS           |
| PROJECT NO: | ISSUE TYPE: |                    | ISSUE DATE:             | REVISION:     |
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