


| element, that specification must apply to all instances of that ele | | | | | | | |
|---|---|-----------------|-------------|--|--|--|--|
| Windows | Glass | Frame | U value | | | | |
| Default | Single glazed, low E low solar gain | Aluminium | 5.6 | | | | |
| Default | Single glazed, low E high solar gain | Aluminium | 5.4 | | | | |
| | | | | | | | |
| Skylights | Glass | Frame | U value | | | | |
| | | | | | | | |
| External walls | Construction | Added Insula | ation | | | | |
| Cavity brick | | R 1.0 | | | | | |
| | | | | | | | |
| Internal walls | Construction | Added Insula | ation | | | | |
| Stud Framed | | Nome | | | | | |
| Brick | | None | | | | | |
| | | | | | | | |
| Floors | Construction | Added Insula | ation | | | | |
| Concrete | | R1.0 | | | | | |
| Concrete | | R2_0 | | | | | |
| | | | | | | | |
| Ceilings | Construction | Added Insula | ntion | | | | |
| Plasterboard | Construction | None | luon | | | | |
| Plasterboard | | R4.0 | | | | | |
| Master Doard | | N4.V | | | | | |
| Roof | Construction | Added Insula | ation | | | | |
| Metal sheeting | | (refer to ceili | ng detail) | | | | |
| Other Requirer | ments | | | | | | |
| All and an und from | | diadt to be and | مر مر المرا | | | | |



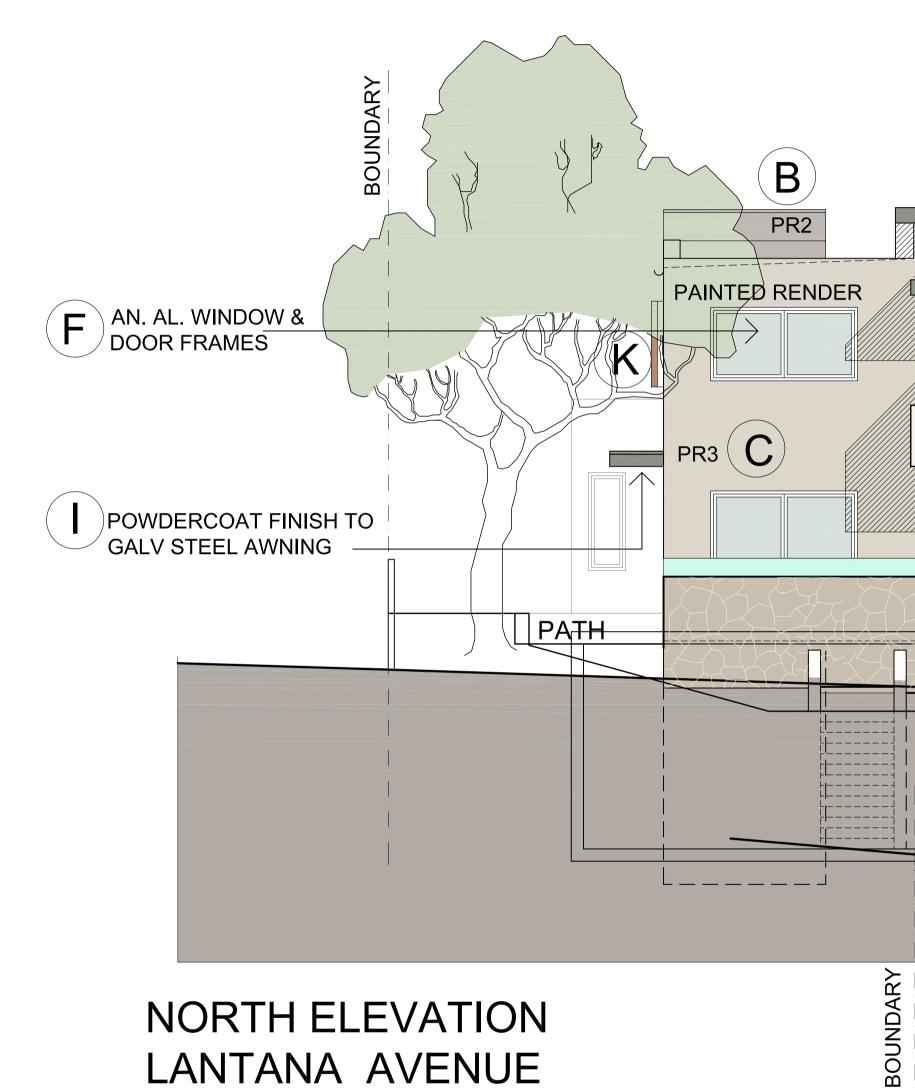


NORTH ELEVATION LANTANA AVENUE



(E) SANDSTONE CLADDING



(F) "SATIN SPANISH SILVER" ANODISED ALUMINIUM

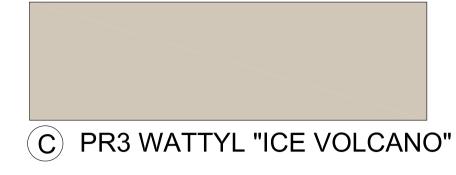



NDARY UNIT 1/2 HI-LIGHT WINDOW PR3 Y SL ↑ PRIVACY SCREEN PR¹ (\mathbf{A}) (\mathbf{H}) GLAZED 212 BALUSTRADE STONE CLADDING E RAMP EXISTING GROUND LINE AT BOUNDARY ADJACENT SHARED DRIVEWAY DRIVEWAY BOUNDARY EXISTING GROUND LINE AT LANTANA AVE

EXTERNAL FINISHES & COLOURS SCHEDULE

PR1 PAINTED RENDER (\mathbf{A})

DRIVEWAY BOUNDARY

- B PR2 PAINTED RENDER
- \bigcirc PR3 PAINTED RENDER
- \bigcirc METAL ROOFING, FLASHINGS & DP'S
- E STONE CLADDING
- F **DOOR & WINDOW FRAMES**
- G HANDRAILS

K


- (\mathbf{H}) BALUSTRADE
- METAL AWNINGS
- J METAL PRIVACY SCREENS
 - TIMBER WINDOW SCREENS
- WATTYL "CHALKDU WATTYL "CASTLE G WATTYL "ICE VOLC COLORBOND "WIND **IRREGULAR SANDS "SATIN SPANISH SII** SATIN STAINLESS S GLAZED POWDERCOAT "CO POWDERCOAT "CO TIMBER


| Architects Suite 25A, 2 Beattie Street, Balmain, NSW, Australia, 2041 Phone: (612) 9855 8028 Fax: (612) 9810 01 Email: Info@barryush.com.au Www.barryrush.com.au Www.barryrush.com.au Client BAYVIEW LINKS PTY LTD CANO" DSPRAY" STONE LVER" ANODISED ALUMINIUM STEEL DLORBOND WINDSPRAY" DLORBOND SURFMIST" DLORBOND SURFMIST" DLORBOND SURFMIST" | | |
|---|--------------------|--|
| Architects Suite 25A, 2 Beattie Street, Balmain, NSW, Australia, 2041 Phone: (612) 9855 8028 Fax: (612) 9810 01 Email: Info@barryush.com.au Www.barryrush.com.au Www.barryrush.com.au Client BAYVIEW LINKS PTY LTD CANO" DSPRAY" STONE LVER" ANODISED ALUMINIUM STEEL DLORBOND WINDSPRAY" DLORBOND SURFMIST" DLORBOND SURFMIST" DLORBOND SURFMIST" | | ISSUE DATE AMENDMENTS |
| DSPRAY" STONE LVER" ANODISED ALUMINIUM STEEL DLORBOND WINDSPRAY" DLORBOND SURFMIST" Potted 16/09/2019 5:28 PM Job No 1704 Version DA Drawing No: A COPYRIGHT BRAAP/L | GREY" | Suite 25A, 2 Beattie Street, Balmain, NSW, Australia, 2041 Phone: (612) 9555 8028 Fax: (612) 9810 0161 Email: info@barryrush.com.au www.barryrush.com.au Client |
| STELL SCHEDULE Scale NTS Drawn B File DAb LANTANA Elevitest.dwgB Plotted 16/09/2019 5:28 PM Job No 1704 Version DA Drawing No: © COPYRIGHT BR&A P/L | DSPRAY" STONE | 44 ROSE AVE & 43 LANTANA AVE WHEELER HEIGHTS LOT 4 IN DP 203378 & LOT 4 IN DP 26532 |
| File DAb LANTANA EleVationest.dwgB Plotted 16/09/2019 5:28 PM Job No 1704 Version DA Drawing No: © COPYRIGHT BR&A P/L | STEEL | |
| Plotted 16/09/2019 5:28 PM Job No 1704 Version DA Drawing No: | LORBOND WINDSPRAY" | |
| Job No 1704 Version DA Drawing No: | ORBOND SURFMIST" | |
| | | Job No 1704 |
| Do not scale off this drawing. Use figured dimensions Verify all dimensions on site. | | © COPYRIGHT BR&A P/L Do not scale off this drawing. Use figured dimensions only. |


THIS PLAN IS TO BE READ IN CONJUNCTION WITH THE CONDITIONS OF DEVELOPMENT CONSENT


DA2019/1136

northern beaches council

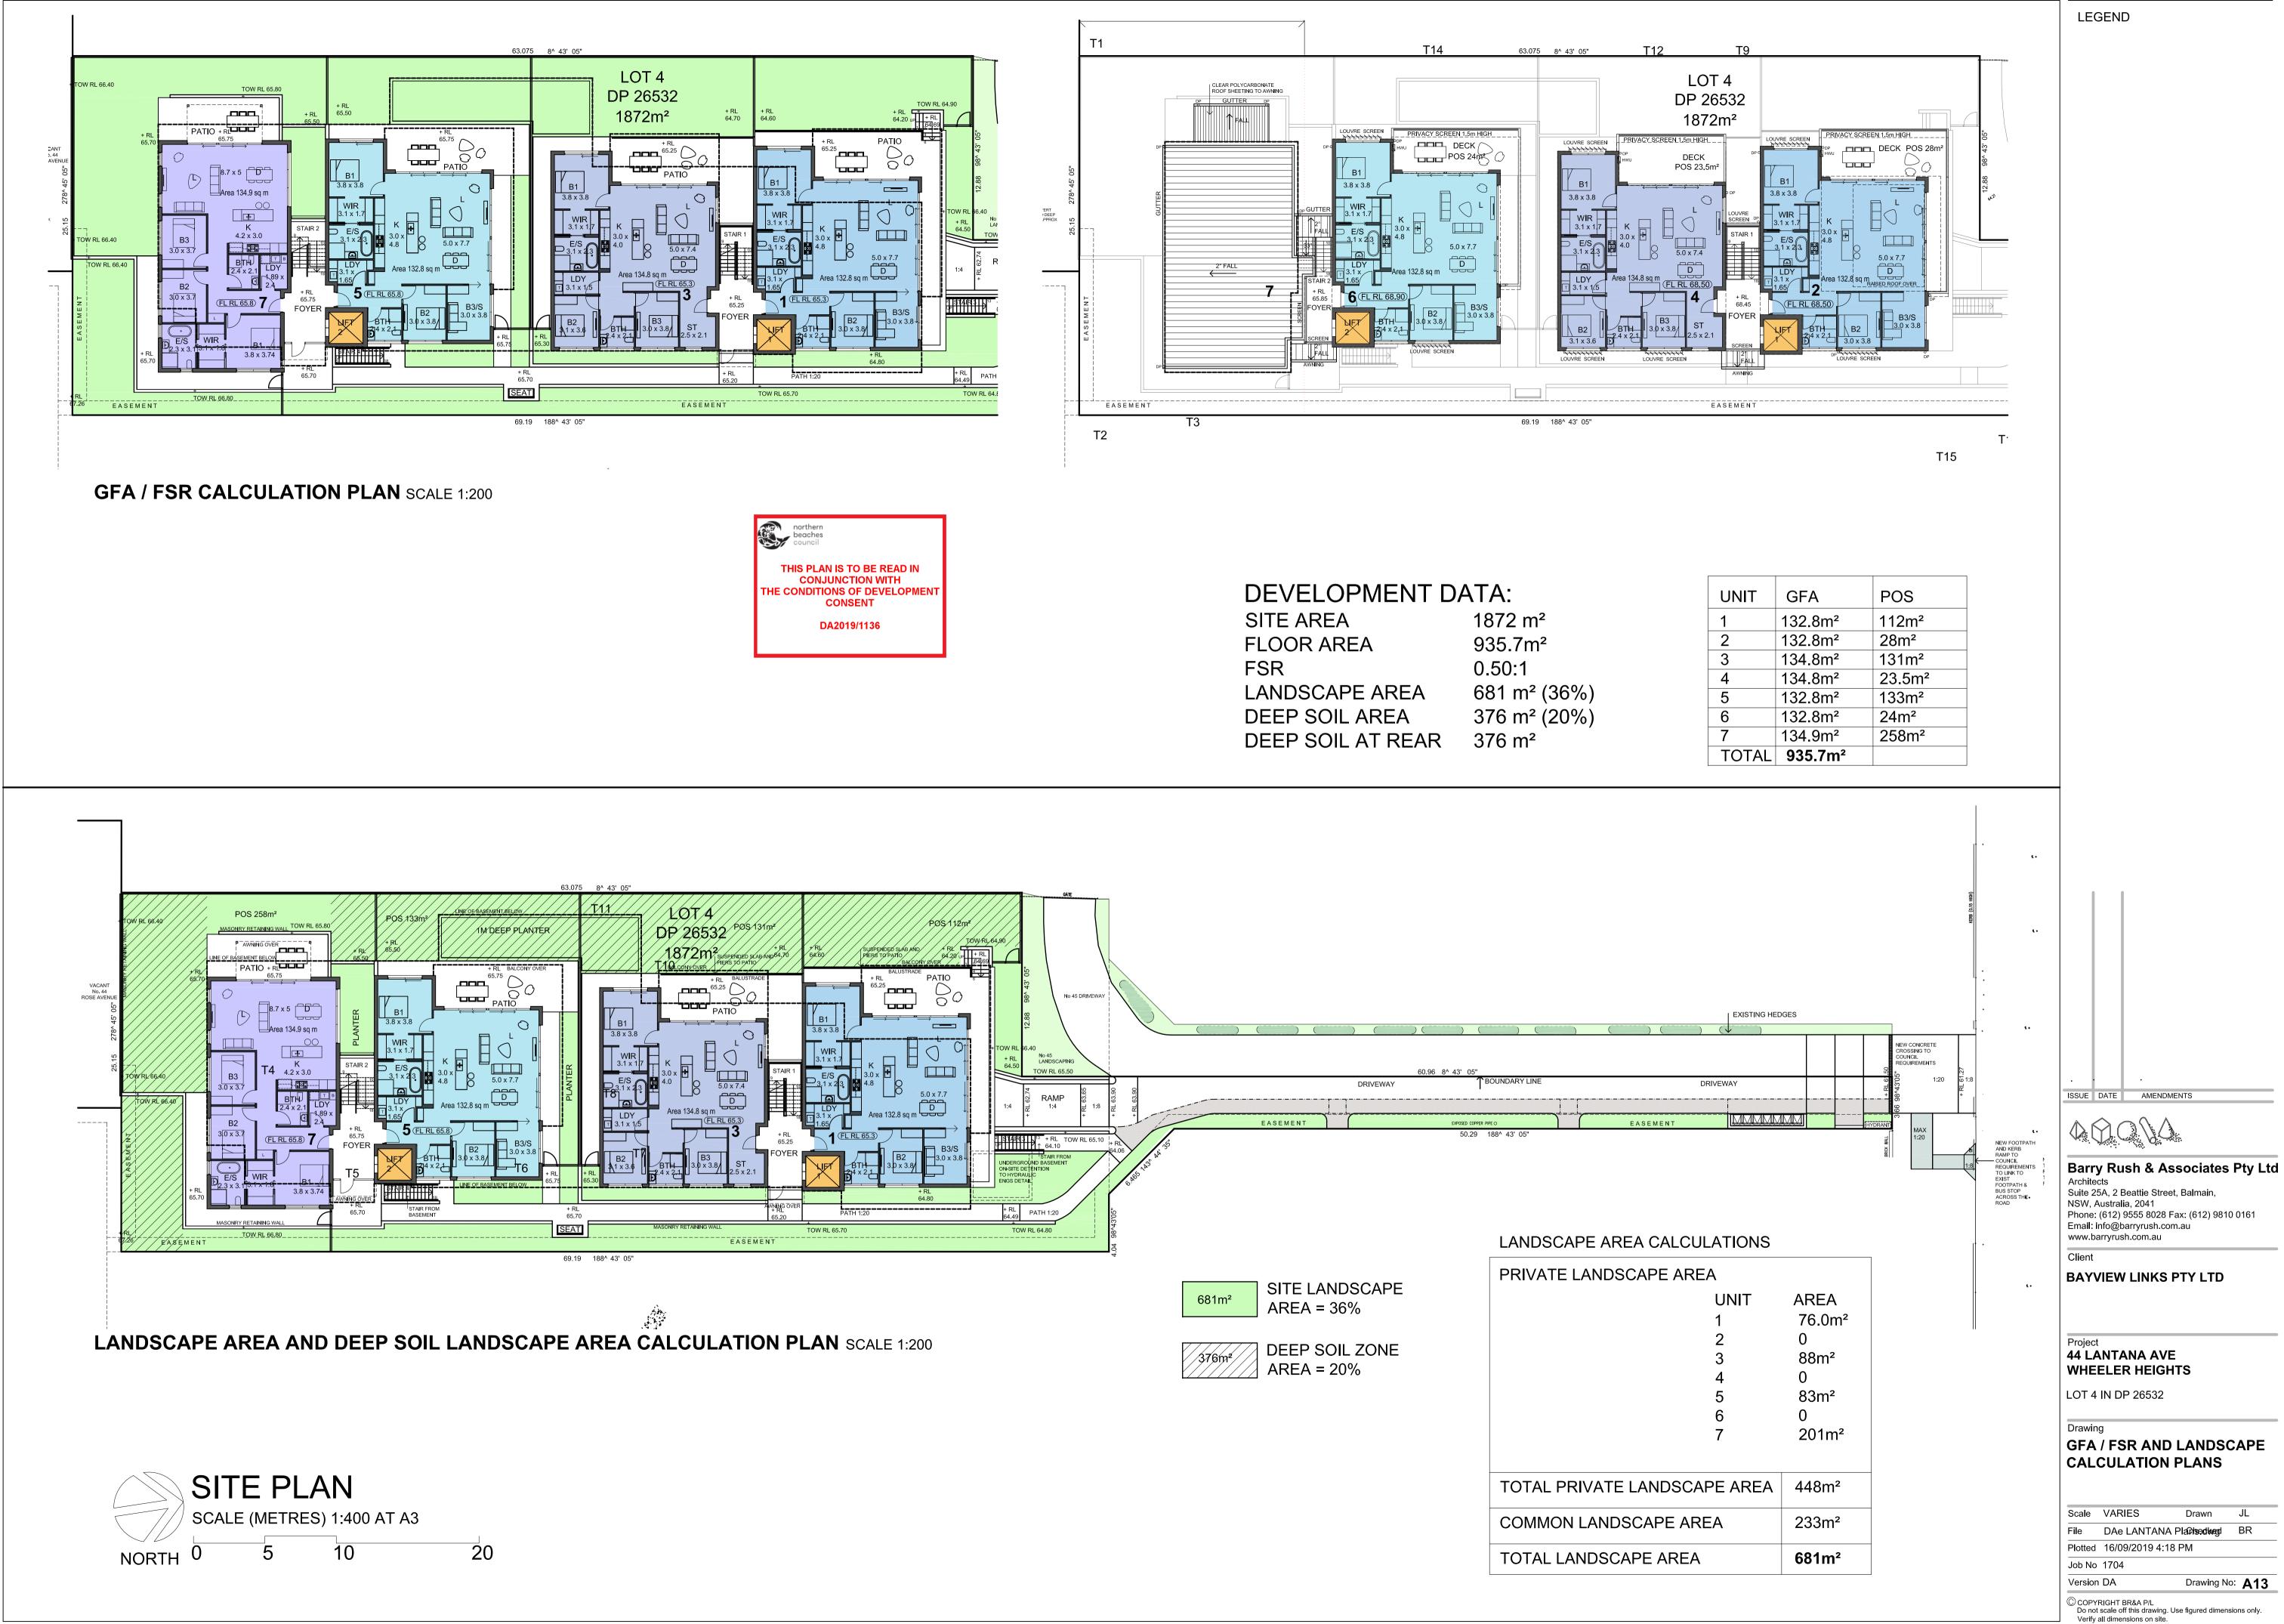

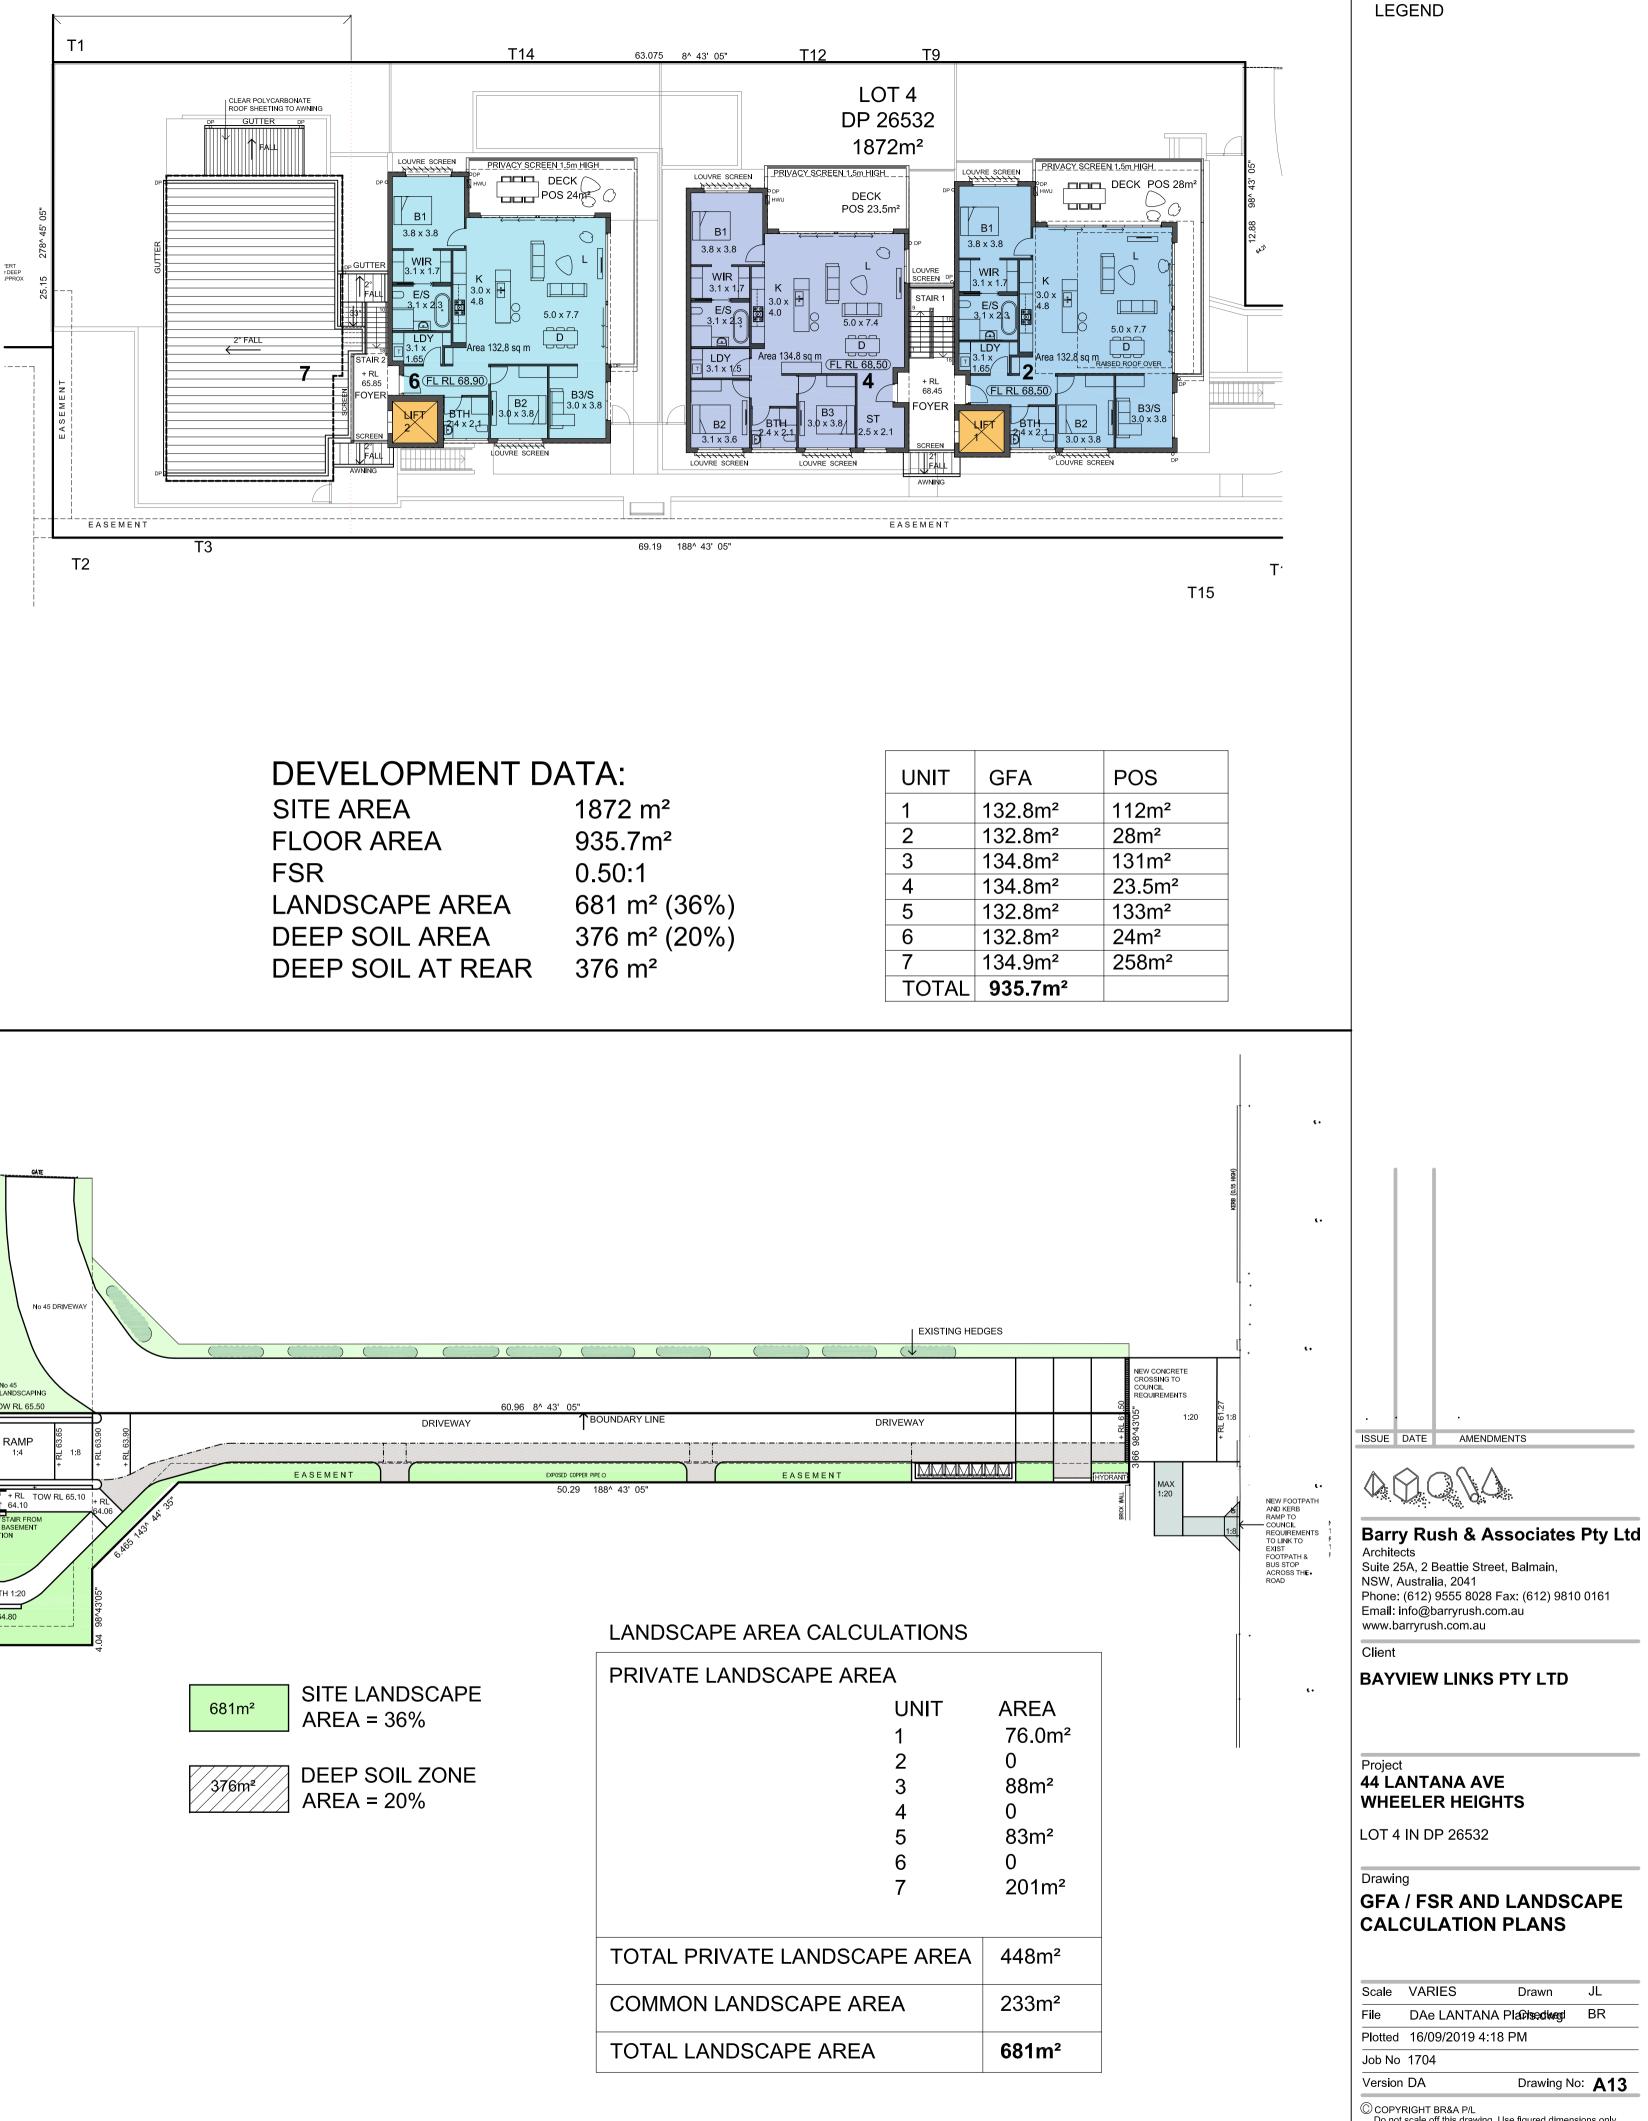

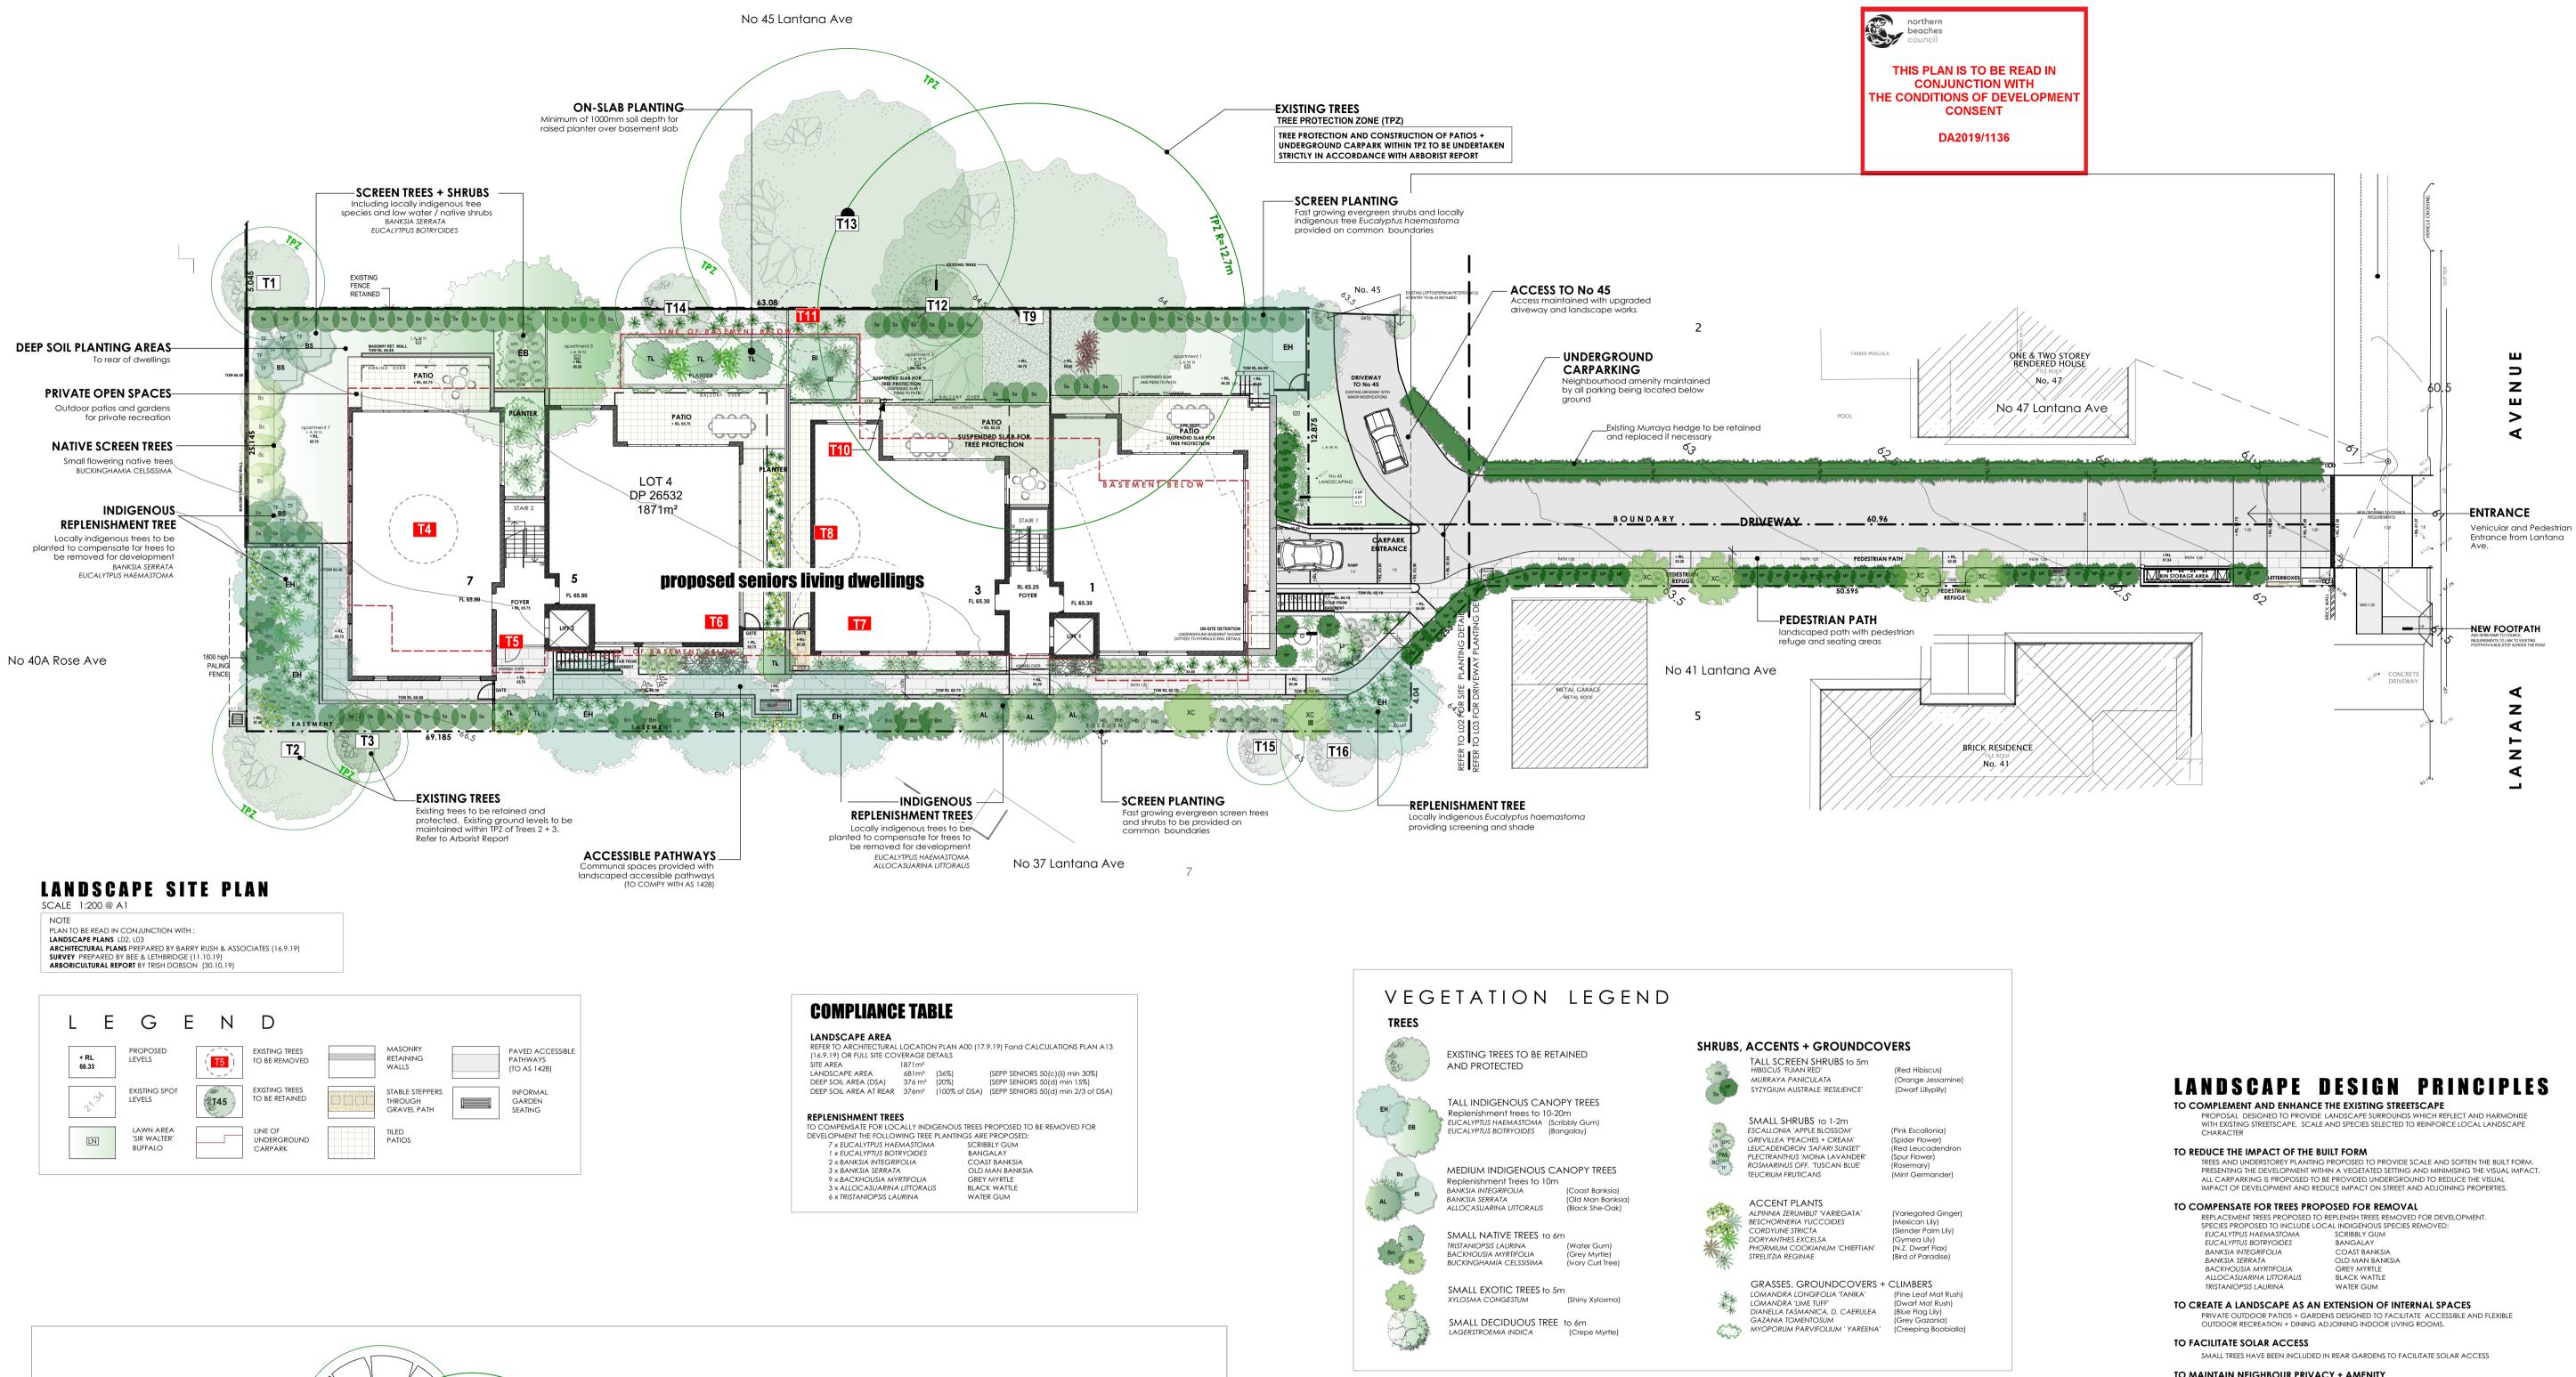

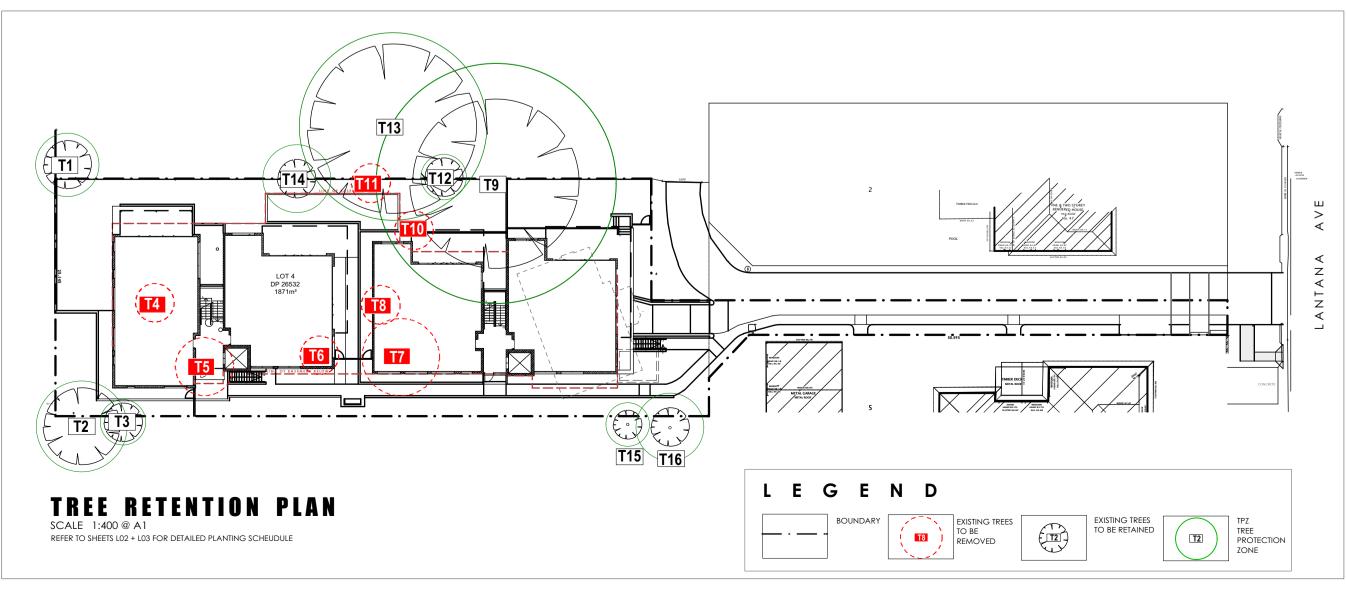

| IGENOUS CAI | NOPY TREES | | | | | |
|----------------|-------------------|--|--|--|--|--|
| t Trees to 10m | | | | | | |
| FOLIA | (Coast Banksia) | | | | | |
| 4 | (Old Man Banksia) | | | | | |
| LITTORALIS | (Black She-Oak) | | | | | |
| | | | | | | |
| | | | | | | |
| 'E TREES to 6m | | | | | | |

| JM 'CHIEFTIAN' | (Gymea Lily) (N.Z. Dwarf Flax) (Bird of Paradise) |
|----------------|---|
| NDCOVERS + | CLIMBERS |
| LIA 'TANIKA' | (Fine Leaf Mat Rush |
| 2 | (Dwarf Mat Rush) |
| , D. CAERULEA | (Blue Flag Lily) |
| | |

| EXISTING TREE SCHEDULE | | T18 EXISTING TREES TO BE RETAINED AND PROTECTED | | | TO BE RE | TAINED | EXISTING TREES TO BE REMOVED | | |
|------------------------|--------------------------|---|--------|--------|----------|--------|---------------------------------|------------|---|
| NO | SPECIES | COMMON NAME | DBH | HEIGHT | SPREAD | TPZ | SRZ | Ret. Value | STATUS |
| T1 | SYZYGIUM PANICULATUM cv. | DWARF LILLYPILLY | 280mm | 5m | 5m | 3.4m | 2.1m | LOW | Retain + Protect to Arborist Specifications |
| T2 | BANKSIA INTEGRIFOLIA | COAST BANKSIA | 400mm | 10m | 8m | 4.8m | 2.5m | MOD | Retain + Protect to Arborist Specifications |
| Т3 | CALLISTEMON VIMINALIS | WEEPING BOTTLEBRUSH | 200mm | 5m | 4m | 2.4m | 2m | LOW | Retain + Protect to Arborist Specifications |
| T4 | EUCALYTPUS BOTRYOIDES | BANGALAY | 200mm | 6m | 3m | 2.4m | 2m | V LOW | Remove. Refer Arborist Report |
| T5 | CINNAMOMUM CAMPHORA | CAMPHOR LAUREL | 200mm | 8m | - | - | - | V.LOW | Remove. Noxious Weed |
| Т6 | CUPRESSUS SEMPERVIRENS | ITIALIAN CYPRESS | 300mm | 13m | 3m | 6.5m | 2.8m | V.LOW | Remove. Exempt Species |
| T7 | EUCALYPTUS HAEMASTOMA | SCRIBBLY GUM | 390mm | 7m | 8m | 4.7m | 2.4m | LOW | Remove. Refer Arborist Report |
| Т8 | CUPRESSUS TORULOSA | BHUTAN CYPRESS | 390mm | 10m | 4m | - | - | V.LOW | Remove. Exempt Species |
| Т9 | EUCALYPTUS BOTRYOIDES | BANGALAY | 1060mm | 20m | 18m | 12.7m | 3.5m | HIGH | Retain + Protect to Arborist Specifications |
| T10 | ALLOCASUARINA LITTORALIS | BLACK SHE-OAK | 220mm | 6m | 4m | 2.6m | 2m | V.LOW | Remove. Refer Arborist Report |
| T11 | ERYTHRINA CRISTA-GALLI | COCKSPUR CORAL TREE | 510mm | 7m | 8m | 6.1m | 3m | LOW | Remove. Exempt Species |
| T12 | CALLISTEMON SALIGNUS | WILLOW BOTTLEBRUSH | 200mm | 5m | 4m | 2.4m | 1.9m | LOW | Retain + Protect. Exempt Height |
| T13 | EUCALYPTUS BOTRYOIDES | BANGALAY | 800mm | 20m | 18m | 9.9m | | HIGH | Retain + Protect to Arborist Specifications |
| T14 | EUCALYPTUS HAEMASTOMA | SCRIBBLY GUM | 300mm | 5m | 4m | 3.6m | 2.1m | V.LOW | Retain + Protect to Arborist Specifications |
| T15 | METROSIDEROS EXCELSA | NZ XMAS BUSH | 200mm | 5m | 3m | 2.4m | - | LOW | Retain + Protect to Arborist Specifications |
| T16 | METROSIDEROS EXCELSA | NZ XMAS BUSH | 300mm | 5m | 4m | 3.6m | - | LOW | Retain + Protect to Arborist Specifications |



trish dobson landscape architecture 5/57 AVALON PARADE, AVALON NSW 2107 0408 983020 02-99188005 REGISTERED LANDSCAPE ARCHITECT #450 HORTICULTURIST ABN 57 241 486 158

DEVELOPMENT APPLICATION SEPP SENIORS RESIDENTIAL DEVELOPMENT

43 Lantana Aves, Wheeler Heights

| EUCALYTPUS HAEMASTOMA | SCRIBBLY GUM |
|--------------------------|---------------|
| EUCALYPTUS BOTRYOIDES | BANGALAY |
| BANKSIA INTEGRIFOLIA | COAST BANKSIA |
| BANKSIA SERRATA | old man bank |
| BACKHOUSIA MYRTIFOLIA | GREY MYRTLE |
| ALLOCASUARINA LITTORALIS | BLACK WATTLE |
| TRISTANIOPSIS LAURINA | WATER GUM |
| | |

- TO MAINTAIN NEIGHBOUR PRIVACY + AMENITY
- SCREEN PLANTING CONSISTING OF PRINCIPALLY NATIVE SPECIES PROPOSED TO PROVIDE PRIVACY SCREENING ON BOUNDARIES ADJOINING NEIGHBOURING DWELLINGS TO PROVIDE ACCESSIBILE ACCESS FOR SENIORS THROUGHOUT THE SITE
- ACCESSIBLE PATHWAYS, TERRACES AND LIFTS FROM UNDERGROUND CARPARK DESIGNED TO ENSURE SITE IS ACCESSIBLE THROUGHOUT. SAFE AND ATTRACTIVE PATHWAYS SHALL BE COMPLIANT WITH
- TO PROVIDE DEEP SOIL LANDSCAPE BOUNDARY BUFFER AREAS DEEP SOIL PLANTING BUFFER AREAS HAVE BEEN PROVIDED TO THE REAR OF DWELLINGS TO ALLOW FOR REPLENISHMENT CANOPY TREE PLANTING.
- TO ENHANCE THE LOCAL ECOLOGY SELECTION OF LOCALLY NATIVE TREES AND A VARIETY OF LOW GROWING + FLOWERING SHRUB SPECIES PROPOSED TO PRESERVE AND EXTEND THE LOCAL FLORA, PROVIDING HABITAT AND FORAGING OPPORTUNITIES FOR LOCAL FAUNA AND ATTRACTING BIRDLIFE TO SITE.
- TO ERADICATE NOXIOUS AND ENVIRONMENTAL WEEDS TREE REMOVAL AND LANDSCAPE WORKS TO INCLUDE ERADICATION AND MANAGEMENT OF ALL NOXIOUS + ENVIRONMENTAL WEEDS
- TO COMPLY WITH RELEVANT COUNCIL CONTROLS LANDSCAPE PLAN DESIGNED TO MEET LOCAL COUNCIL LEP + DCP OBJECTIVES AND CONTROLS AND SEPP SENIORS 2004 DESIGN PRINCIPLES

