

# **ACTION PLANS**

# 14 ERNEST STREET, BALGOWLAH HEIGHTS NSW 2093

m: 0426 957 518

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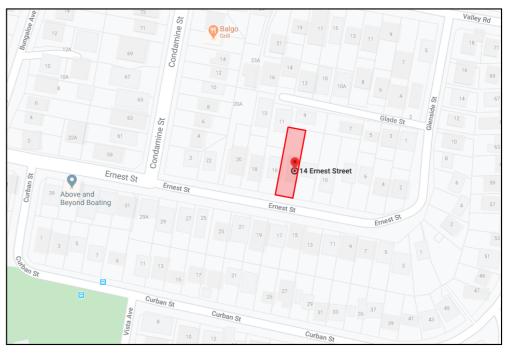
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## **DEVELOPMENT APPLICATION**

These plans are for Development Approval only.


SHEET NUMBER	SHEET NAME	DATE PUBLISHED
DA00	COVER	31/08/2020
DA01	SITE ANALYSIS	31/08/2020
DA02	${\tt SITE/ROOF/SEDIMENTEROSION/WASTEMANAGEMENT/STORMWATERCONCEPTPLAN}$	31/08/2020
DA03	EXISTING LOWER GROUND FLOOR PLAN	31/08/2020
DA04	EXISTING GROUND FLOOR PLAN	31/08/2020
DA05	PROPOSED LOWER GROUND FLOOR PLAN	31/08/2020
DA06	PROPOSED GROUND FLOOR PLAN	31/08/2020
DA07	PROPOSED FIRST FLOOR PLAN	31/08/2020
DA08	NORTH / SOUTH ELEVATION	31/08/2020
DA09	WEST ELEVATION	31/08/2020
DA10	EAST ELEVATION	31/08/2020
DA11	CROSS SECTION	31/08/2020
DA12	LONG SECTION	31/08/2020
DA13	POOL PLAN / POOL LONG SECTION	31/08/2020
DA14	DRIVEWAY PLAN / LONG SECTION / FRONT FENCE ELEVATION	31/08/2020
DA15	AREA CALCULATIONS	31/08/2020
DA16	FSR CALCULATIONS	31/08/2020
DA17	SAMPLE BOARD	31/08/2020
DA18	WINTER SOLSTICE 9 AM	31/08/2020
DA19	WINTER SOLSTICE 12 PM	31/08/2020
DA20	WINTER SOLSTICE 3 PM	31/08/2020
DA21	BASIX COMMITMENTS	31/08/2020

ITEM DETAILS	DEVELOPMENT APPLICATION						
ADDRESS	14 ERNEST STREET, BALGOWLAH HEIGHTS, NSW 2093						
LOT & DP/SP	LOT 15A DP 31138						
COUNCIL	NORTHERN BEACHES COUNCIL (MANLY)						
SITE AREA	875.3m²						
FRONTAGE	15.24m						
CONTROLS	PERMISSIBLE / REQUIRED	EXISTING	PROPOSED	COMPLIANCE			
CONTROLS	m / m² / %	m / m² / %	m / m² / %				
<u>LEP</u>							
LAND ZONING	R2 – LOW DENSITY RESIDENTIAL	R2	R2	YES			
MINIMUM LOT SIZE	500m²	875.3m <sup>2</sup>	UNCHANGED	YES			
FLOOR SPACE RATIO	0:45 : 1 (393.88m²)	0.162 : 1 (142.42m²)	0.314 : 1 (275.58m²)	YES			
MAXIMUM BUILDING HEIGHT	8.5m	6.10m	8.794m	NO			
<u>HAZARDS</u>							
	NOT IDENTIFEID						
<u>DCP</u>							
RESIDENTIAL OPEN SPACE	AREA OS3						
TOTAL OPEN SPACE (TOS)	55% (481.41m²)	50.4% (441.55m²)	53.7% (470.79m²)	NO (EXISTING)			
LANDSCAPE AREA	35% OF TOS (55%): 168.49m <sup>2</sup>	84.1% (405.07m²)	70.6% (339.89m²)	YES			
OPEN SPACE ABOVE GROUND	MAX. 40% OF TOS (55%): 192.56m <sup>2</sup>	6.42% (30.95m²)	10.8% (52.12m²)	YES			
PRINCIPAL PRIVATE OPEN SPACE	18m²	28.9m²	30.9m²	YES			
FRONT SETBACK	PREVALING BULDING LINE: 12.806m	HOUSE: 10.625m	H: UNCHANGED GARAGE: 6.962m	NO (EXISTING)			
REAR SETBACK	8.0m	28.756m	UNCHANGED	YES			
SIDE SETBACKS	1/3 WALL HEIGHT E: 2.050m W: 2.403m SIDE VARIATION SETBACK: 0.9m	E HOUSE: 1.348m W: 3.324m	E H: UNCHANGED E GARAGE: 0.9m W: UNCHANGED	NO (EXISTING) YES			
CAR PARKING SPACES	Required: 1	1	2	YES			



#### NCC & AS COMPLIANCES SPECIFICATIONS


- EARTHWORKS PART 3.1.1 OF NCC
- EARTH RETAINING STRUCTURES PART 3.1.2 OF NCC
- DRAINAGE PART 3.1.3 OF NCC
- TERMITE-RISK MANAGEMENT PART 3.1.4 OF NCC
- FOOTINGS & SLAB PART 3.2 OF NCC INCLUDING AS2870
- MASONRY PART 3.3 OF NCC INCLUDING AS3700
- FRAMING PART 3.4 OF NCC
- SUB FLOOR VENTILATION PART 3.4.1 OF NCC
- ROOF CLADDING AND WALL-CLADDING PART 3.5 OF NCC
- GLAZING PART 3.6 OF NCC INCLUDING AS1288
- FIRE SAFETY PART 3.7 OF NCC
- FIRE SEPERATION PART 3.7.2 OF NCC
- FIRE PROTECTION OF SEPERATING WALLS AND FLOORS- PART 3.7.3 OF NCC
- SMOKE ALARMS PART 3.7.5 OF NCC
- WET AREAS AND EXTERNAL WATERPROOFING PART 3.8.1 OF NCC
- ROOM HEIGHTS PART 3.8.2 OF NCC
- FACILITIES PART 3.8.3 OF NCC
- LIGHT PART 3.8.4 OF NCC
- VENTILATION PART 3.8.5 OF NCC
- SOUND INSULATION PART 3.8.6 OF NCC
- STAIRWAYAND RAMP CONSTRUCTION PART 3.9.1 OF NCC
- BARRIERS AND HANDRAILS PART 3.9.2 OF NCC
- SWIMMING POOLS PART 3.10.1 OF NCC
- CONSTRUCTION IN BUSHFIRE PRONE AREAS PART 3.10.5 OF NCC
- FENCING & OTHER PROVISIONS REGS & AS1926
- DEMOLITION WORKS AS2601-1991 THE DEMOLITION OF STRUCTURES.
- ALL WATERPROOF MEMBRANES TO COMPLY WITH WITH AS 3740-2010
- ALL PLUMBING & DRAINAGE WORK TO COMPLY WITH AS 3500
- SITE CLASSIFICATION AS TO AS 2870
- ALL PLASTERBOARD WORK TO COMPLY WITH AS 2588-1998
- ALL STRUCTURAL STEEL WORK TO COMPLY WITH AS 4100 & AS 1554
- ALL CONCRETE WORK TO COMPLY WITH AS 3600
- ALL ROOF SHEETING WORK TO COMPLY WITH AS 1562-1992
- ALL SKYLIGHTS TO COMPLY WITH WITH AS 4285-2007
- ALL CERAMIC TILING TO COMPLY WITH AS 3958.1-2007 & 3958.2-1992
- ALL GLAZING ASSEMBLIES TO COMPLY WITH AS2047 & 1288
- ALL TIMBER RETAINING WALLS ARE TO COMPLY WITH AS 1720.1-2010, AS 1720.2-2006, AS 1720.4-2006, AS 1170.1-1989 & AS 1170.4-2007
- ALL RETAINING WALLS ARE TO COMPLY WITH 3700 2011 & AS 3600 -2009
- ALL CONSTRUCTION TO COMPLY TO AS3959- 2009

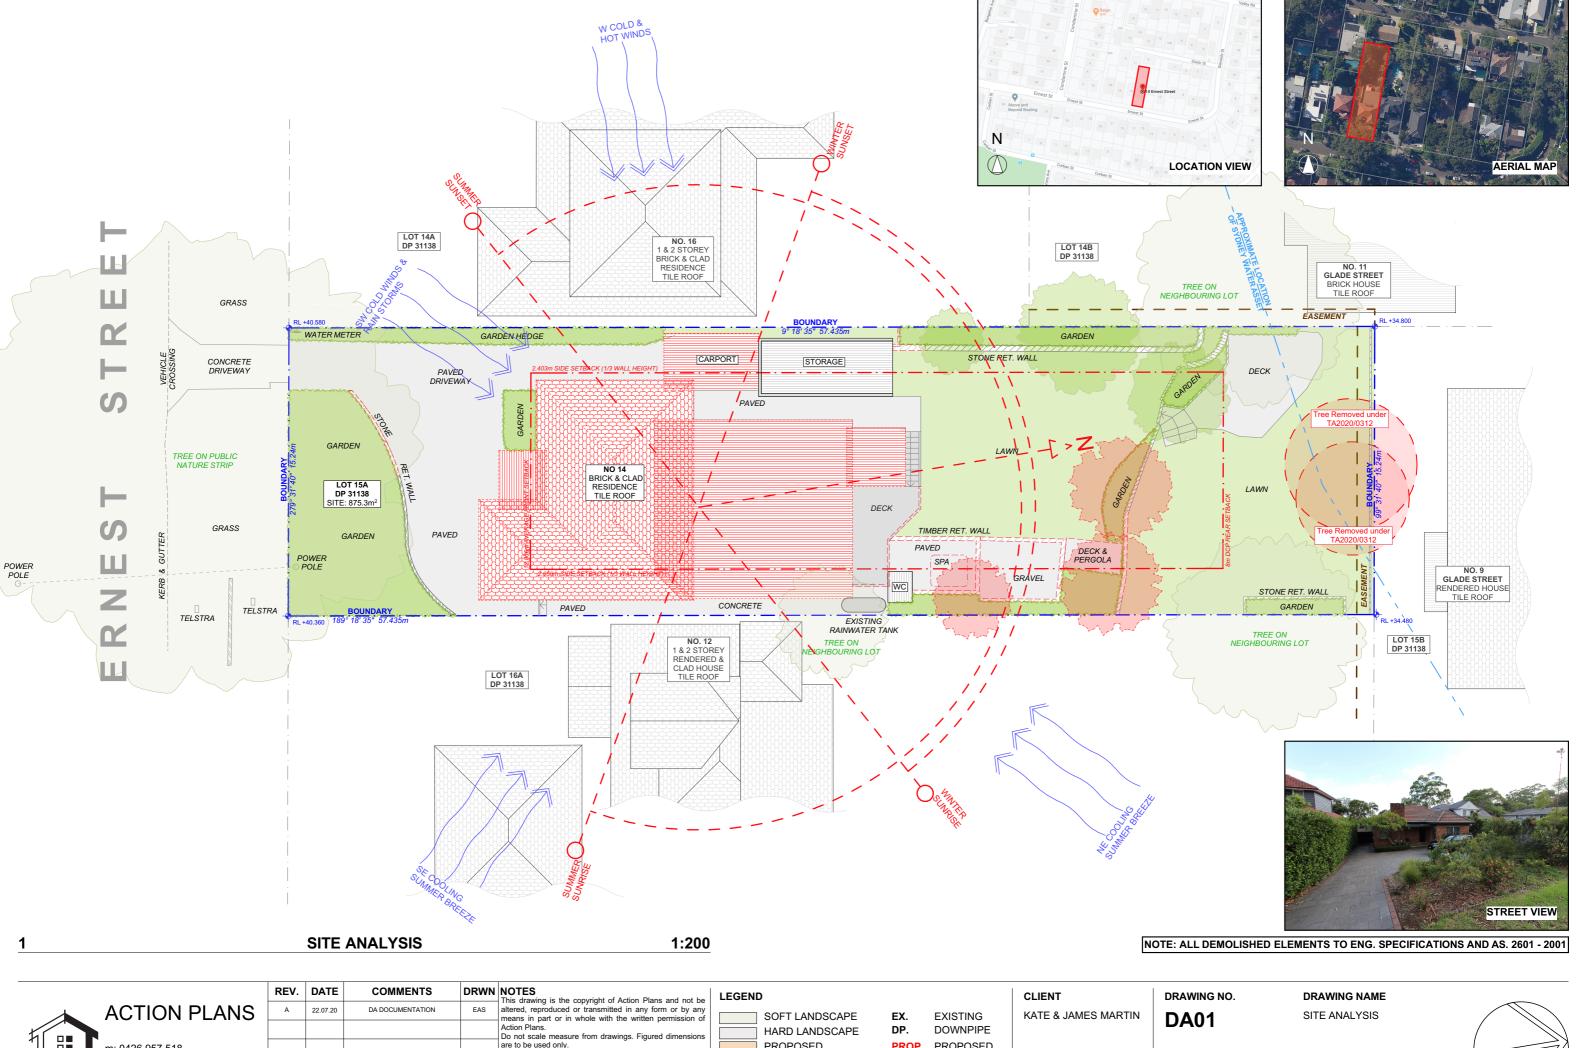



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Ī					All errors and omissions are to be verified by the Builder/Contractor and referred to the designer prior to the
٠					commencement of works.

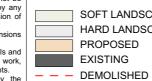

PROPOSED PROP. DP. DOWNPIPE


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DATE

Monday, 31 August 2020

SCALE

1:200 @A3



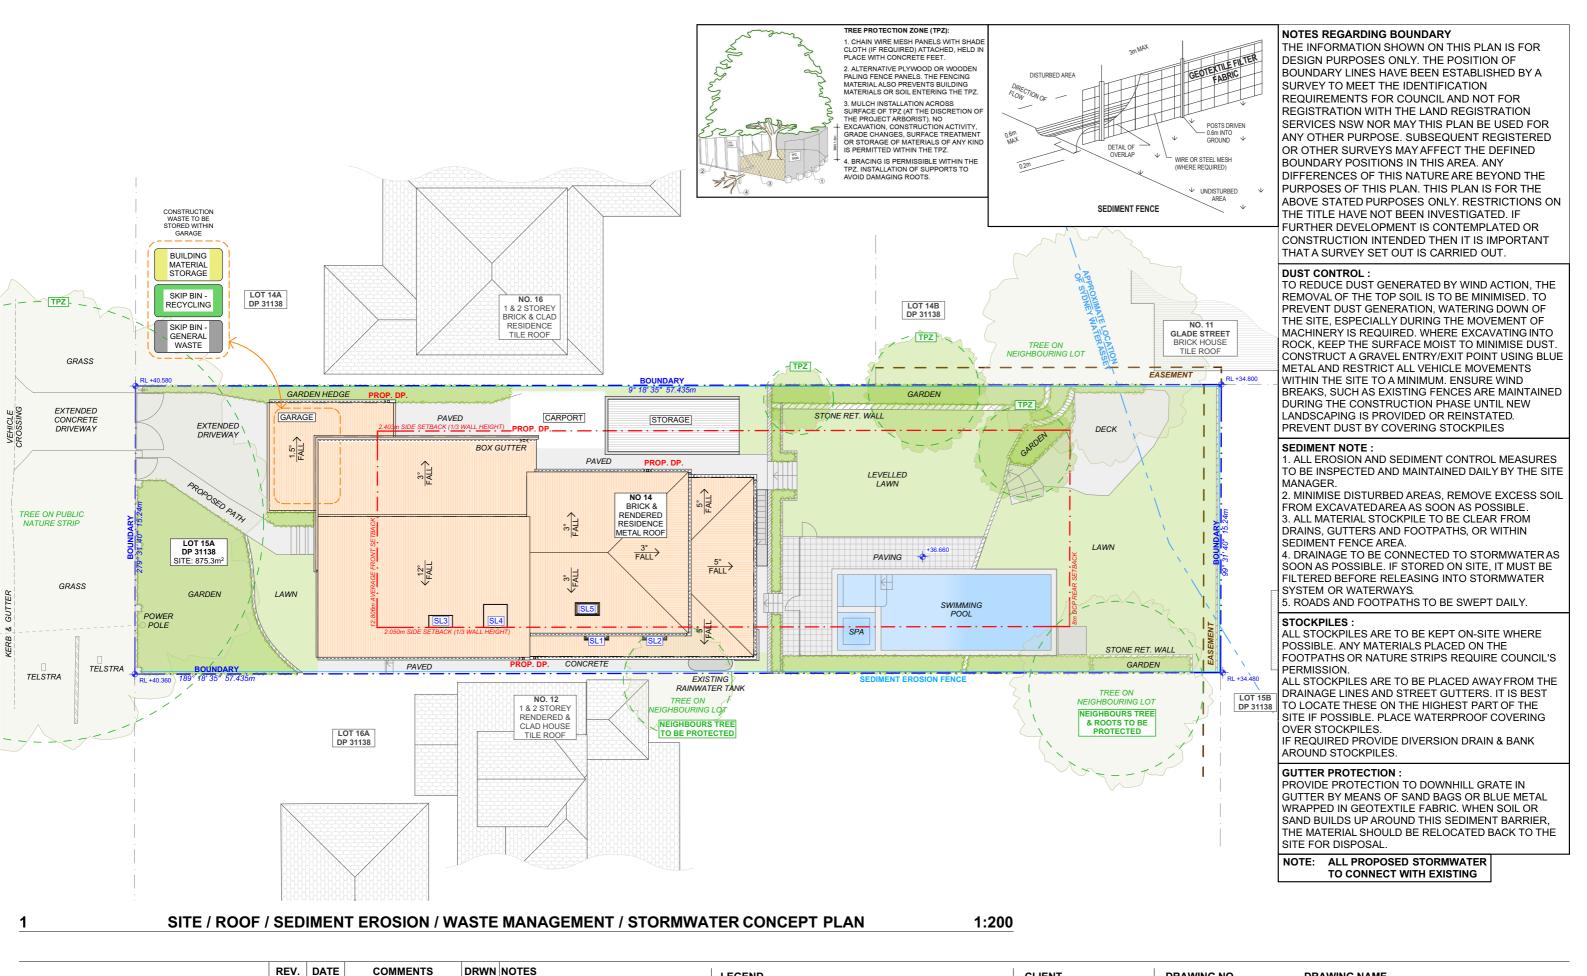

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EX. **EXISTING** DΡ DOWNPIPE PROP. PROPOSED DP. DOWNPIPE

KATE & JAMES MARTIN

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CLIENT

DRAWING NO. **DA02** 


DATE Monday, 31 August 2020


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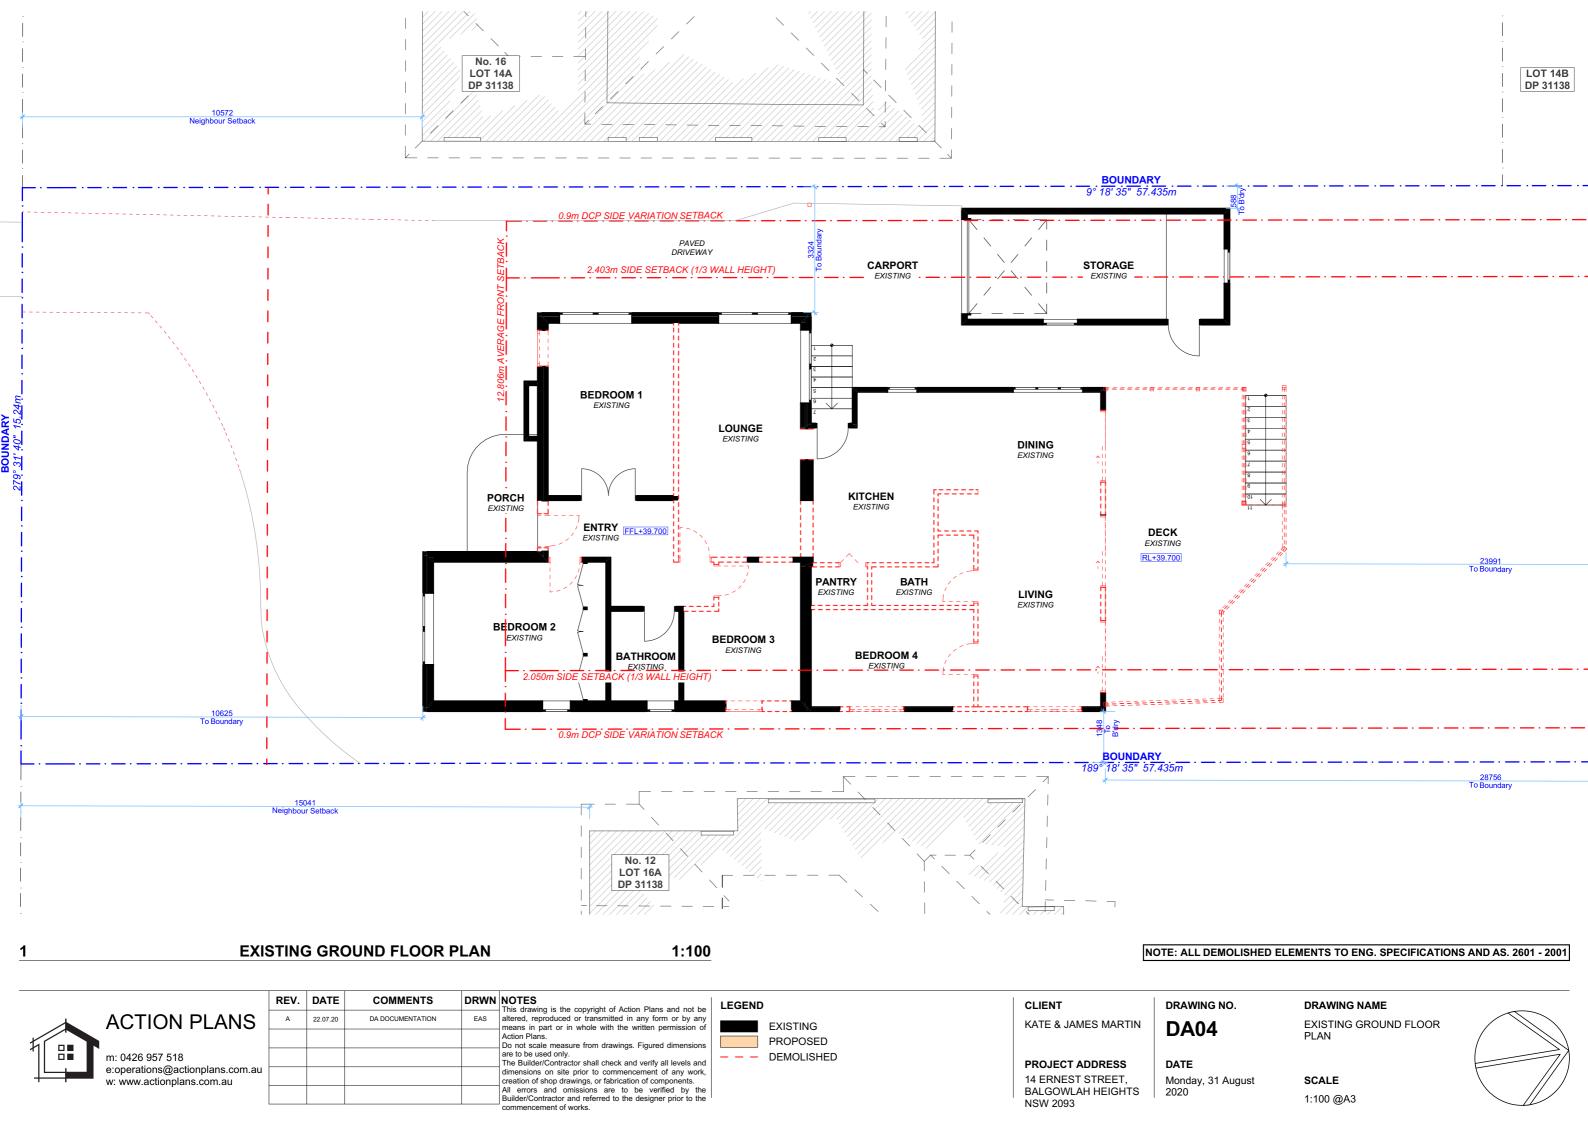
SITE / ROOF / SEDIMENT **EROSION / WASTE** MANAGEMENT / STORMWATER CONCEPT PLAN


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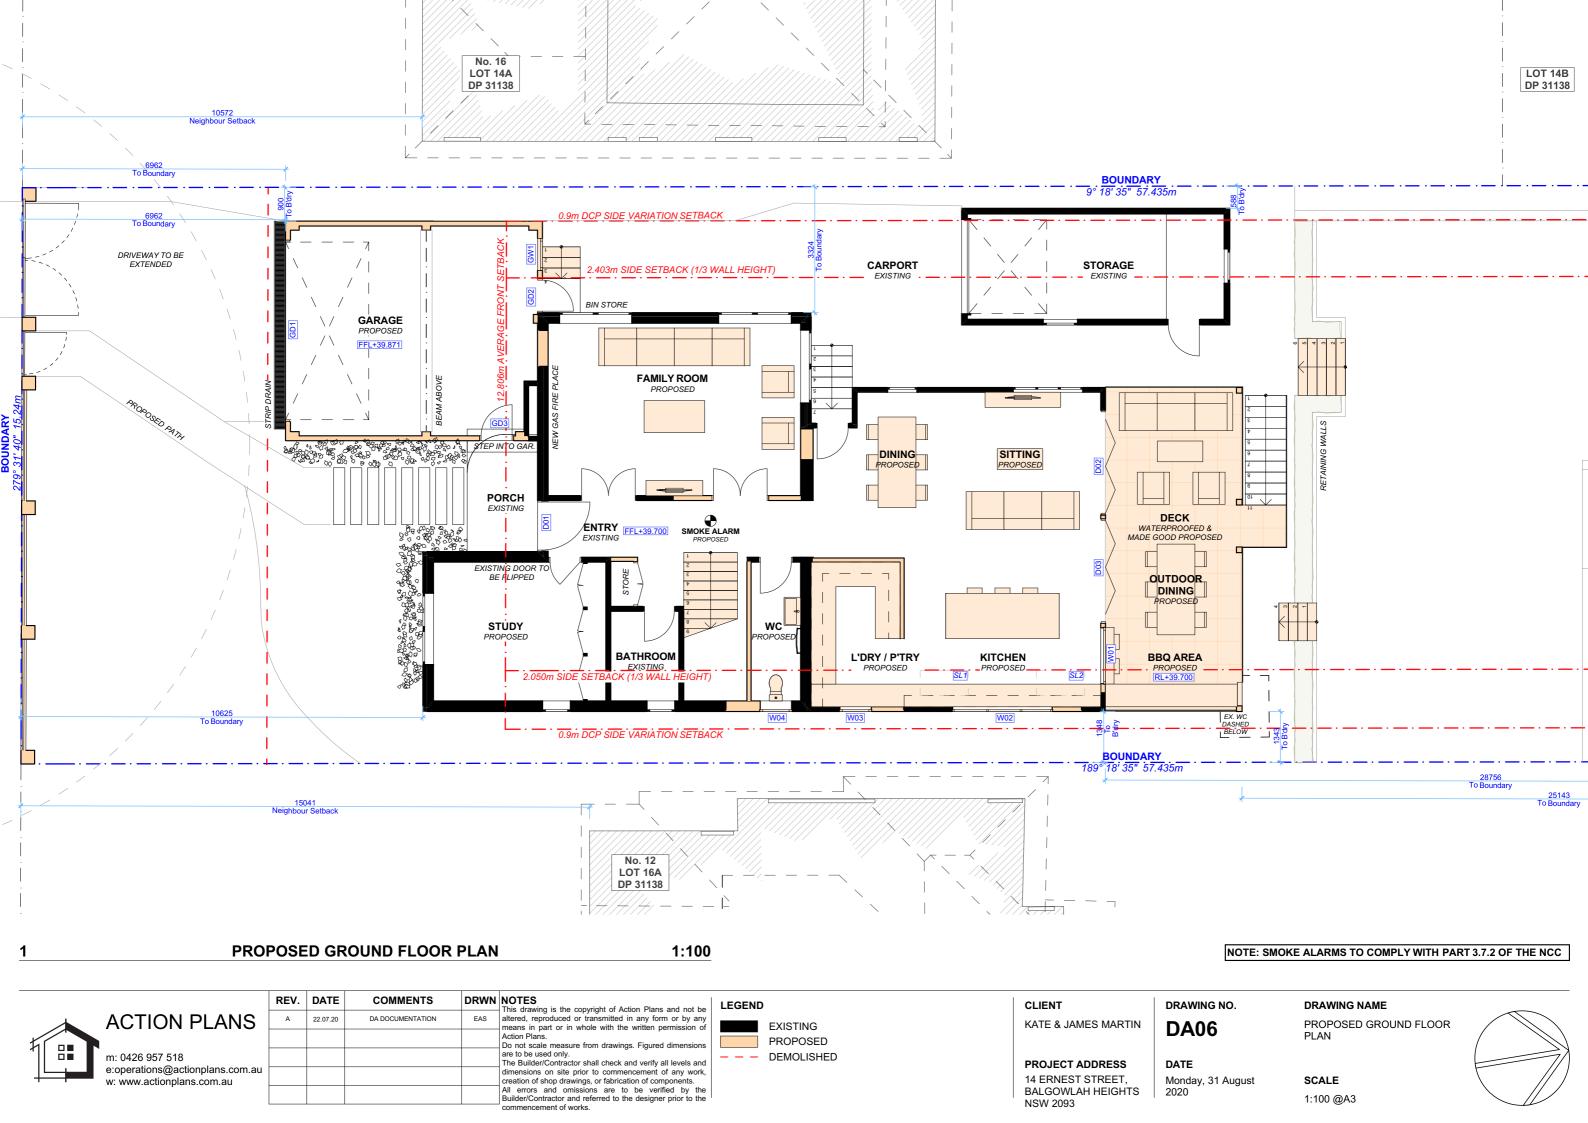
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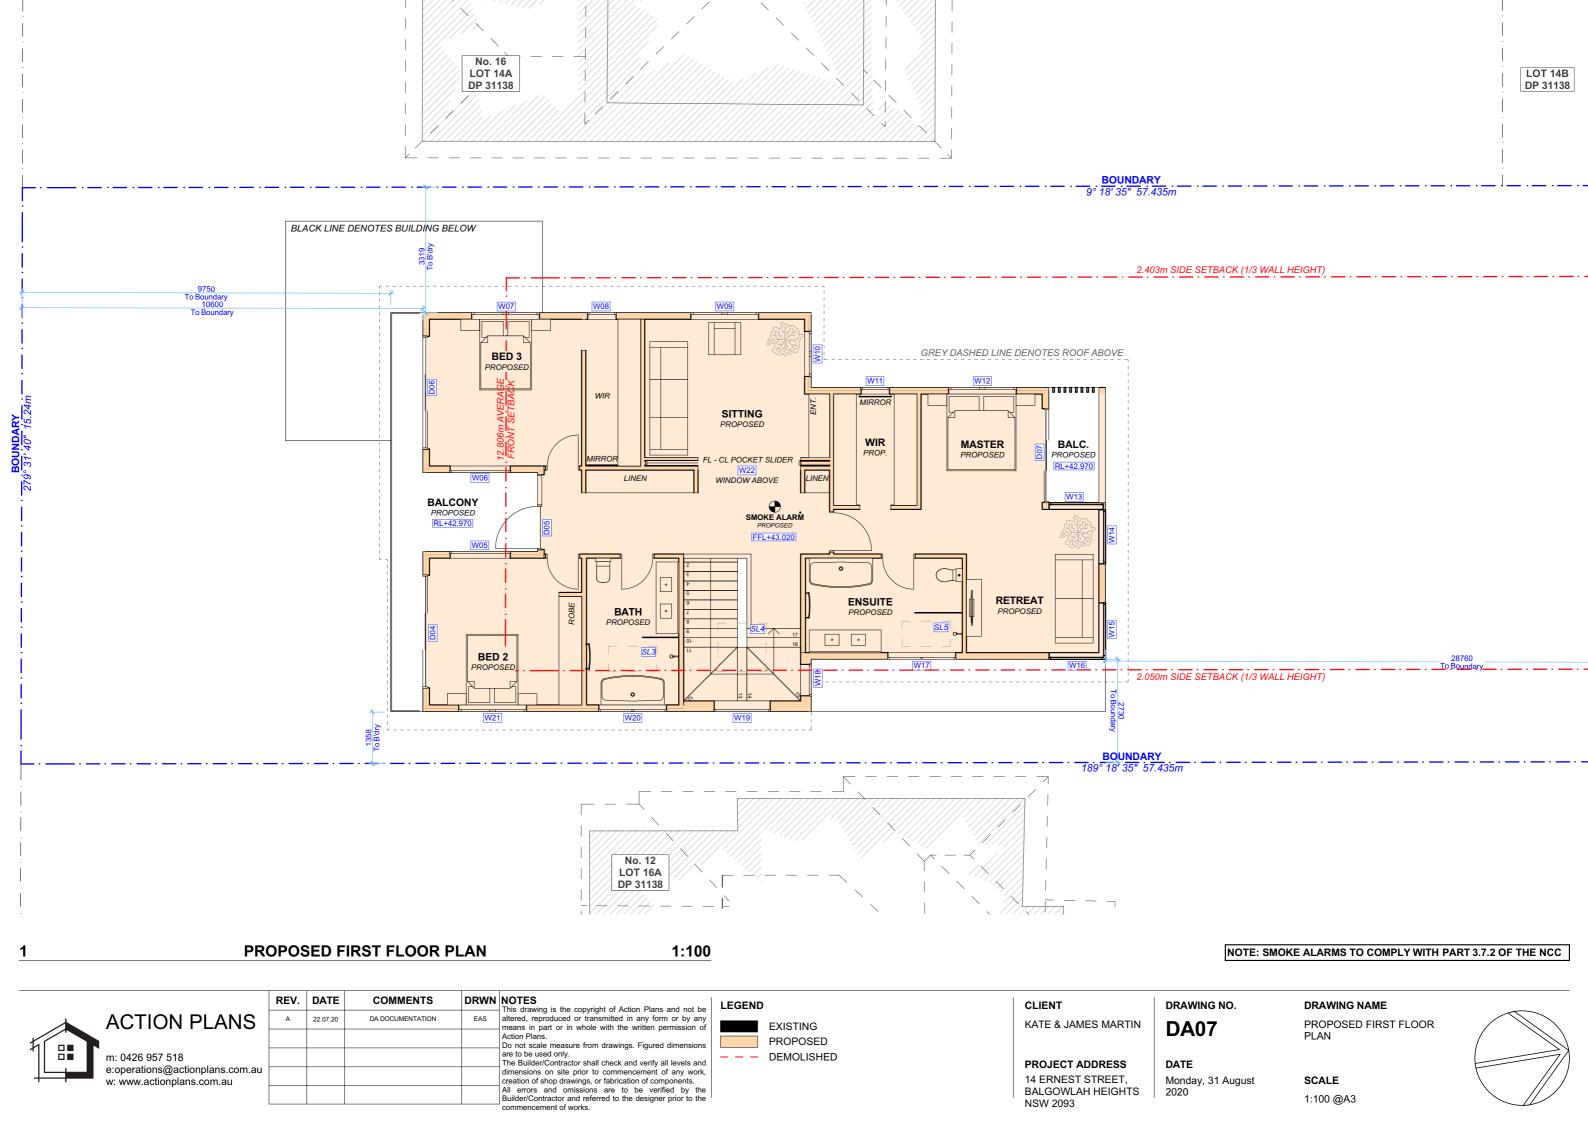







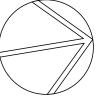

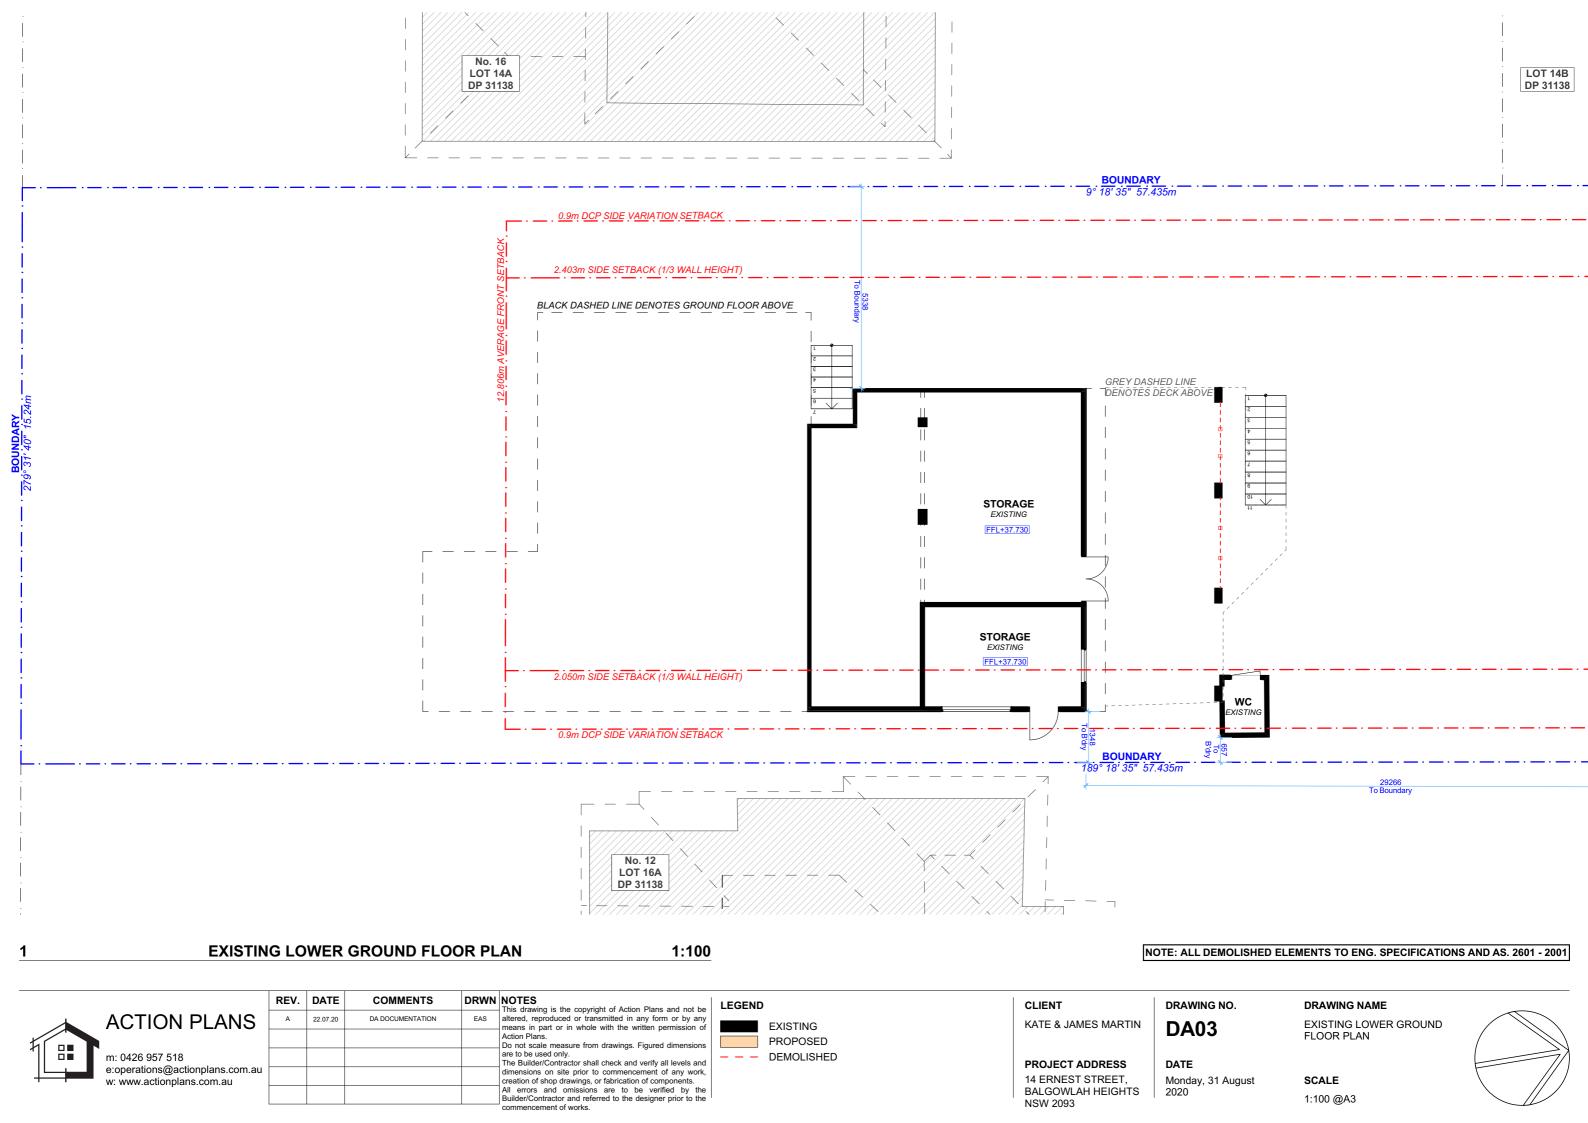


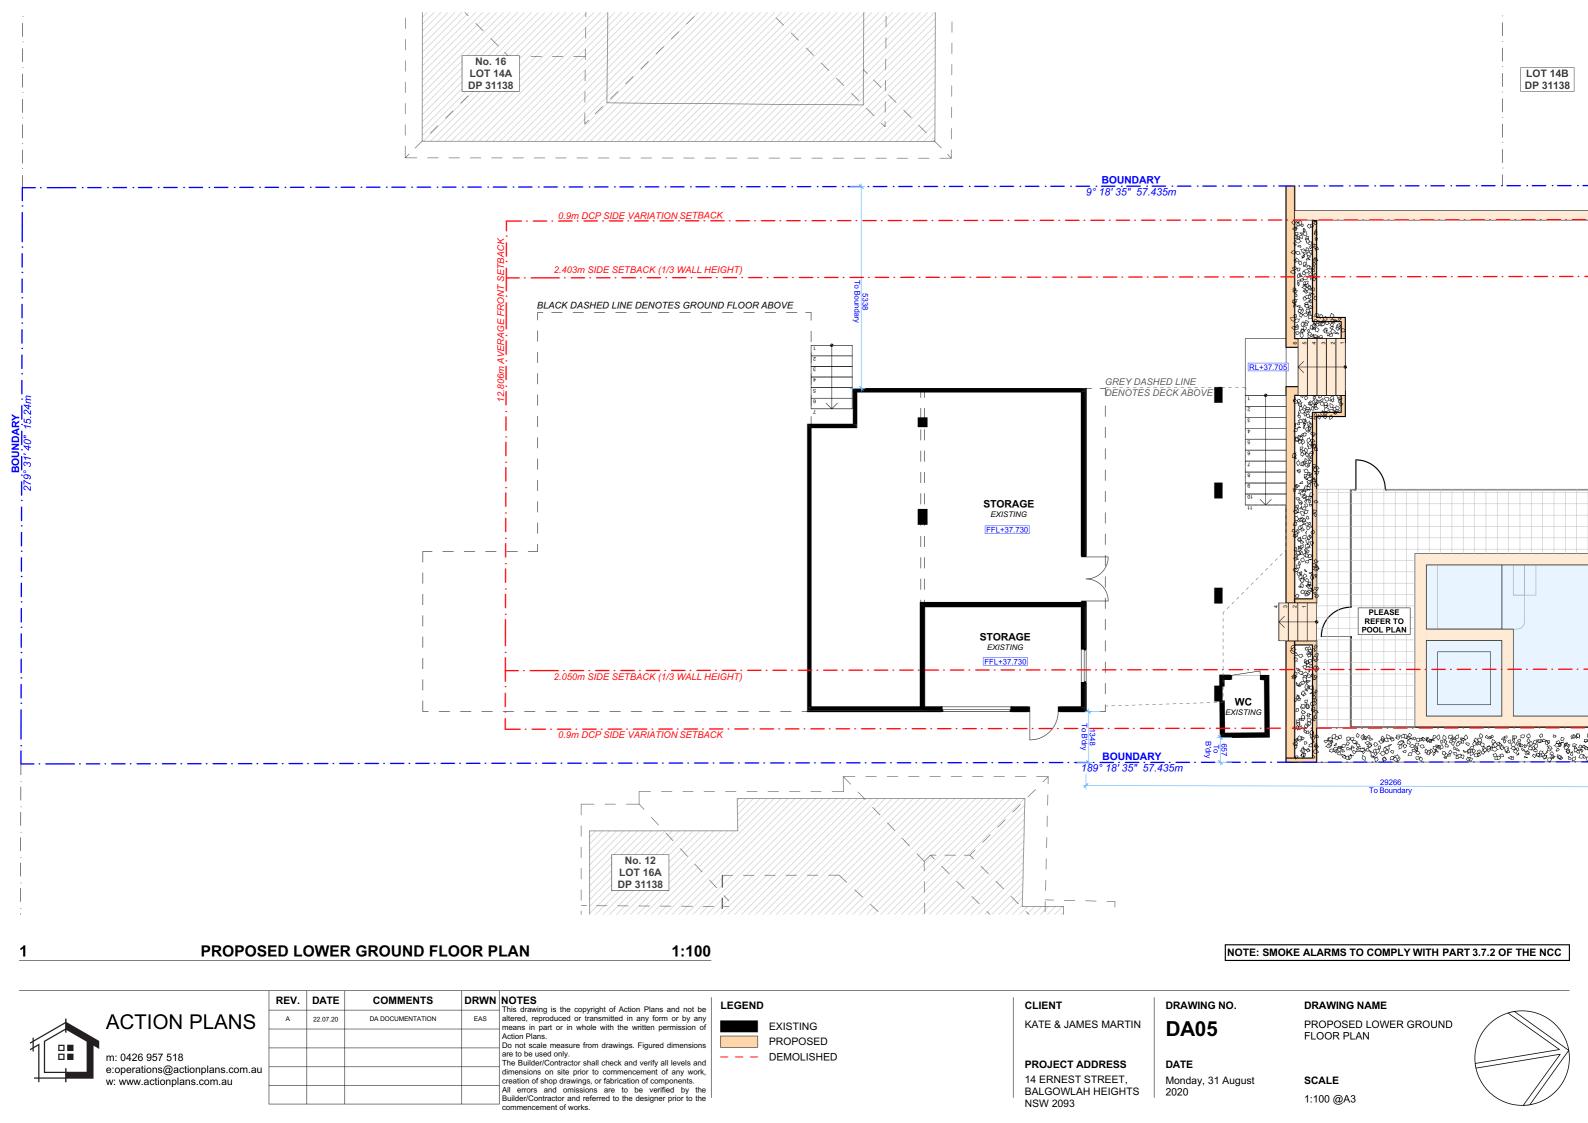




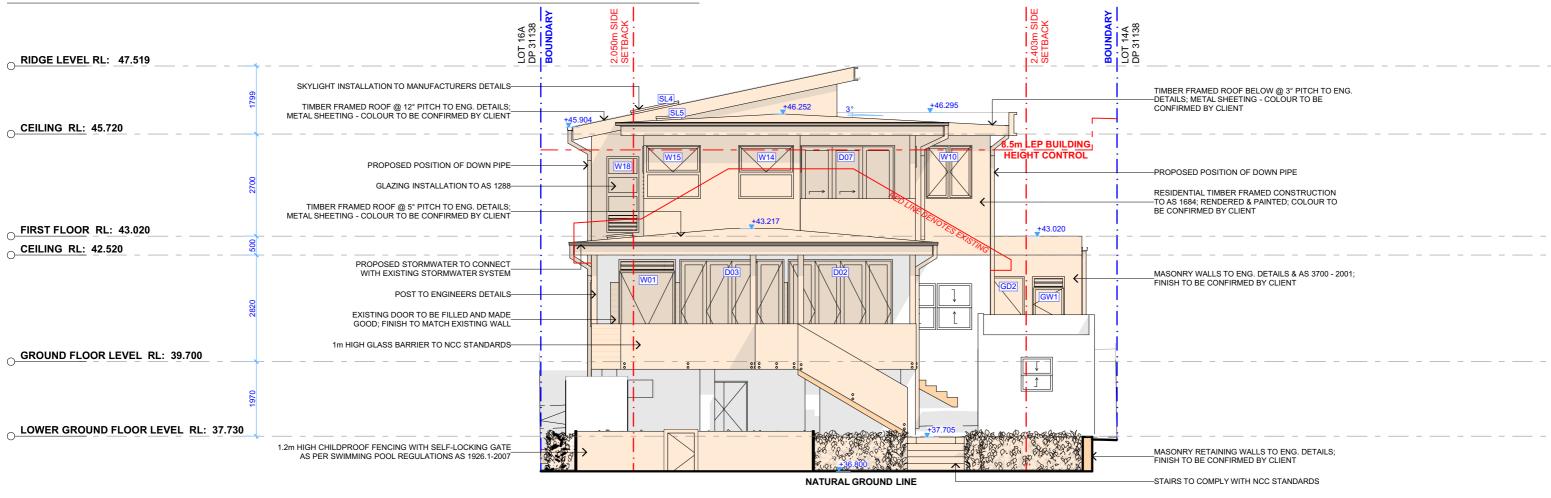



2 NORTH ELEVATION 1:100

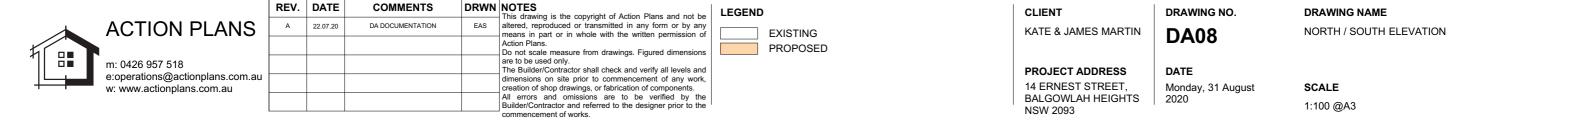

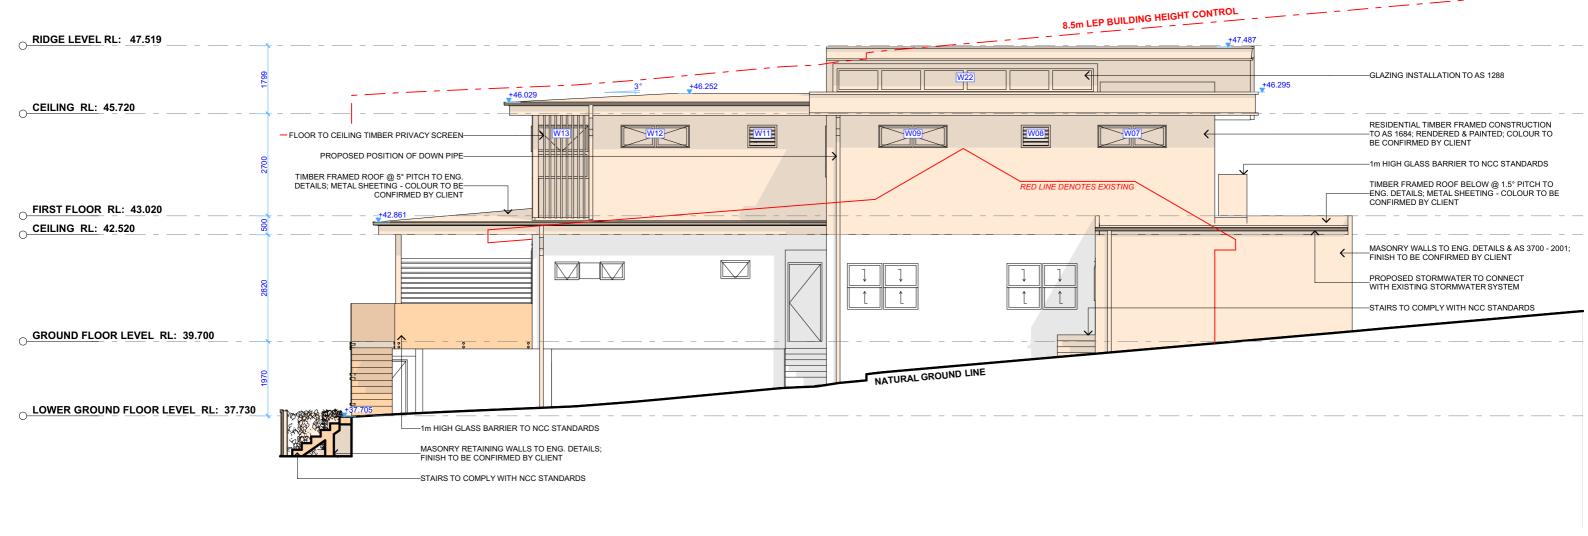



1 WEST ELEVATION 1:100

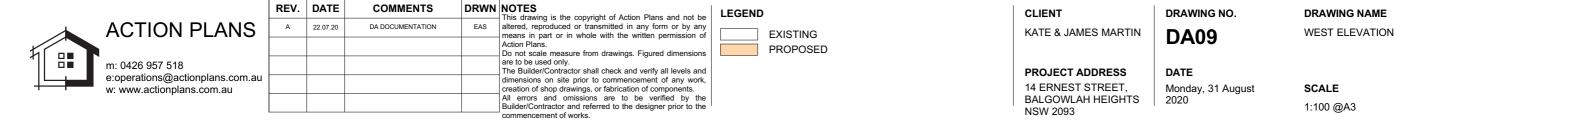

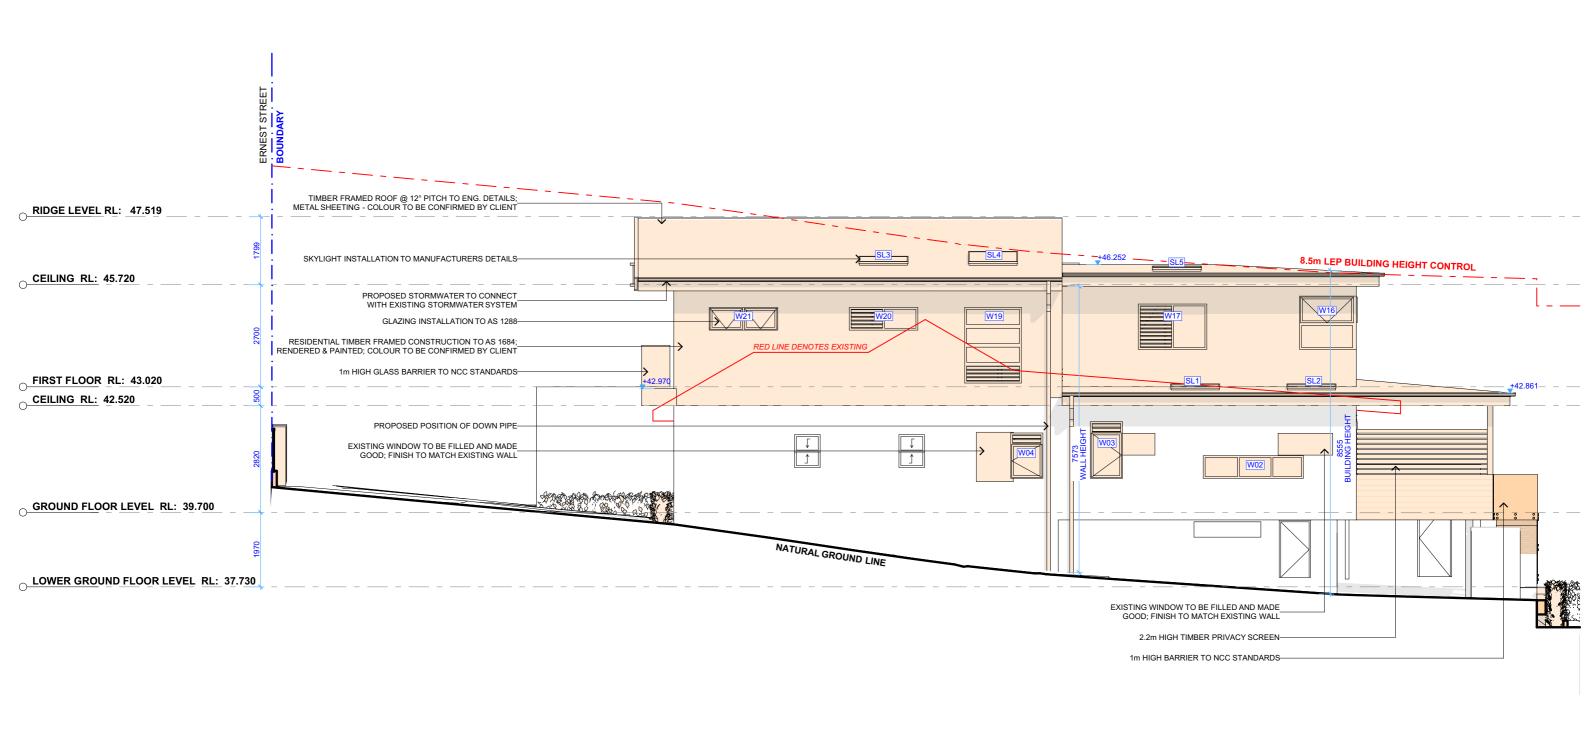

1 EAST ELEVATION 1:100

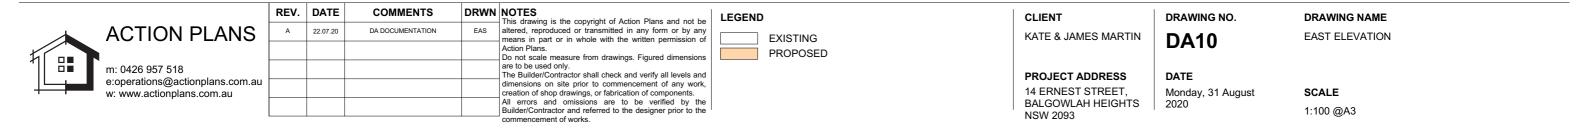

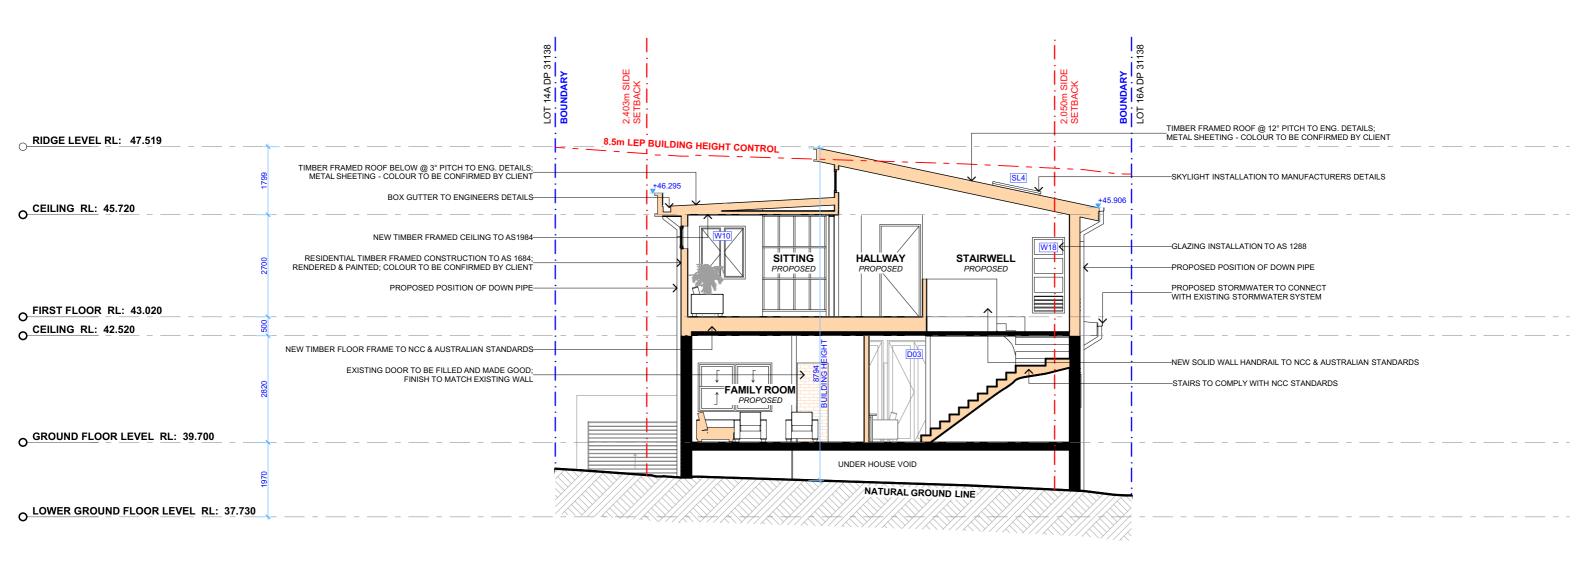

1 CROSS SECTION 1:100




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CLIENT KATE & JAMES MARTIN	DA11	DRAWING NAME CROSS SECTION
PROJECT ADDRESS	DATE	
14 ERNEST STREET,	Monday, 31 August	SCALE
BALGOWLAH HEIGHTS	2020	1.100 @ 43

NSW 2093


1:100 @A3



BOUNDARY
ERNEST STREET

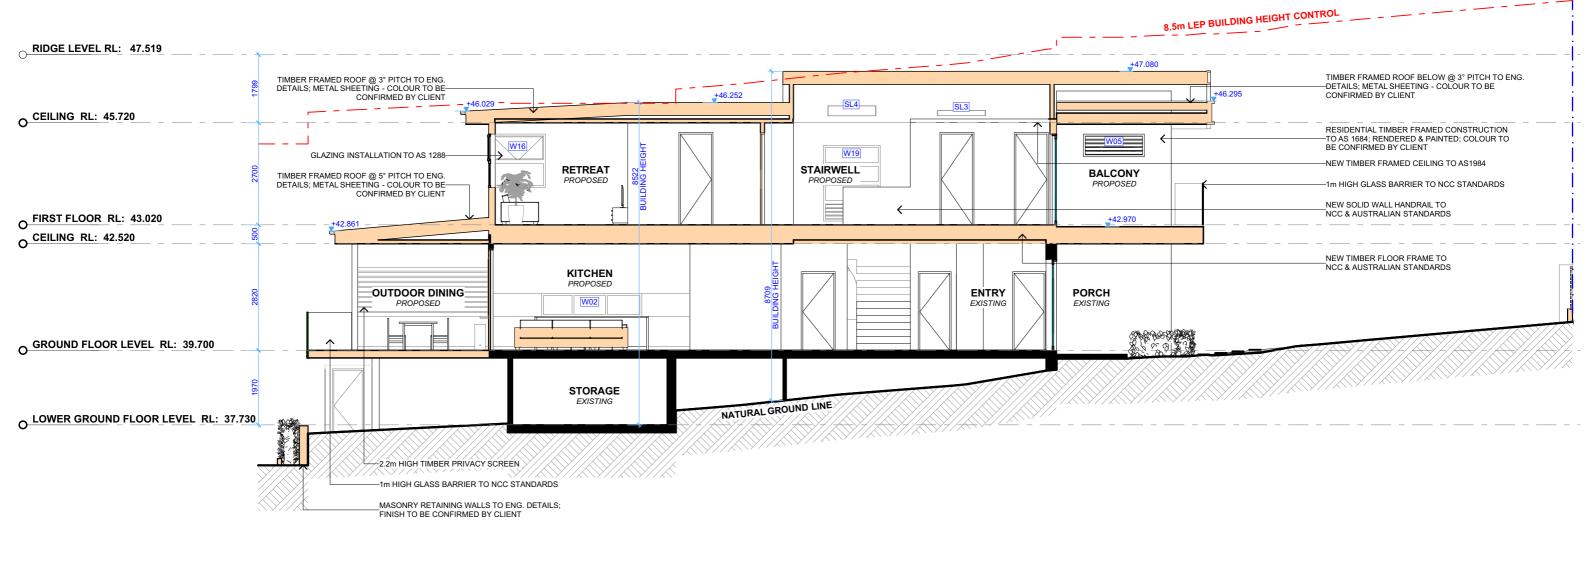1 LONG SECTION 1:100

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	<b>ACTION PLANS</b>	А	22.07.20	DA DOCUMENTATION	EAS altered, reproduced or transmitted in any form or by any means in part or in whole with the written permission of		KATE & JAMES MARTIN	DA12	LONG SECTION
110					Action Plans.  Do not scale measure from drawings. Figured dimensions	PROPOSED		DAIZ	
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	w: www.actionplans.com.au				creation of shop drawings, or fabrication of components.  All errors and omissions are to be verified by the		14 ERNEST STREET,	Monday, 31 August	SCALE
					Builder/Contractor and referred to the designer prior to the commencement of works.		BALGOWLAH HEIGHTS NSW 2093	2020	1:100 @A3

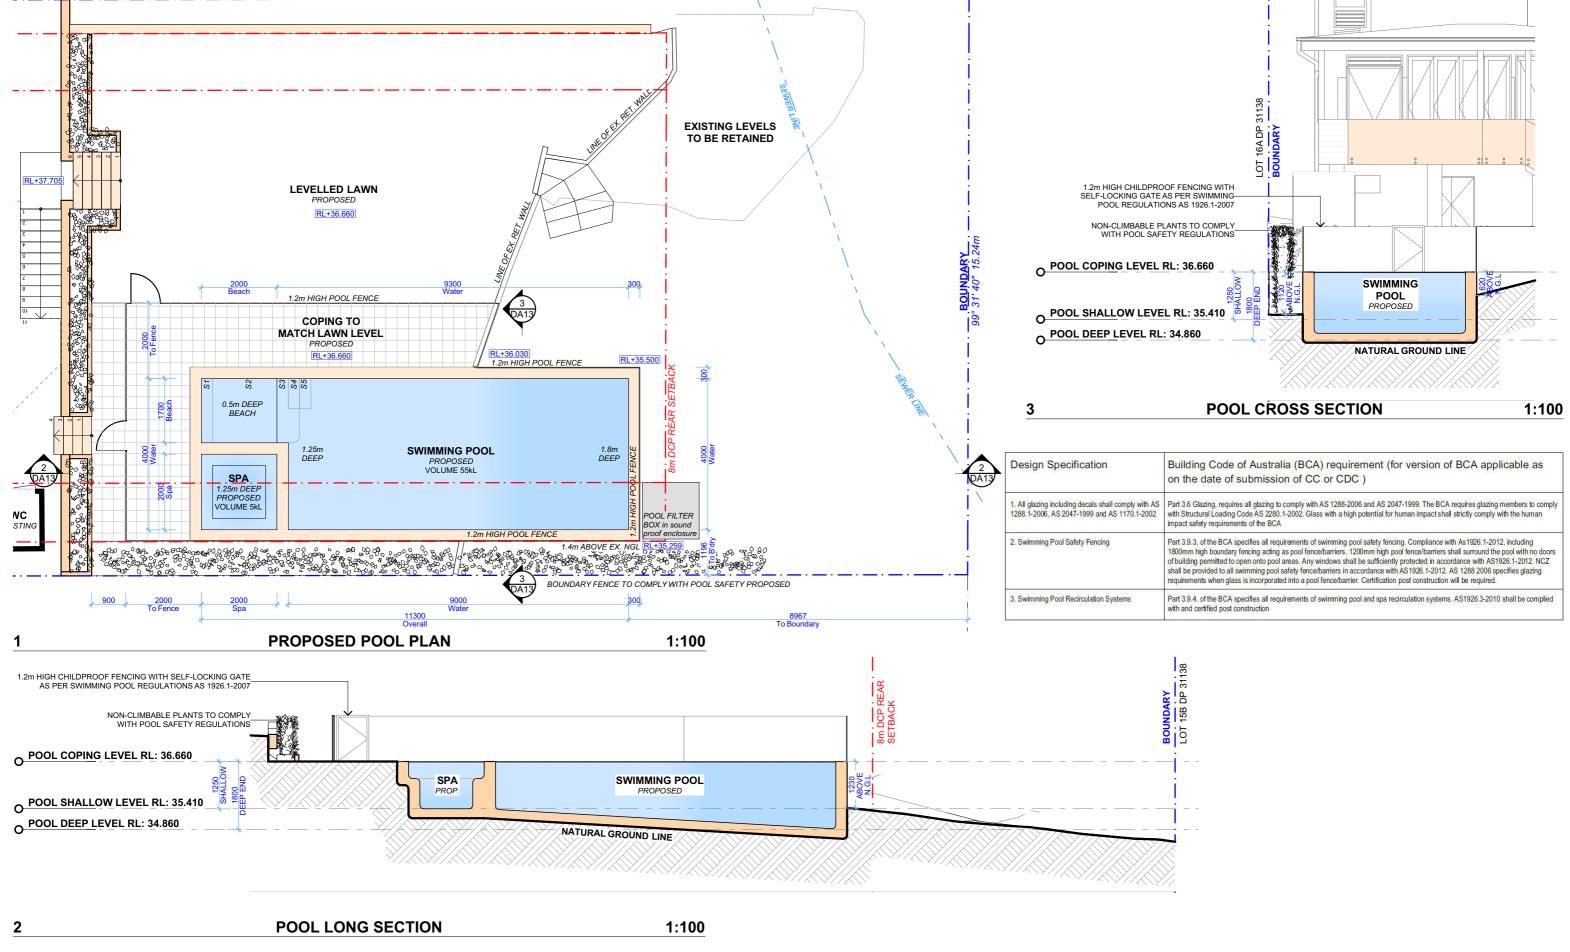

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LEGEND

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BALGOWLAH HEIGHTS

CLIENT

NSW 2093

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14 ERNEST STREET, Monda

Monday, 31 August 2020


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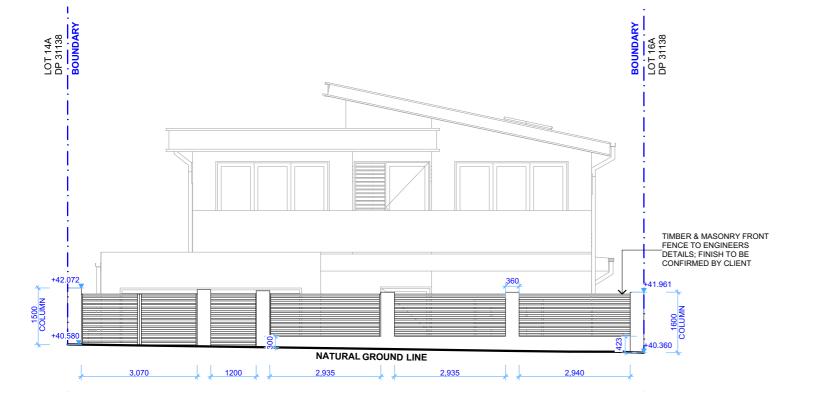
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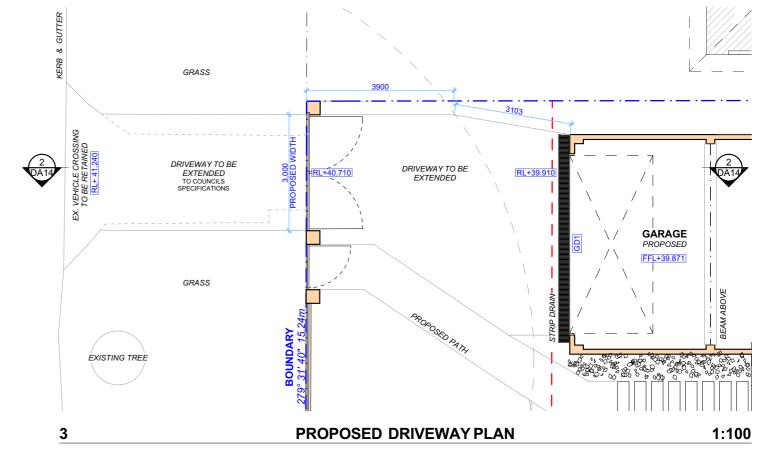
POOL PLAN / POOL LONG

SECTION


SCALE 1:100 @A3





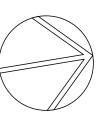

1 FRONT FENCE ELEVATION 1:100

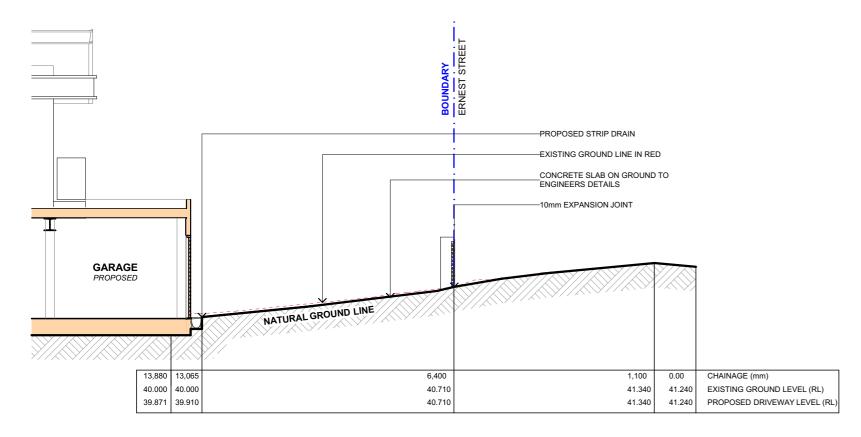

2 DRIVEWAY LONG SECTION 1:100



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**LEGEND** 

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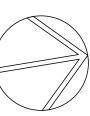
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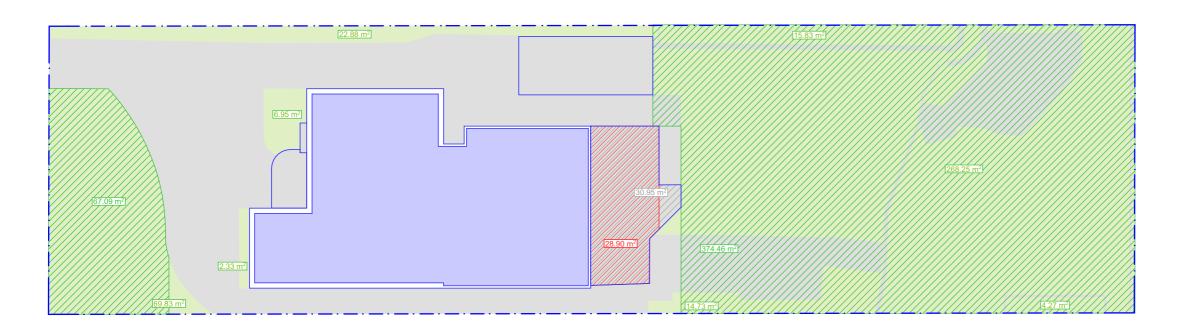
DA14

DATE Monday, 31 August 2020 DRAWING NAME


DRIVEWAY PLAN / LONG
SECTION / FRONT FENCE


SCALE
1:100 @A3





**EXISTING AREA CALCULATIONS** 1:200

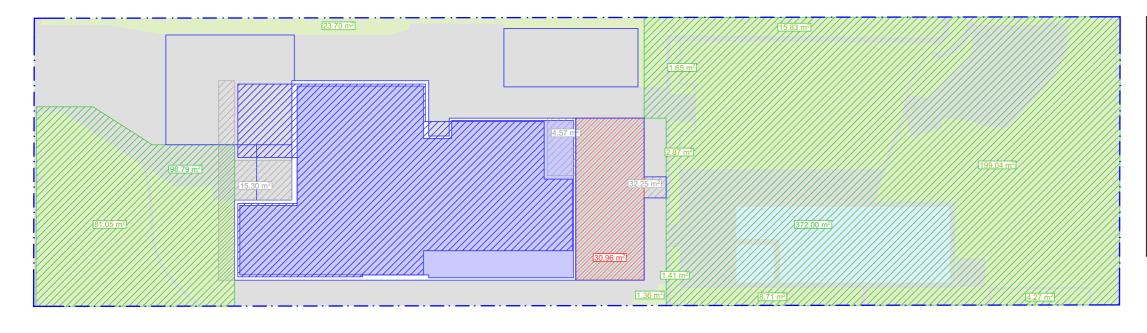

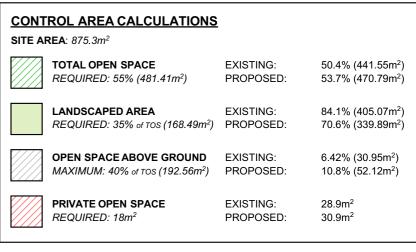

#### PROPOSED AREA CALCULATIONS 1:200



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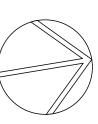
DRAWING NO. **DA15** 


DRAWING NAME AREA CALCULATIONS

DATE


Monday, 31 August 2020

SCALE 1:200 @A3



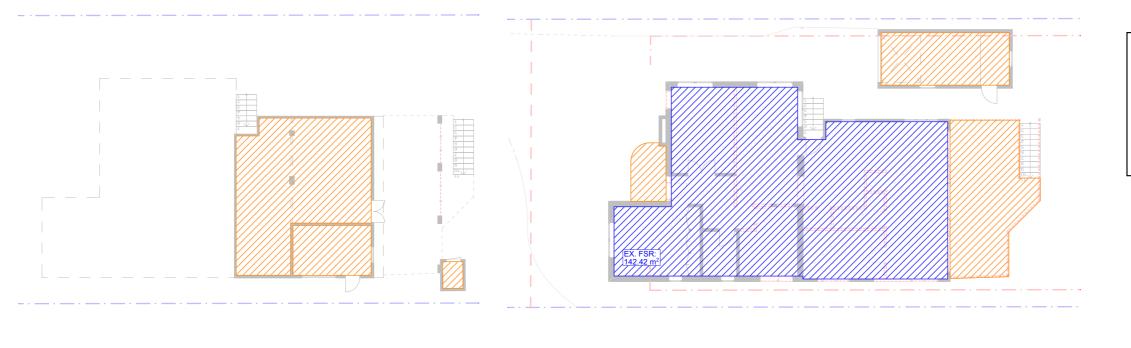

**CONTROL F.S.R CALCULATIONS SITE AREA**: 875.3m<sup>2</sup> FLOOR SPACE RATIO 0.162 : 1 (142.42m<sup>2</sup>) EXISTING: MAXIMUM: 0.450 : 1 (393.88m<sup>2</sup>) PROPOSED: 0.314 : 1 (275.58m<sup>2</sup>) **FSR - EXCLUDED AREAS** MAXIMUM: N/A

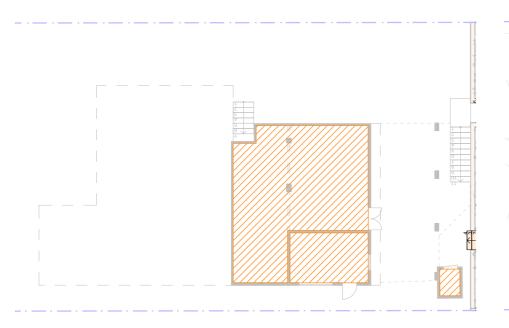

**EXISTING FSR: LOWER GROUND FLOOR PLAN 1:200** 

**EXISTING FSR: GROUND FLOOR PLAN** 

PROPOSED FSR: LOWER GROUND FLOOR PLAN 1:200

PROPOSED FSR: GROUND FLOOR PLAN

PROPOSED FSR: FIRST FLOOR PLAN

DRAWING NAME

1:200

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1:200

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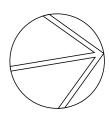
1:200

PROJECT ADDRESS 14 ERNEST STREET, BALGOWLAH HEIGHTS DRAWING NO. **DA16** 

FSR CALCULATIONS

DATE Monday, 31 August 2020

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### **SAMPLE BOARD**



ALUMINIUM FRAMED DOOR WITH SIDE LOUVER BY STEGBAR OR OTHER

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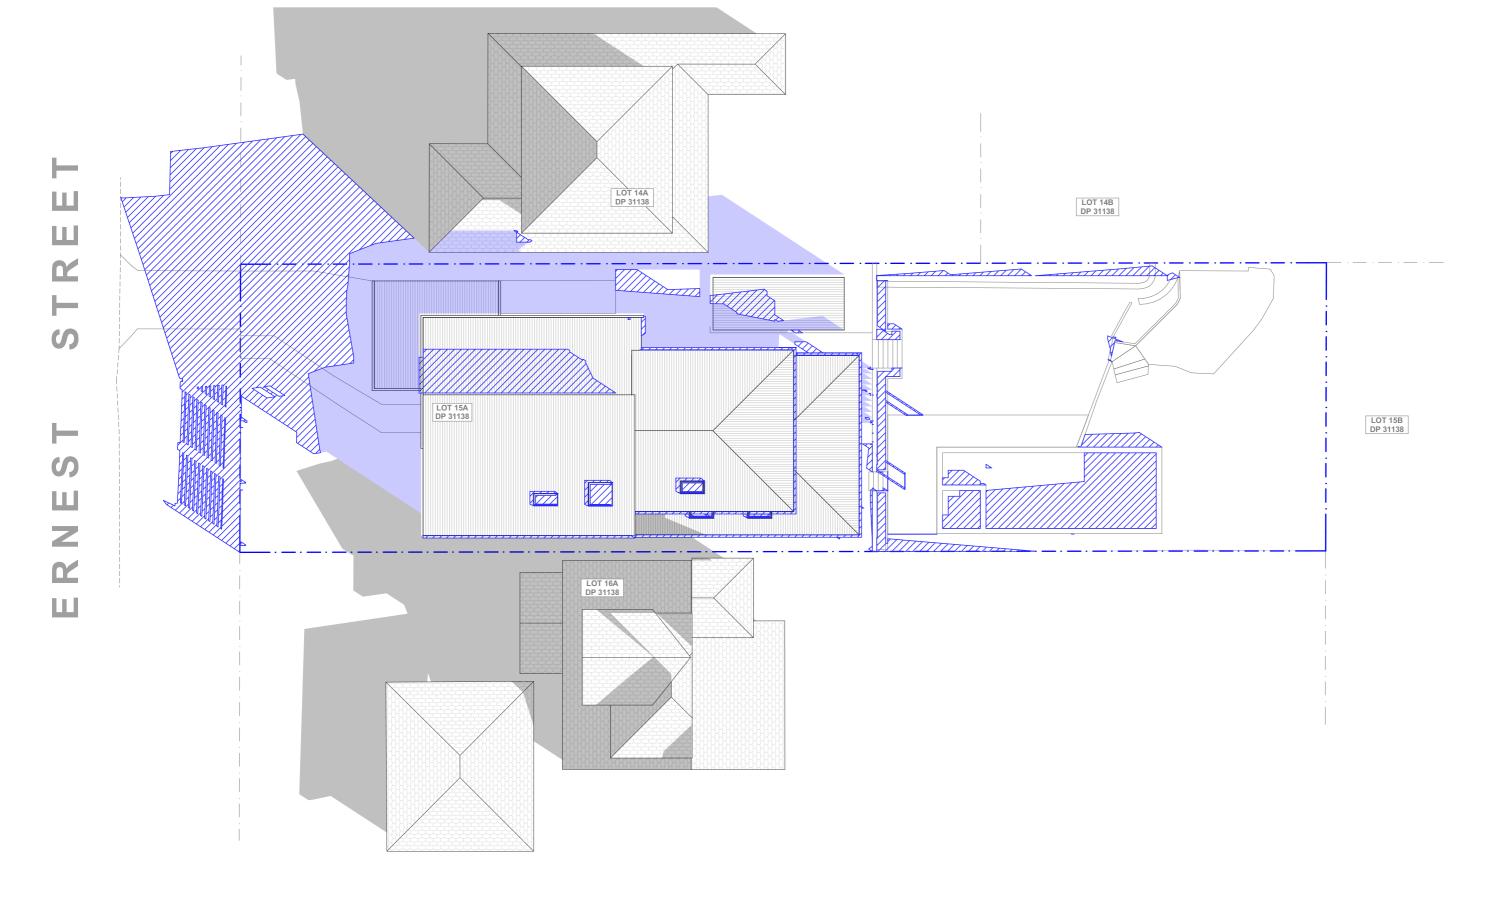
14 ERNEST STREET, BALGOWLAH HEIGHTS NSW 2093

DRAWING NO.

**DA17** 

DATE Monday, 31 August 2020 DRAWING NAME SAMPLE BOARD


SCALE @A3



1 WINTER SOLSTICE 9AM 1:200



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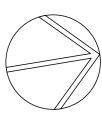
PROJECT ADDRESS	
14 ERNEST STREET,	
BALGOWLAH HEIGHTS	6
NSW 2093	

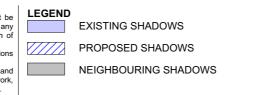
DRAWING NO.

DATE Monday, 31 August 2020

**DRAWING NAME**WINTER SOLSTICE 9 AM

SCALE 1:200 @A3




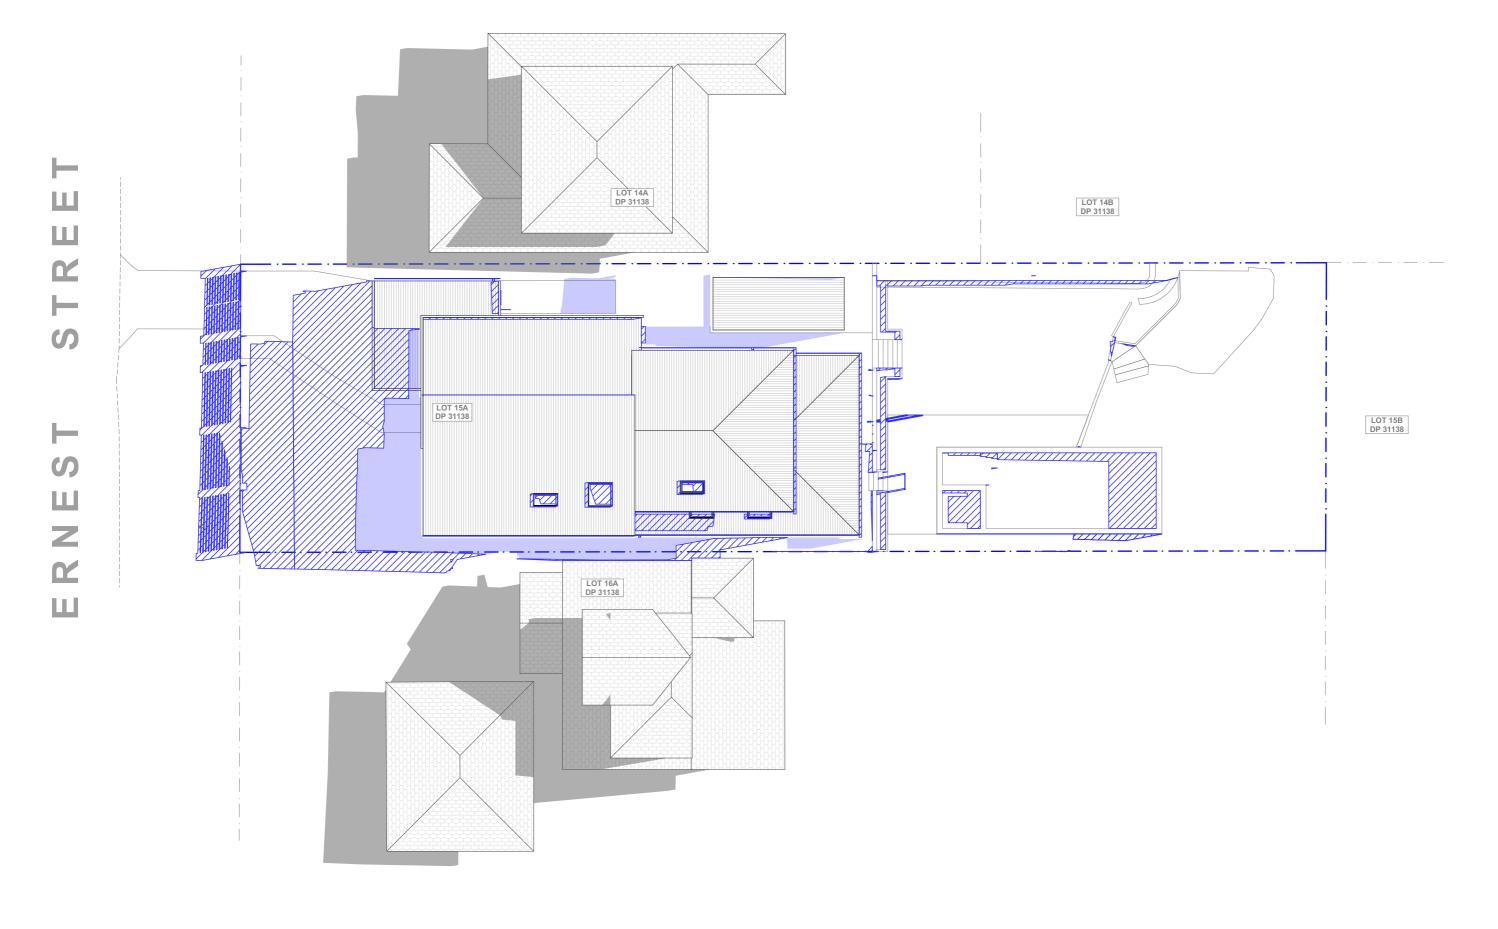

WINTER SOLSTICE 12PM 1:200



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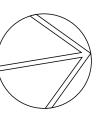
PROJECT ADDRESS
14 ERNEST STREET,
BALGOWLAH HEIGHTS
NSW 2093

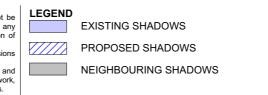
DRAWING NO	)
<b>DA19</b>	

DA19	WINTER SOLSTICE 12 PM
DATE	

Monday, 31 August 2020 SCALE 1:200 @A3

DRAWING NAME




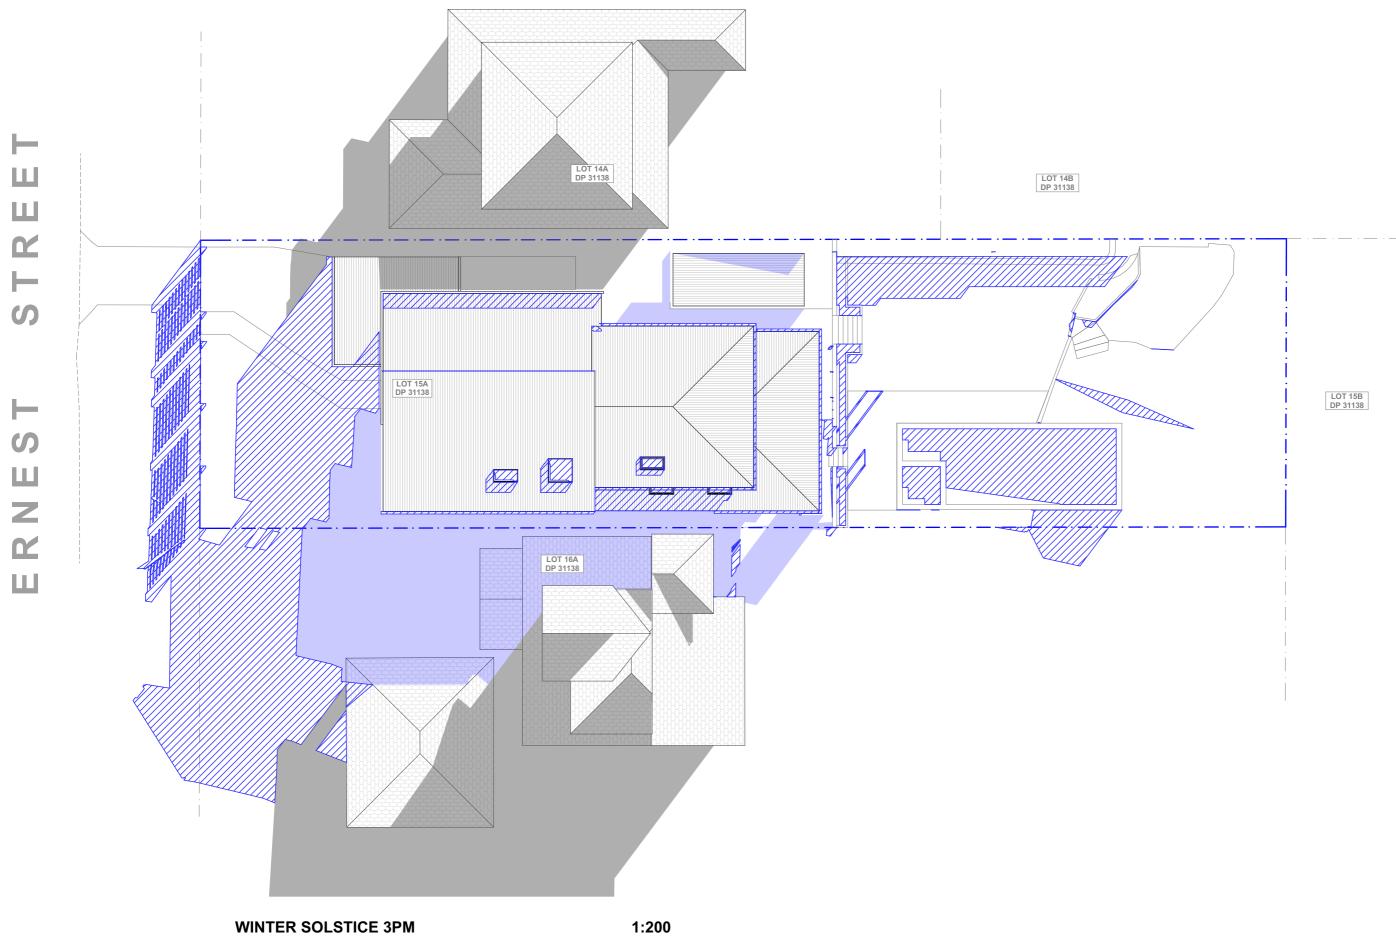

WINTER SOLSTICE 3PM



REV.	DATE	COMMENTS	DRWN	NOTES This drawing is the copyright of Action Plans and not be
А	22.07.20	DA DOCUMENTATION	EAS	altered, reproduced or transmitted in any form or by any means in part or in whole with the written permission of
				Action Plans. Do not scale measure from drawings. Figured dimensions are to be used only. The Builder/Contractor shall check and verify all levels and
				dimensions on site prior to commencement of any work, creation of shop drawings, or fabrication of components.
				All errors and omissions are to be verified by the Builder/Contractor and referred to the designer prior to the commencement of works.

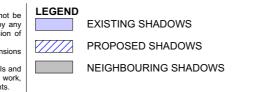

CLIENT KATE & JAMES MARTIN

PROJECT ADDRESS 14 ERNEST STREET, BALGOWLAH HEIGHTS NSW 2093

DRAWING NO. **DA20** 


Monday, 31 August 2020

DATE

SCALE 1:200 @A3

DRAWING NAME

WINTER SOLSTICE 3 PM

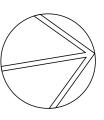



Building Sustainability Index www.basix.nsw.gov.au

#### **Alterations and Additions**

Certificate number: A383818\_02

This certificate confirms that the proposed development will meet the NSW government's requirements for sustainability, if it is built in accordance with the commitments set out below. Terms used in this certificate, or in the commitments, have the meaning given by the document entitled "BASIX Alterations and Additions Definitions" dated 80/10/2017 published by the Department. This document is available at www.basix.nsw.gov.au

Secretary
Date of issue: Tuesday, 21, July 2020
To be valid, this certificate must be lodged within 3 months of the date of issue.

Environmen
Environme

project	Project address	
O	Project name	14 Ernest Street Balgowlah Heights_02
	Street address	14 Ernest Street Balgowlah Heights 2093
ĭ	Local Government Area	Northern Beaches Council
Q	Plan type and number	Deposited Plan 31138
U-	Lot number	15A
0	Section number	
	Project type	
.0	Dwelling type	Separate dwelling house
ript	Type of alteration and addition	My renovation work is valued at \$50,000 or more, and includes a pool (and/or spa).
Description		

Certificate Prepared by (please complete before submitting to Council or PCA)
Name / Company Name: Action Plans
ABN (if applicable): 17118297587

Pool and Spa	Show on DA Plans	Show on CC/CDC Plans & specs	Certifier Check
Rainwater tank			
The applicant must install a rainwater tank of at least 2843 litres on the site. This rainwater tank must meet, and be installed in accordance with, the requirements of all applicable regulatory authorities.	<b>✓</b>	<b>✓</b>	<b>~</b>
The applicant must configure the rainwater tank to collect rainwater runoff from at least 245 square metres of roof area.		<b>✓</b>	<b>✓</b>
The applicant must connect the rainwater tank to a tap located within 10 metres of the edge of the pool and outdoor spa.		✓	<b>✓</b>
Outdoor swimming pool			
The swimming pool must be outdoors.	✓	✓	✓
The swimming pool must not have a capacity greater than 55 kilolitres.	✓	~	✓
The swimming pool must have a pool cover.		~	✓
The applicant must install a pool pump timer for the swimming pool.		<b>~</b>	✓
The applicant must install the following heating system for the swimming pool that is part of this development: electric heat pump.		<b>✓</b>	<b>✓</b>
Outdoor spa		•	•
The spa must not have a capacity greater than 5 kilolitres.	✓	✓	V
The spa must have a spa cover.		<b>✓</b>	<b>✓</b>
The applicant must install a spa pump timer.		✓	✓
The applicant must install the following heating system for the outdoor spa that is part of this development: electric heat pump.		V	✓

Fixtures and systems	Show on	Show on	Certifier
	DA Plans	CC/CDC Plans & specs	Check
Lighting			
The applicant must ensure a minimum of 40% of new or altered light fixtures are fitted with fluorescent, compact fluorescent, or light-emitting-diode (LED) lamps.		<b>✓</b>	<b>✓</b>
Fixtures		•	
The applicant must ensure new or altered showerheads have a flow rate no greater than 9 litres per minute or a 3 star water rating.		✓	✓
The applicant must ensure new or altered toilets have a flow rate no greater than 4 litres per average flush or a minimum 3 star water rating.		✓	<b>~</b>
The applicant must ensure new or altered taps have a flow rate no greater than 9 litres per minute or minimum 3 star water rating.		./	

Construction	Show on DA Plans	Show on CC/CDC Plans & specs	Certifier Check		
nsulation requirements					
The applicant must construct the new or altered he table below, except that a) additional insulat s not required for parts of altered construction w	<b>V</b>	<b>V</b>	<b>√</b>		
Construction	Additional insulation required (R-value)	Other specifications			
concrete slab on ground floor.	nil				
floor above existing dwelling or building.	nil				
external wall: framed (weatherboard, fibro, metal clad)	R1.30 (or R1.70 including construction)				
external wall: other/undecided	R1.70 (including construction)				
flat ceiling, pitched roof	ceiling: R2.50 (up), roof: foil/sarking	medium (solar absorptance 0.475 - 0.70)			
flat ceiling, flat roof: framed	ceiling: R2.50 (up), roof: foil/sarking	medium (solar absorptance 0.475 - 0.70)			

Glazing re	equirements	S					Show on DA Plans	Show on CC/CDC Plans & specs	Certifier Check
Vindows a	and glazed	doors							
					nading devices, in accordance with to each window and glazed door.	he specifications listed in the table below.	<b>✓</b>	<b>✓</b>	~
The followin	ng requiremer	nts must also	be satisfi	ed in relation	to each window and glazed door:			~	<b>V</b>
have a U-va	alue and a So	lar Heat Gai	n Coefficie	ent (SHGC) r		d glass may either match the description, or, e below. Total system U-values and SHGCs		<b>✓</b>	~
Each window or glazed door with improved frames, or pyrolytic low-e glass, or clear/air gap/clear glazing, or toned/air gap/clear glazing must have a U-value and a Solar Heat Gain Coefficient (SHGC) no greater than that listed in the table below. Total system U-values and SHGCs must be calculated in accordance with National Fenestration Rating Council (NFRC) conditions. The description is provided for information only. Alternative systems with complying U-value and SHGC may be substituted.								~	~
					each eave, pergola, verandah, bald han 2400 mm above the sill.	cony or awning must be no more than 500 mm	✓	✓	✓
Pergolas wit	th polycarbon	nate roof or s	imilar tran	slucent mate	erial must have a shading coefficient	t of less than 0.35.		<b>✓</b>	<b>✓</b>
External lou	vres and blin	ds must fully	shade the	window or	glazed door beside which they are s	ituated when fully drawn or closed.		<b>✓</b>	~
Pergolas with fixed battens must have battens parallel to the window or glazed door above which they are situated, unless the pergola also shades a perpendicular window. The spacing between battens must not be more than 50 mm.								✓	~
Windows	and glaze	d doors g	lazing r	equireme	nts		1		
	loor Orientati			dowing	Shading device	Frame and glass type			
no.		glass inc. frame (m2)	Height (m)	Distance (m)					
W1	N	2.7	0	0	eave/verandah/pergola/balcony >=900 mm	standard aluminium, single clear, (or U-value: 7.63, SHGC: 0.75)			
W2	E	1.59	0	0	eave/verandah/pergola/balcony >=600 mm	standard aluminium, single pyrolytic low-e, (U-value: 5.7, SHGC: 0.47)			
W3	E	1.27	0	0	eave/verandah/pergola/balcony	standard aluminium, single pyrolytic low-e,			

Glazing requirements								Show on CC/CDC Plans & specs	Certifier Check
Window / door no.	Orientation	Area of glass inc. frame (m2)	Oversha Height (m)	Distance (m)	Shading device	Frame and glass type			
					>=600 mm	(U-value: 5.7, SHGC: 0.47)			
W4	E	1.2	0	0	eave/verandah/pergola/balcony >=600 mm	standard aluminium, single pyrolytic low-e, (U-value: 5.7, SHGC: 0.47)			
W5	W	0.96	0	0	eave/verandah/pergola/balcony >=900 mm	standard aluminium, single clear, (or U-value: 7.63, SHGC: 0.75)			
W6	E	0.96	0	0	eave/verandah/pergola/balcony >=900 mm	standard aluminium, single clear, (or U-value: 7.63, SHGC: 0.75)			
W7	W	1.08	0	0	eave/verandah/pergola/balcony >=600 mm	improved aluminium, single pyrolytic low-e, (U-value: 4.48, SHGC: 0.46)			
W8	W	0.46	0	0	eave/verandah/pergola/balcony >=600 mm	standard aluminium, single clear, (or U-value: 7.63, SHGC: 0.75)			
W9	W	1.08	0	0	eave/verandah/pergola/balcony >=600 mm	improved aluminium, single pyrolytic low-e, (U-value: 4.48, SHGC: 0.46)			
W10	N	1.69	0	0	external louvre/blind (adjustable)	standard aluminium, single clear, (or U-value: 7.63, SHGC: 0.75)			
W11	W	0.46	0	0	eave/verandah/pergola/balcony >=900 mm	standard aluminium, single clear, (or U-value: 7.63, SHGC: 0.75)			
W12	W	1.08	0	0	eave/verandah/pergola/balcony >=900 mm	standard aluminium, single clear, (or U-value: 7.63, SHGC: 0.75)			
W13	W	2.04	0	0	eave/verandah/pergola/balcony >=900 mm	standard aluminium, single clear, (or U-value: 7.63, SHGC: 0.75)			
W14	N	2.04	0	0	eave/verandah/pergola/balcony >=750 mm	standard aluminium, single clear, (or U-value: 7.63, SHGC: 0.75)			
W15	N	2.04	0	0	eave/verandah/pergola/balcony >=750 mm	standard aluminium, single clear, (or U-value: 7.63, SHGC: 0.75)			
W16	E	2.04	0	0	eave/verandah/pergola/balcony	standard aluminium, single pyrolytic low-e,			

Show on DA Plans   Show on										
	Glazing requirements								CC/CDC Plans &	
W17		Orientation	glass inc. frame	Height	Distance	Shading device	Frame and glass type			
N						>=750 mm	(U-value: 5.7, SHGC: 0.47)			
U-value: 7.63, SHGC: 0.75	W17	E	2.17	0	0					
	W18	N	1.7	0	0	external louvre/blind (adjustable)				
Second mm	W19	E	3	0	0					
S	W20	E	1.08	0	0					
D2	W21	E	1.08	0	0					
S	D1	s	3.24	0	0					
S   S   Roc.   S   S   S   S   S   S   S   S   S	D2	N	7.45	0	0					
S   S   S   S   S   S   S   S   S   S	D3	N	7.45	0	0					
S=900 mm	D4	s	7.2	0	0					
D7   N   6   0   0   eave/verandah/pergola/balcony   U-value: 7.63, SHGC: 0.75)	D5	s	4.8	0	0					
>=900 mm U-value: 7.63, SHGC: 0.75)	D6	s	7.2	0	0					
W22 W 4.06 0 0 external louvre/blind (adjustable) standard aluminium, single clear, (or	D7	N	6	0	0					
	W22	W	4.06	0	0	external louvre/blind (adjustable)	standard aluminium, single clear, (or			

Glazing requirements										Certifier Check
Window / door C		Area of glass inc. irame (m2)	Overshad Height (m)	Distance (m)	Shading device		Frame and glass type			
							U-value: 7.63, SHGC: 0.75)			
Skylights								I	1	1
The applicant must install the skylights in accordance with the specifications listed in the table below.								✓	✓	<b>~</b>
The following requirements must also be satisfied in relation to each skylight:									<b>✓</b>	<b>~</b>
Each skylight may either match the description, or, have a U-value and a Solar Heat Gain Coefficient (SHGC) no greater than that listed in he table below.									✓	<b>✓</b>
External awnings	and louvres	must ful	y shade t	he skylight a	oove which they a	re situated when	fully drawn or closed.		<b>✓</b>	<b>✓</b>
Skylights glaz	zing requi	rement	s							
Skylight number	Area of gla		Shading	device		Frame and	glass type			
S1	0.847		no shadii	ng		aluminium, 6.21, SHG0	moulded plastic single clear, (or U-value: :: 0.808)			
S2	0.847	0.847 external adjustable awning or blind				aluminium, 6.21, SHG0	moulded plastic single clear, (or U-value: :: 0.808)			
S3	0.847		external adjustable awning or blin		vning or blind		aluminium, moulded plastic single clear, (or U-value: 6.21, SHGC: 0.808)			
\$4	1.625		external	adjustable av	vning or blind	aluminium, 6.21, SHG0	moulded plastic single clear, (or U-value: :: 0.808)	71		
S5	0.847		external	adjustable av	vning or blind	aluminium, 6.21, SHG0	moulded plastic single clear, (or U-value:			

Legend
these commitments, "applicant" means the person carrying out the development.
commitments identified with a "\" in the "Show on DA plans" column must be shown on the plans accompanying the development application for the proposed development (if a evelopment application is to be lodged for the proposed development).
commitments identified with a "\square\" in the "Show on CC/CDC plans & specs" column must be shown in the plans and specifications accompanying the application for a construction ertificate / complying development certificate for the proposed development.
Commitments identified with a "\forall "in the "Certifier check" column must be certified by a certifying authority as having been fulfilled, before a final occupation certificate for the levelopment may be issued.

ACTION PLANS
m: 0426 957 518 e:operations@actionplans.com.au w: www.actionplans.com.au

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The Builder/Contractor shall check and verify all levels and dimensions on site prior to commencement of any work, creation of shop drawings, or fabrication of components.

All errors and omissions are to be verified by the Builder/Contractor and referred to the designer prior to the commencement of works.

All window & door dimensions, orientation, glazing materials, opening types, frame types are to be confirmed by a suitably qualified person prior to the ordering of any such materials are to take place.

U value takes precedence over glazing type/colour in all cases.

All new glazing must meet the BASIX specified frame and glass type, <u>OR</u> meet the certified U value and SHGC value.

CLIENT

KATE & JAMES MARTIN

PROJECT ADDRESS 14 ERNEST STREET,

BALGOWLAH HEIGHTS NSW 2093

DRAWING NO. **DA21** 

DRAWING NAME BASIX COMMITMENTS

DATE

Monday, 31 August 2020