		day	11	14	
		month	3	6	
		year	19	19	 
Drawing Nur	nber Drawing Title		Revisi	on	
	A00 Drawing Register & Location Plan		0	Α	
	A01 Site Analysis Plan 1:200		0	-	
	A02 Erosion & Sediment Ctrl. / Excavation & Fill / Demo Plan	1:200	0	-	
	A03 Site Plan 1:200, Area Calculations		0	Α	
	A04 Lower Ground Floor Plan - Proposed 1:100		0	Α	
	A05 Ground Floor Plan - Proposed 1:100		0	Α	
	A06 First Floor Plan - Proposed 1:100		0	Α	
	A07 Roof Plan 1:100		0	Α	
	A08 Pool Plan and Sections 1:100		0	Α	
	A09 East and West Elevation 1:100		0	Α	
	A10 North & South Elevations 1:100		0	Α	
	A11 Sections 1:100		0	Α	
	A12 Driveway Long Section 1:50		0	Α	
	A13 Site Shadows - June 21 @ 9am		0	-	
	A14 Site Shadows - June 21 @ 12 Noon		0	-	
	A15 Site Shadows - June 21 @ 3pm		0	-	
	A16 Landscape Area Calculation Plan 1:200		0	Α	
	A17 External Window & Door Schedule / External Finishes Sc	hedule	0	-	
	A18 Thermal Performance Requirements		0	-	
	A19 BASIX Certificate		0	-	
	A20 3D Perspective Views		0	Α	
Document Distribution:			DA1	DA2	 
Client			0	0	
Structural Engineer					
Hydraulic Engineer			0		
Landsc. Consultant			0		
Approval Authority			0	0	

Issue Date

# **GENERAL BUILDING SPECIFICATION**

- All general construction to conform to the current BCA and Local Govt conditions of Development Consent.
- Demolition works to be carried out in accordance with AS 2601.
- All masonry work in accordance with AS 3700.


**Drawing Register** 

- Termite protection to be installed in accordance with AS 3660.1 and the current BCA.
- All roof water and storm-water runoff to be connected to a Council approved system of collection and/or disposal.
- All carpentry work to conform to AS1684 for Light Timber Framing.
- All sewer waste to be connected to the existing mains service in accordance with AS 3500.
- All pre-fabricated timber trusses and frames to utilize sustainable plantation timbers installed to the manufacturer's detail and specification.
- All concrete slabs, retaining walls, structural steel, foundations and footings to be designed & specified by the consulting structural engineer and built strictly in accordance with such details, as approved.
- Plumbing services to be carried out only by licenced tradespersons and in accordance with AS 3500.3.2, AS 3500.2.2, AS 3500.1.2, AG 601 and other associated standards and codes.
- All electrical services to be installed by licenced electricians and in accordance with AS3000. Telecommunications cabling to be installed in accordance with AS/ACIF S009:2000 and associated standards and guidelines. Upgrade safety switches & smoke alarms as required to meet relevant standards.
- All insulation to be provided and installed in accordance with AS4859.1, AS3999 (bulk insul'n), AS1904 (foil insul'n) and associated standards and codes.
- Contractor to ensure selected tiles, fittings, etc, are appropriate and suitable for each application.
- Any proposed variations to the details supplied in these documents must be discussed with and approved by Cadence & Co Design in writing, before the Contractor orders or installs the relevant materials or systems. The Contractor must ensure that all proprietary systems and materials used in the construction of these works will be compatible with the details provided by Cadence & Co Design.
- All measurements shown and scheduled are nominal. The contractor shall check all measurements on site before ordering materials and check any anomalies with Cadence & Co Design before proceeding.
- Proposed RL's shown on drawings are to be FINISHED LEVELS. Builder to provide set set down's and allowances to accommodate finished levels.

# **BUSHFIRE SPECIFICATION**

- The highest Bushfire Attack Level to the proposed dwelling was determined from Table 2.4.2 of AS3959 – 2009 to be 'BAL 12.5'. The proposed dwelling is required to comply with section 3 and BAL 12.5 section 5 under AS 3959 – 2009 and Addendum Appendix 3 under PBP 2006.



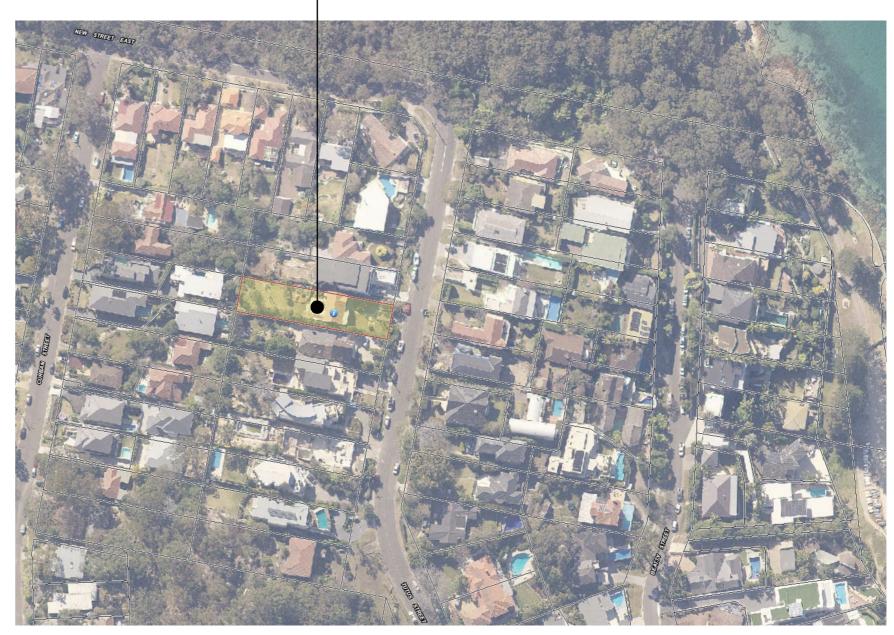

# **LOCATION PLAN (NTS)**

(Source SIX maps)

# THERMAL COMFORT INCLUSIONS

NatHERS Thermal Comfort Inclusions

Floors

Concrete slab on ground with an R1.5 insulation Concrete between levels, no insulation required

Timber between levels, no insulation required

Suspended timber floor with R2.5 insulation

External Walls

200mm dincel walls

Lightweight cladding on framed walls with R2.0 insulation (insulation only value) Note: No insulation is required to garage walls

External Colour

Default colour modelled

Walls within dwellings 110mm dincel walls. R1.5 insulation to internal entry walls

Plasterboard on studs no insulation

Glazing Doors/Windows Aluminium framed performance glazing:

U-value: 5.20 (equal to or lower than) SHGC: 0.49 (±10%)

Given values are AFRC total window system values (glass and frame)

Note: Openability modelled as per BASIX Thermal Protocol -4.14.2 and NatHERS Technical Note 1.2 - 10.11 with regards to restricted openings

Skylights

Double glazed with timber or aluminium frame

R1.5 insulation to skylight shaft

Roof

Concrete roof, no insulation

Metal roof with foil backed blanket (R $_{\rm u}1.0$  and R $_{\rm d}1.0$ ) External Colour

Dark (SA > 0.7)

Ceilings

Plasterboard ceiling with R3.0 insulation (insulation only value) where roof or balcony

Plasterboard ceiling with R2.5 insulation (insulation only value) to soffit of concrete basement, storage and service areas

eiling Penetrations

Ceiling penetrations not to exceed NatHERS certificate

Floor coverings

Carpet to bedrooms, tiles to bathrooms and laundry, timber elsewhere

External Shading

Vergola, window boxes, pergolas and eaves as per NatHERS stamped plans



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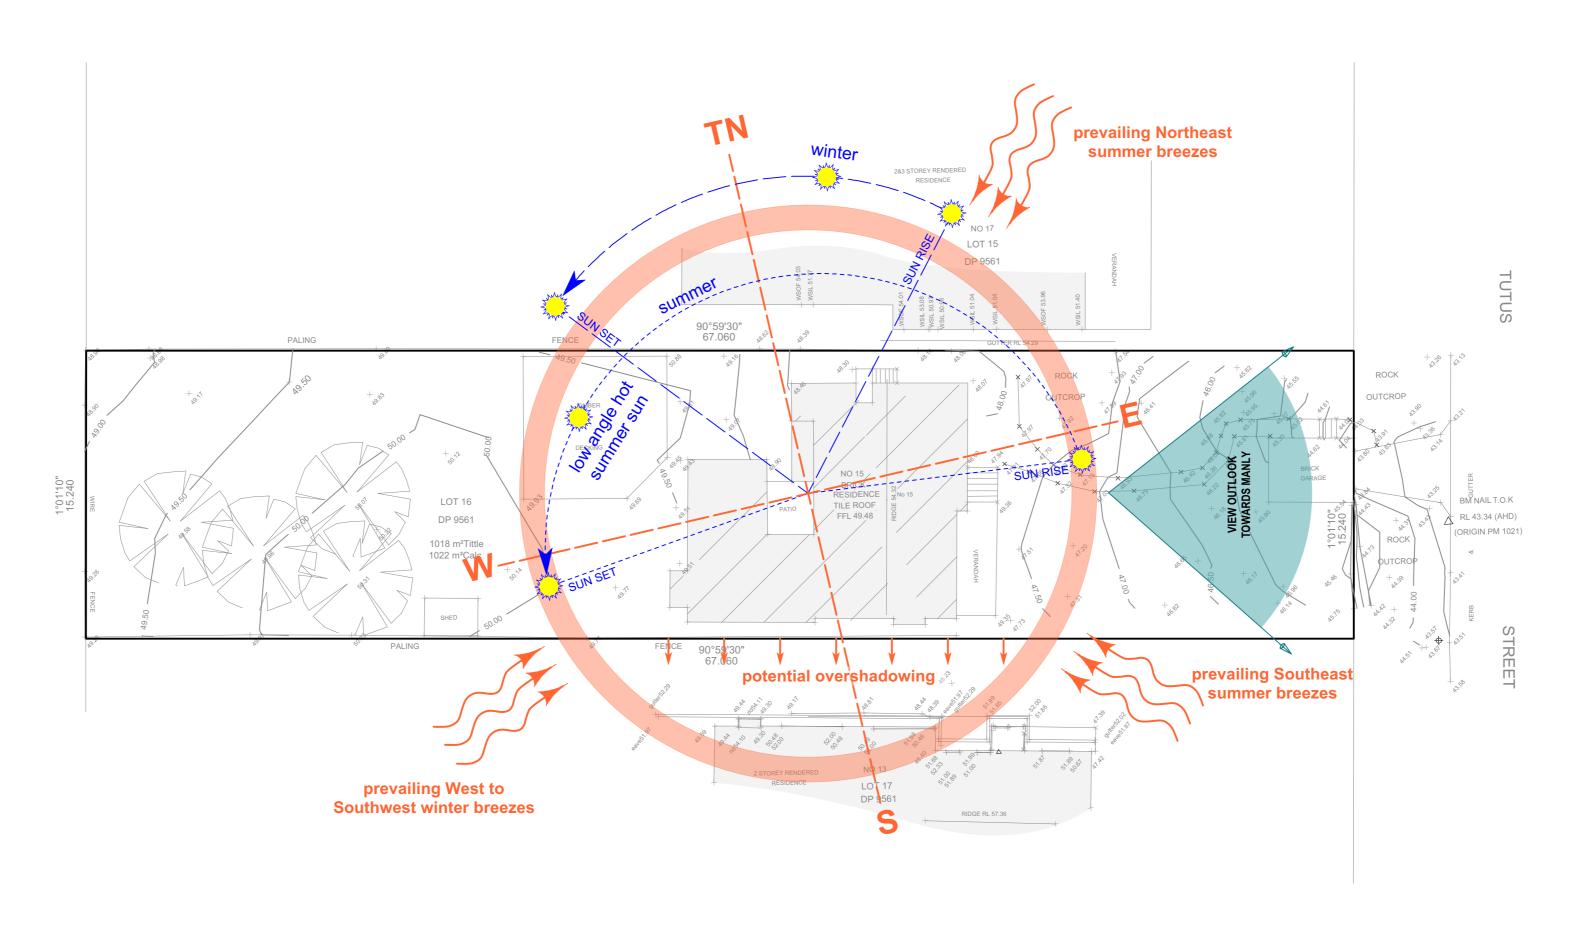
ABN: 12 168 714 752
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REVISED DA - 14/6/19

N DATE REVISION NOTE

14/6/19 ALL DA AMENDMENTS AS NOTED RED ON THE DRAWINGS

П	CLIENT:	DRAWING:		DRAWN:	SHEET NO:
	Colin & Emily Panagakis	Drawing Register		PV	<b>A00</b>
١	, ,			CHKD:	SCALE @ A2:
ı	PROJECT:	PROJECT NO:	ISSUE TYPE:		
١	15 Tutus St, Balgowlah Heights	PAN 0518	DA2	ISSUE DATE:	REVISION:
	Being LOT 16 in D.P. 9561	PAN 0310		14/6/19	A




Site Analysis Plan
Scale: 1:200




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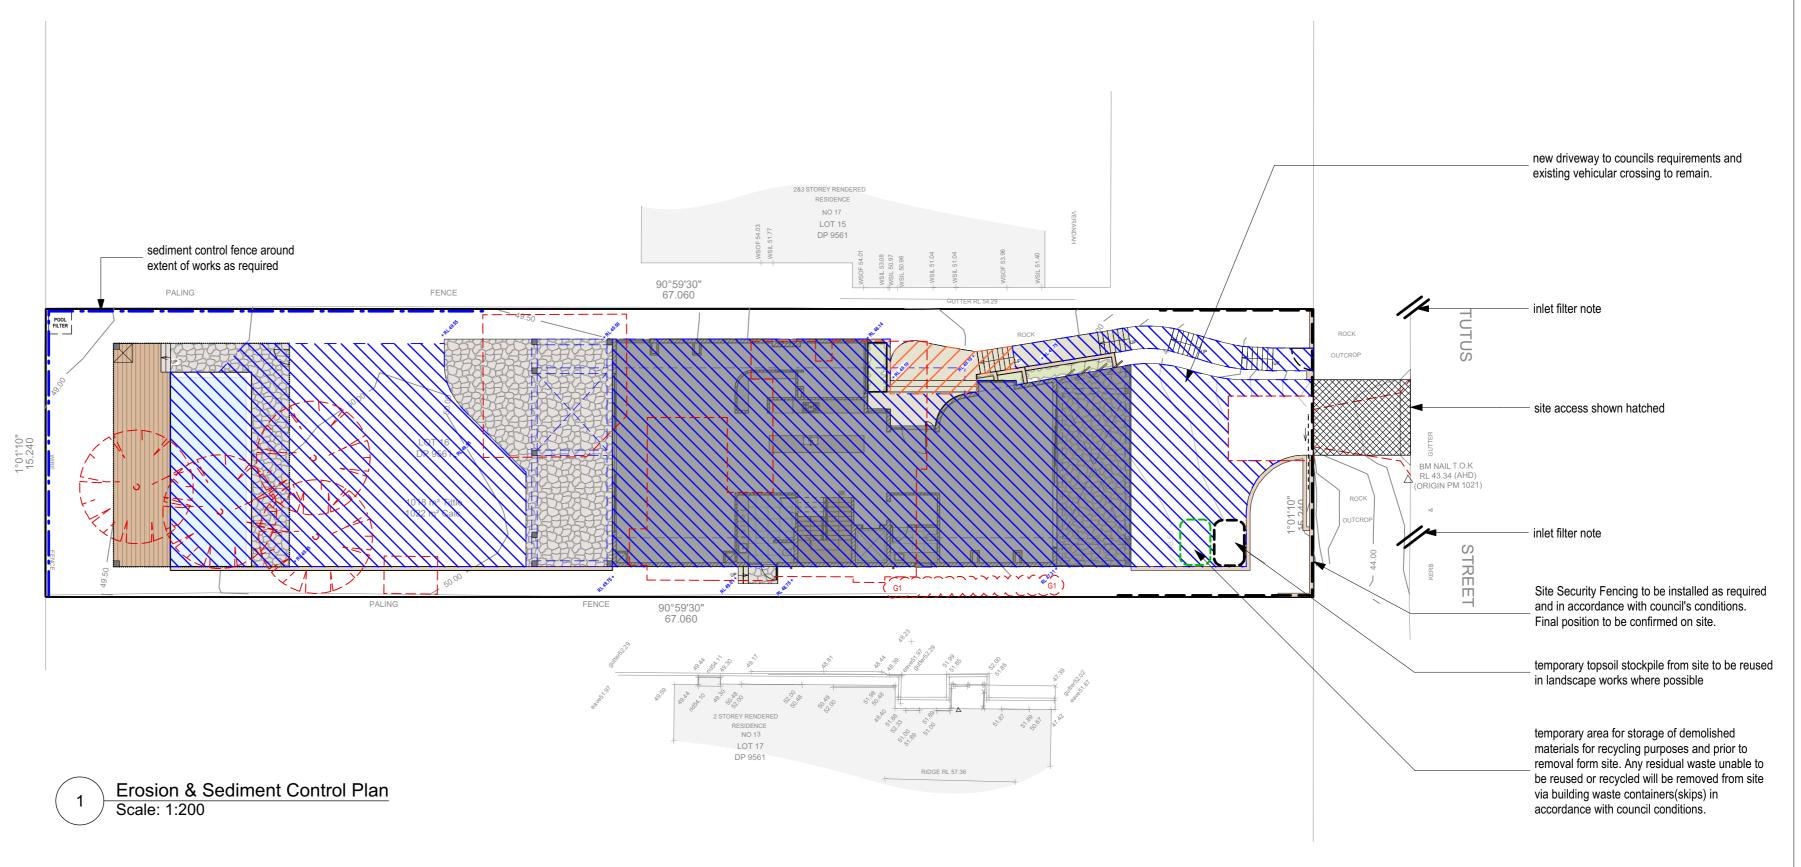
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Terrey Hills, NSW, 2084,
P 9450 1950
E info@cadenceandco.com.au
ABN: 12 168 714 752
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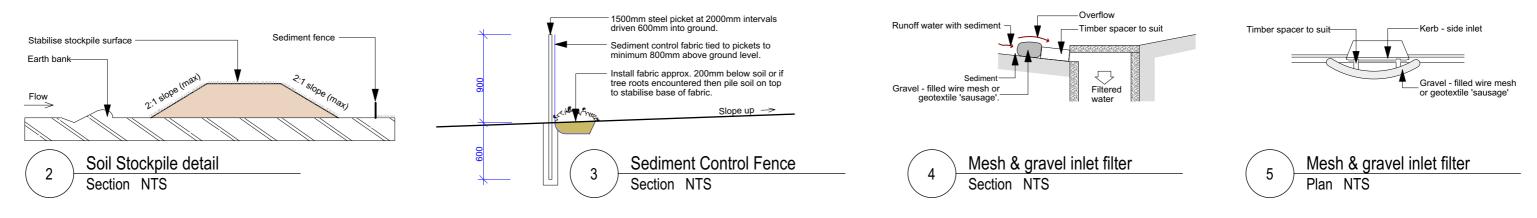
REVISION DATE REVISION NOTE



	CLIENT:	DRAWING:		DRAWN:	SHEET NO
	Colin & Emily Panagakis	Site Analysis		PV	A01
}	,			CHKD:	SCALE @ A2
/		PROJECT NO:	ISSUE TYPE:		1:200
	15 Tutus St, Balgowlah Heights	PAN 0518	DA1	ISSUE DATE:	REVISION
	Being LOT 16 in D.P. 9561	7.14.0010		11/3/19	

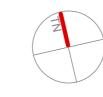



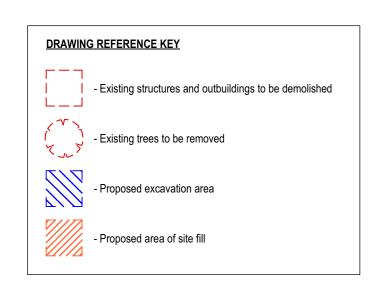


**GENERAL NOTES:** 

-Install temporary sediment control fence as shown.


-Provide temporary haybales where sediment control fence requires dismantling for site access.

-Install mesh and drainage inlet protection on stormwater inlets down slope of site


	CADENCE & CO DESIGN		REVISION	DATE	REVISION NOTE
DENCE & CO	Suite 7, 287 Mona Vale Rd, Terrey Hills, NSW, 2084, P 9450 1950 E info@cadenceandco.com.au				
	ABN: 12 168 714 752 Copyright © CADENCE & CO DESIGN PTY LTD	DA SUBMISSION ONLY - NOT FOR CONSTRUCTION			

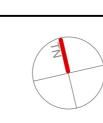

CLIENT:	DRAWING:		DRAWN:	SHEET NO:
Colin & Emily Panagakis	Erosion & Sedim	nent Ctrl. / Excav. & Fill /	PV	A02
, ,	Demolition Plan		CHKD:	SCALE @ A2
PROJECT:	PROJECT NO:	ISSUE TYPE:		1:200
15 Tutus St, Balgowlah Heights	PAN 0518	DA1	ISSUE DATE:	REVISION
Being LOT 16 in D.P. 9561	PAN 0310	DAT	11/3/19	

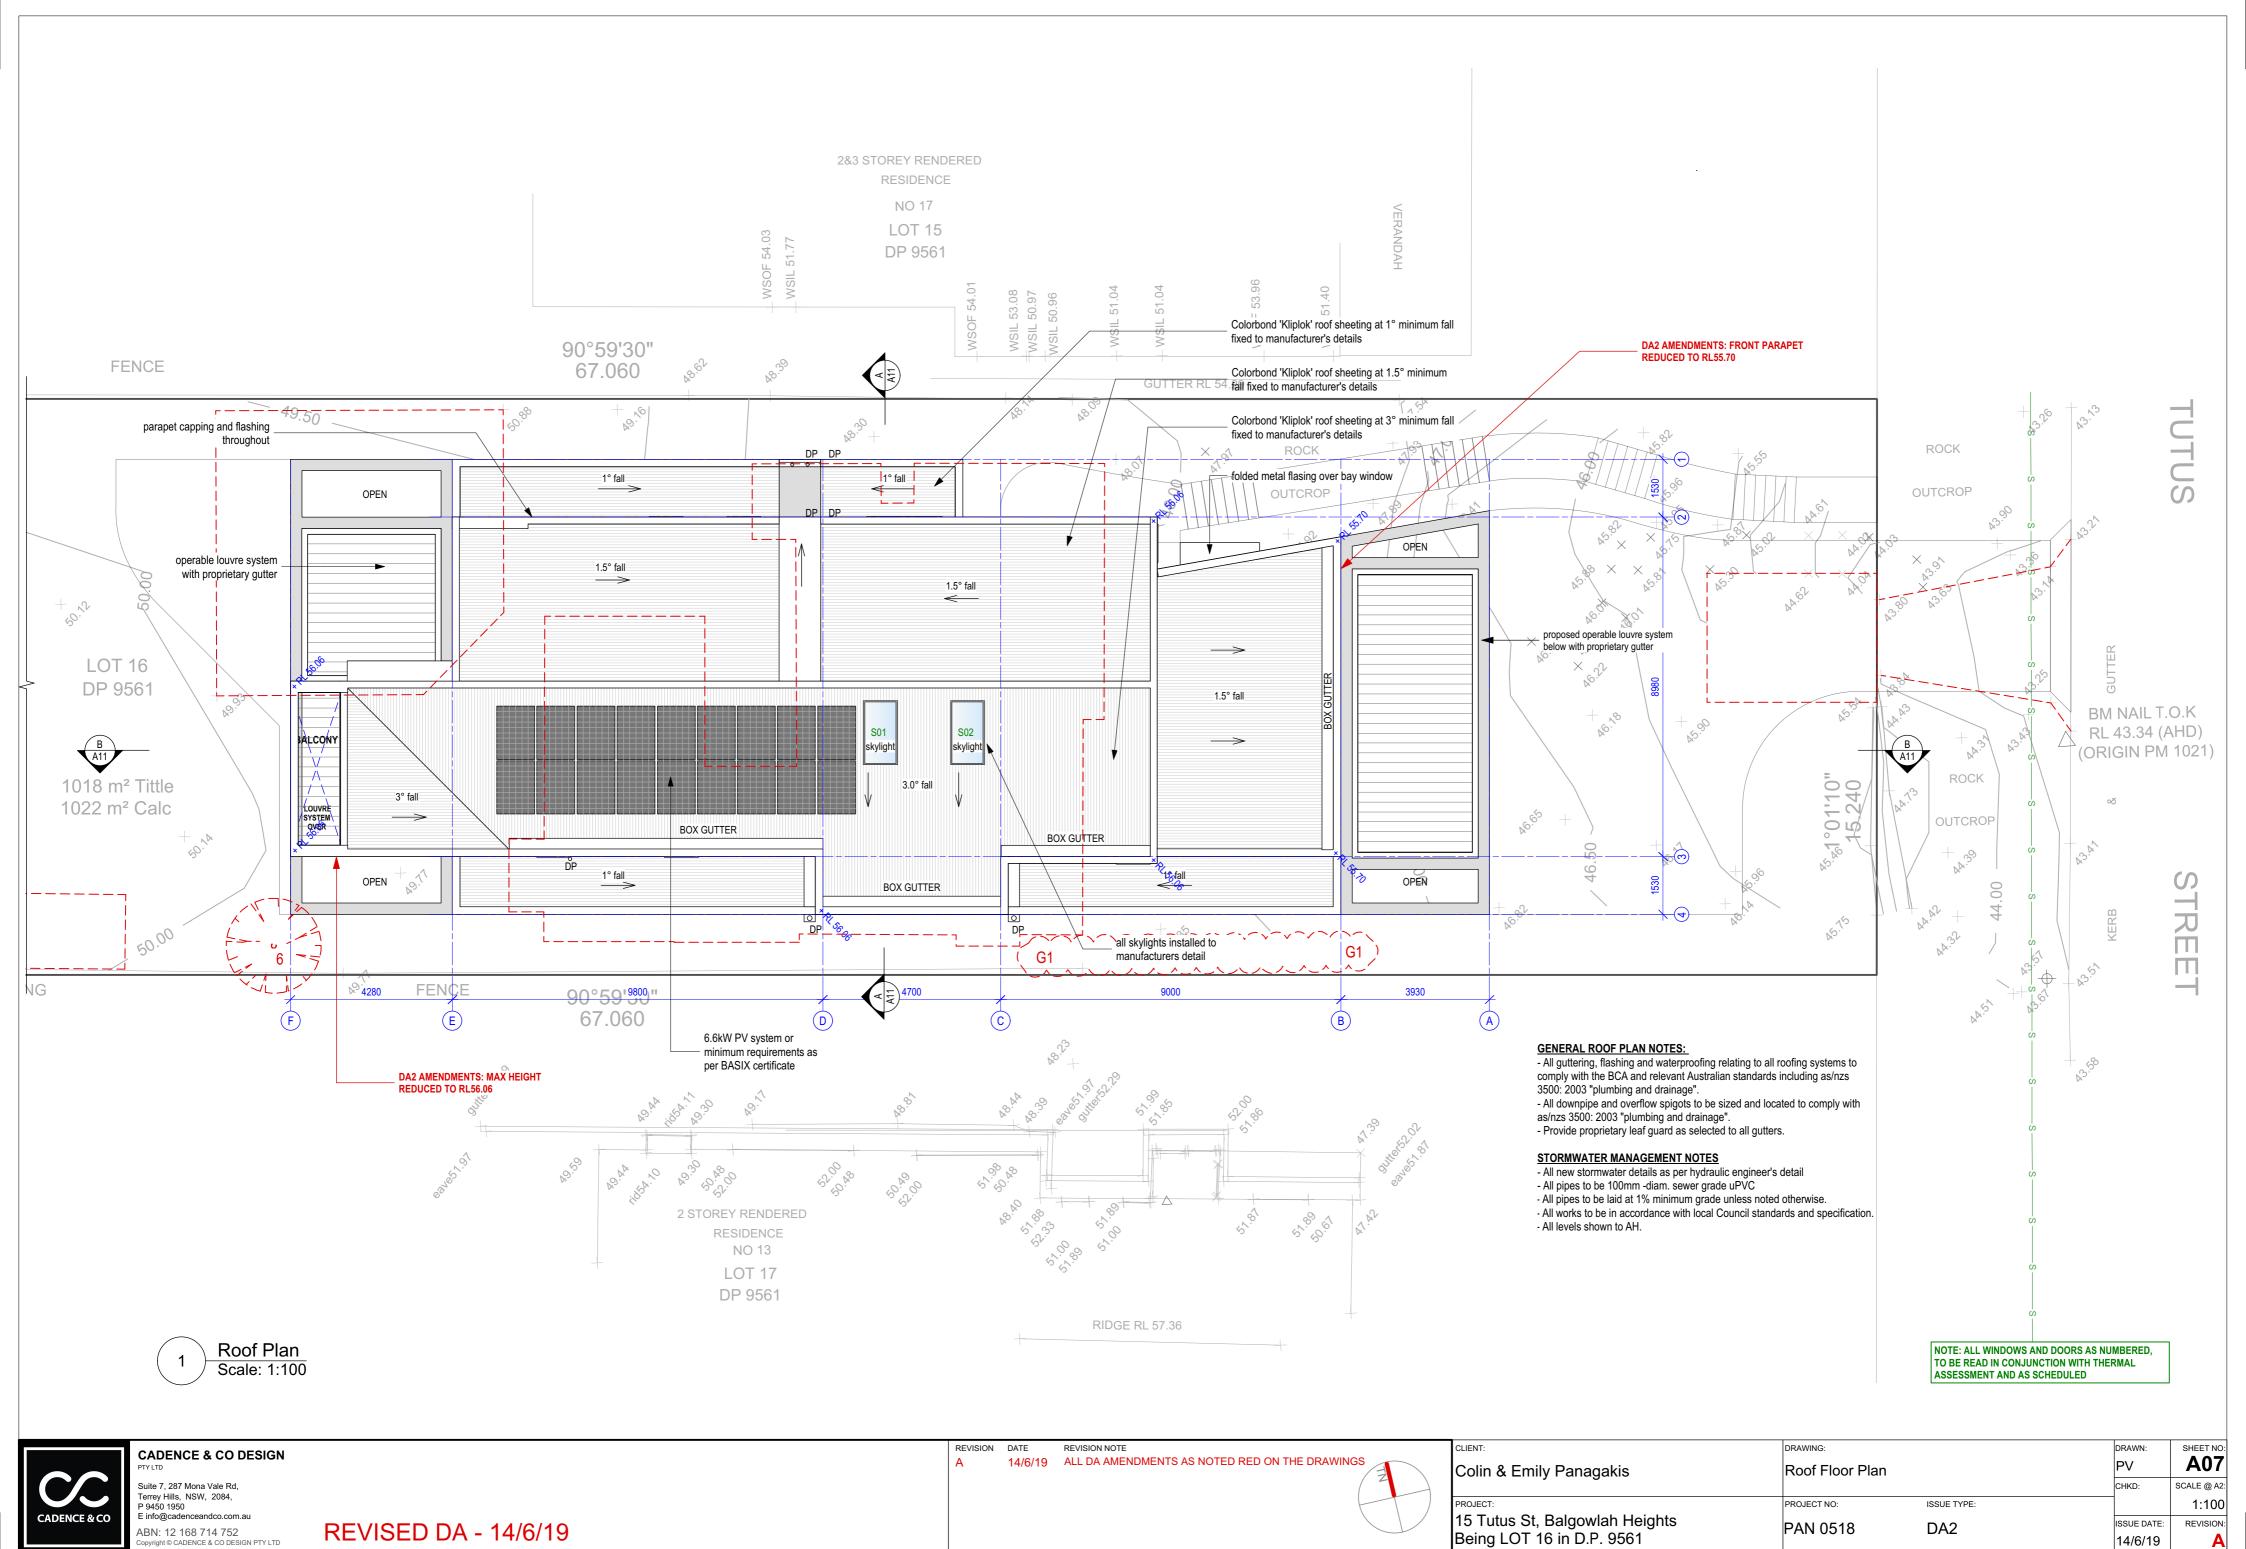

GENERAL NOTES: ALL RL'S SHOWN ARE FINISHED LEVELS, BUILDER TO PROVIDE SET DOWNS & ALLOWANCES AS REQUIRED. ALL OPENING DIMENSIONS ARE NOMINAL, BUILDER TO CHECK SIZES ON-SITE BEFORE ORDERING WINDOW AND DOOR I

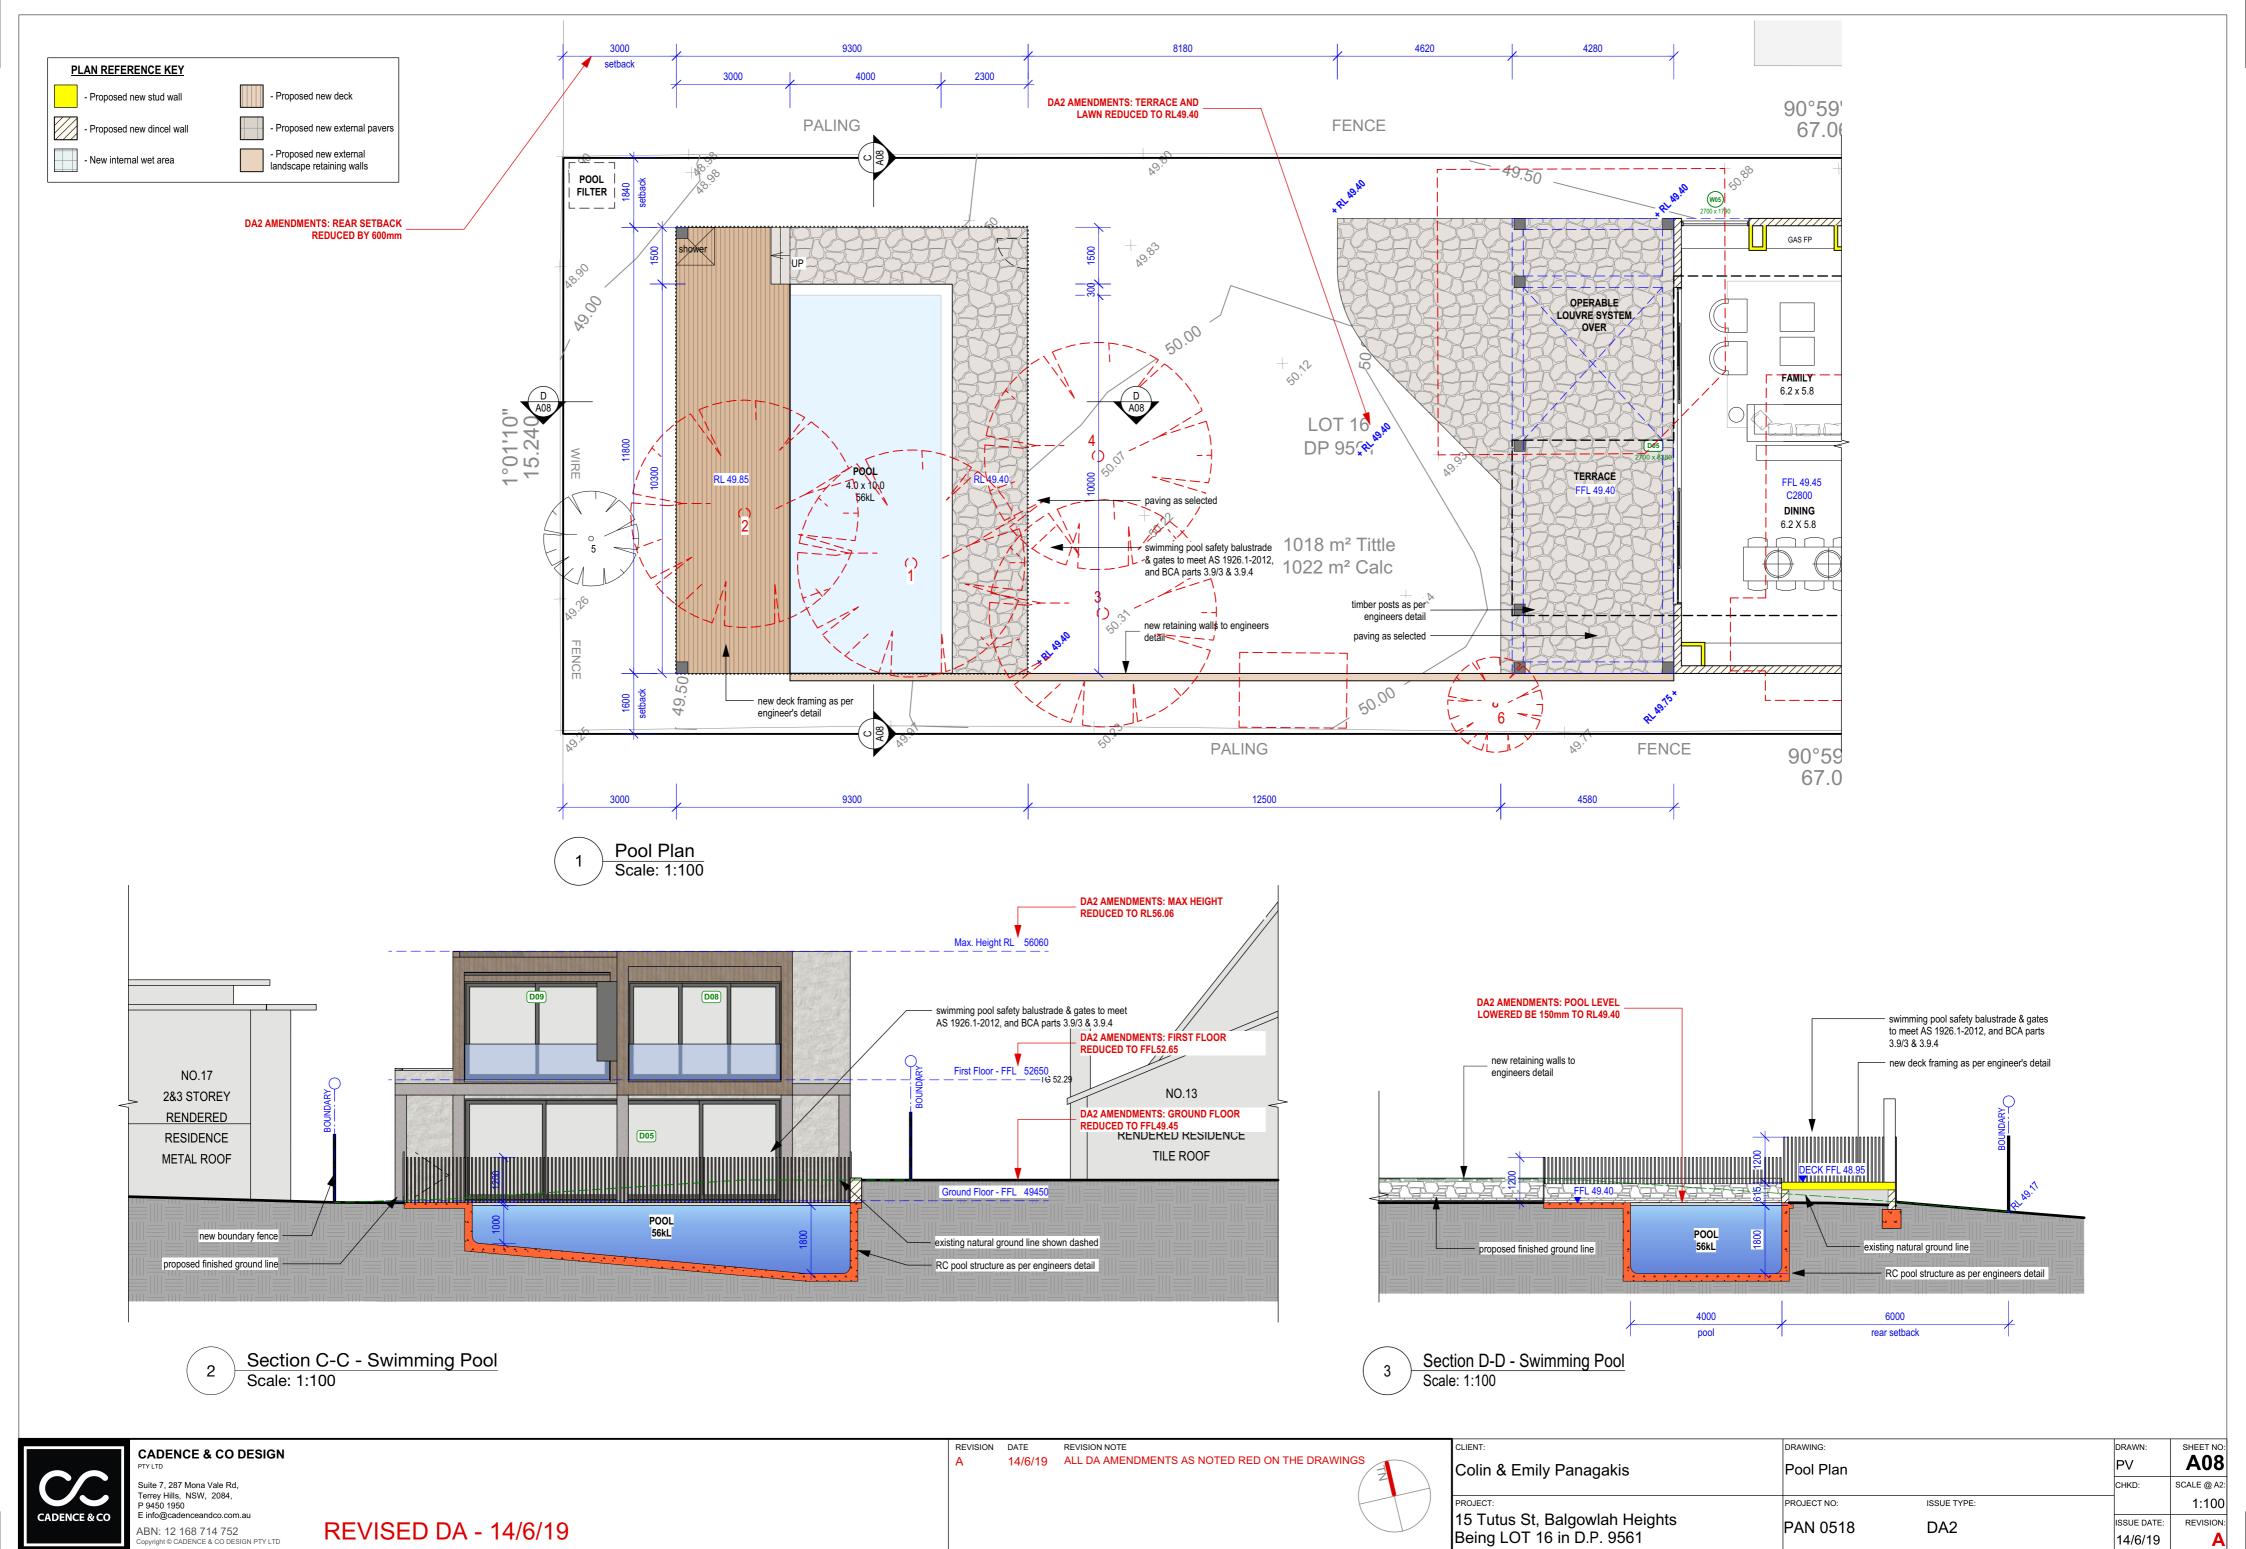



GENERAL NOTES: ALL RL'S SHOWN ARE FINISHED LEVELS, BUILDER TO PROVIDE SET DOWNS & ALLOWANCES AS REQUIRED. ALL OPENING DIMENSIONS ARE NOMINAL, BUILDER TO CHECK SIZES ON-SITE BEFORE ORDERING WINDOW AND DOOR UNITS.




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GENERAL NOTES: ALL RL'S SHOWN ARE FINISHED LEVELS, BUILDER TO PROVIDE SET DOWNS & ALLOWANCES AS REQUIRED. ALL OPENING DIMENSIONS ARE NOMINAL, BUILDER TO CHECK SIZES ON-SITE BEFORE ORDERING WINDOW AND DOOR UNITS.



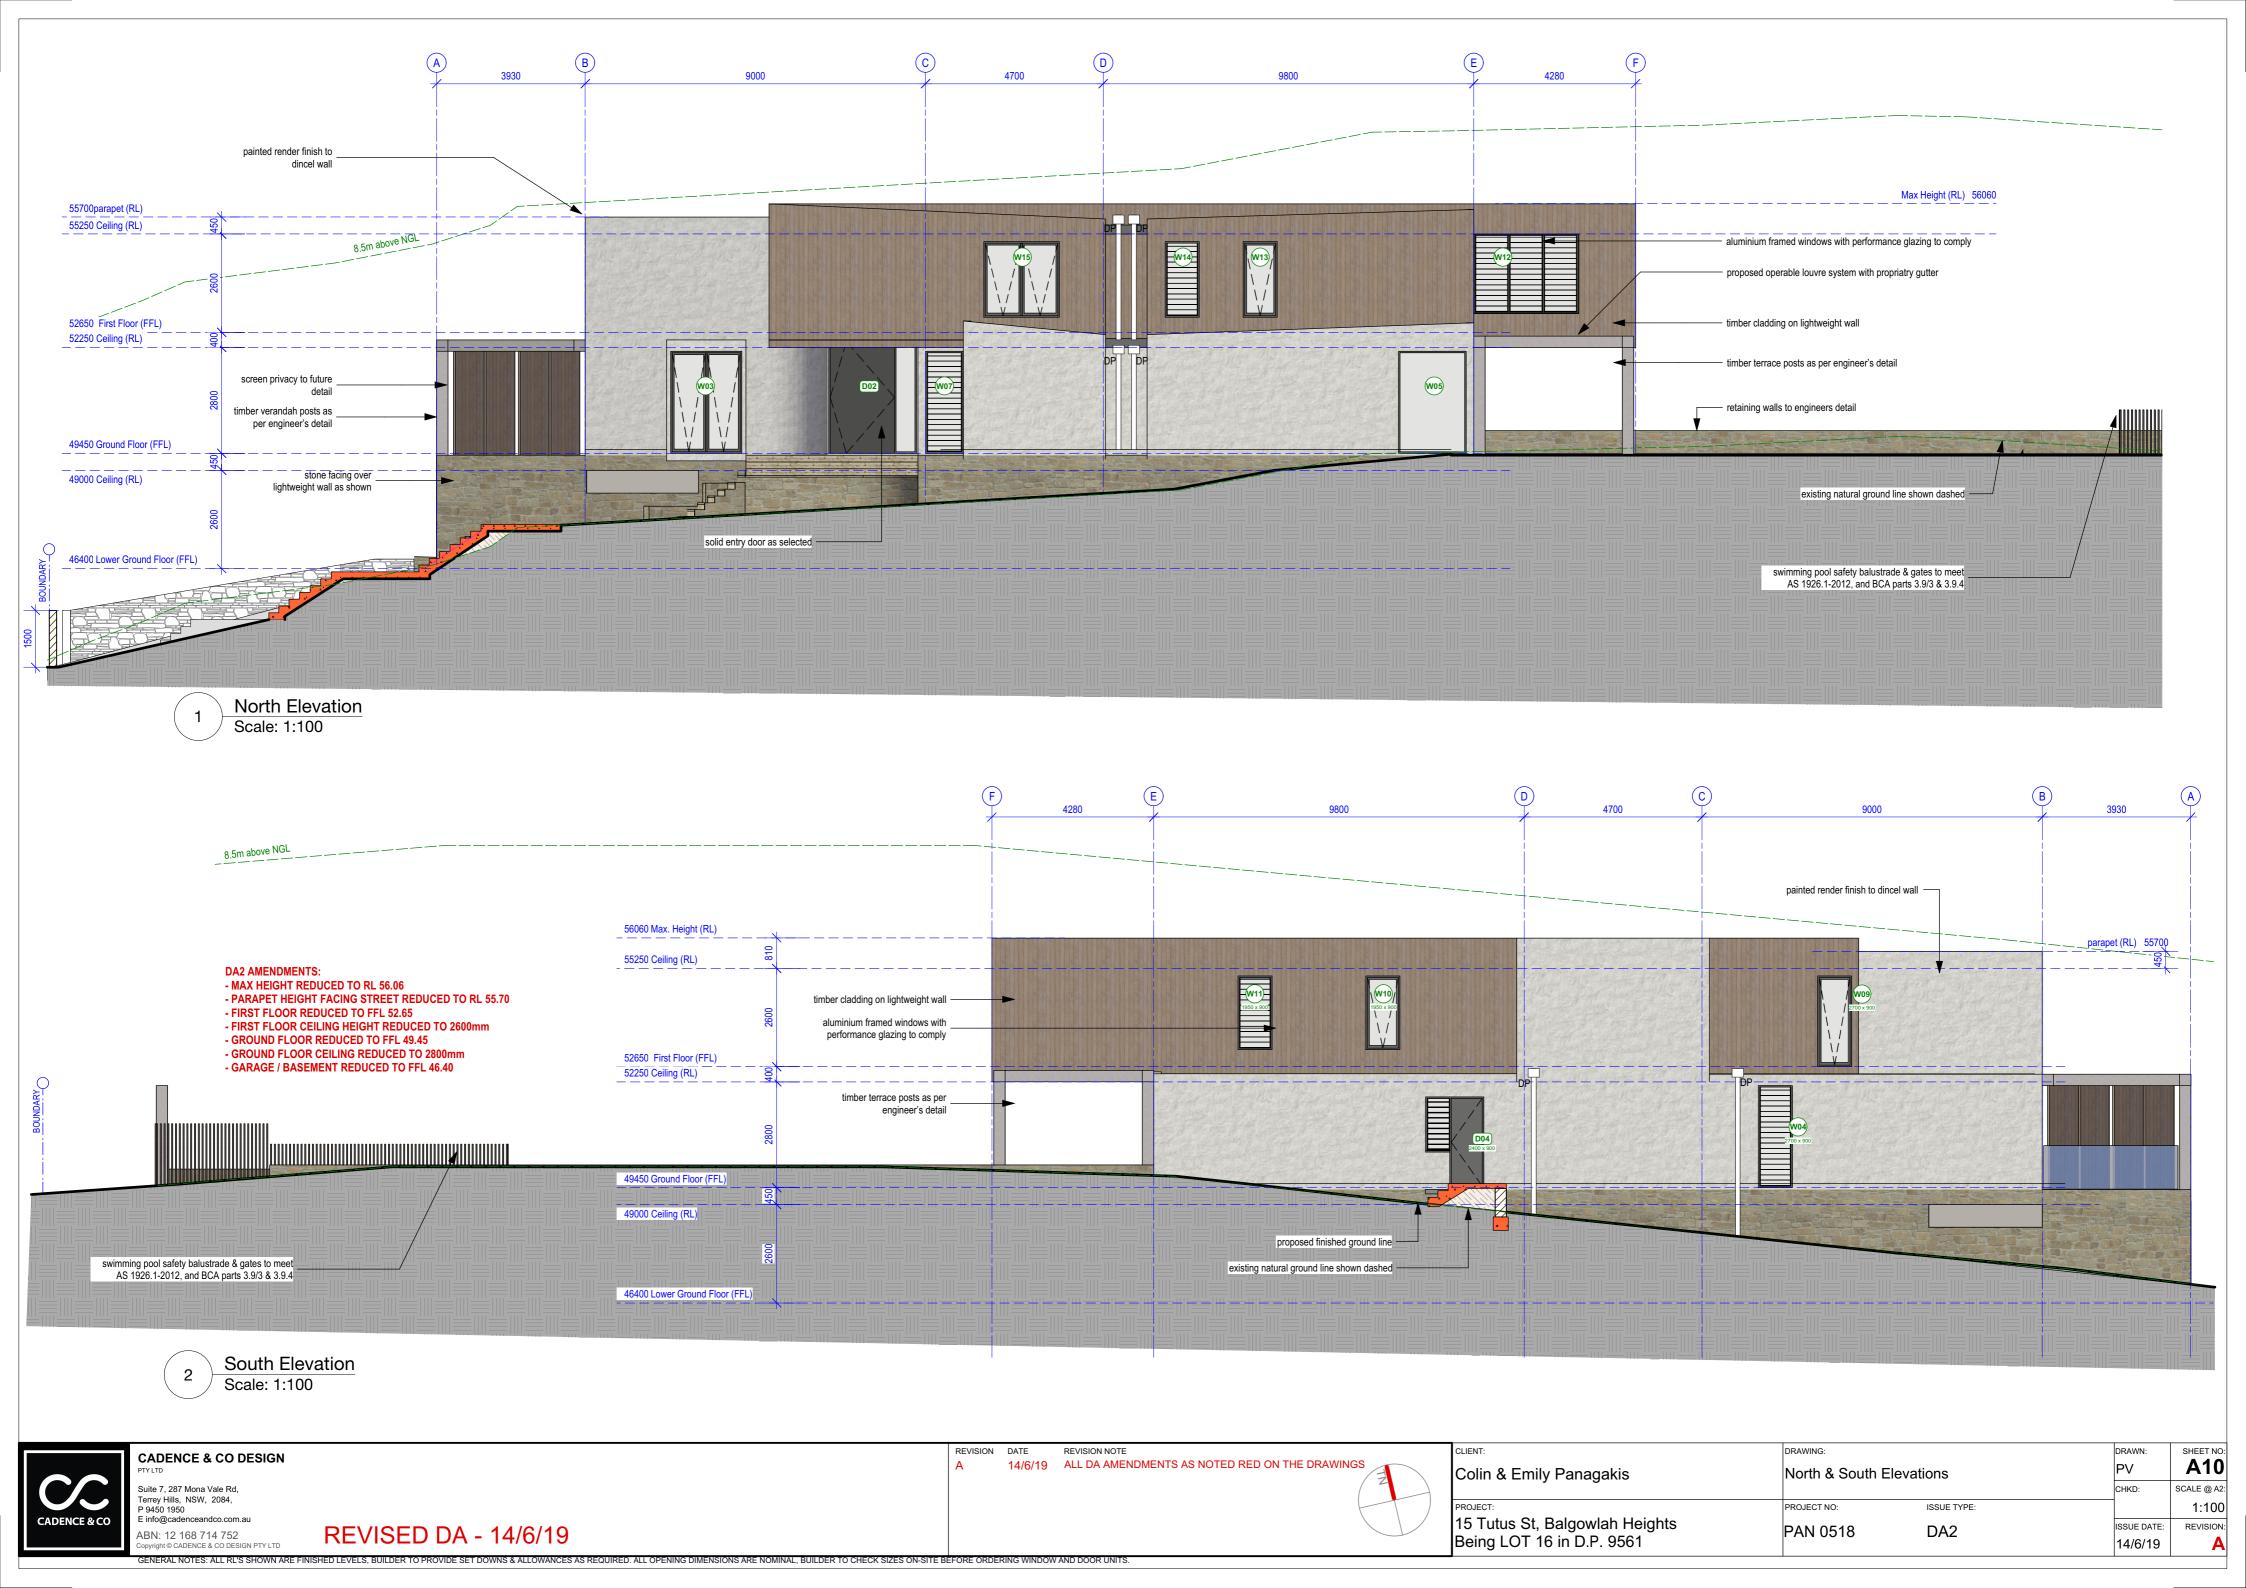

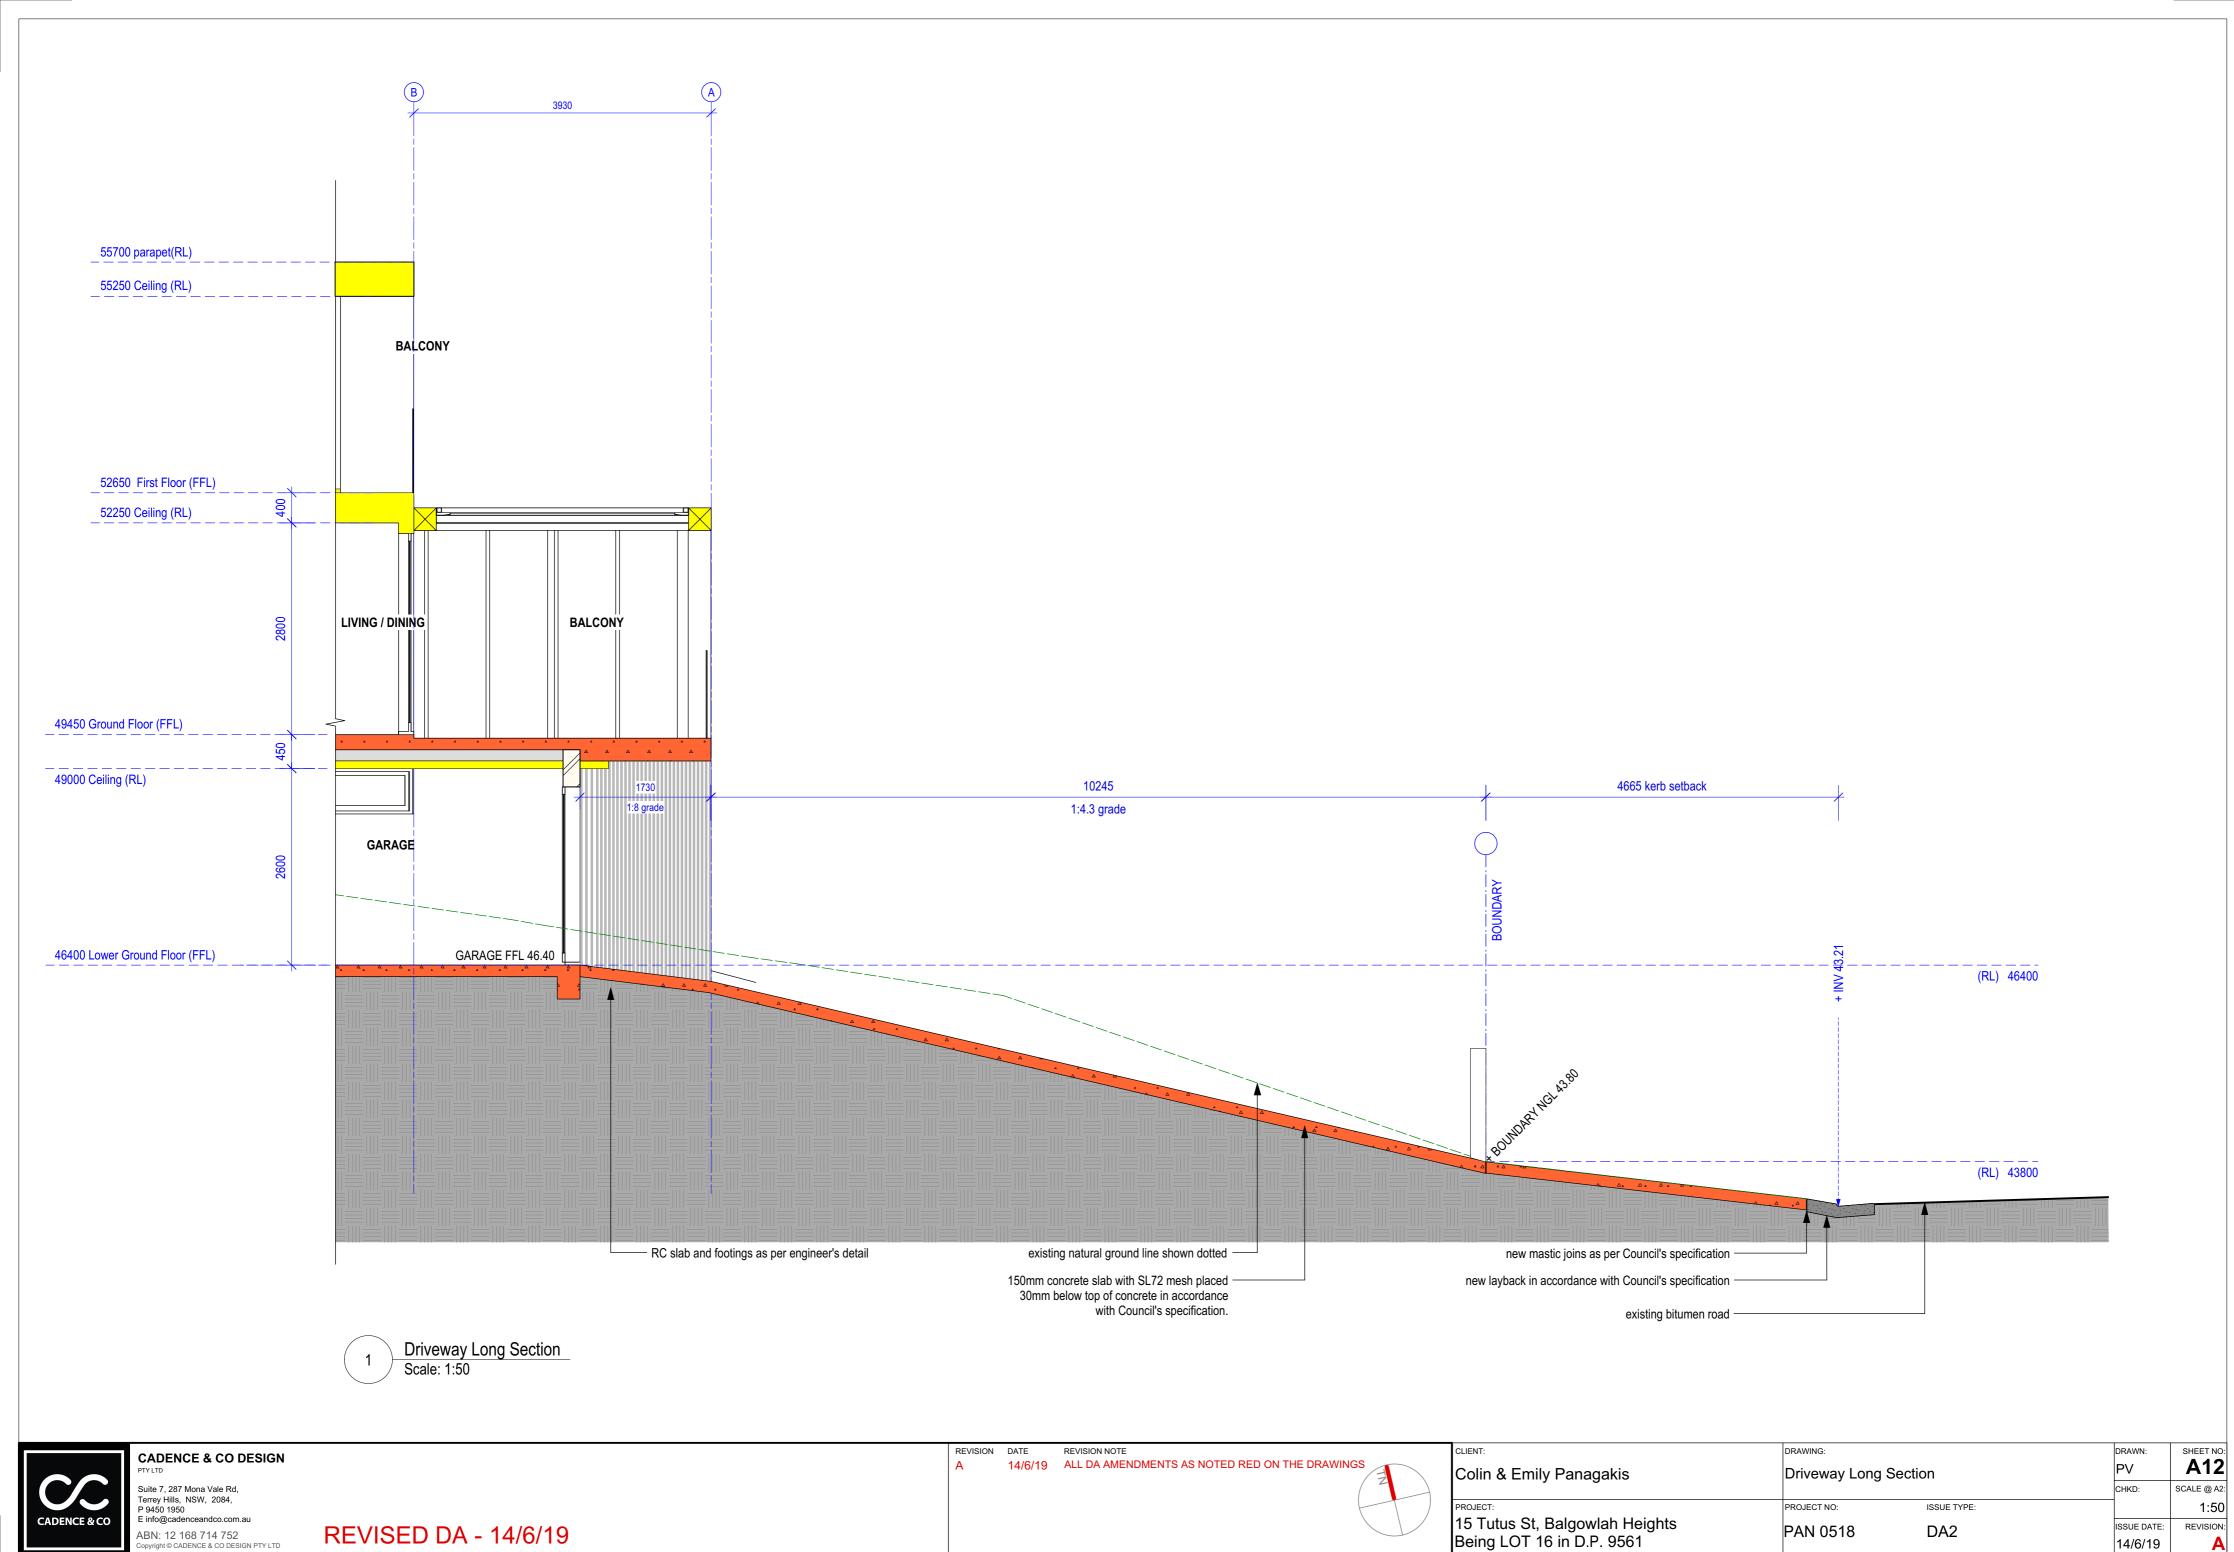GENERAL NOTES: ALL RL'S SHOWN ARE FINISHED LEVELS, BUILDER TO PROVIDE SET DOWNS & ALLOWANCES AS REQUIRED. ALL OPENING DIMENSIONS ARE NOMINAL, BUILDER TO CHECK SIZES ON-SITE BEFORE ORDERING WINDOW AND DOOR UNITS.

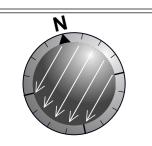

# 9:00 AM


Sydney June 21 Azimuth: 42° 32' [42° 0' east]
Altitude: 18° 56'
Solar Time: 9:03 AM

# SHADOW KEY




PROPOSED SITE SHADOWS

EXISTING SITE SHADOWS

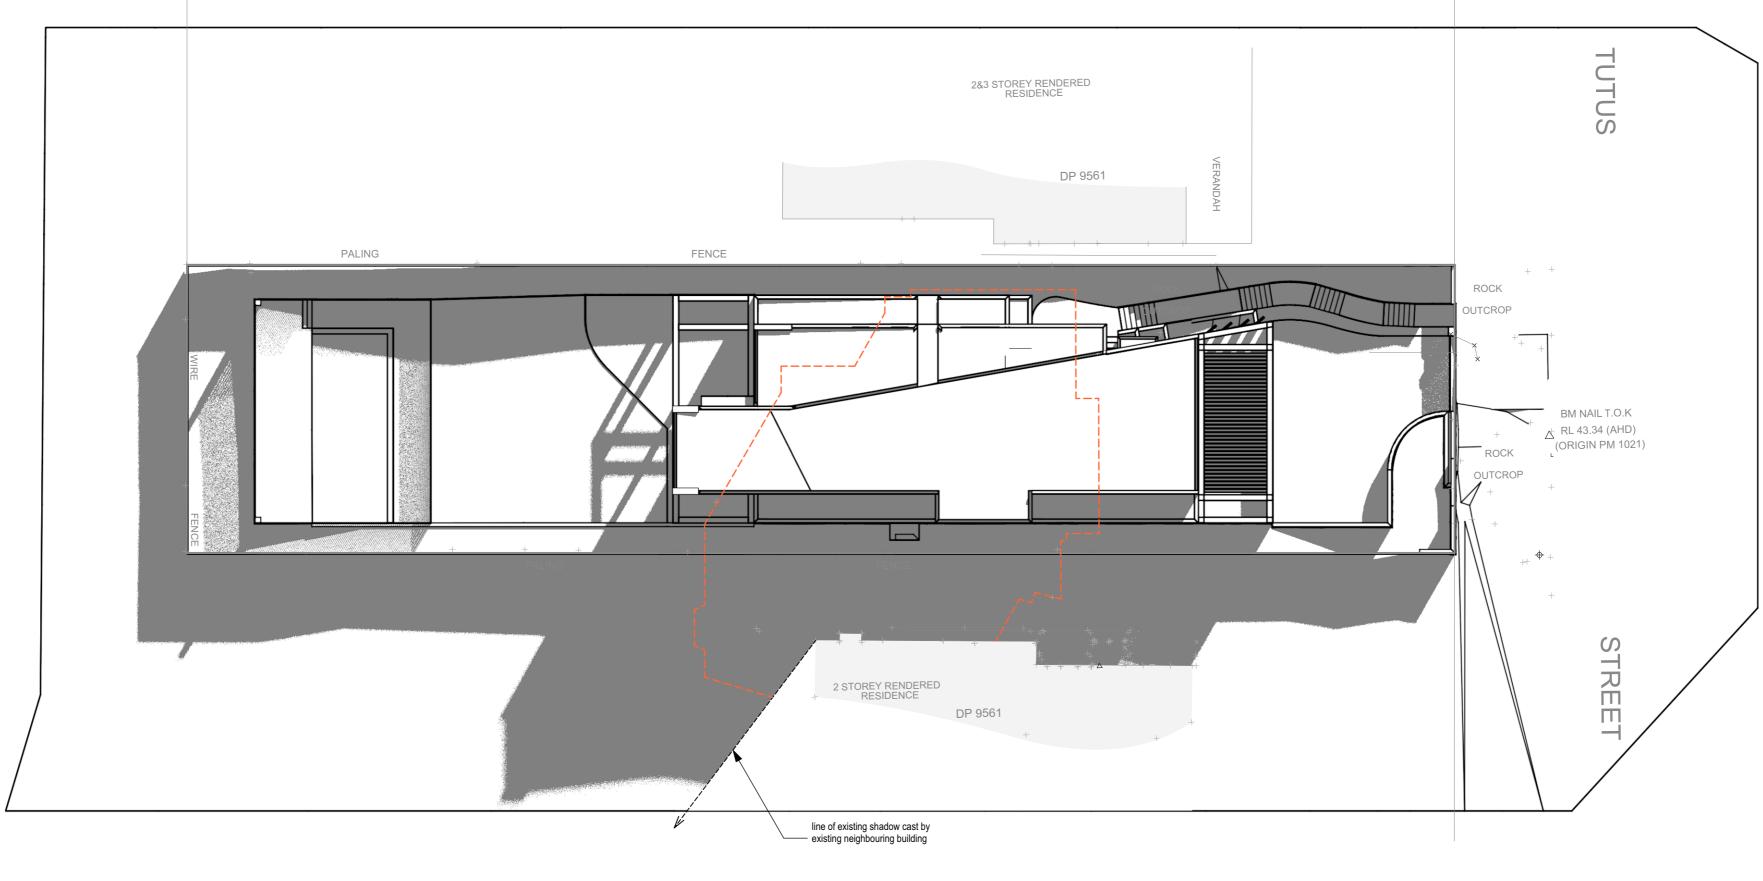

Site Shadows - June 21 @ 9am Scale: 1:200

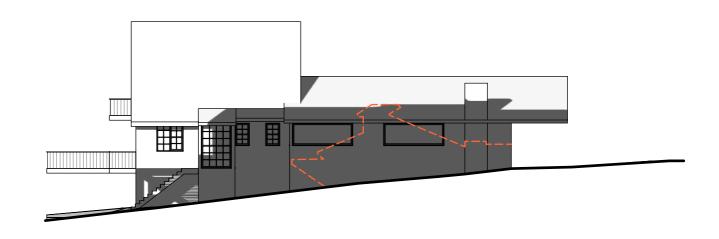

Elevational shadow diagram - June 21 @ 9am Scale: 1:200




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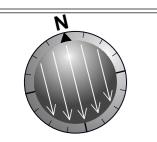
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REVISION DATE

REVISION NOTE



CLIENT:	DRAWING:		DRAWN:	SHEET NO:
Colin & Emily Panagakis	Site Shadows - June	21 @ 9am	PV	A13
, 3			CHKD:	SCALE @ A2:
PROJECT:	PROJECT NO:	ISSUE TYPE:		1:200
15 Tutus St, Balgowlah Heights	PAN 0518	DA1	ISSUE DATE:	REVISION:
Being LOT 16 in D.P. 9561	ANOSTO		11/3/19	

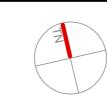

12:00 PM

Sydney June 21 Azimuth: 359° 7' [0° 0' west] Altitude: 32° 40' Solar Time: 12:03 PM

# SHADOW KEY




PROPOSED SITE SHADOWS




SHADOWS

EXISTING SITE

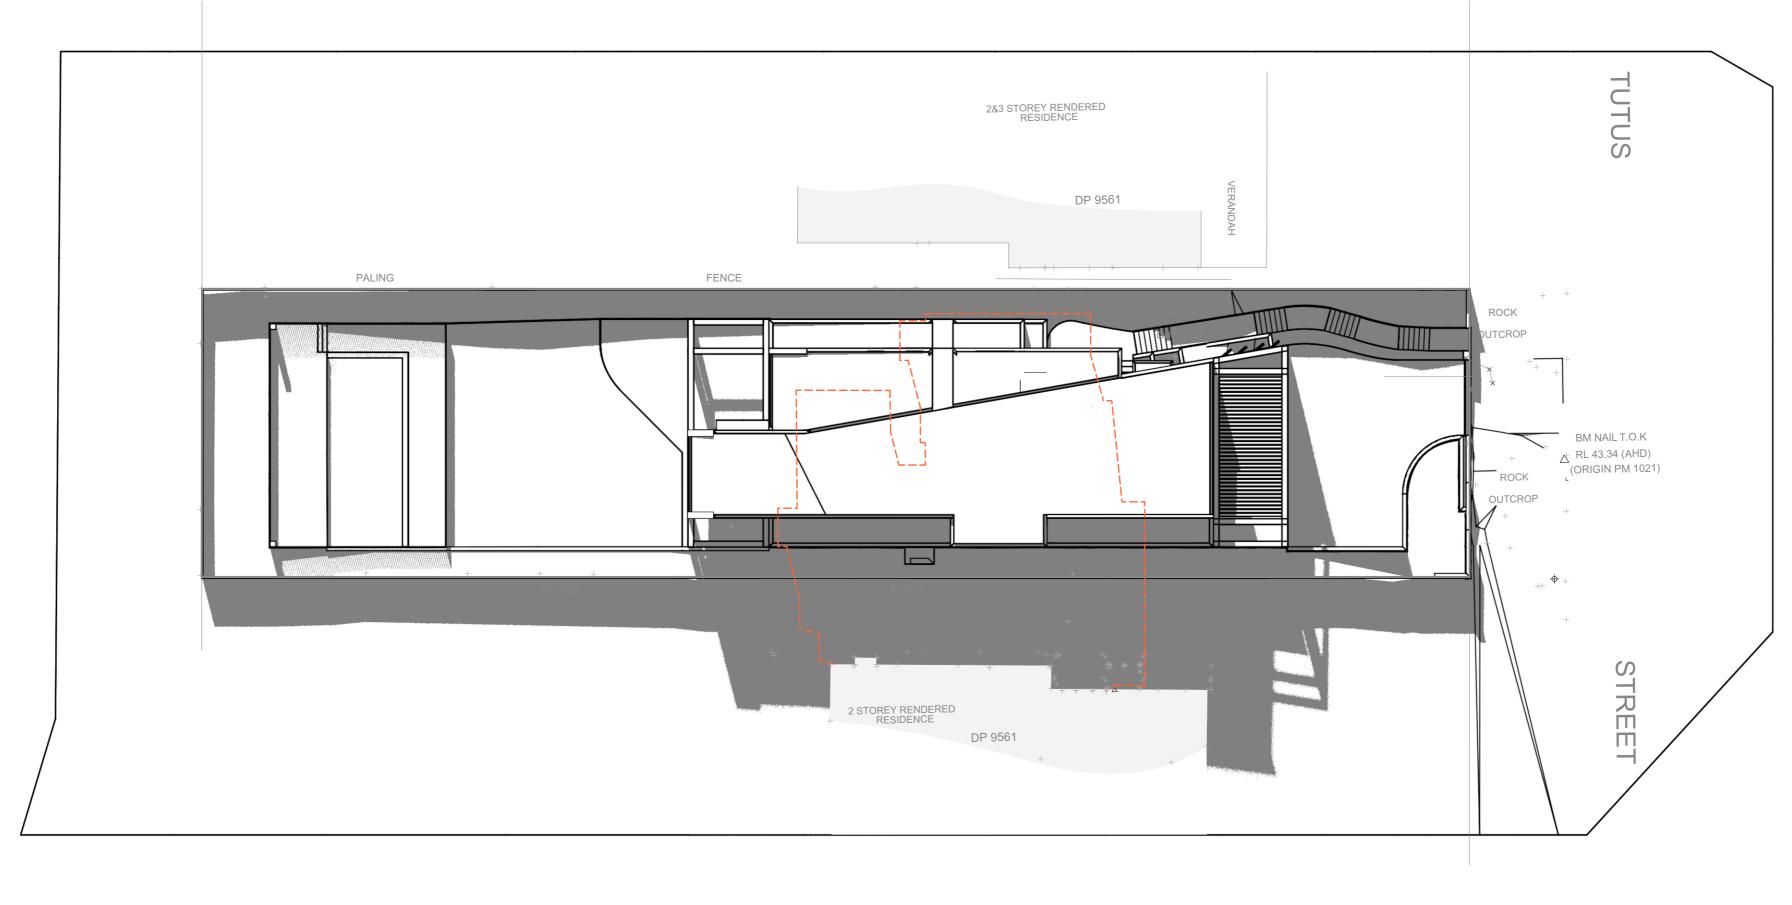

Site Shadows - June 21 @ 12noon Scale: 1:200

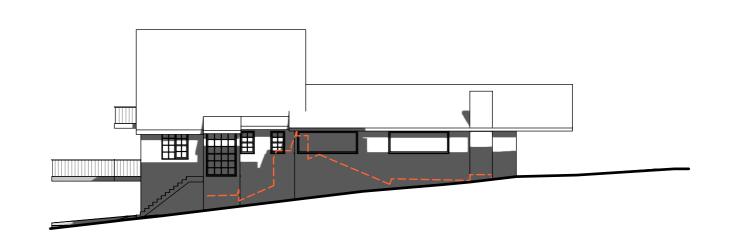

Elevational shadow diagram - June 21 @ 12noon Scale: 1:200



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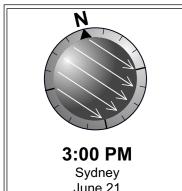
REVISION DATE

REVISION NOTE



	CLIENT:	DRAWING:		DRAWN:	SHEET NO:
	Colin & Emily Panagakis	Site Shadows - June	21 @ 12Noon	PV	A14
7	, 5			CHKD:	SCALE @ A2:
	PROJECT:	PROJECT NO:	ISSUE TYPE:		1:200
/	15 Tutus St, Balgowlah Heights	PAN 0518	DA1	ISSUE DATE:	REVISION:
	Being LOT 16 in D.P. 9561	711 05 10		11/3/19	

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Sydney
June 21
Azimuth: 316° 14' [43° 0' west]
Altitude: 18° 0'
Solar Time: 3:03 PM


SHADOW KEY



PROPOSED SITE SHADOWS

EXISTING SITE SHADOWS




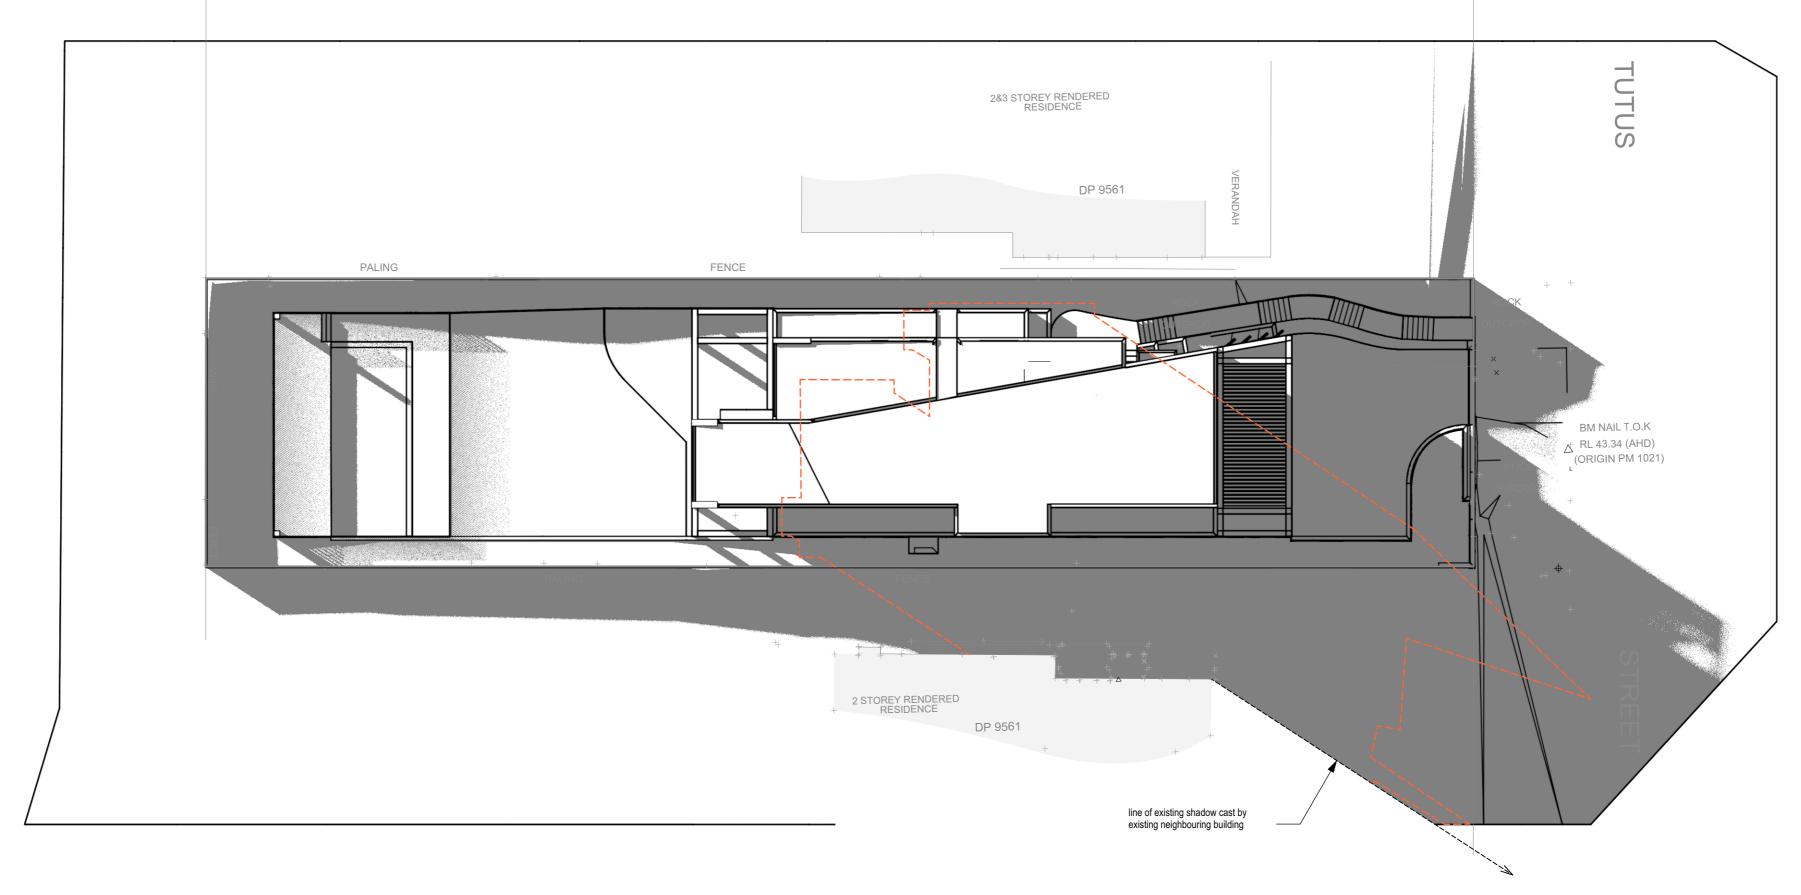

REVISION DATE

REVISION NOTE

Site Shadows - June 21 @ 3pm Scale: 1:200

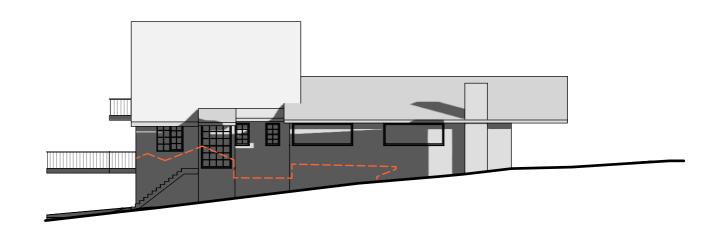

Elevational shadow diagram - June 21 @ 3pm Scale: 1:200



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CLIENT:	DRAWING:		DRAWN:	SHEET NO
Colin & Emily Panagakis	Site Shadows - June	21 @ 3pm	PV	A15
, ü			CHKD:	SCALE @ A2
	PROJECT NO:	ISSUE TYPE:		1:200
15 Tutus St, Balgowlah Heights	PAN 0518	ΠΔ1	ISSUE DATE:	REVISION
Being LOT 16 in D.P. 9561	1 711 00 10		11/3/19	
	Colin & Emily Panagakis  PROJECT:  15 Tutus St. Balgowlah Heights	Colin & Emily Panagakis  PROJECT:  15 Tutus St, Balgowlah Heights  Site Shadows - June  PROJECT NO:  PAN 0518	Colin & Emily Panagakis  Site Shadows - June 21 @ 3pm  PROJECT:  15 Tutus St, Balgowlah Heights  PAN 0518  DA1	Colin & Emily Panagakis  Site Shadows - June 21 @ 3pm  PROJECT:  PROJECT NO: ISSUE TYPE:  15 Tutus St, Balgowlah Heights  PAN 0518  DA1  ISSUE DATE:

|
ENERAL NOTES: ALL RL'S SHOWN ARE FINISHED LEVELS, BUILDER TO PROVIDE SET DOWNS & ALLOWANCES AS REQUIRED. ALL OPENING DIMENSIONS ARE NOMINAL, BUILDER TO CHECK SIZES ON-SITE BEFORE ORDERING WINDOW AND DOOF

### WINDOWS SCHEDULE **Opening Height** Head (nom.) Comments Type **Opening Width Unit Area** Glazing Type W01 600 mm 3000 mm 1.8 m2 2600 awning W02 600 mm 3000 mm 1.8 m2 2600 awning W03 2700 mm 1880 mm 5.076 m2 2700 awning 2.43 m2 2700 W04 louvre 2700 mm 900 mm 2700 mm 1790 mm 4.833 m2 2700 W05 fixed W06 awning 2700 mm 2650 mm 7.155 m2 2700 2700 mm 1000 mm 2.7 m2 2700 W07 louvre 2700 mm 2.754 m2 2700 W08 fixed 1020 mm W08 fixed 2700 mm 1020 mm 2.754 m2 2700 2.16 m2 W09 2400 mm 900 mm 2400 awning W10 1950 mm 900 mm 1.755 m2 2400 awning W11 1950 mm 900 mm 1.755 m2 2400 louvre W12 2100 mm 2770 mm 5.817 m2 2700 louvre 1950 mm 1.755 m2 2400 W13 900 mm awning W14 1950 mm 900 mm 1.755 m2 2400 louvre 2400 W15 1950 mm 2000 mm 3.9 m2 awning

# DOORS SCHEDULE

DOOK	3 3CHEDULE							
ID	Type	Opening Height	Opening Width	Unit Area	Glazing Type	Head (nom.)	No. Doors	Comments
D01	garage	2400 mm	6530 mm	15.672 m2	Solid	2400	1	Solid garage door as selected
D02	entry door	3000 mm	2320 mm	6.96 m2		3000		Solid entry pivot door as selected with 600mm side light
D03	sliding	2700 mm	8300 mm	22.41 m2		2700		Stacking sliding
D04	solid door	2400 mm	1540 mm	3.696 m2		2400		Solid door with side light
D05	sliding	2700 mm	8380 mm	22.626 m2		2700		Stacking sliding
D06	sliding	2700 mm	2670 mm	7.209 m2		2700		Stacking sliding
D07	sliding	2700 mm	4600 mm	12.42 m2		2700		Stacking sliding
D08	sliding	2700 mm	4040 mm	10.908 m2		2700		Stacking sliding
D09	sliding	2700 mm	3850 mm	10.395 m2		2700		Stacking sliding

Glazing Doors/Windows

Aluminium framed performance glazing:

U-value: 5.20 (equal to or lower than) SHGC: 0.49 (±10%)

Given values are AFRC total window system values (glass and frame)

**Note:** Openability modelled as per BASIX Thermal Protocol – 4.14.2 and NatHERS Technical Note 1.2 – 10.11 with regards

to restricted openings

Skylights

Double glazed with timber or aluminium frame

R1.5 insulation to skylight shaft

## NOTES

- 1. All external glazing units to have powder coated aluminium frames as selected. Owner to give final approval to external glazing units before ordering.
- 2. All glazing to comply with U-Value and SHGC as specified in the Thermal report, and Part 3.6 of the current BCA.
- 3. Dimensions given are nominal and to suit scheduled opening sizes - Contractor to check all dimensions on site before ordering glazing units. Contact Cadence & Co Design if dimensions conflict.
- 4. Refer to Elevations for fixed/openable sashes.
- 5. Provide approved matching insect screens to opening window and door sashes. 6. Internal door sixes generally as noted on plan, to be painted flush solid core doors unless noted otherwise.
- 7. Provide Brio (or similar) retractable screens to all glazed external sliding doors. Owner to confirm
- 8. The highest Bushfire Attack Level to the proposed dwelling was determined from Table 2.4.2 of AS3959 – 2009 to be 'BAL 12.5'. The proposed dwelling is required to comply with section 3 and BAL 12.5 section 5 under AS 3959 – 2009 and Addendum Appendix 3 under PBP 2006.

## **EXTERNAL FINISHES SCHEDULE**



TIMBER WEATHERBOARD

HARDWOOD CLADDING

CLADDING



PAINTED RENDER

PAINTED WARM GREY



SANDSTONE FACING

SANDSTONE FACING



**ALUMINIUM WINDOW AND EXTERNAL DOOR FRAMES** 

DARK GREY / CHARCOAL


**EXTERNAL WOODWORK / FASCIA'S & GUTTERS** 

DARK GREY / CHARCOAL



DECKING

HARDWOOD AS SELECTED

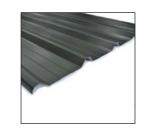

STEEL ROOF SHEETING -'KLIPLOK' or similar

eg. MONUMENT

NOTE: All colour selections shall be sampled and swatch tested on subject surface prior to final application.

Colours represented on this schedule do NOT necessarily reflect true colours.



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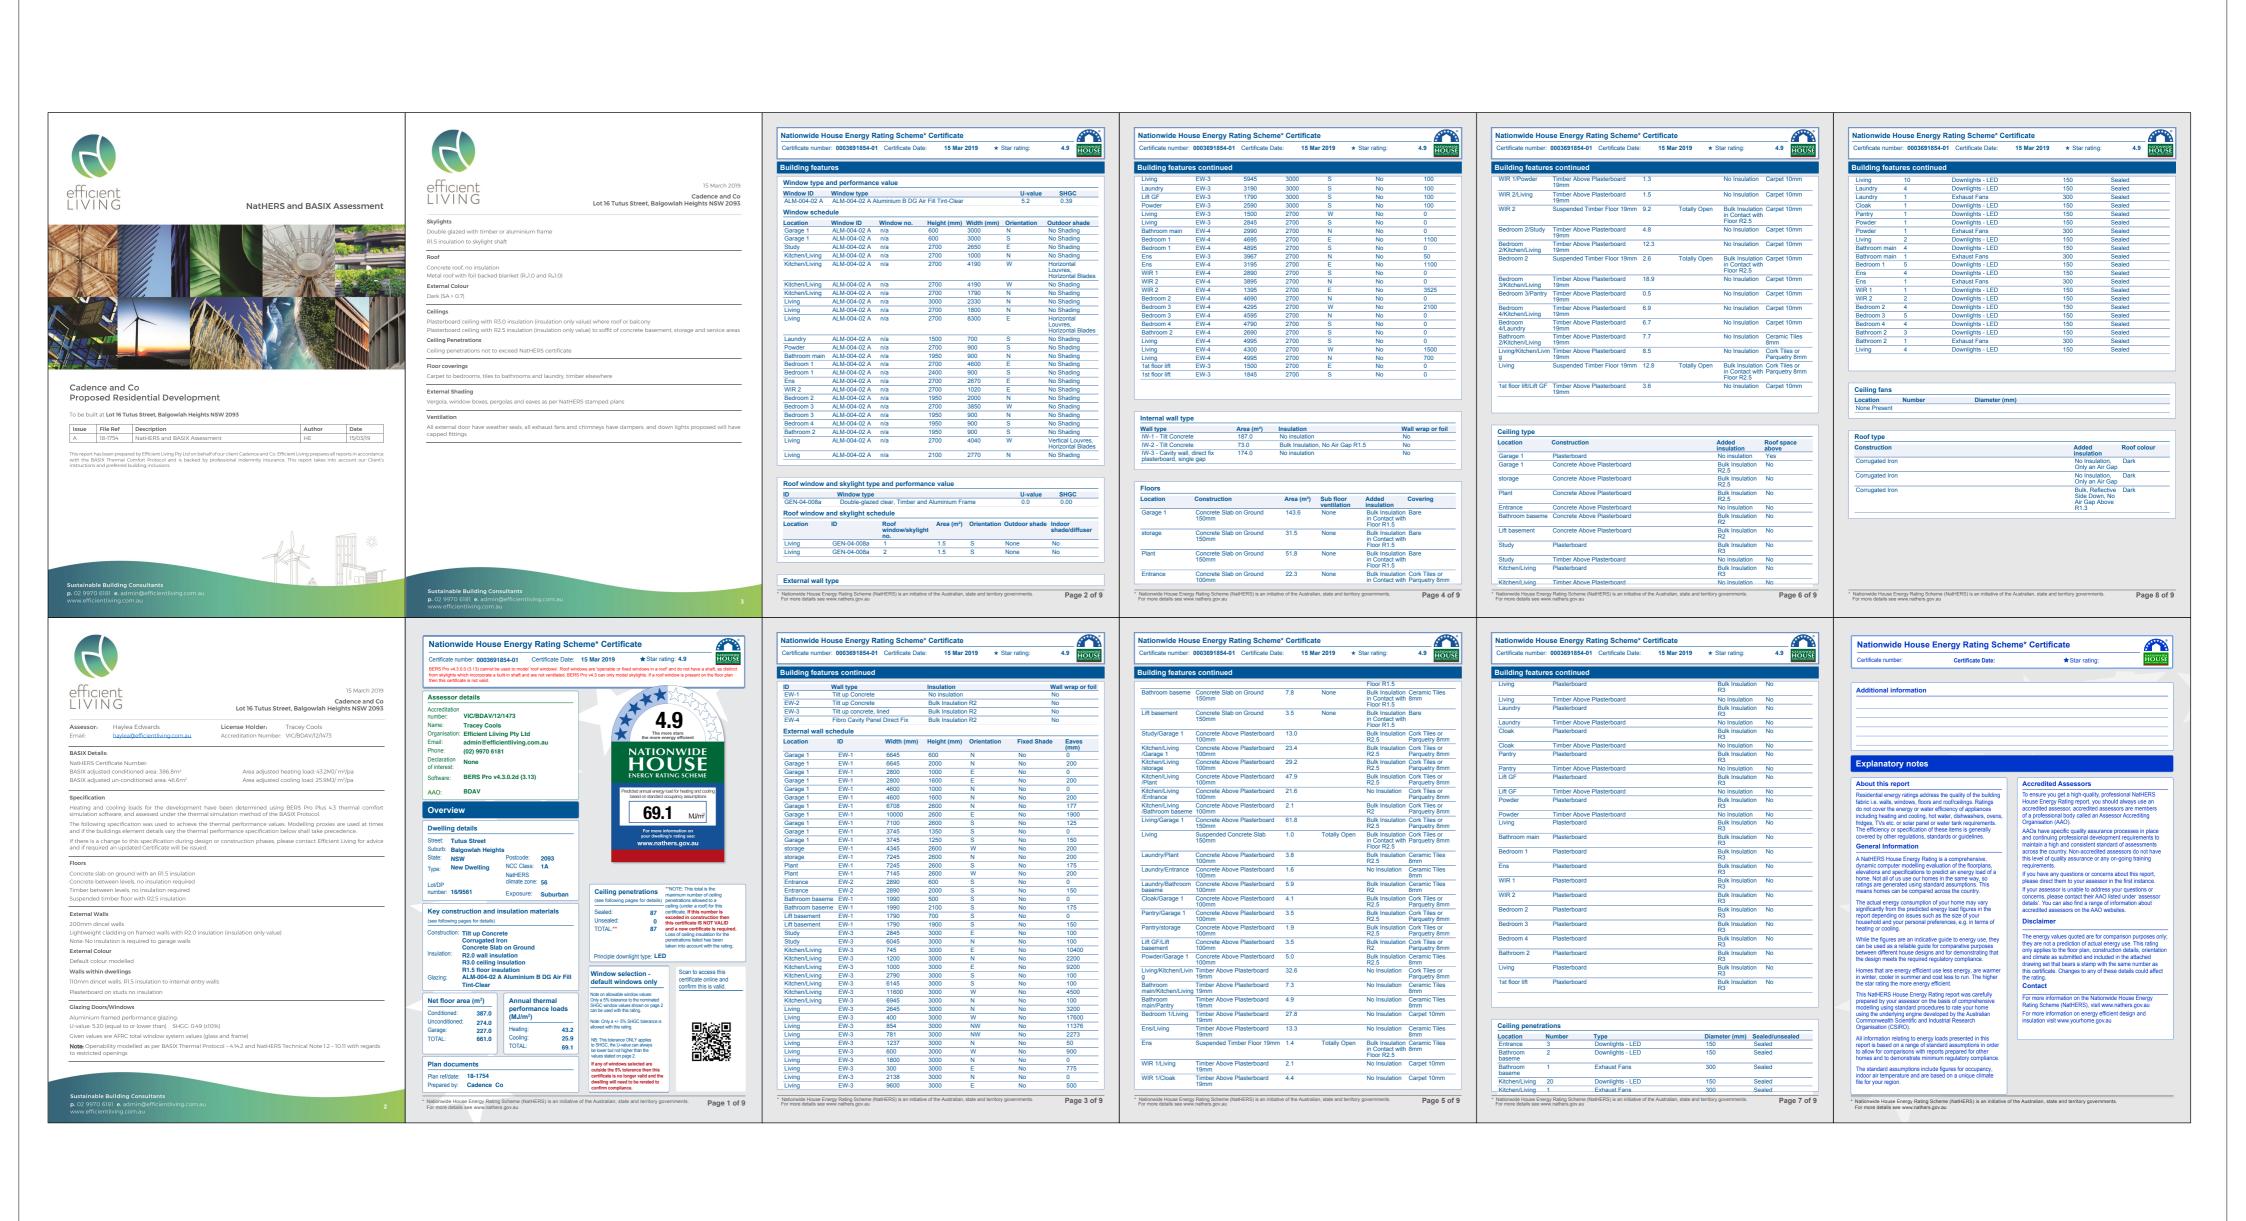
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REVISION DATE REVISION NOTE Colin & Emily Panagakis 15 Tutus St, Balgowlah Heights

Being LOT 16 in D.P. 9561

DRAWING: External Window & Door Schedule PROJECT NO: ISSUE TYPE: PAN 0518 DA1

SHEET NO: **A17** DV CHKD: SCALE @ A2: 1:100 REVISION: ISSUE DATE: 11/3/19





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REVISION DATE REVISION NOTE

SHEET NO: **A18** DV Colin & Emily Panagakis Thermal Performance Requirements CHKD: SCALE @ A2: 1:100 PROJECT NO: ISSUE TYPE: 15 Tutus St, Balgowlah Heights REVISION: ISSUE DATE: PAN 0518 DA1 Being LOT 16 in D.P. 9561 11/3/19



This certificate confirms that the proposed development will meet the NSW government's requirements for sustainability, if it is built in accordance with the commitments set out below. Terms used in this certificate, or in the commitments, have the meaning given by the document entitled "BASIX Definitions" dated 06/10/2017 published by the Department. This document is available at www.basix.nsw.gov.au

Secretary
Date of issue: Monday, 18 March 2019
To be valid, this certificate must be lodged within 3 months of the date of issue.




Project summary		
Project name	15 Tutus Street, Balgowla	n Heights
Street address	15 Tutus Street Balgowla	h Heights 2093
Local Government Area	Northern Beaches Counc	il
Plan type and plan number	deposited 16	
Lot no.	9561	
Section no.	-	
Project type	separate dwelling house	
No. of bedrooms	4	
Project score		
Water	<b>✓</b> 43	Target 40
Thermal Comfort	<b>✓</b> Pass	Target Pass
Energy	<b>✓</b> 53	Target 50
·		

Certificate Prepared by	
Name / Company Name: Efficient Living Pty Ltd	
ABN (if applicable): 82116346082	


BASIX Planning & Environment www.basix.nsw.gov.au Version: 3.0 / DARWINIA\_3\_8\_8 Certificate No.: 994011S Monday, 18 March 2019


Water Commitments			Show on DA plans	Show on CC/CDC plans & specs	Certifier check
The swimming pool must be outdoors.			~	~	
X Planning & Environment www.basix.nsw.go	v.au Version: 3.0 / DARWINIA_3_8_8	Certificate No.: 994011S	Monday, 18 Marc		pa


Energy Commitments	Show on DA plans	Show on CC/CDC plans & specs	Certifie check
all bathrooms/toilets;		~	~
• the laundry;		•	
• all hallways;		•	
Natural lighting			·
The applicant must install a window and/or skylight in 4 bathroom(s)/toilet(s) in the development for natural lighting.	~	~	~
Swimming pool			
The applicant must install the following heating system for the swimming pool in the development (or alternatively must not install any heating system for the swimming pool): solar only		~	
The applicant must install a timer for the swimming pool pump in the development.		<b>~</b>	
Alternative energy			
The applicant must install a photovoltaic system with the capacity to generate at least 2 peak kilowatts of electricity as part of the development. The applicant must connect this system to the development's electrical system.	~	~	~
Other			
The applicant must install a gas cooktop & electric oven in the kitchen of the dwelling.		•	
The applicant must install a fixed outdoor clothes drying line as part of the development.		~	

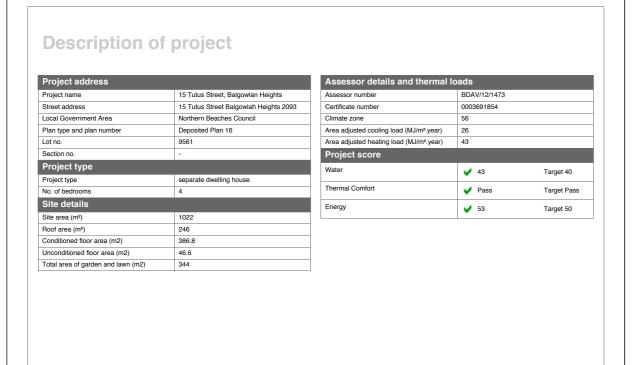

BASIX Planning & Environment www.basix.nsw.gov.au Version: 3.0 / DARWINIA\_3\_8\_8 Certificate No.: 994011S Monday, 18 March 2019

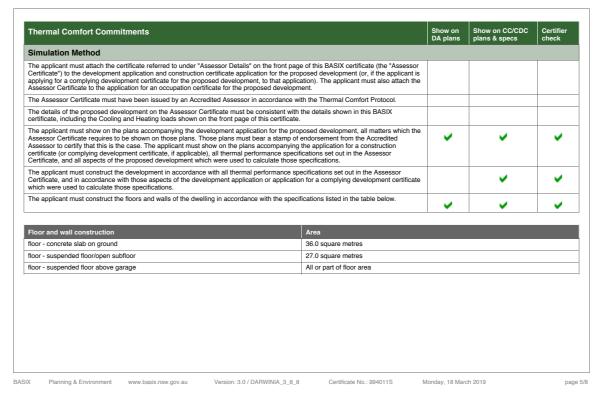

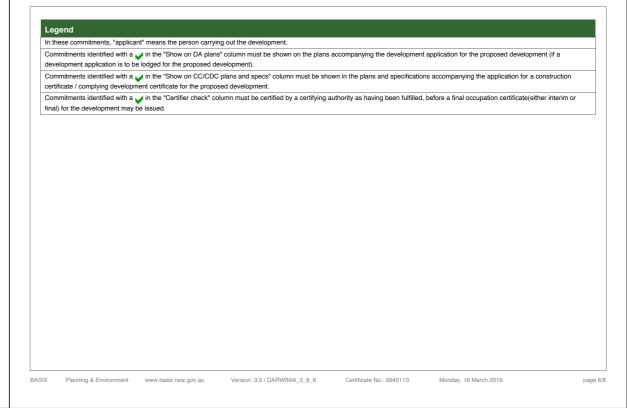

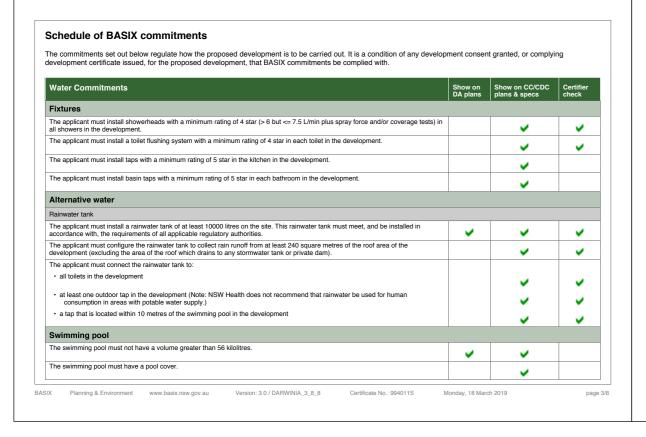

Energy Commitments	Show on DA plans	Show on CC/CDC plans & specs	Certifier check
Hot water			
The applicant must install the following hot water system in the development, or a system with a higher energy rating: gas nstantaneous with a performance of 6 stars.	~	V	~
Cooling system			
The applicant must install the following cooling system, or a system with a higher energy rating, in at least 1 living area: 3-phase airconditioning; Energy rating: EER 3.0 - 3.5		~	~
The applicant must install the following cooling system, or a system with a higher energy rating, in at least 1 bedroom: 3-phase airconditioning; Energy rating: EER 3.0 - 3.5		~	~
Heating system			
The applicant must install the following heating system, or a system with a higher energy rating, in at least 1 living area: gas fixed flued leater; Energy rating: 4 Star		~	~
The applicant must install the following heating system, or a system with a higher energy rating, in at least 1 bedroom: 3-phase airconditioning; Energy rating: EER 3.5 - 4.0		~	~
/entilation			
The applicant must install the following exhaust systems in the development:			
At least 1 Bathroom: individual fan, ducted to façade or roof; Operation control: manual switch on/off		•	•
Kitchen: individual fan, ducted to façade or roof; Operation control: manual switch on/off		•	•
Laundry: individual fan, ducted to façade or roof; Operation control: manual switch on/off		•	•
Artificial lighting			
The applicant must ensure that the "primary type of artificial lighting" is fluorescent or light emitting diode (LED) lighting in each of the ollowing rooms, and where the word "dedicated" appears, the fittings for those lights must only be capable of accepting fluorescent or gift emitting diode (LED) lamps:			
at least 4 of the bedrooms / study;		J	J
at least 2 of the living / dining rooms;		<b>.</b>	<b>.</b>
• the kitchen:		_	_
· He NICHEII,		<b>✓</b>	-



CADENCE & CO DESIGN

Suite 7, 287 Mona Vale Rd, Terrey Hills, NSW, 2084, P 9450 1950 E info@cadenceandco.com.au ABN: 12 168 714 752

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REVISION DATE REVISION NOTE

SHEET NO: DRAWING: A19 DV Colin & Emily Panagakis BASIX Certificate CHKD: SCALE @ A2: 1:100 PROJECT NO: ISSUE TYPE: 15 Tutus St, Balgowlah Heights REVISION: ISSUE DATE: PAN 0518 DA1 Being LOT 16 in D.P. 9561 11/3/19












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**REVISED DA - 14/6/19** 

REVISION DATE REVISION NOTE
A 14/6/19 ALL DA AMENDMENTS AS NOTED RED ON THE DRAWINGS

CLIENT:	DRAWING:		DRAWN:	SHEET NO:
Colin & Emily Panagakis	Perspective Views		DV	A20
,			CHKD:	SCALE @ A2:
PROJECT:	PROJECT NO:	ISSUE TYPE:	1	
15 Tutus St, Balgowlah Heights	PAN 0518	DAG	ISSUE DATE:	REVISION:
Being LOT 16 in D.P. 9561	PAIN UD 10	DA2	14/6/19	A





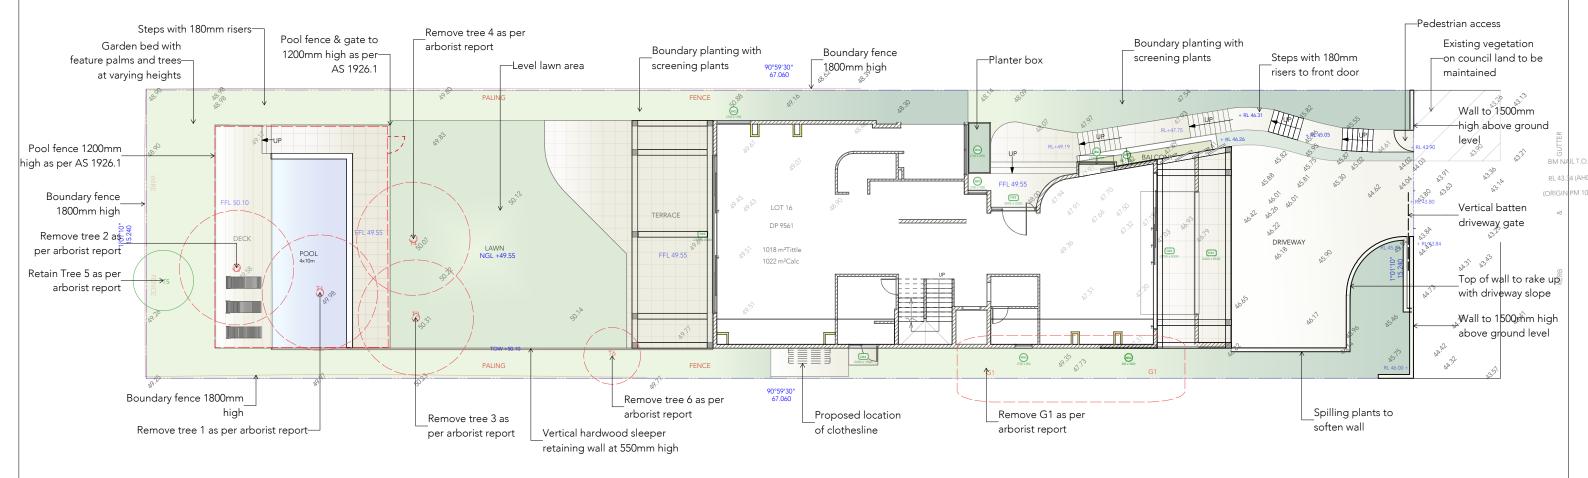

NOTES:

Verify all measurements on sit
 Notify S&S of any inconsisten

DRAWING NAME LANDSCAPE PLAN CLIENT Colin & Emily Panagakis ADDRESS

15 Tutus Street, Balgowlah Heights


REF# SCALE 1:200 @A3 PROJECT NO. 0683 DRAWING NO. F101

**DATE DRAWN** 01.03.2019 DRAWN BY KR

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36B OXFORD STREET PADDINGTON NSW 2021

REV# T: 0426 259 973 CHECKED BY JL

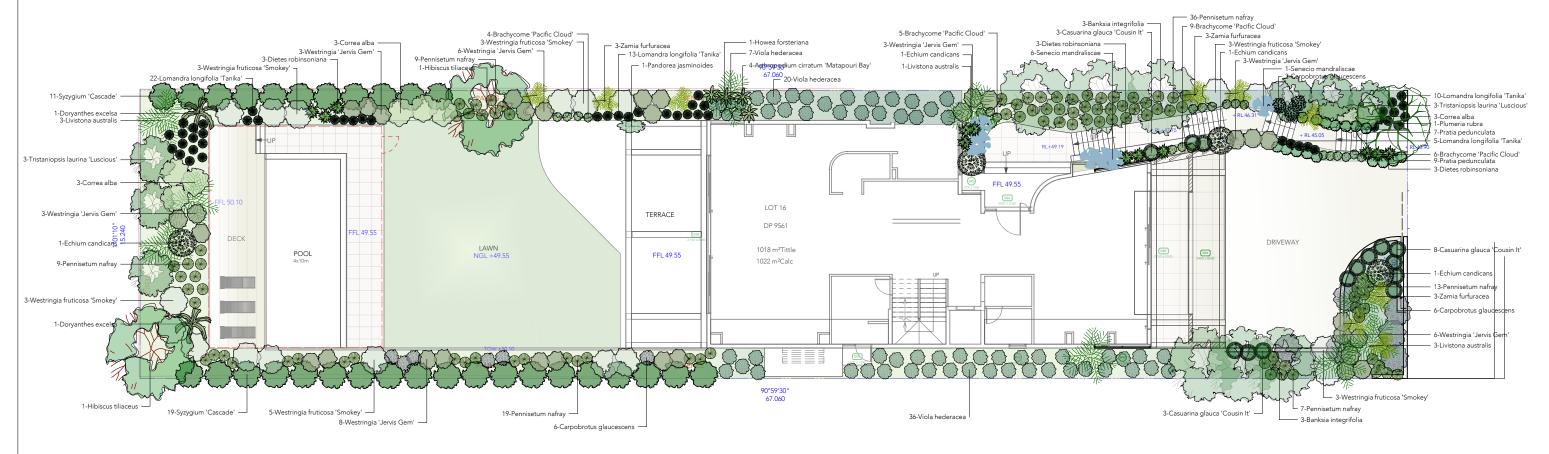

ID	Qty	Common Name	Botanical Name	Pot Size	Mature Height	Mature Spread	Notes
Trees							
3i	6	Coastal Banksia	Banksia integrifolia	75ltr	9M	4M	Indigenous
HiT-1	2	Cottonwood	Hibiscus tiliaceus	100ltr	6M	3M	Native
Aca-1	2	Kentia Palm	Howea forsteriana	45ltr	10M	3M	Native
CTP	7	Cabbage Tree Palm	Livistona australis	45ltr	20M	3M	Indigenous
Pr .	1	Frangipani	Plumeria rubra	75ltr	4M	4M	
ic	30	Dwarf Weeping Lillypilly	Syzygium 'Cascade'	45ltr	3M	1.5M	Native
VG	6	Water Gum	Tristaniopsis laurina 'Luscious'	75ltr	8M	2.5M	Indigenous
Shrubs							
AcMB	4	New Zealand Rock Lily	Arthropodium cirratum 'Matapouri Bay'	200mm	1000mm	1000mm	
Coa	9	White Correa	Correa alba	250mm	1.5M	1.5M	Native
)ra	12	Wedding Lily	Dietes robinsoniana		1.5M	1.5M	
De	2	Gymea Lily	Doryanthes excelsa	300mm	3M	2M	Native
ic	4	Pride of Meidera	Echium candicans	300mm	1M	1.5M	
VJG	32	Jervis Gem	Westringia 'Jervis Gem'	250mm	1M	1M	Native
Vfs	20	Westringia Smokey	Westringia fruticosa 'Smokey'	300mm	1M	1M	Indigenous
Fround Covers							
IPC .	24	Pacific Cloud Cut Leaf Da	Brachycome 'Pacific Cloud'	200mm	300mm	500mm	Native
g	15	Aussie Rambler	Carpobrotus glaucescens	140mm	200mm	1.5M	Native
gc	14	Cousin It	Casuarina glauca 'Cousin It'	200mm	300mm	900mm	Native
'p	16	Trailing pratia	Pratia pedunculata	140mm	0.1-0.2m	0.5-1m	Indigenous
m	7	Blue Chalk Sticks	Senecio mandraliscae	140mm	300mm	1M	
'h	63	Native Violet	Viola hederacea	140mm	100mm	600mm	Indigenous
irasses							
t	50	Lomandra Tanika	Lomandra longifolia 'Tanika'	140mm	600mm	650mm	Indigenous
'ny	93	Nafray	Pennisetum nafray	140mm	600mm	600mm	Native
Climbers							
Pjs	1	Bower Vine	Pandorea jasminoides	300mm	3000mm	3000mm	Native
Total .	840						

# PLANTING PALETTE







NOTES:

3. Notify S&S of any ir

DRAWING NAME PLANTING PLAN CLIENT

ADDRESS

Colin & Emily Panagakis

SCALE 15 Tutus Street, Balgowlah Heights

PROJECT NO. DRAWING NO. 1:200 @A3



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T: 0426 259 973

F102

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REF#

### SITE NOTES:

### SITE PREPERATION

Any existing trees and vegetation to be retained shall be preserved and protected from damage of any sort during the execution or landscape works. In particular, root systems of existing plants must not be disturbed. Any nearby site works should be carried out carefully using hand tools. Trees shall not be removed or lopped unless specific written approval to do so is given or is indicated on plan. Storage of materials, mixing of materials, vehicle parking, disposal of liquids, machinery repairs and refuelling, site office and sheds shall not occur within three (3) metres of any existing or new trees. Do not stockpile soil, rubble or other debris cleared from the site, or building materials within the drip line of existing or new

### SERVICE

Services and utilities shown have been located by physical evidence and/or by reference to surveys provided. Pits may not have been opened to verify the type of utility. Excavation has not been carried out to confirm underground location. Service details should be confirmed with the relevant service authority during design and prior to commencement of construction

### **SOIL PREPERATION**

All proposed planting areas to be deep ripped to 300mm. Clay soils to be combined with 50-100mm of A.N.L 'Organic Clay Breaker'. 75mm depth of A.N.L 'Organic Garden Mix' to be imported and combined with 25mm depth of A.N.L 'Greenlife' compost or approved equivalent. Care to be taken to hand cultivate in any area where existing tree roots exist to preserve health of trees.

### NEW PLANTINGS

Newly planted advanced trees are to be secured with 3 @ 1.8mm x 22mm x 22mm hardwood stakes with hessian ties to prevent excessive movement. Planting holes for plants are to be large enough to take the root ball with additional space for back fill with soil prepared as

All planting areas, unless otherwise specified to me mulched with A.N.L 'Droughtmaster' to 50mm deep with catchment dish to be left around base of plants.

On completion of work all planting areas are to be fertilised with 'Osmocote Pro (8-9mo) Controlled Release Fertiliser' which is to be sufficiently watered in. GARDEN EDGING

All planter beds adjacent to lawn areas to have flush 3mm corten steel.

### IRRIGATION

By others

Plants require hand watering until established, in addition to irrigation

### PAVING

All paving to be selected by client.

All paving to be laid to maufacturers recommendations. All paving adjacent to house to have a minimum fall of 1:100 directed away from residence. Sealing of all paving should be a consideration with the supplier. This is to be sought by client.

### DRAINAGE

To intercept rainwater at the bottom of the fall, install a grated surface drain at the edge of the paving. If draining a large area or you are likely to get a lot of silt in the runoff captured by the drain, install a sump or clean-out section between the drain and the stormwater pipe to collect soil and sand. Clean it out periodically.

### POOL ENCLOSURE

Pool fencing material to comply Australian Standards for Pool enclosure requirements regarding height and gate fixtures. AS1926

Turf to be as specified. Turf to be laid on 50mm topsoil over 200mm deep rotary hoed prepared area. Turf areas to be evenly graded. Adequate drainage to be provided under lawn area.

### **Weed Control**

Identify weed species and eradicate as per best horticultural practice. On going maintenance plan to be discussed with client.

### RETAINING WALLS

All retaining walls over 600mm to be to constructed to Engineers specifications.

### HARD CONSTRUCTION

All civil, structural and hydraulic work associated with this project shall be to consulting Engineers details. All external stairs to be constructed in accordance with Clause D2.13 of the Building Code of Australia.


### PLANTING

Unless supplied, installed and maintained by **Sticks & Stones Landscape Design** takes no responsibility taken for the vigour, condition or life span of any plant material.

80mm DIA conduit required under all paving and paths for cable access.


Where trees are recommended for removal, client should seek council approval to do so.


# **DETAIL DRAWINGS**

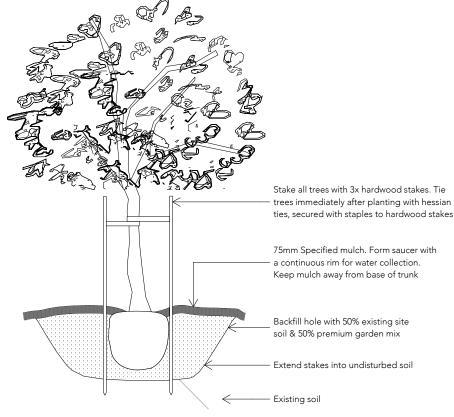


NOTE: Planting hole must be minimum 2.5 times rootball size. Apply 'Osmocote' or equivalent to manufacturers specifications



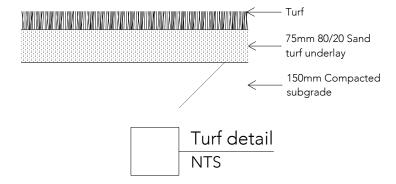

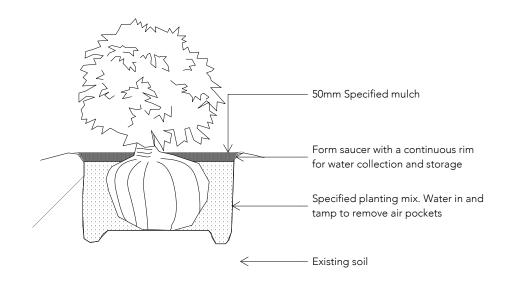

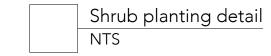







3. Notify S&S of any

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DRAWING NAME

DETAIL DRAWINGS

CLIENT

ADDRESS

Colin & Emily Panagakis

15 Tutus Street, Balgowlah Heights

REF# SCALE

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PROJECT NO. 0683 DRAWING NO.

**DATE DRAWN** 01.03.2019 DRAWN BY

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KR