
NORTHERN BEACHES COUNCIL

These plans relate to Development Consent No. 279/16

The plans are NOT for construction.

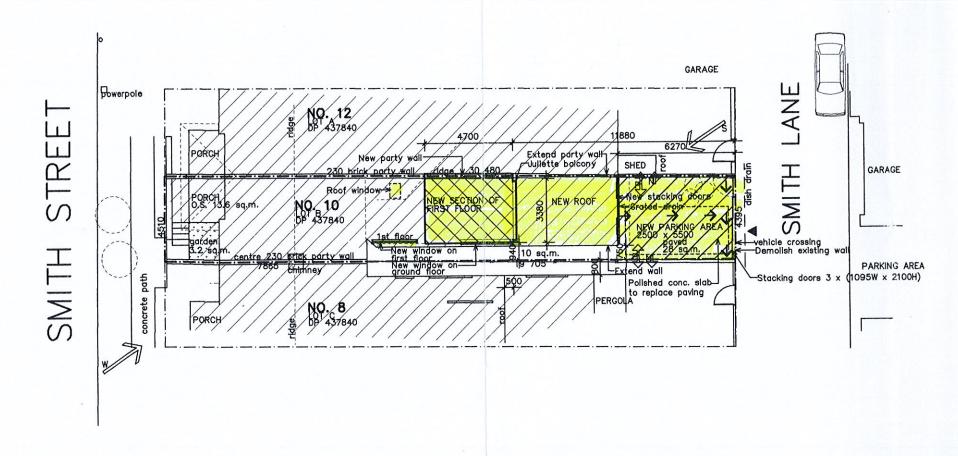

BEACHES COUNCIL

NORTHERN Determined under:-

Development

Assessment Unit

279/2016

Date: , 23/11/16



NOTES:
This drawing is the copyright of Duffy Regan Design and may not be altered, reproduced or transmitted without permission of Duffy Regan Design.
All levels and dimensions are to be checked on site prior to commencement of any work.
All new and altered works to relevant BCA and AS/NZ standards.
NOT FOR CONSTRUCTION

Project: ALTERATIONS AND ADDITIONS

Job. No. 565/16

for: at:

J. Tunbridge 10 Smith St., Manly NSW 2095

Title:


Scale: 1:200 @ A3

Date: AUG 2016 Drawn: D.R.

SITE PLAN SITE ANALYSIS PLAN DUFFY REGAN DESIGN
Tel. & fax (02) 9905 6009
Mobile: 0416 037 847
Email: duffyregandesign@iprimus.com.au DUFFY REGAN DESIGN

Drawing No. DA-01

KEY PREVAILING WINDS (SUMMER) PREVAILING WINDS (WINTER) NOISE CONSIDERATIONS FALLS FOR DRAINAGE

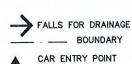

SITE AREA: 136.5 sq.m.

EXISTING & PROPOSED LANDSCAPED AREA: 3.2 sq.m. (0,4%)

EXISTING OPEN SPACE: 51.6 sq.m. (38%)

EXISTING GROUND FLOOR: 8B sq.m.

EXISTING FIRST FLOOR: 26 sq.m.

NEW FIRST FLOOR: 15.8 sq.m.

FSR: 0.45:1 (based on 250 sq.m. of site area)

Revision:

NORTHERN BEACHES tinU memsees COUNCIL

This plan is to be read in conjunction with conditions contained within the Notice of Determination that may change the form of the development or the manner in which the development proceeds.


These plans are not for construction. Where demolition, site works or building works are proposed a Construction Certificate is to be obtained prior to commencement of work.

A copy of the approved Development Application Plans and Construction Certificate must be kept on site for the duration of the works.


RECEIVED 12 OCT 2016

These plans relate to Development Consent No. 279/16

The plans are NOT for construction.

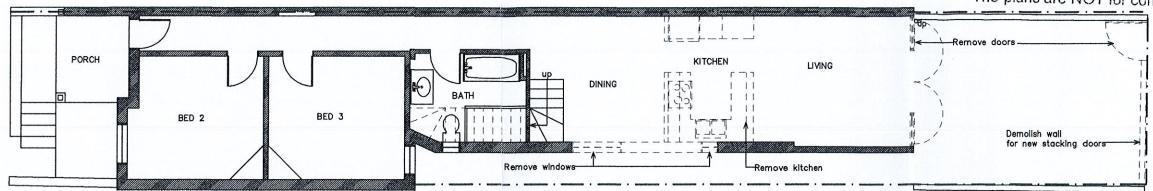

GROUND FLOOR

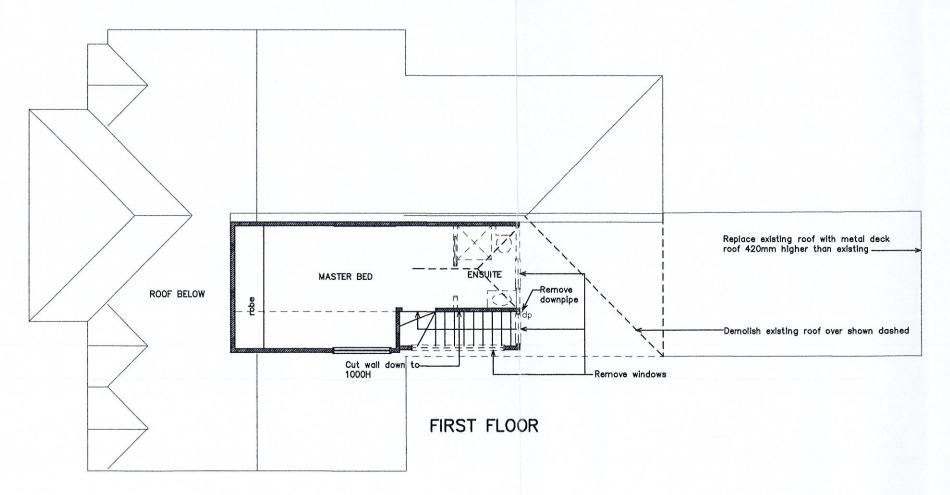



LEGEND	
en resului mananan annana.	Existing timber frame wall
analumnya manamummanana	Existing single brick wall
	Existing double brick wall
c=======	Demolish timber frame wall

_____ Demolish double brick wall

NOTES:
This drawing is the copyright of Duffy Regan Design and may not be altered, reproduced or transmitted without permission of Duffy Regan Design.
All levels and dimensions are to be checked on site prior to commencement of any work. All new and altered works to relevant BCA and AS/NZ standards.
NOT FOR CONSTRUCTION

Project: ALTERATIONS AND ADDITIONS

Job. No. 565/16

J. Tunbridge 10 Smith St., Manly NSW 2095 for: at:

Title: Scale: 1:100 @ A3 **DEMOLITION PLANS**

Date: AUG 2016 Drawn: D.R.

DUFFY REGAN DESIGN
Tel. & fax: (02) 9905 6009
Mobile: 0416 037 847
121 Soldiers Ave., Freshwater NSW 2096 Email: duffyregandesign@iprimus.com.au

Drawing No. DA-02



Revision:


NORTHER! NEACHES TOUNCIL

These plans relate to Developmen. Consent No.


The plans are NOT for certain union.

12 OCT 2016 BY:

These plans relate to Development Consent No. 279/IG

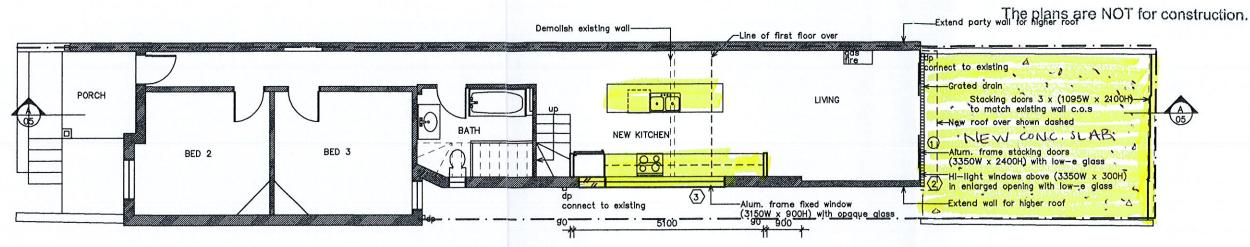

GROUND FLOOR

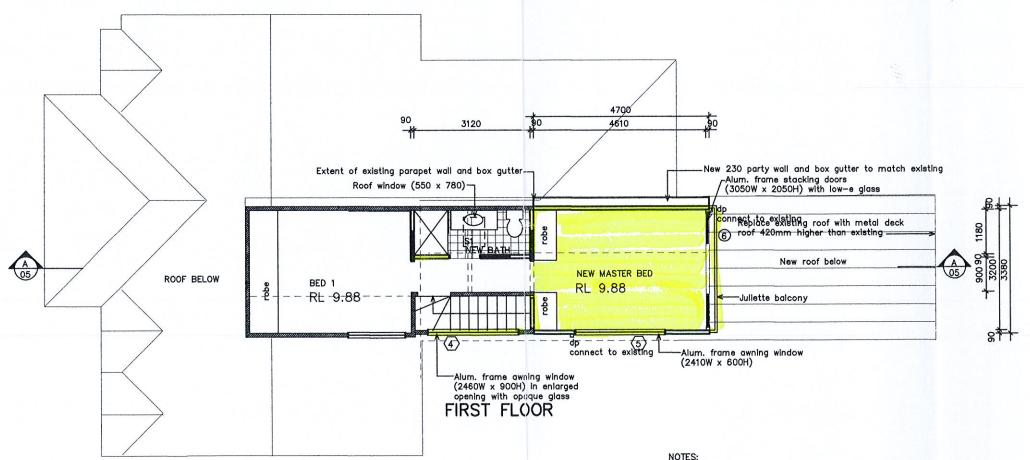

BASIX REQUIREMENTS:
All new window and door frames to be improved aluminium frames.
Window 1& 6 to have low—e glass and a 450D pergola over.
Windows 3 & 4 to have single toned glass.
Window 5 to have single clear glass.
Skylight S1: timber double clear/air fill, (or U-value: 4.3, SHGC: 0.5)

Existing timber frame wall
Existing single brick wall
Existing double brick wall
New timber frame wall
New double brick wall

NOTES:
This drawing is the copyright of Duffy Regan Design and may not be altered, reproduced or transmitted without permission of Duffy Regan Design.
All levels and dimensions are to be checked on site prior to commencement of any work.
All new and altered works to relevant BCA and AS/NZ standards.
NOT FOR CONSTRUCTION

Project: ALTERATIONS AND ADDITIONS

Job. No. 565/16

for: J. Tunbridge at: 10 Smith St

Title:

10 Smith St., Manly NSW 2095

FLOOR PLANS

Scale: 1:100 @ A3
Date: AUG 2016

Drawn: D.R.

DUFFY REGAN DESIGN
Tel. & fax: (02) 9905 6009
Mobile: 0416 037 847
121 Soldiers Ave., Freshwater NSW 2096 Email: duffyregandesign@iprimus.com.au

Drawing No. DA-03

Revision:

MORTHERI BEACHES COUNCIL


These plans relate to Developmen Consent No.

The plans are NOT for construction.

RECEIVED

12 OCT 2016

BY:_____

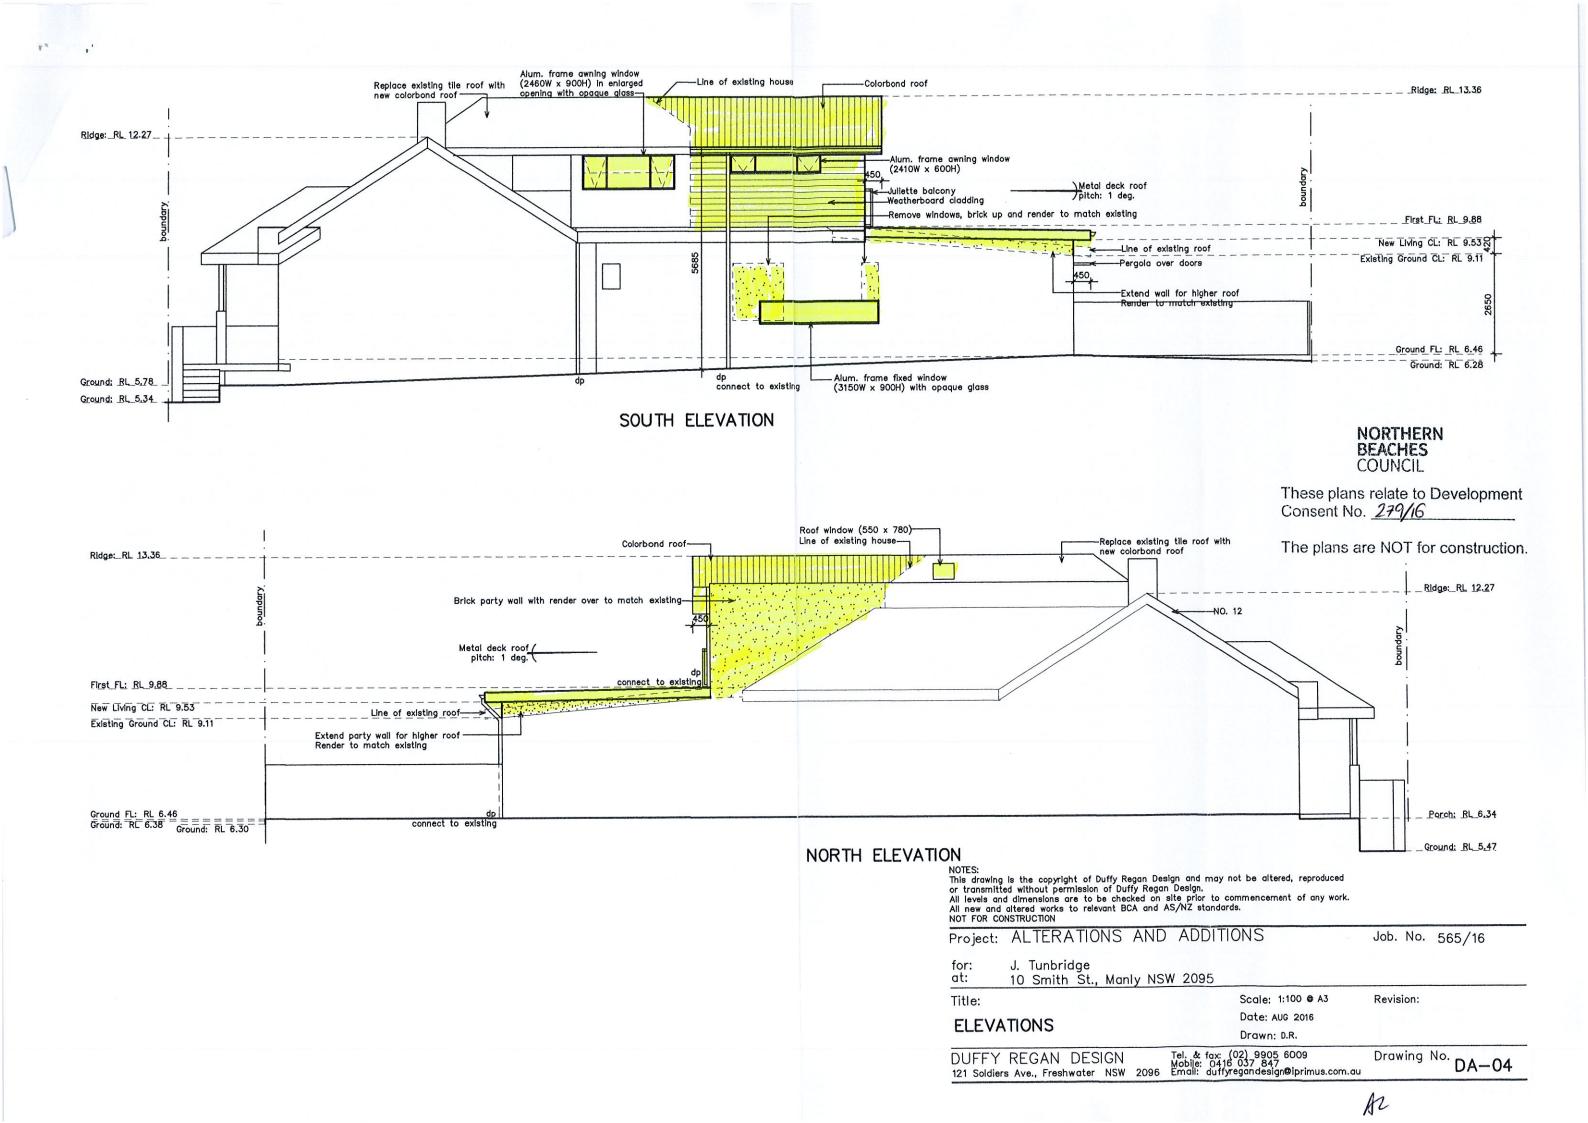

NORTHERN BEACHES COUNCIL


Thesis plans relate to Development Consent No.

noticultance set TOVI are entitled set

RECEIVED

12 OCT 2016

BY:

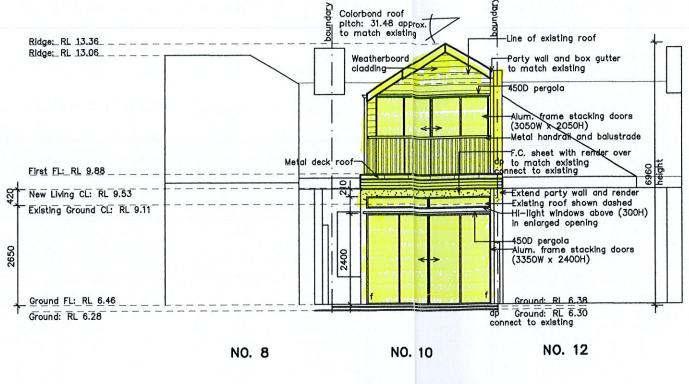

EAST ELEVATION



EAST FENCE ELEVATION

NOTES:
This drawing is the copyright of Duffy Regan Design and may not be altered, reproduced or transmitted without permission of Duffy Regan Design.
All levels and dimensions are to be checked on site prior to commencement of any work.
All new and altered works to relevant BCA and AS/NZ standards.
NOT FOR CONSTRUCTION

Project: ALTERATIONS AND ADDITIONS

Job. No. 565/16

for: J. Tunbridge
at: 10 Smith St., Manly NSW 2095

Title: Scale: 1:100 • A3

ELEVATIONS

Date: AUG 2016

Drawn: D.R.

DUFFY REGAN DESIGN
Tel. & fax: (02) 9905 6009
Mobile: 0416 037 847

121 Soldiers Ave., Freshwater NSW 2096 Email: duffyregandesign@iprimus.com.au

Drawing No. DA-05

AZ

Revision:

NORTHERN BEACHES COUNCIL

These plans relate to Development

The plans are NOT for construction.

Consent No. 279/16

NORTHERN BENCHES COUNCIL These plans relate to Development Consent No.


The plans are NOT for construction

12 0CT 2016 BY:_____ 40 1.01

NORTHERN BEACHES COUNCIL

These plans relate to Development Consent No. <u>279/16</u>

The plans are NOT for construction.

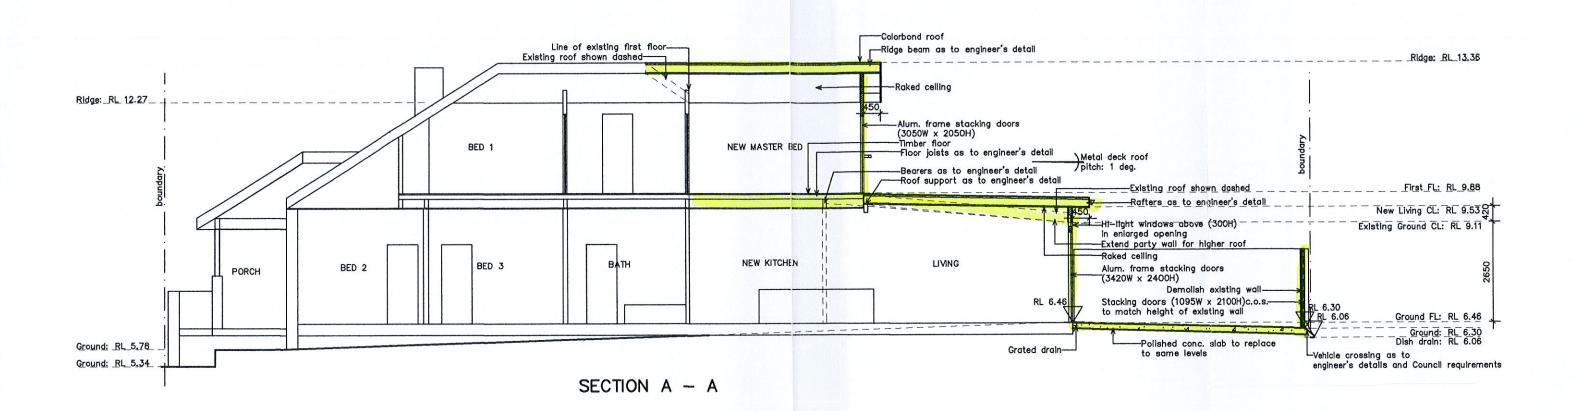

BASIX REQUIREMENTS:

Floor above existing building: nil Roof colour: light (solar absorptance < 0.475) External wall insulation: framed (weatherboard clad) — R1.30 (or R1.70 including construction) Raked ceiling, pitched/skillion roof: framed — R1.00 (up) Roof insulation: 55mm foll backed blanket This drawing is the copyright of Duffy Regan Design and may not be altered, reproduced or transmitted without permission of Duffy Regan Design.

All levels and dimensions are to be checked on site prior to commencement of any work. All new and altered works to relevant BCA and AS/NZ standards.

NOT FOR CONSTRUCTION Project: ALTERATIONS AND ADDITIONS

Job. No. 565/16

for: J. Tunbridge at:

10 Smith St., Manly NSW 2095

Title:

Scale: 1:100 @ A3

Revision:

SECTION

Date: AUG 2016 Drawn: D.R.

DUFFY REGAN DESIGN
Tel. & fax: (02) 9905 6009
Mobile: 0416 037 847
Email: duffyregandesign@iprimus.com.au

Drawing No. DA-06



NORTHERN BEACHES COUNCIL 60 11.3 SA

Triese plans relate to Devidenti Consort No.

The plans are NOT for construction.

12 OCT 2016
BY:

BY: STATEMENT OF ENVIRONMENTAL EFFECTS

This statement refers to the proposed alterations and additions at 10 Smith Street, Manly, lot B, D.P. 437840 with a site area of 136.5 square meters. The site is zoned R1 general residential. It is in a conservation area and is located in group of semi-detached cottages with undersized lot areas.

The proposal will not affect the front streetscape because all the new work is proposed for the rear of the house. The new work will not be visible from the street.

It is proposed to extend the first floor to make a master bedroom with a Juliette balcony. The existing bathroom will be demolished and a new bathroom built. The window over the stairs is to be enlarged. On the ground floor, it is proposed to raise the roof of the living area and install new stacking doors with hi-light windows above. One wall is to be demolished and a new kitchen installed with a new window to replace the existing ones on the south side. It is proposed to demolish the east boundary wall onto Smith Lane, remove the existing paving and replace with a new polished concrete slab. A vehicle crossing will be installed and new automated stacking doors at the same height as the existing wall to make a parking area on the existing paved area.

OPENSPACE AND LANDSCAPE DESIGN

The minimum open space requirement for this site is 55% (75 square meters) of the site area. The existing open space is 38% (51.6 square meters). The new parking area is 14 square meters which will bring the total down to 27% (37.6 square meters).

The minimum percent of total open space as land is 35% (26.25 square meters) for this site. There is .04% (3.2 square meters) existing which will remain unchanged by the proposal.

The lot doesn't comply with the open space requirement now because it is an undersized lot. The car parking is the only aspect of this proposal that affects the open space. The objectives of the control will still be met. There is no impact on landscaping or amenity of the site or surrounding area.

FLOOR SPACE RATIO

The floor space ratio is 0.45:1. It is based on the maximum variation to FSR for undersized lots. The proposal complies with the requirement of 0:60:1.

Note: On existing sites in Residential LEP Zones (including E3 & E4) with a site area less than the minimum lot size required on the LEP Lot Size (LSZ) Map, Council may consider exceptions to the maximum. DCP are satisfied. See LEP clause 4.6(4)(a).

In particular, the undersized nature of a lot is a matter that Council may consider in determining whether 'compliance with the standard is

Reference document related to Development Consent No 279/16 Not for Construction.

To be read in conjunction with Council's Notice of

Determination

is now. The new stacking doors for parking access will be the same height as the existing wall.

PRIVACY & NOISE

Privacy and noise considerations will be as they are now. The proposal is for a new bedroom with high windows facing south. The ground floor living area roof is being raised. There is already parking in the lane. Privacy and noise will be as it is now.

STORMWATER DISPOSAL

Stormwater disposal will remain as existing. New downpipes and grated drain will be connected to the existing stormwater line.

CAR PARKING

There is no car parking at present. A car park is proposed off Smith lane on a new polished concrete slab to replace the existing paving with new stacking doors opening on to it. There will be no effect on soft open space since the area is currently paved. There is a shortage of car parking on the street and the lane in this area. The amenity of the surrounding area will be improved with the addition of another car parking space. Smith Lane has a lot of garages and car parking spaces as seen in the photos. There is a garage and parking area directly across from No. 10 ensuring access for No. 10 as seen on the site plan. On the same side of the street, No. 14 has a garage on the boundary and No. 4 has sliding gates which appear to open to a parking area. There is a precedence in the street. The works do not have an impact on kerbside parking in this Lane because of existing access required to the parking area and garage across from No. 10.

HERITAGE

The proposal will not affect the front of the house because all the new work is proposed for the rear of the house. The new work will not be visible from the street. The front of the house will remain as existing including the existing traditional roof at the front. The heritage character of the area is being retained. The proposal will not alter the heritage significance of this group of semi-detached cottages.

page 1 / 6

Building Sustainability Index www.basix.nsw.gov.au

Alterations and Additions

Certificate number: A255614

document is available at www.basix.nsw.gov.au commitments set out below. Terms used in this certificate, or in the commitments, government's requirements for sustainability, if it is built in accordance with the Definitions" dated 18/09/2014 published by Planning & Infrastructure. This have the meaning given by the document entitled "BASIX Alterations and Additions This certificate confirms that the proposed development will meet the NSW

Date of issue: Thursday, 04, August 2016

To be valid, this certificate must be lodged within 3 months of the date of issue. Director-General



Description of project

Project type

Dwelling type

Attached dwelling house

Type of alteration and

Section number

0

Lot number

Plan type and number

Deposited Plan 437840

Manly Council

10 Smith Street Manly 2095

Tunbridge

Local Government Area

Street address Project name Project address

NORTHERN BEACHES COUNCIL

and does not include a pool (and/or spa)

My renovation work is valued at \$50,000 or more,

Reference document related to Development Consent No 279/16

To be read in conjunction with Council's Notice of Not for Construction. Determination

Certificate Prepared by (please complete before submitting to Council or PCA)

ABN (if applicable): 93 723 012 005

Name / Company Name: Duffy Regan Design

Fixtures and systems Chapter	Show on Show on DA Plans CC/CDC Plans & specs	on Certifier Check
Fixtures		
The applicant must ensure new or altered showerheads have a flow rate no greater than 9 litres per minute or a 3 star water rating.	<	`
The applicant must ensure new or altered toilets have a flow rate no greater than 4 litres per average flush or a minimum 3 star water rating.	<	` <
The applicant must ensure new or altered taps have a flow rate no greater than 9 litres per minute or minimum 3 star water rating.	<	•

			light (solar absorptance < 0.475)	ceiling: R1.00 (up), roof: foil backed blanket (55 mm)	raked ceiling, pitched/skillion roof: framed
				R1.30 (or R1.70 including construction)	external wall: framed (weatherboard, fibro, metal clad)
	200			nil	floor above existing dwelling or building.
			Other specifications	Additional insulation required (R-value)	Construction
<	<	<	in accordance with the specifications listed in uction is less than 2m2, b) insulation specified	The applicant must construct the new or altered construction (floor(s), walls, and ceilings/roofs) in accordance with the specifications listed in the table below, except that a) additional insulation is not required where the area of new construction is less than 2m2, b) insulation specified is not required for parts of altered construction where insulation already exists.	The applicant must construct the new or altered construction (floor(s), walls, a the table below, except that a) additional insulation is not required where the a is not required for parts of altered construction where insulation already exists
					Insulation requirements
Certifier Check	Show on CC/CDC Plans & specs	Show on DA Plans			Construction

			W3 S 2.83 0 0 none improved aluminium, single toned, (U-value: 6.39, SHGC: 0.56)
			W2 E 1 0 0 eave/verandah/pergola/balcony improved aluminium, single pyrolytic low-e, =450 mm (U-value: 4.48, SHGC: 0.46)
	23223341		W1 E 8.04 0 0 eave/verandah/pergola/balcony improved aluminium, single pyrolytic low-e, >=450 mm (U-value: 4.48, SHGC: 0.46)
			frame (m2) Height Distance (m) (m) (m2)
			ndows and glazed doors glazing rendow / door Orientation Area of Overshace
<	<		Pergolas with fixed battens must have battens parallel to the window or glazed door above which they are situated, unless the pergola also shades a perpendicular window. The spacing between battens must not be more than 50 mm.
<	<		Pergolas with polycarbonate roof or similar translucent material must have a shading coefficient of less than 0.35.
<	<	<	For projections described in millimetres, the leading edge of each eave, pergola, verandah, balcony or awning must be no more than 500 mm above the head of the window or glazed door and no more than 2400 mm above the sill.
<	<		Each window or glazed door with improved frames, or pyrolytic low-e glass, or clear/air gap/clear glazing, or toned/air gap/clear glazing must have a U-value and a Solar Heat Gain Coefficient (SHGC) no greater than that listed in the table below. Total system U-values and SHGCs must be calculated in accordance with National Fenestration Rating Council (NFRC) conditions. The description is provided for information only. Alternative systems with complying U-value and SHGC may be substituted.
<	<		Each window or glazed door with standard aluminium or timber frames and single clear or toned glass may either match the description, or, have a U-value and a Solar Heat Gain Coefficient (SHGC) no greater than that listed in the table below. Total system U-values and SHGCs must be calculated in accordance with National Fenestration Rating Council (NFRC) conditions.
<	<		The following requirements must also be satisfied in relation to each window and glazed door:
<	<	<	The applicant must install the windows, glazed doors and shading devices, in accordance with the specifications listed in the table below. Relevant overshadowing specifications must be satisfied for each window and glazed door.
			Windows and glazed doors
Certifier Check	Show on CC/CDC Plans & specs	Show on DA Plans	Glazing requirements

S1 0.429 no shading	Skylight number Area of glazing Shading device inc. frame (m2)	Skylights glazing requirements	Each skylight may either match the description, or, have a U-value the table below.	The following requirements must also be satisfied in relation to each skylight:	The applicant must install the skylights in accordance with the specifications listed in the table below.	Skylights	W6 E 6.25 0 0 eave/verar >=450 mm	W5 S 1.44 0 0 none	W4 S 2.21 0 0 none	Window / door Orientation Area of Overshadowing Shadino. no. glass Height Distance inc. (m) (m)	Glazing requirements
timber, double clear/air fill, (or U-value: 4.3, SHGC: 0.5)	Frame and glass type		Each skylight may either match the description, or, have a U-value and a Solar Heat Gain Coefficient (SHGC) no greater than that listed in the table below.	skylight:	ifications listed in the table below.		eave/verandah/pergola/balcony improved aluminium, single pyrolytic low-e, >=450 mm (U-value: 4.48, SHGC: 0.46)	improved aluminium, single clear, (U-value: 6.44, SHGC: 0.75)	standard aluminium, single toned, (or U-value: 7.57, SHGC: 0.57)	Shading device Frame and glass type	
					<						DA Plans
			<	<	<						CC/CDC Plans & specs
			<	<	<						Check

Legend

In these commitments, "applicant" means the person carrying out the development.

development application is to be lodged for the proposed development). Commitments identified with a "/" in the "Show on DA plans" column must be shown on the plans accompanying the development application for the proposed development (if a

certificate / complying development certificate for the proposed development. Commitments identified with a "/" in the "Show on CC/CDC plans & specs" column must be shown in the plans and specifications accompanying the application for a construction

development may be issued. Commitments identified with a "/" in the "Certifier check" column must be certified by a certifying authority as having been fulfilled, before a final occupation certificate for the