15 Southern Cross Way, ALLAMBIE HEIGHTS



site location plan




source: google earth

drawing register

			issue Duie.
		Day	12
		Month	2
		Year	25
DA//00	Site Location & Drawing Register		Α
DA//01	Perspective Views // Existing		Α
DA//02	Planning Approval Pathway (DA)		Α
DA//03	Site Analysis Plan // Existing		Α
DA//04	Site Layout Plan // Proposed		Α
DA//05	GF Plan // Existing		Α
DA//06	GF Plan // Proposed		Α
DA//07	Lower GF Plan // Proposed		Α
DA//08	Roof Plan // Proposed		Α
DA//09	Sections // Proposed		Α
DA//10	Elevations North // Exg. & Prop.		Α
DA//11	Elevations South // Exg. & Prop.		Α
DA//12	Elevations East // Existing		A
DA//13	Elevations East // Proposed		A
DA//14	Elevations West // Exg. & Prop.		A
DA//15	BASIX Report - Sht 1		A
DA//16	BASIX Report - Sht 2		A
DA//17	Ext. Window Schedule		A
DA//18	Ext. Door & Finishes Schedule		Α
DA//19	Building Height Envelope		Α
DA//20	Shadow Diagram Jun 21st 9am		Α
DA//21	Shadow Diagram Jun 21st 12pm		Α
DA//22	Shadow Diagram Jun 21st 3pm		Α
DA//24	Sed. & Erosion//Site Setup Plan		Α
DA//AA	Notification Plans		Α


Issue:	Recipients:	
(DA)	Clients: W. & L. Quick	•
	Council: Northern Beaches Council	•
	Town Planner : Watermark - Sarah McNeilly	•
	Engineer: Found Engineers - Faran Daneshgari	•

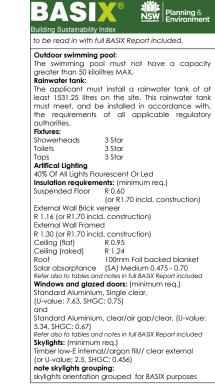

setbacks // dimensions





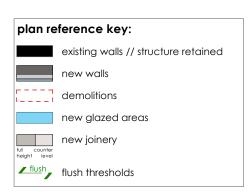

DEVELOPMENT APPLICATION (DA) not for construction

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address: 15 Southern Cross Way, Allambie Heights,	title: Site Location & Drawing Register					
NSW 2010. LOT 8 DP 223922	drawn by: JOB	scale: @ a3				
client: W. & L. Quick	date: 12/02/2025	issue: © VIEW//THRU				
project: Alterations & additions	dwg. no.: DA//00	Rev. no.:				







Issue Date:









existing street view



existing garden view



proposed street view



proposed gardenview

DEVELOPMENT APPLICATION (DA)

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project: Alterations & additions	dwg. no.: DA//01	v. no.:				
client: W. & L. Quick	date: 12/02/2025 issu	Je: (DA)				
NSW 2010. LOT 8 DP 223922	drawn by: JOB sca	ale: @ a3				
address: 15 Southern Cross Way, Allambie Heights,	title: Perspective Views // Existing					





BALGOWLAH, NSW 2093. HRU PTY. LTD. T/A VIEWTHRU ACN 620 (











COMPLIANCE TABLE - AREA CALCULATIONS FOR DA (m2) Warringah Local Environmental Plan (LEP) 2011, Warringah Development Control Plan (DCP) 2011 Local Goverment Area: Northern Beaches Council CONTROLS: (LEP) (DCP) ACID BIO CRITICAL LANDSLIDE FLOOD FORESHORE FORESHORE

					LAND	MIIN	ACID	ыо	CKIIICAL	LANDSLIDE	FLOOD	LOKE2HOKE	POKESHOKE	l GEO	HERITAGE OF	SIIE	LANDSCAPED	DUSHLIKE	PRIVALE	PARKING
	SITE		GROUND	LOWER	ZONE	LOT	SULPHTE	DIVER.	HABITAT	RISK	RISK	SCENIC	BUILDING	TECH	CONSERV.	COVERAGE	AREA	PRONE	OPEN	
	AREA	GARAGE	FLOOR	GROUND		SIZE	SOILS			LAND		PROTECT.	LINE	HAZARD	AREA			LAND	SPACE	
CONTROL																	= 40% min			
CONTROL																	= 242 SQM MIN			
																	21200,777		60 sqm	
						600 sgm													MIN	
			İ																	
EXISTING	605 sqm	31.6 m2	96 m2	-	R 2												321 sqm			
PROPOSED	605 sgm		_	_	R2												- sqm			
			169 3 m2	92.5 m2										✓			218 sqm	✓		2
			107.01112	72.01112										Area B & D			= 36%			
														AIGGB&D			- 50%			
COMPUANCE	1			1		1	NI//A	NI//A	NI//A	NI//A	NI//A	NI//A	NI//A	Defeate Demant	NI//A	NI//A	Defeate CEE	Defeate Demant		

DEVELOPMENT APPLICATION (DA)

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address:	Way, Allambie Heights,	title: Plar	nning Approvo	al Pathw	ay (DA)
NSW 2010. LOT 8		drawn by:	JOB	scale:	@ a3
client: W. & L. (Quick	date:	12/02/2025	issue:	O VIEW//THRU (DA)
project: Alteration	ons & additions	dwg. no.:	DA//02	Rev. no.:	Α

plan reference key:

gross floor area existing

landscaped area

proposed extended gross floor area


open space

site coverage



RIAI



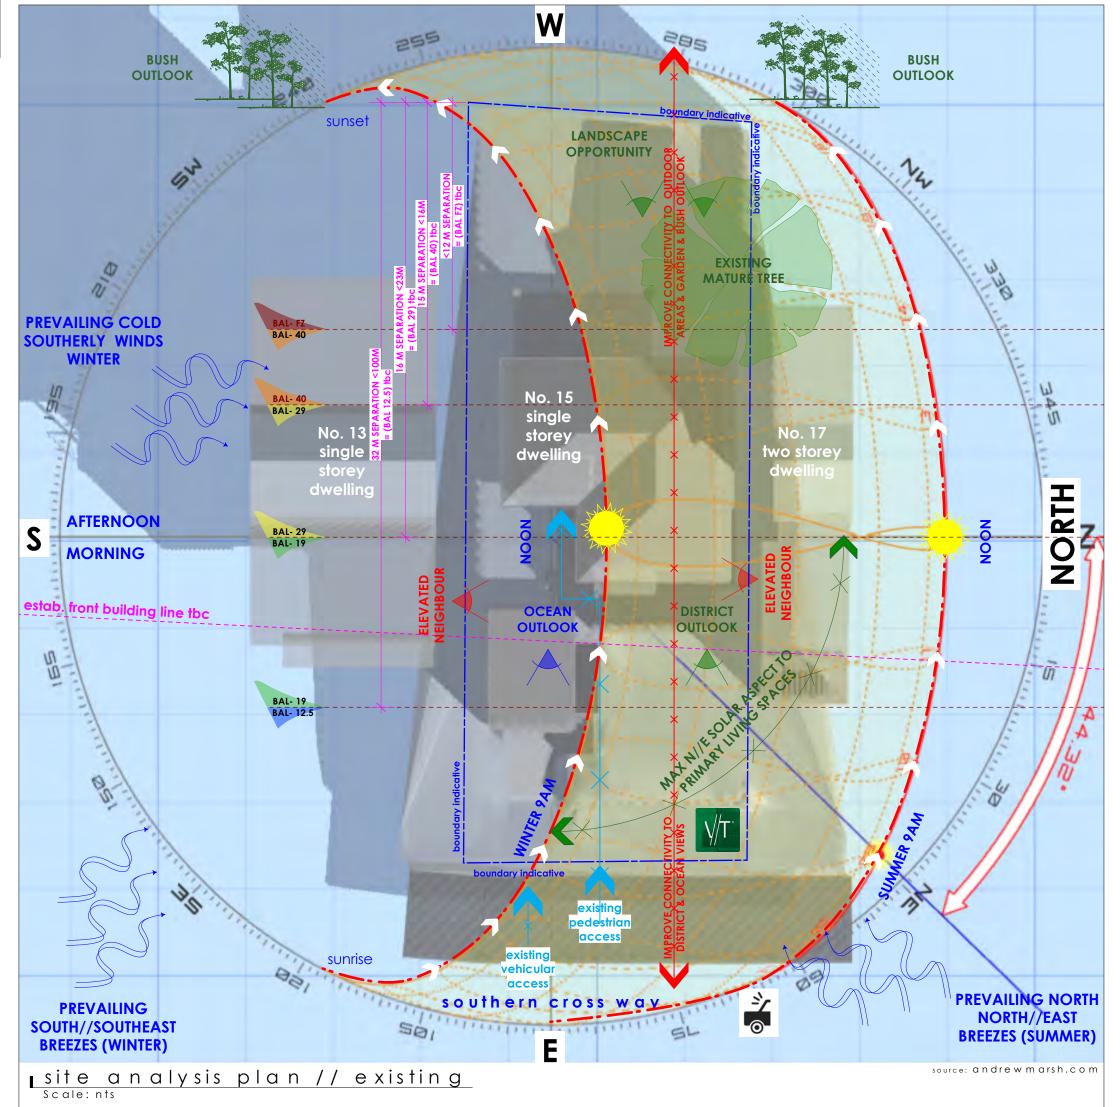

GEOGRAPHIC LOCATION V plan reference key: Latitude -30.00° potential overlooking 150.1171875° Longitude: Timezone: GMT+10:00 views water DATE AND TIME views bush // district Date: 21 Jun 2023 site entry points 12:01 Time: traffic noise SOLAR INFORMATION 0.09° / 36.58° Azi / Alt: existing bush outlook 06:55 / 17:08 Rise / Set: Bushfire Ratings (BAL) Daylight: 10:13 Hrs

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site analysis // street view

DEVELOPMENT APPLICATION (DA)


		,
address:	title: Site Analysis Plan // Existing	
15 Southern Cross Way, Allambie Heights, NSW 2010. LOT 8 DP 223922	drawn by: JOB scale: 1:200 @ a3	
client: W. & L. Quick	date: 12/02/2025 issue: (DA)	
project: Alterations & additions	dwg. no.: DA//03 Rev. no.: A	










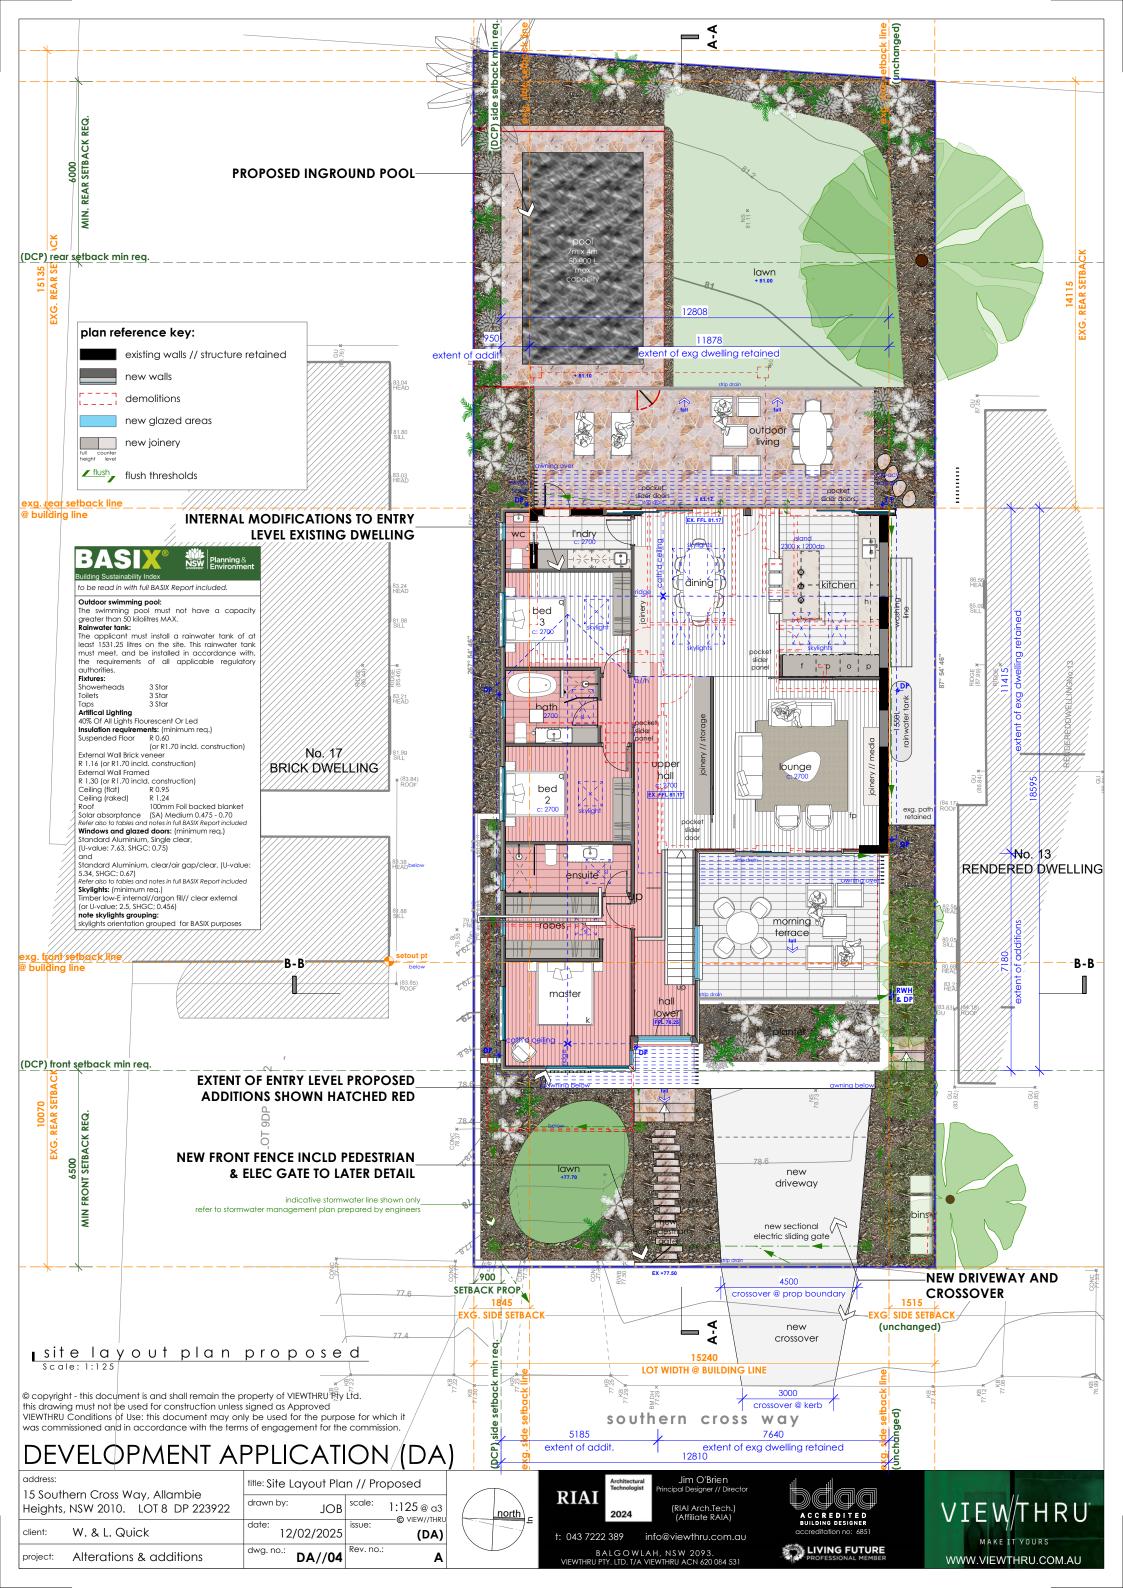

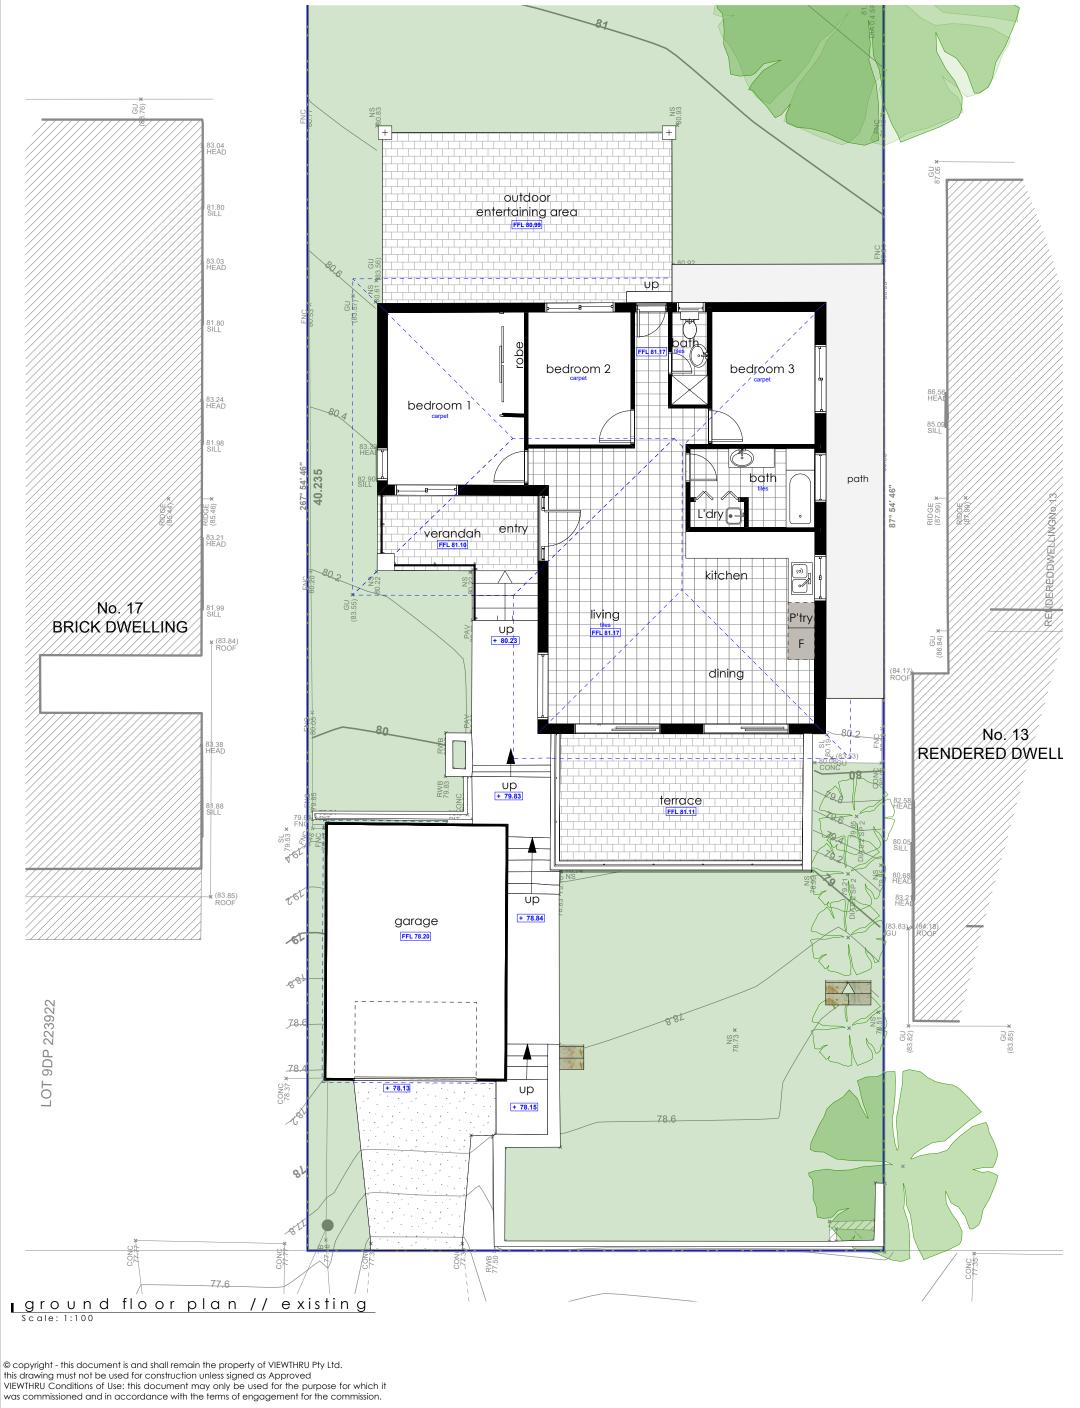

DEVELOPMENT APPLICATION

title: GF Plan // Existing 15 Southern Cross Way, Allambie drawn by: 1:100 @ a3 Heights, NSW 2010. LOT 8 DP 223922 JOB W. & L. Quick 12/02/2025 (DA) dwg. no.: **DA//05**

Alterations & additions

project:



Α

Rev. no.:
















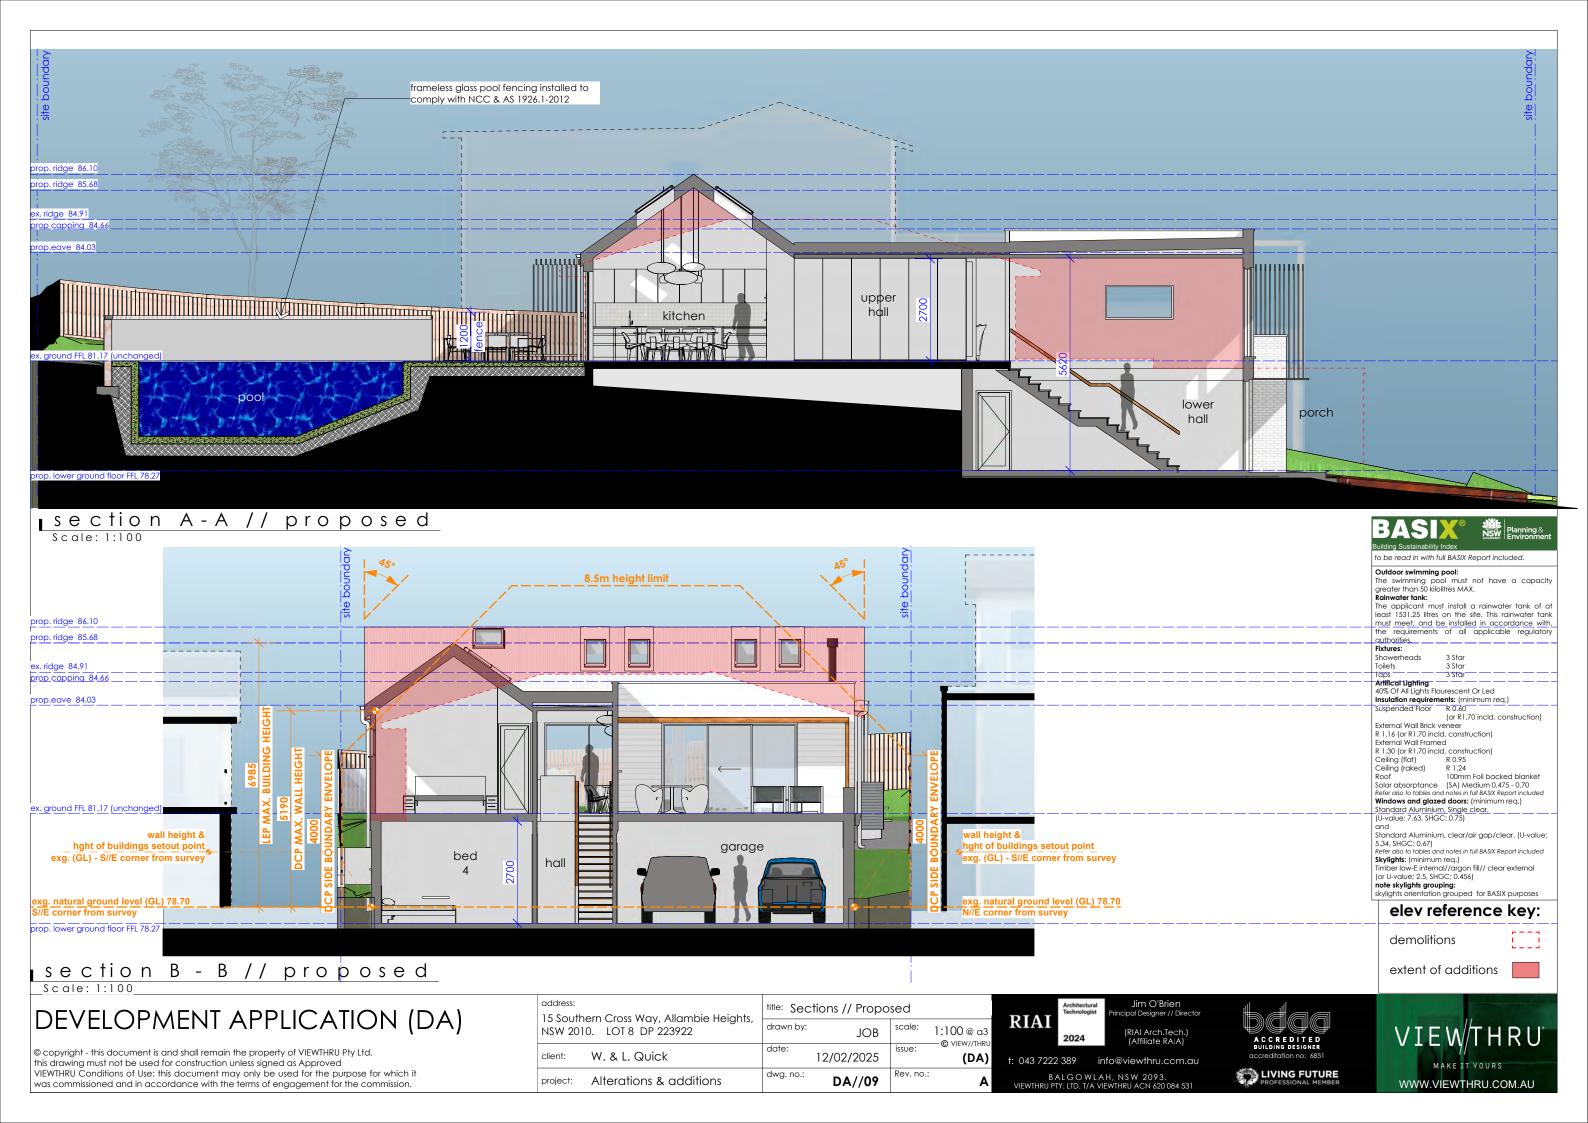

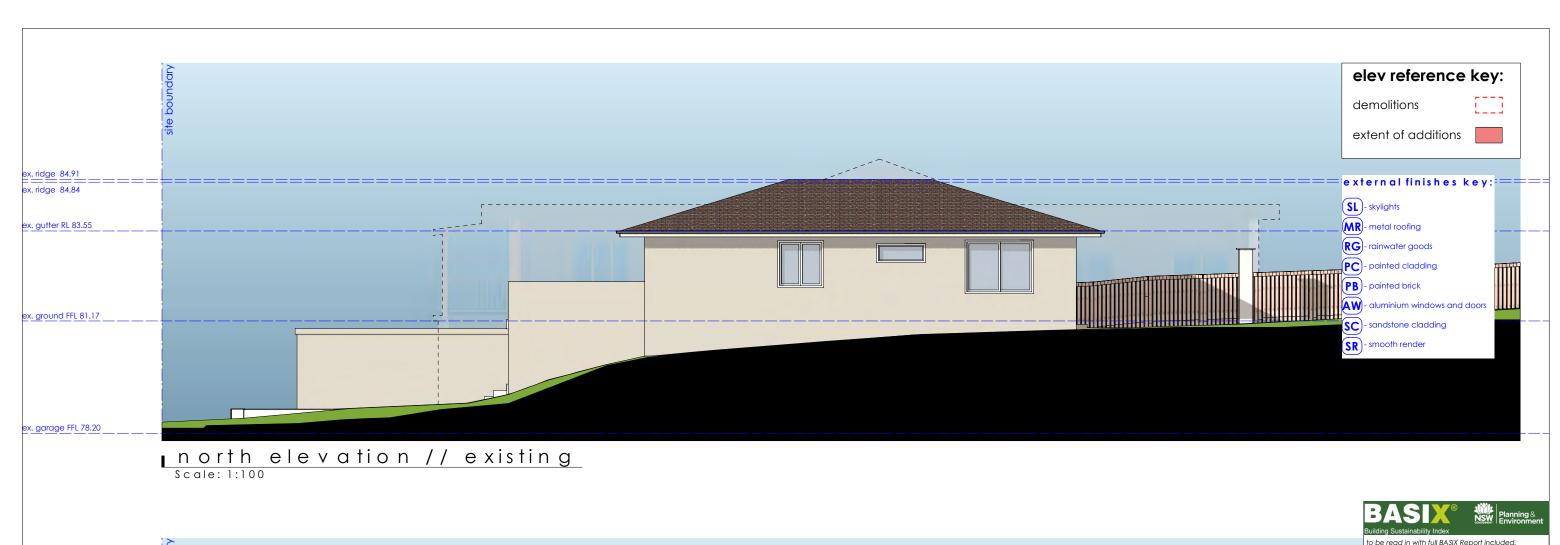

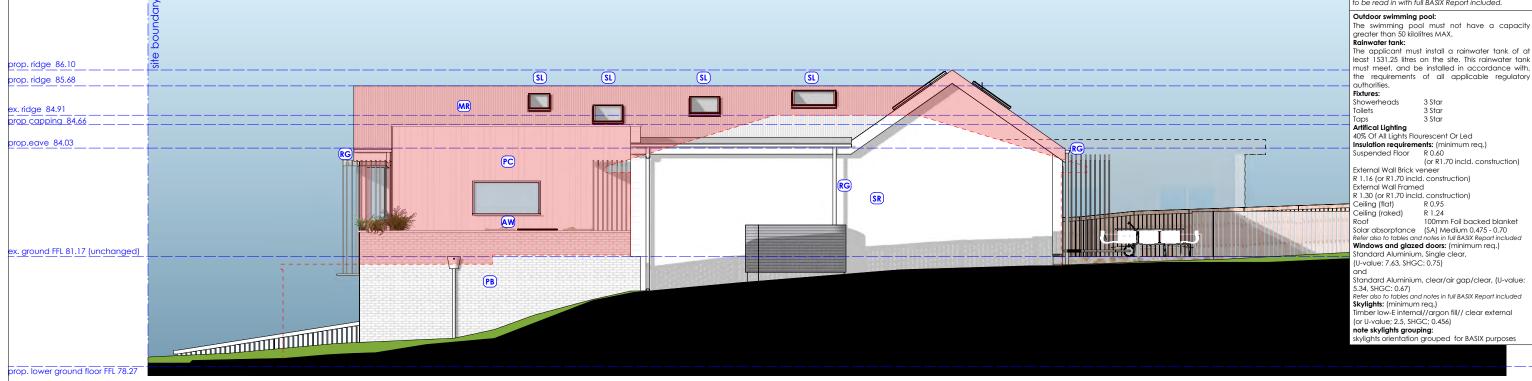

n orth elevation // proposed Scale: 1:100

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project: Alterations 8	& additions	dwg. no.:	DA//10	Rev. no.:	Α
client: W. & L. Quic	k	date:	12/02/2025	issue:	(DA)
NSW 2010. LOT 8 DP 2	0 .	drawn by:	JOB	scale:	1:100 @ a3 —© VIEW//THRI
address: 15 Southern Cross Way,	Allambia Haights	title: Elev	ations North /	'/ Exg. 8	k Prop.



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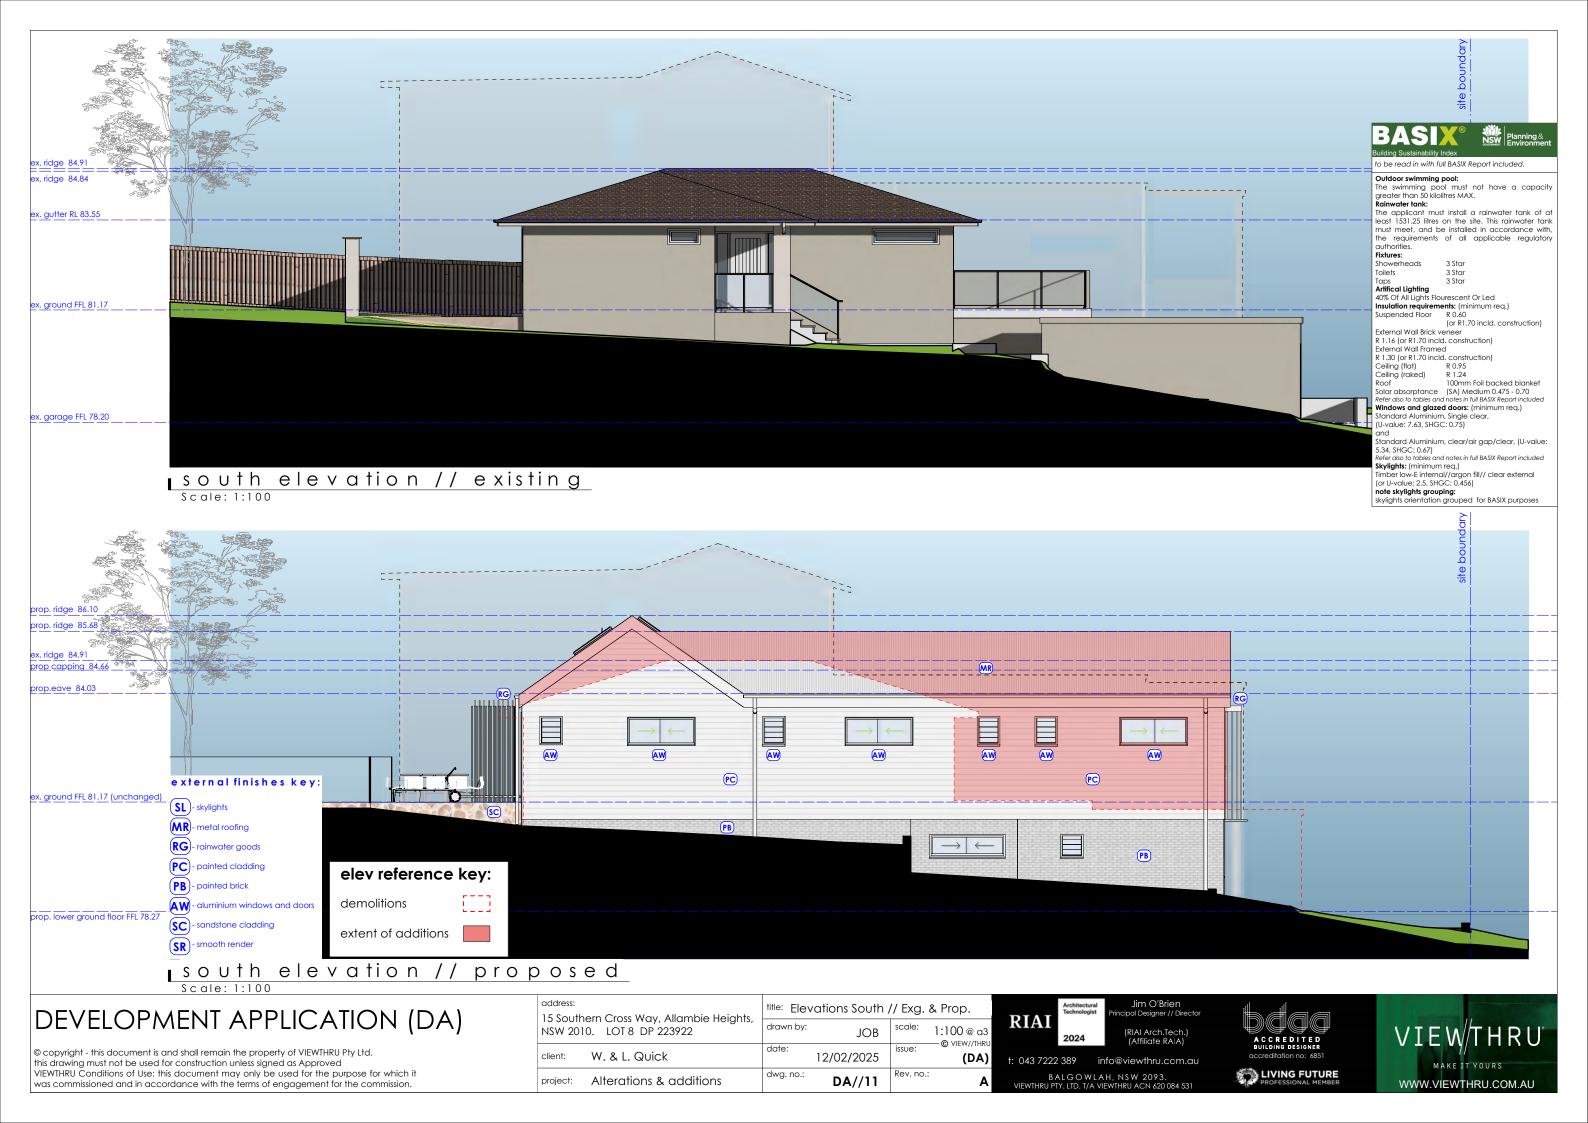





3 Star 3 Star

R 0.95

(or R1.70 incld. construction)



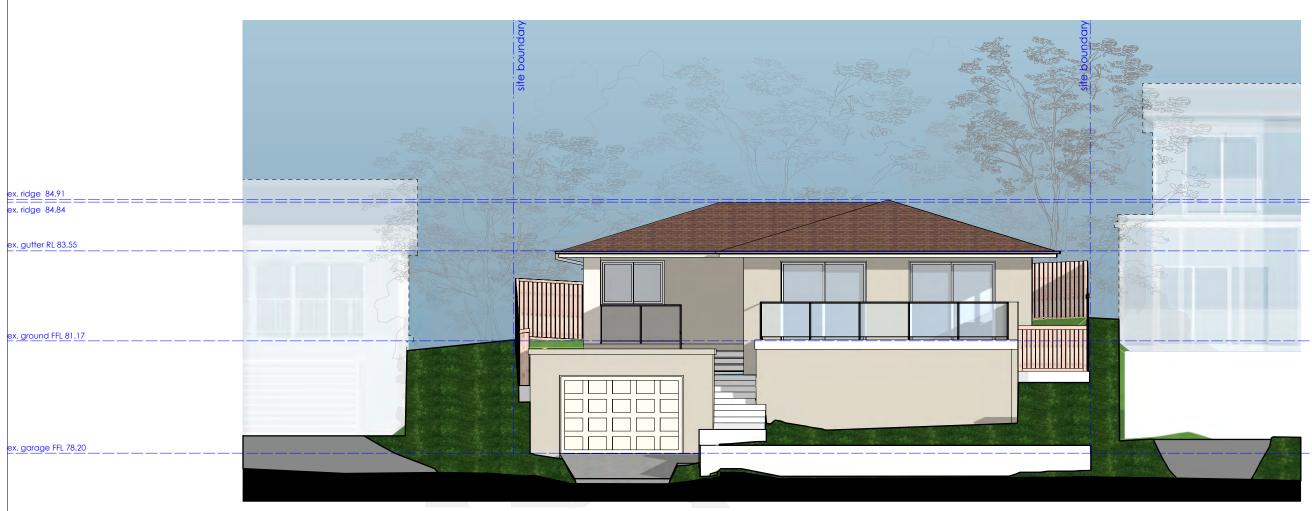

east elevation // existing

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address: 15 Southern Cross Way, Allambie Heights,	title: Elevations East // Existing	
NSW 2010. LOT 8 DP 223922	300	00 @ a3
client: W. & L. Quick	date: 12/02/2025 issue:	(DA)
project: Alterations & additions	dwg. no.: DA//12 Rev. no.:	Α




t: 043 7222 389 info@viewthru.com.au

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<u>east elevation // proposed</u>

elev reference key:

demolitions

extent of additions

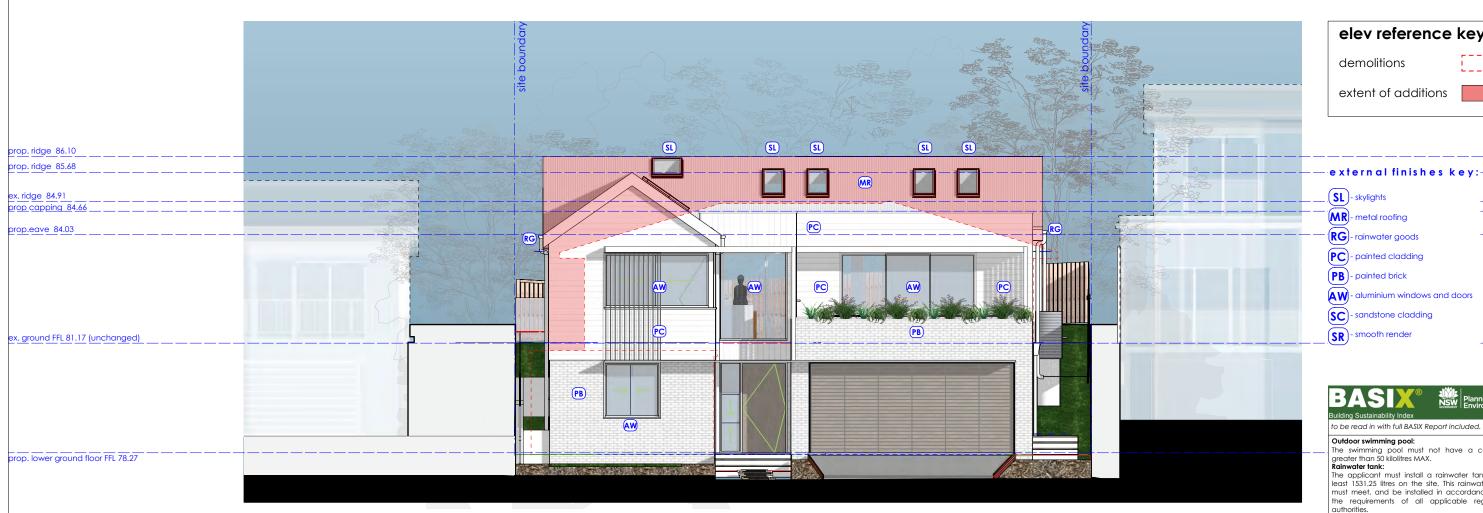SL - skylights

MR - metal roofing

(RG)- rainwater goods

PC - painted cladding

(PB) - painted brick

SC)- sandstone cladding

(SR) - smooth render

Outdoor swimming pool:

Curator swimming pool:
The swimming pool must not have a capacity
greater than 50 kilolitres MAX.
Rainwater tank:
The applicant must install a rainwater tank of at
least 1531,25 litres on the site. This rainwater tank

must meet, and be installed in accordance with, the requirements of all applicable regulatory

authorities.

Fixtures: 3 Star 3 Star 3 Star

Artifical Lighting

40% Of All Lights Flourescent Or Led

Insulation requirements: (minimum req.)

Suspended Floor R 0.60

(or R1.70 incld. construction)

External Wall Brick veneer

R 1.16 (or R1.70 incld. construction)

External Wall Framed R 1.30 (or R1.70 incld. construction)
Ceiling (flat) R 0.95
Ceiling (raked) R 1.24

100mm Foil backed blanket

Solar absorptance (SA) Medium 0.475 - 0.70
Refer also to tables and notes in full BASIX Report included
Windows and glazed doors: (minimum req.)
Standard Aluminium, Single clear,

(U-value: 7.63, SHGC: 0.75) and Standard Aluminium, clear/air gap/clear, (U-value:

Standard Alcriministry, clearly air gapy clear, to-value.
5.34, SHGC: 0.67)
Refer also to tables and notes in full BASIX Report included
Skylights: (minimum req.)
Timber low-E internal/argon fill// clear external
[or U-value; 2.5, SHGC; 0.456)

note skylights grouping: skylights orientation grouped for BASIX purposes

DEVELOPMENT APPLICATION (DA)

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address: 15 Southern Cross Way, Allambie Heights,	title: Elevations East //	Proposed
NSW 2010. LOT 8 DP 223922	drawn by: JOB	scale: 1:100 @ a3
client: W. & L. Quick	date: 12/02/2025	issue: © VIEW//THRI
project: Alterations & additions	dwg. no.: DA//13	Rev. no.:






BALGOWLAH, NSW 2093. RUPTY. LTD. T/A VIEWTHRU ACN 6200







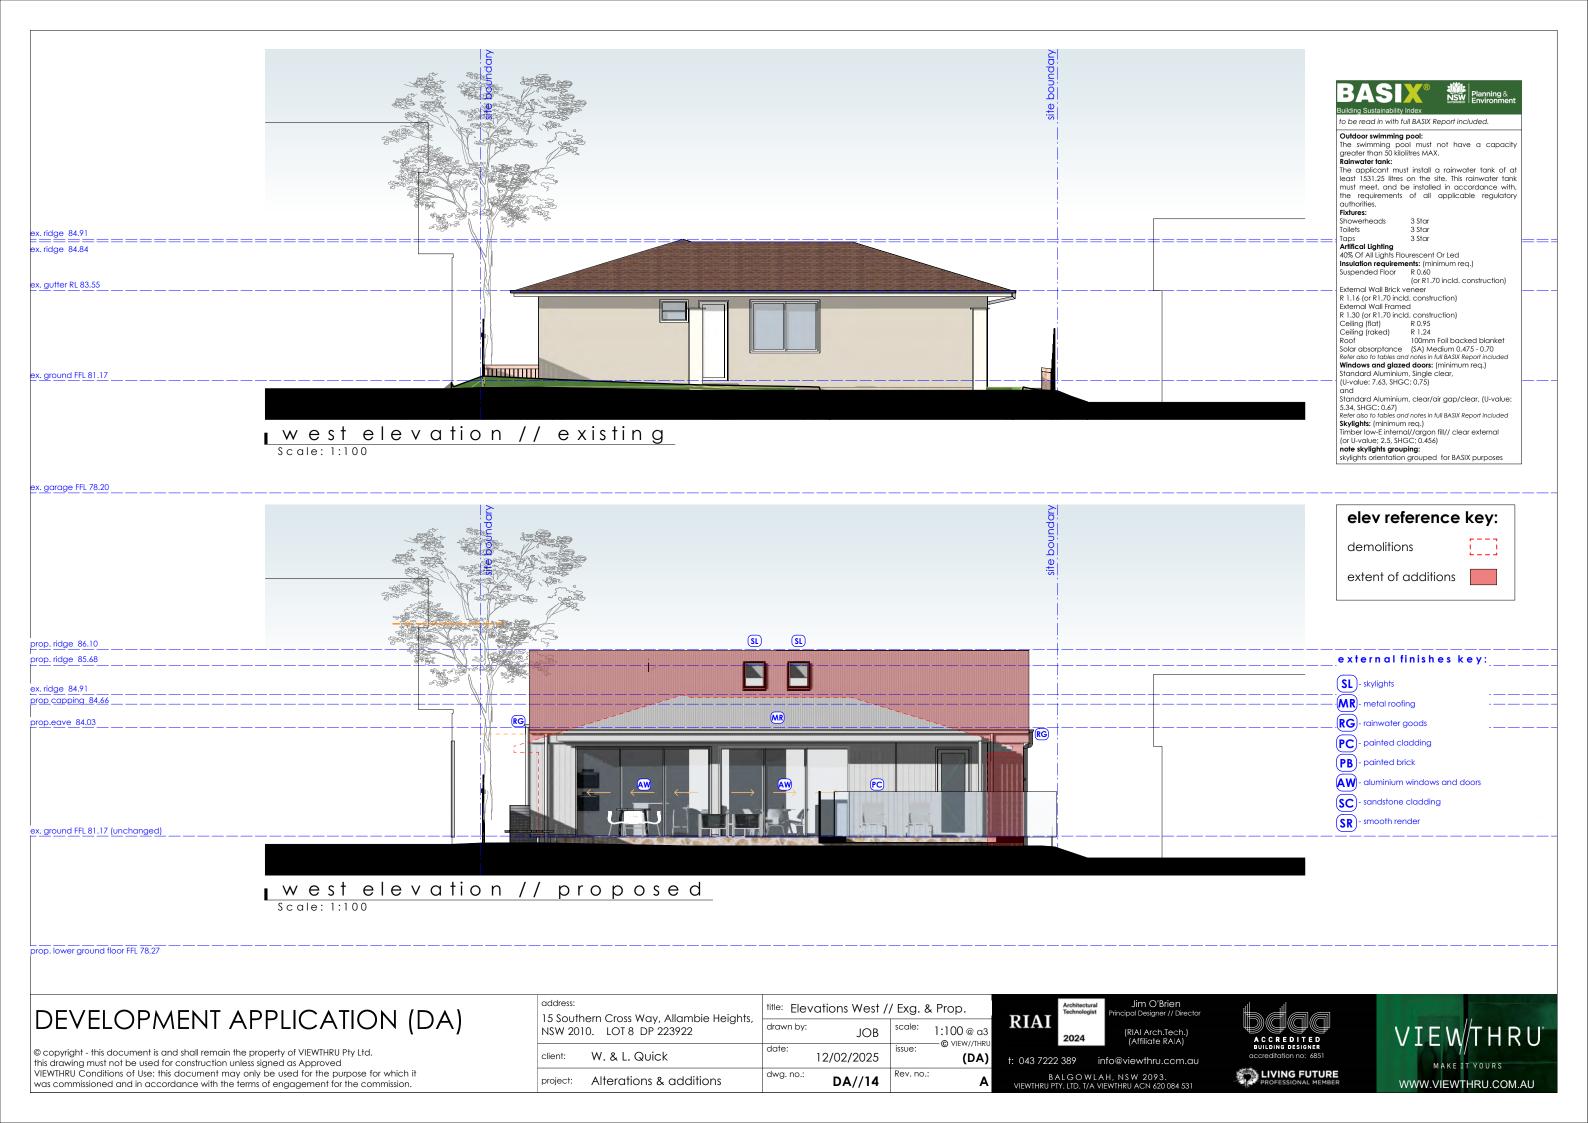

BASIX Certificate Building Sustainability Index www.basix.nsw.gov.au

Alterations and Additions

Certificate number: A1779888

This certificate confirms that the proposed development will meet the NSW government's requirements for sustainability, if it is built in accordance with the commitments set out below. Terms used in this certificate, or in the commitments, have the meaning given by the document entitled "BASIX Definitions" dated 10/09/2020 published by the Department. This document is available at www.basix.nsw.gov.au

Secretary
Date of issue: Tuesday, 14 January 2025
To be valid, this certificate must be lodged within 3 months of the date of issue.



Project address	
Project name	ALLAMBIE #02
Street address	15 SOUTHERN CROSS - ALLAMBIE HEIGHTS 2100
Local Government Area	Northern Beaches Council
Plan type and number	Deposited Plan DP223922
Lot number	8
Section number	-
Project type	
Dwelling type	Dwelling house (detached)
Type of alteration and addition	The estimated development cost for my renovation work is \$50,000 or more, and includes a pool (and/or spa).
N/A	N/A
Certificate Prepared by (please	complete before submitting to Council or PCA)
Name / Company Name: VIEWTHRU PT	TY LTD
ABN (if applicable): 53620084531	
· · · · · · · · · · · · · · · · · · ·	•

BASIX Certificate number:A1779888

Pool and Spa	Show on DA Plans	Show on CC/CDC Plans & specs	Certifier Check
Rainwater tank			
The applicant must install a rainwater tank of at least 1531.25 litres on the site. This rainwater tank must meet, and be installed in accordance with, the requirements of all applicable regulatory authorities.	~	~	~
The applicant must configure the rainwater tank to collect rainwater runoff from at least 50 square metres of roof area.		~	~
The applicant must connect the rainwater tank to a tap located within 10 metres of the edge of the pool.		~	~
Outdoor swimming pool	·		
The swimming pool must be outdoors.	~	~	~
The swimming pool must not have a capacity greater than 50 kilolitres.	~	~	~
The swimming pool must have a pool cover.		~	~
The applicant must install a pool pump timer for the swimming pool.		~	~
The applicant must install the following heating system for the swimming pool that is part of this development: solar (electric boosted).		~	-

BASIX Certificate number:A1779888

Fixtures and systems	Show on DA Plans	Show on CC/CDC Plans & specs	Certifier Check
Lighting			
The applicant must ensure a minimum of 40% of new or altered light fixtures are fitted with fluorescent, compact fluorescent, or light-emitting-diode (LED) lamps.		~	~
Fixtures			
The applicant must ensure new or altered showerheads have a flow rate no greater than 9 litres per minute or a 3 star water rating.		~	~
The applicant must ensure new or altered toilets have a flow rate no greater than 4 litres per average flush or a minimum 3 star water rating.		~	~
The applicant must ensure new or altered taps have a flow rate no greater than 9 litres per minute or minimum 3 star water rating.		~	

Construction	Show on DA Plans	Show on CC/CDC Plans & specs	Certifier Check		
Insulation requirements					
listed in the table below, except that a) addit	red construction (floor(s), walls, and ceilings/ tional insulation is not required where the are of altered construction where insulation alrea	a of new construction is less than 2m2, b)	~	~	~
Construction	Additional insulation required (R-value)	Other specifications			
concrete slab on ground floor.	nil	N/A			
suspended floor with enclosed subfloor: framed (R0.7).	R0.60 (down) (or R1.30 including construction)	N/A			
floor above existing dwelling or building.	nil	N/A			
external wall: brick veneer	R1.16 (or R1.70 including construction)				
external wall: framed (weatherboard, fibro, metal clad)	R1.30 (or R1.70 including construction)				
internal wall shared with garage: plasterboard (R0.36)	nil				
flat ceiling, pitched roof	ceiling: R0.95 (up), roof: foil backed blanket (100 mm)	medium (solar absorptance 0.475 - 0.70)			
raked ceiling, pitched/skillion roof: framed	ceiling: R1.24 (up), roof: foil backed blanket (100 mm)	medium (solar absorptance 0.475 - 0.70)			

Glazing requirements	Show on DA Plans	Show on CC/CDC Plans & specs	Certifier Check
Windows and glazed doors			
The applicant must install the windows, glazed doors and shading devices, in accordance with the specifications listed in the table below. Relevant overshadowing specifications must be satisfied for each window and glazed door.	~	~	~
The following requirements must also be satisfied in relation to each window and glazed door:		~	~
Each window or glazed door with standard aluminium or timber frames and single clear or toned glass may either match the description, or, have a U-value and a Solar Heat Gain Coefficient (SHGC) no greater than that listed in the table below. Total system U-values and SHGCs must be calculated in accordance with National Fenestration Rating Council (NFRC) conditions.		~	~
Each window or glazed door with improved frames, or pyrolytic low-e glass, or clear/air gap/clear glazing, or toned/air gap/clear glazing must have a U-value and a Solar Heat Gain Coefficient (SHGC) no greater than that listed in the table below. Total system U-values and SHGSs must be calculated in accordance with National Fenestration Rating Council (NFRC) conditions. The description is provided for information only. Alternative systems with complying U-value and SHGC may be substituted.		~	~
For projections described in millimetres, the leading edge of each eave, pergola, verandah, balcony or awning must be no more than 500 mm above the head of the window or glazed door and no more than 2400 mm above the sill.	~	~	~
Pergolas with polycarbonate roof or similar translucent material must have a shading coefficient of less than 0.35.		~	~

BASIX Certificate number:A1779888

Glazing requir	ements	Show on DA Plans	Show on CC/CDC Plans & specs	Certifier Check					
Windows and gla	zed doors glazing								
Window/door number	Orientation	Area of glass including frame (m2)	Overshadowing height (m)	Overshadowing distance (m)	Shading device	Frame and glass type			
W01	S	0.36	0	0	none	standard aluminium, single clear, (or U-value: 7.63, SHGC: 0.75)			
W02	S	1.2	0	0	eave/ verandah/ pergola/balcony >=900 mm	standard aluminium, single toned, (or U-value: 7.57, SHGC: 0.57)			
W03	Е	2.25	0	0	eave/ verandah/ pergola/balcony >=450 mm	standard aluminium, single pyrolytic low-e, (U- value: 5.7, SHGC: 0.47)			
W04	S	1.35	0	0	none	standard aluminium, single clear, (or U-value: 7.63, SHGC: 0.75)			
W05	S	0.45	0	0	none	standard aluminium, single clear, (or U-value: 7.63, SHGC: 0.75)			

DEVELOPMENT APPLICATION (DA)

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address:	ern Cross Way, Allambie Heights,	title: BAS			
	D. LOT 8 DP 223922	drawn by:	JOB	scale:	@ a3
client:	W. & L. Quick	date:	12/02/2025	issue:	O VIEW//THR (DA)
project:	Alterations & additions	dwg. no.:	DA//15	Rev. no.:	Δ







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BALGOWLAH, NSW 2093. VIEWTHRU PTY. LTD. T/A VIEWTHRU ACN 620 084 53







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Glazing require	ements	Show on DA Plans	Show on CC/CDC Plans & specs	Certifier Check					
Window/door number	Orientation	Area of glass including frame (m2)	Overshadowing height (m)	Overshadowing distance (m)	Shading device	Frame and glass type			
W06	S	0.45	0	0	none	standard aluminium, single clear, (or U-value: 7.63, SHGC: 0.75)			
W07	S	1.35	0	0	none	standard aluminium, single clear, (or U-value: 7.63, SHGC: 0.75)			
W08	S	0.45	0	0	none	standard aluminium, single clear, (or U-value: 7.63, SHGC: 0.75)			
W09	S	0.45	0	0	eave/ verandah/ pergola/balcony >=900 mm	standard aluminium, single clear, (or U-value: 7.63, SHGC: 0.75)			
W10	s	0.45	0	0	none	standard aluminium, clear/air gap/ clear, (U-value: 5.34, SHGC: 0.67)			

Planning Industry And Environment

Building Sustainability Index www.basix.nsw.gov.au

Glazing requir	ements	Show on DA Plans	Show on CC/CDC Plans & specs	Certifier Check					
Windows and gla	zed doors glazing	requirements							
Window/door number	Orientation	Area of glass including frame (m2)	Overshadowing height (m)	Overshadowing distance (m)	Shading device	Frame and glass type			
W11	N	1.62	0	0	eave/ verandah/ pergola/balcony >=900 mm	standard aluminium, single clear, (or U-value: 7.63, SHGC: 0.75)			
W12	E	4.32	0	0	awning (fixed) >=900 mm	standard aluminium, single clear, (or U-value: 7.63, SHGC: 0.75)			
W13	N	0.8	0	0	external louvre/blind (adjustable)	standard aluminium, single clear, (or U-value: 7.63, SHGC: 0.75)			
D01	E	1.2	0	0	eave/ verandah/ pergola/balcony >=900 mm	standard aluminium, single clear, (or U-value: 7.63, SHGC: 0.75)			
D02	W	2.1	0	0	eave/ verandah/ pergola/balcony >=900 mm	standard aluminium, single clear, (or U-value: 7.63, SHGC: 0.75)			

Planning Industry And Environment Building Sustainability Index www.basix.nsw.gov.au

Glazing requirements								Show on CC/CDC Plans & specs	Certifier Check
Window/door number	Orientation	Area of glass including frame (m2)	Overshadowing height (m)	Overshadowing distance (m)	Shading device	Frame and glass type			
D03	W	8.3	0	0	eave/ verandah/ pergola/balcony >=900 mm	standard aluminium, single clear, (or U-value: 7.63, SHGC: 0.75)			
D04	W	8.6	0	0	eave/ verandah/ pergola/balcony >=900 mm	standard aluminium, single clear, (or U-value: 7.63, SHGC: 0.75)			
W14	E	4.2	0	0	eave/ verandah/ pergola/balcony >=450 mm	standard aluminium, single pyrolytic low-e, (U- value: 5.7, SHGC: 0.47)			
D05	E	8.64	0	0	eave/ verandah/ pergola/balcony >=900 mm	standard aluminium, single clear, (or U-value: 7.63, SHGC: 0.75)			

BASIX Certificate number: A1779888 page 10/11

Glazing requirements	Show on DA Plans	Show on CC/CDC Plans & specs	Certifier Check			
Skylights						
The applicant must install th	e skylights in accordance with the spec	cifications listed in the table l	pelow.	~	~	~
The following requirements	must also be satisfied in relation to each	h skylight:			~	~
Each skylight may either ma listed in the table below.	atch the description, or, have a U-value	and a Solar Heat Gain Coef	fficient (SHGC) no greater than that		~	~
Skylights glazing requiren	nents					
Skylight number	Area of glazing inc. frame (m2)	Shading device	Frame and glass type			
01-05	1.5	no shading	timber, low-E internal/argon fill/clear external, (or U-value: 2.9, SHGC: 0.456)			
05-10	2	no shading	timber, low-E internal/argon fill/clear external, (or U-value: 2.9, SHGC: 0.456)			
11-12	1	no shading	timber, low-E internal/argon fill/clear external, (or U-value: 2.9, SHGC: 0.456)			

page 11/11

Legend
In these commitments, "applicant" means the person carrying out the development.
Commitments identified with a vin the "Show on DA plans" column must be shown on the plans accompanying the development application for the proposed development (if a development application is to be lodged for the proposed development).
Commitments identified with a vin the "Show on CC/CDC plans & specs" column must be shown in the plans and specifications accompanying the application for a construction certificate / complying development certificate for the proposed development.
Commitments identified with a v in the "Certifier check" column must be certified by a certifying authority as having been fulfilled, before a final occupation certificate for the development may be issued.

DEVELOPMENT APPLICATION (DA)

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title: BASIX Report - Sht 2 15 Southern Cross Way, Allambie Heights, drawn by: scale: NSW 2010. LOT 8 DP 223922 @ a3 JOB -© VIEW//THRU date: issue: W. & L. Quick 12/02/2025 (DA) dwg. no.: Alterations & additions DA//16













WINDOW // DOOR SCHEDULE							
IMAGE	ID	Туре	Opening Height	Opening Width	Unit Area	Glazing Type	Comments
	W01	louvre	600 mm	600 mm	0.36 m2	REFER TO BASIX	
	W02	sashless HS	600 mm	2000 mm	1.2 m2	REFER TO BASIX	
	W03	sashless HS	1500 mm	1500 mm	2.25 m2	REFER TO BASIX	
	W04	sashless HS	750 mm	1800 mm	1.35 m2	REFER TO BASIX	
	W05	louvre	750 mm	600 mm	0.45 m2	REFER TO BASIX	
	W06	louvre	750 mm	600 mm	0.45 m2	REFER TO BASIX	
	W07	sashless HS	750 mm	1800 mm	1.35 m2	REFER TO BASIX	
	W08	louvre	750 mm	600 mm	0.45 m2	REFER TO BASIX	
	W09	sashless HS	750 mm	1800 mm	1.35 m2	REFER TO BASIX	
	W10	louvre	750 mm	600 mm	0.45 m2	REFER TO BASIX	
	W11	fixed	900 mm	1800 mm	1.62 m2	REFER TO BASIX	
	W12	fixed	2400 mm	1800 mm	4.32 m2	REFER TO BASIX	
	W13	sashless DH	1500 mm	550 mm	0.825 m2	REFER TO BASIX	
	W14	sashless HS	1500 mm	2800 mm	4.2 m2	REFER TO BASIX	

notes:

- 1. All external glazing units to have aluminium frames as selected unless stated otherwise
- 2. window supplier to issue shop drawings for sign off prior to commencement of fabrication
- 3. Refer to BASIX for glazing spec and shading requirements
- 4. Dimensions given are nominal and to suit scheduled opening sizes, Contractor to check all dimensions on site before proceeding, Contact VIEW//THRU if dimensions conflict.
- 5. Refer to Elevations for fixed/openable sashes.
- 6. window supplier to include for supply of fly screens to all openable sashes.
- 7. All window & door numbers corespond with BASIX reference.
- 8. All operable windows 2m or more above ground level to be capable of being restricted to 125mm sphere in acc. AS and BCA req.
- 9. ALL glazing assemblies to comply with Bush Fire Report recommendations, certification to be issued prior to commencement of fabrication where applicable



DEVELOPMENT APPLICATION (DA)

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address: 15 Southern Cross Way, Allambie Heights,	title: Ext. Window Schedule
NSW 2010. LOT 8 DP 223922	drawn by: JOB scale: @ a3
client: W. & L. Quick	date: 12/02/2025 issue: © VIEW//THRU (DA)
project: Alterations & additions	dwg. no.: DA//17 Rev. no.: A









BALGOWLAH, NSW 2093. RUPTY. LTD. T/A VIEWTHRU ACN 6200





DOOR SCHEDULE									
IMA G E	ID	Туре	Opening Height	Opening Width	Unit Area	Glazing Type	No. Doors	Comments	
<u>↓</u> ↑	D01	hinged door sidelight fixed	2400 mm	1800 mm	4.32 m2	REFER TO BASIX	1		
	D02		2360 mm	900 mm	2.124 m2	REFER TO BASIX	1		
← ← ←	D03	sliding centre opening	2400 mm	3450 mm	8.28 m2	REFER TO BASIX	3		
$\longrightarrow \longrightarrow$	D04	cavity sliding	2400 mm	3589 mm	8.614 m2	REFER TO BASIX			
	D05	sliding centre opening	2400 mm	3600 mm	8.64 m2	REFER TO BASIX	1		

notes:

- 1. All external glazing units to have aluminium frames as selected unless stated otherwise
- 2. window supplier to issue shop drawings for sign off prior to commencement of fabrication
- 3. Refer to BASIX for glazing spec and shading requirements
- 4. Dimensions given are nominal and to suit scheduled opening sizes, Contractor to check all dimensions on site before proceeding, Contact VIEW//THRU if dimensions conflict.
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- 7. All window & door numbers corespond with BASIX reference.
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external finishes schedule



SKYLIGHTS Velux - Colour - RAL 7043 Grey



MR METAL ROOFING Colour - Wallaby (or similar)



RAINWATER GOODS 'Colorbond - Dover White' or similar



PC PAINTED CLADDING 'Colorbond - Dover White' or similar



PB PAINTED BRICK 'Colorbond - Dover White' or similar



AW ALUMINIUM WINDOW AND EXTERNAL DOOR FRAMES

'Colorbond - Dover White' or similar



SC SANDSTONE CLADDING



SR SMOOTH RENDER Color - eg. Dover White or similar

external finishes key:

(SL)- skylights

(MR)- metal roofing

(**RG**)- rainwater goods

(PC)- painted cladding

(PB) - painted brick

(AW) - aluminium windows and doors

- sandstone cladding

smooth render

to be read in with full BASIX Report included Outdoor swimming pool: The swimming pool. The swimming pool must not have a capacity greater than 50 kilolitres MAX. Rainwater tank: The applicant must install a rainwater tank of at least 1531.25 litres on the site. This rainwater tank must meet, and be installed in accordance with, the requirements of all applicable regulatory authorities. Fixtures: Showerheads Toilets 3 Star 3 Star Taps 3 Star Artifical Lighting 40% Of All Lights Flourescent Or Led Insulation requirements: (minimum req.) Suspended Floor R 0.60 (or R1.70 incld. construction) External Wall Brick veneer R 1.16 (or R1.70 incld. construction) External Wall Framed R 1.30 (or R1.70 incld. construction) Ceiling (flat) Ceiling (raked)

Standard Aluminium, clear/air gap/clear, (U-value: 5.34, SHGC: 0.67) Refer also to tables and notes in full BASIX Report included Skylights: (minimum req.) Timber low-E internal//argon fill// clear external (or U-value; 2.5, SHGC; 0.456) **note skylights grouping:**skylights orientation grouped for BASIX purposes

Solar absorptance (SA) Medium 0.475 - 0.70
Refer also to tables and notes in full BASIX Report included Windows and glazed doors: (minimum req.)
Standard Aluminium, Single clear,
(U-value: 7.63, SHGC: 0.75)

DEVELOPMENT APPLICATION (DA)

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address: 15 Southern Cross Way, Allambie Heights,	title: Ext. Door & Finishes Schedule				
NSW 2010. LOT 8 DP 223922	drawn by: JOB scale: @ a3				
client: W. & L. Quick	date: 12/02/2025 issue: (DA)				
project: Alterations & additions	dwg. no.: DA//18 Rev. no.: A				



BALGOWLAH, NSW 2093. U PTY. LTD. T/A VIEWTHRU ACN 620







100mm Foil backed blanket



<u>building height envelope diagram</u>

plan reference key:

extent of non-compliance

building envelope control

DEVELOPMENT APPLICATION (DA)


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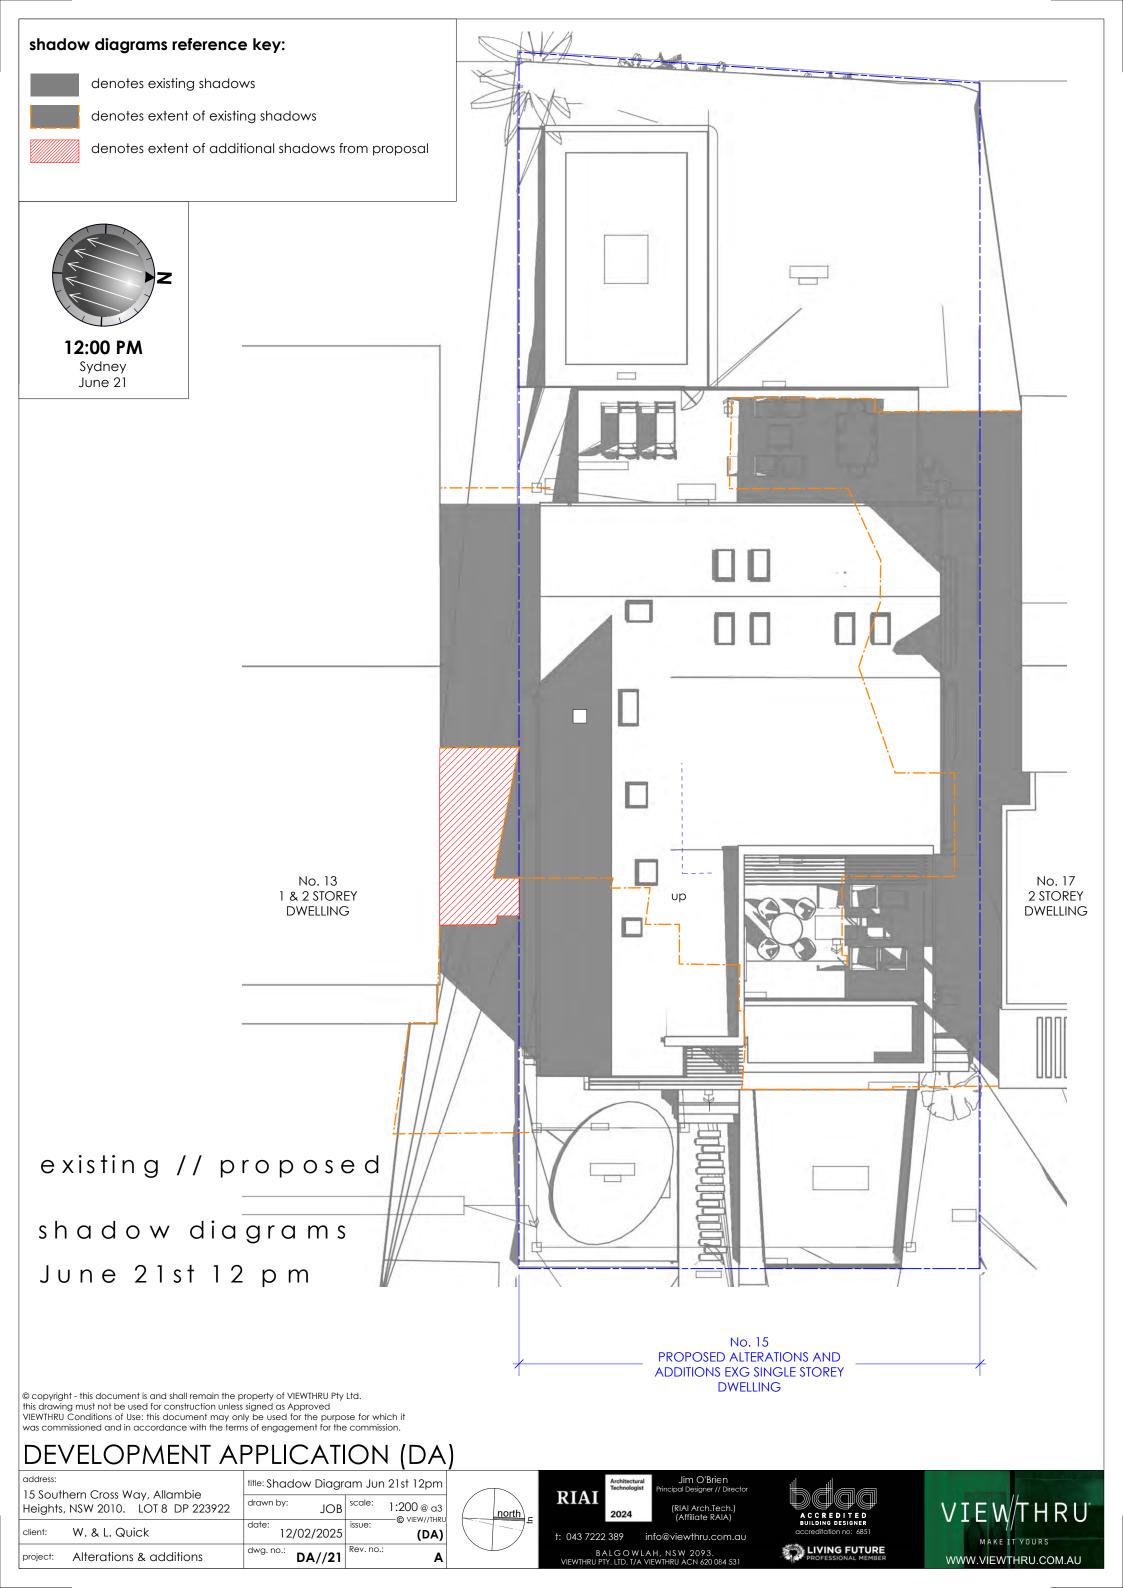
address: 15 Southern Cross Way, Allambie Heights,	title: Building Height Envelope				
NSW 2010. LOT 8 DP 223922	drawn by: JOB	scale: @ a(
client: W. & L. Quick	date: 12/02/2025	issue: © VIEW//THRU			
project: Alterations & additions	dwg. no.: DA//19	Rev. no.:			










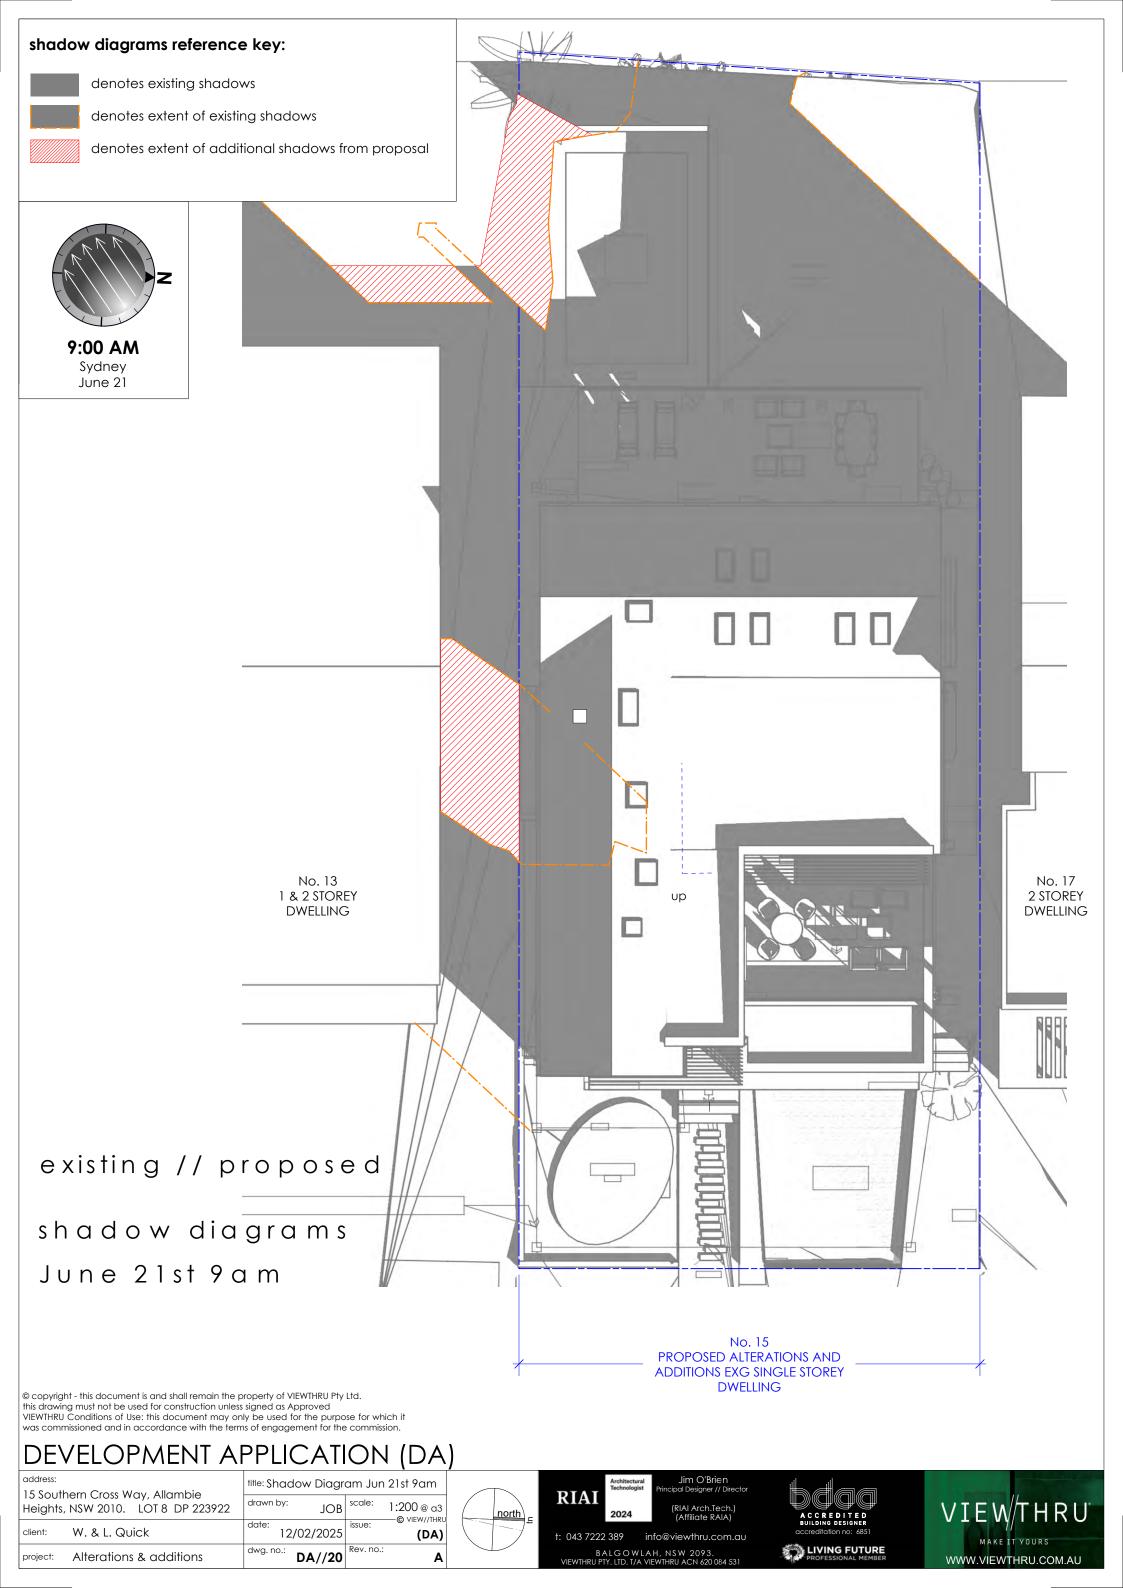

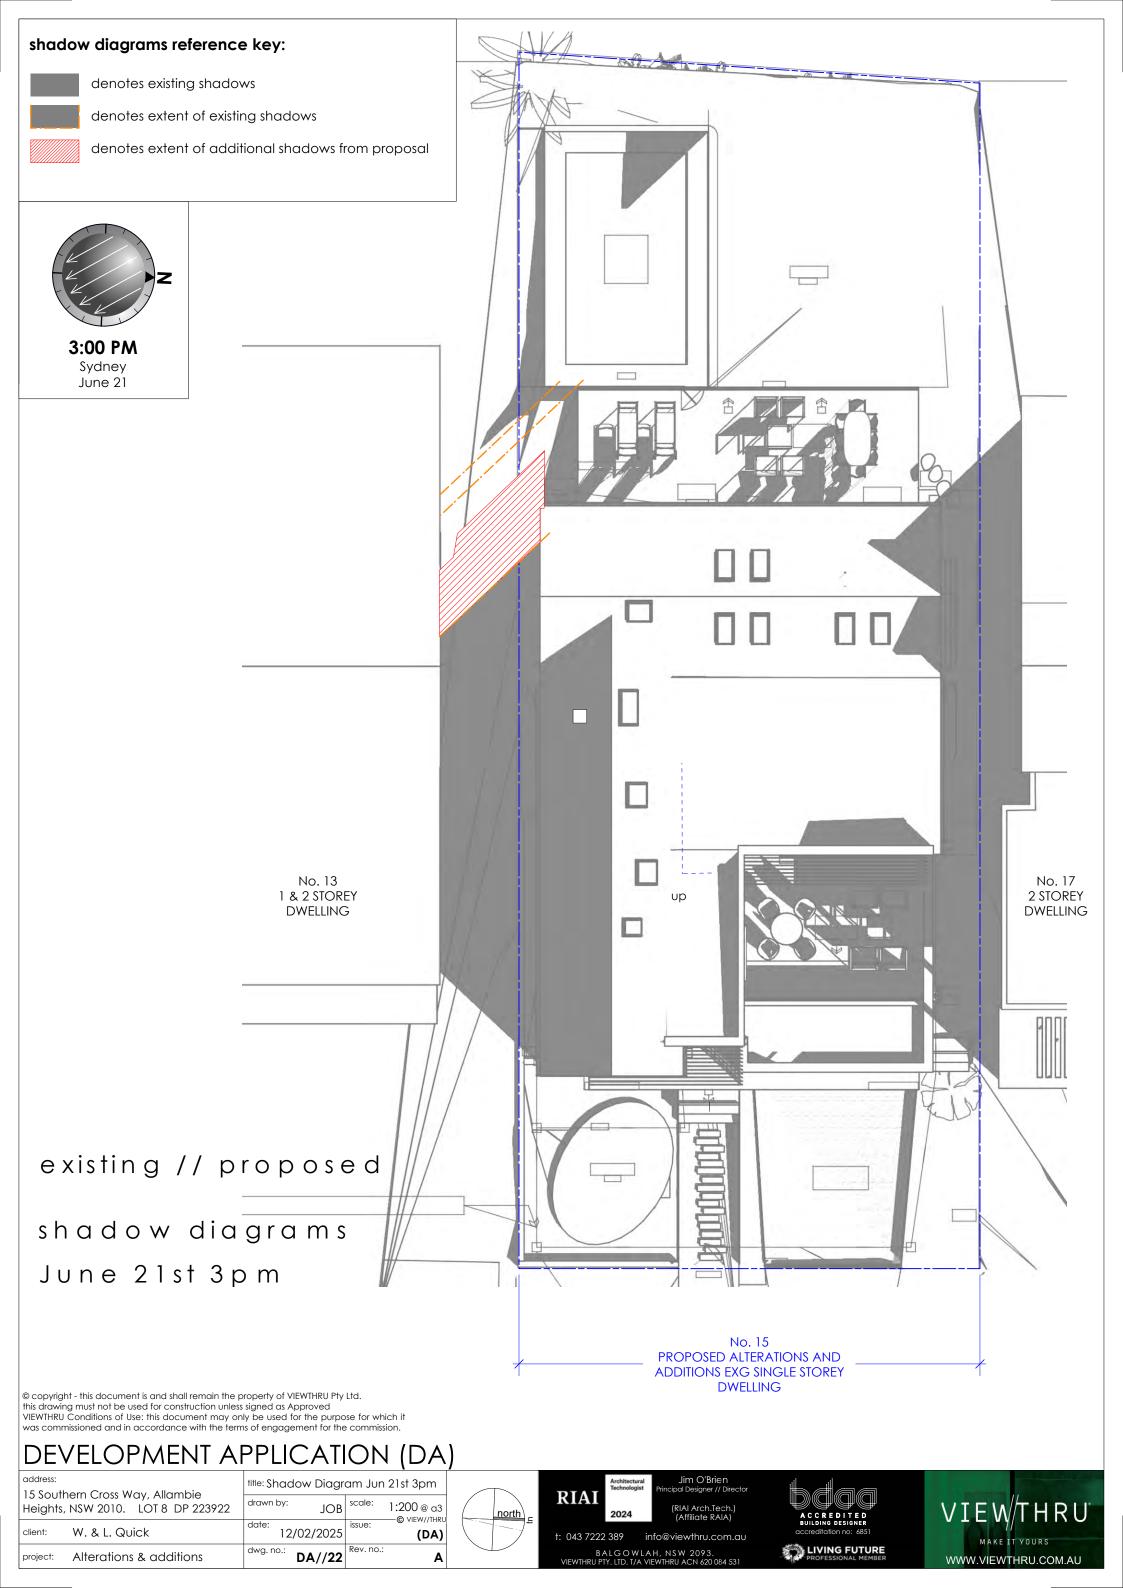



DEVELOPMENT: 15 Southern Cross Way, Allambie Heights NSW 2100, Australia

Applicant: ALLAMBIE

Principal Contractor / Owner Builder(responsible for ESC Plan): TEST

ESC Plan Creation Date: 23/10/2024

Supplementary Comments

Designer: D Barnes (CPESC Cert No. 8494) Proposed Development Area = 387 m2

STORMWATER: SOILS AND CONSTRUCTION VOL. 1, 4TH EDITION (LANDCOM, 2004). 2. ESC MEASURE LOCATIONS ARE INDICATIVE ONLY. FINAL LOCATION TO BE DETERMINED DURING

CONSTRUCTION AND UPDATED AS REQUIRED. 3. CHECK DAMS (I.E. COIR LOGS, GEOTEXTILE GRAVEL BAGS ETC.) SHALL BE USED INSTEAD OF SEDIMENT

FENCE IN CONCENTRATED FLOW PATHS OR WHERE SEDIMENT FENCING CANNOT BE INSTALLED. SMALL 45° RETURNS SHALL BE UNDERTAKEN AT THE ENDS OF THE SEDIMENT FENCING (NOT SHOWN IN THE DRAWING) TO ASSIST WITH THE CONTAINMENT OF RUNOFF AND SEDIMENT. 4. THE REQUIREMENT AND FEASABILITY OF POTENTIAL CLEAN WATER DIVERSIONS NEEDS TO BE

LINDERTAKEN ON-SITE PRIOR TO GROUND DISTURBANCE WORKS. ANY DIVERSION STRUCTURES SHALL BE SUITABLY STABILISED TO CONVEY FLOWS AND SHALL DISCHARGE INTO A SUITABLY STABILISED AREA AND NOT INTO A NEIGHBOURING PROPERTY. 5. ALL ESC MEASURES SHALL BE INSPECTED IN ACCORDANCE WITH THE FREQUENCY ON THE STANDARD

NOTES DRAWING AND MAINTAINED AS REQUIRED THROUGHOUT THE COURSE OF THE WORKS AND

6. ALL SEDIMENT COLLECTED SHALL BE REGULARLY REMOVED AND IF UNSUITABLE FOR REUSE DISPOSED OF IN AN APPROVED MANNER.

7. ESC MEASURES SHALL BE INSTALLED PRIOR TO ANY GROUND DISTURBANCE.

8. ALL TEMPORARY ESC MEASURES SHALL BE REMOVED WHEN NO LONGER REQUIRED.

9. SEDIMENT FENCES SHALL BE PLACED AROUND THE DOWNSLOPE BATTER OF ALL TEMPORARY SOIL STOCKPILE AREAS WHERE OUTSIDE THE MAN DISTURBANCE AREA. THESE STOCKPILES SHALL NOT BE PLACED IN CONCENTRATED FLOW PATHS.

10. GROUND DISTURBANCE WORKS SHALL BE STAGED TO MINIMISE THE POTENTIAL FOR SEDIMENT TO BE MOBILISED IN RUNOFF AT ANY GIVEN TIME. BASED ON THE SEQUENCING OF THE CONSTRUCTION WORKS ADDITIONAL ESC MEASURES MAY BE REQUIRED TO RETAIN SEDIMENT LADEN RUNOFF AS REQUIRED.

11. VISUAL INSPECTIONS OF ALL VEHICLES LEAVING THE SITE WILL BE UNDERTAKEN AND WHERE IT IS DEEMED POSSIBLE THAT SEDIMENT COULD BE TRACKED ONTO THE ADJACENT STREETS, THE VEHICLES SHALL BE WASHED DOWN IN A SUITABLE LOCATION SUCH THAT THE WASH DOWN WATER REPORTS TO APPROPRIATE SEDIMENT CONTROLS. STREET SWEEPING WILL BE USED AS A CONTINGENCY MEASURE WHERE SEDIMENT IS OBSERVED ON THE STREETS.

12. ANY DETAILS OF EXISTING SERVICES SHOWN ON THE DRAWINGS ARE NOT TO BE TAKEN AS INDICATING ALL EXISTING SERVICES OR LOCATIONS. IT IS THE CONTRACTOR'S RESPONSIBILITY TO ADEQUATELY INFORM HIMSELF AS TO THE LOCATION OF ANY AND ALL SERVICES.

13. WORKS SHALL BE UNDERTAKEN DURING PERIODS OF GOOD FORECAST WEATHER (AS BEST AS IS PRACTICALLY POSSIBLE).

14. REFER TO THE CIVIL DRAWINGS FOR PLANT/VEHICLE PARKING AREAS, EQUIPMENT LAYDOWN AREAS AND LIMITS OF CUT/FILL (IF APPLICABLE).

15. ALL HARD WASTE SHOULD BE STORED ON-SITE IN A WAY THAT PREVENTS MATERIAL LOSS CAUSED BY WIND OR WATER. SMALLER MATERIALS SUCH AS LITTER SHOULD BE CONTAINED IN COVERED BINS OR LITTER TRAPS. WHEN TRAVELLING TO AND FROM THE SITE, SECURE LOAD TO PREVENT WIND BLOWN LITTER POLLUTION.

16. DISTURBED AREAS SHALL BE REHABILITAED / SEALED AS SOON AS PRACTICALLY POSSIBLE. THIS MAY INCLUDE TURFING, LANDSCAPING, SEEDING, CONCRETING ETC.

17. ALL AREAS OUTSIDE OF THE GROUND DISTURBANCE AREA SHALL BE CONSIDERED A NO-GO ZONE. AND NOT DISTURBED IN ANY WAY.

NSW GOVERNMENT - SPATIAL SERVICES



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NSW 2010. LOT 8 DP 223922 W. & L. Quick

Alterations & additions

JOB 12/02/2025 (DA) dwg. no.: DA//24



t: 043 7222 389







