

FOR COUNCIL - FIRE RATED WALL NOTES

B 03/06/2021

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PROPOSED ALTERATIONS AND ADDITIONS

DRAWING TITLE:

SITE ANALYSIS PLAN

156 WARRIEWOOD RD, WARRIEWOOD NSW 2102

03/21

880/21

JOB No:

MS

CHECKED BY:

1:200 @ A3

DA.01


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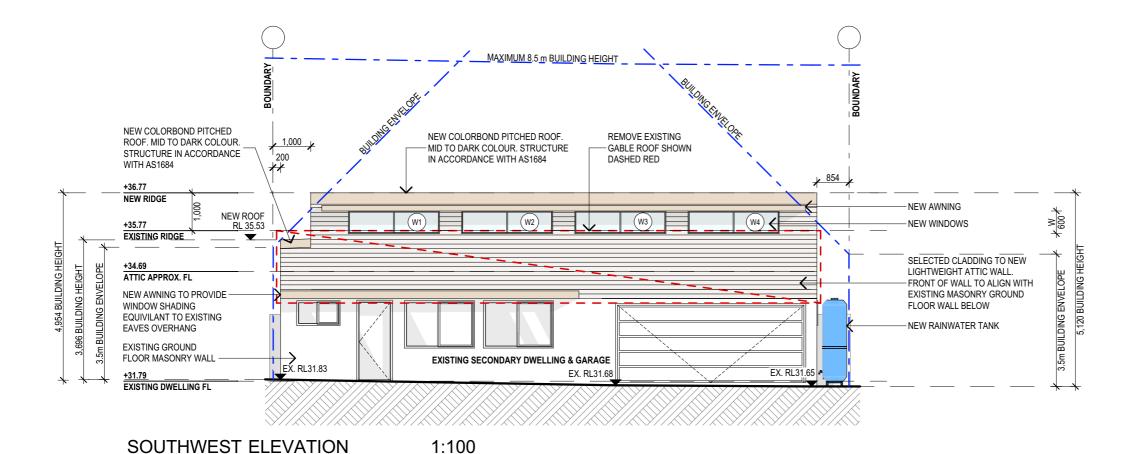



• These drawings are to be read in conjunction with all other consultant's drawings and All workmanship & materials shall be in accordance with the requirements of current edition

by a practicing engineer.

New materials are to be used throughout unless otherwise noted.
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 Concrete footings, slab, structural beams or any other structural members are to be designed.



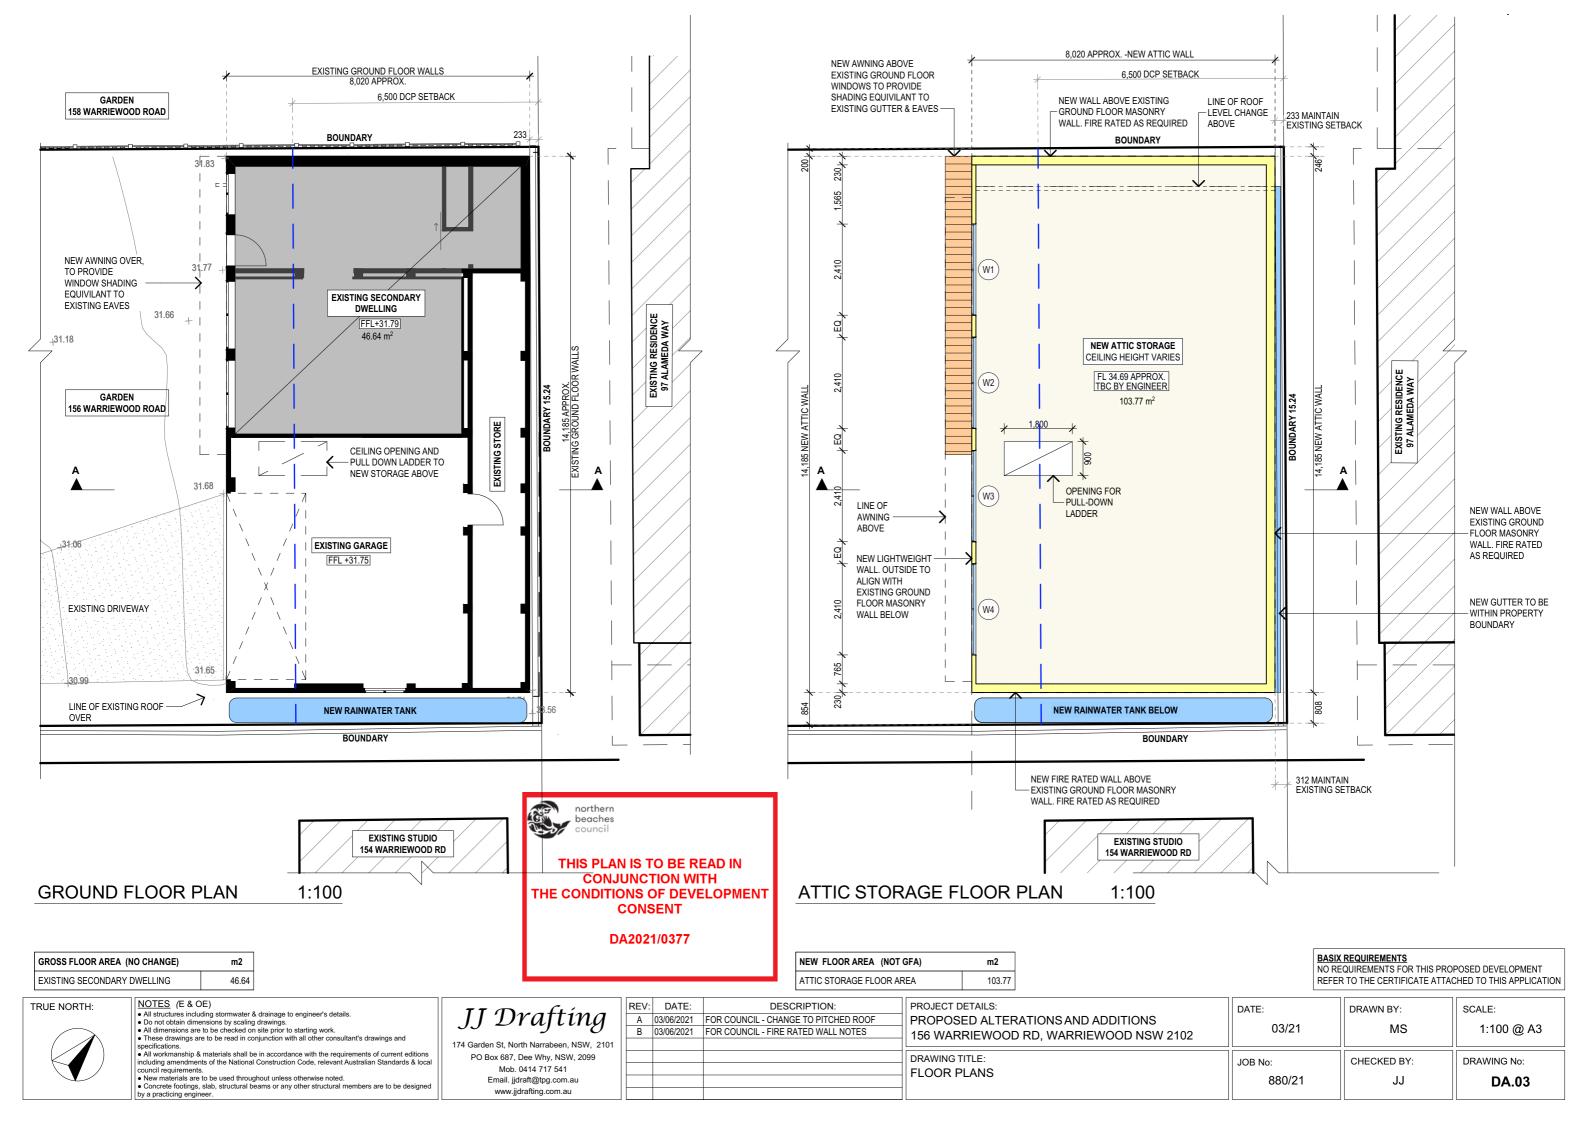

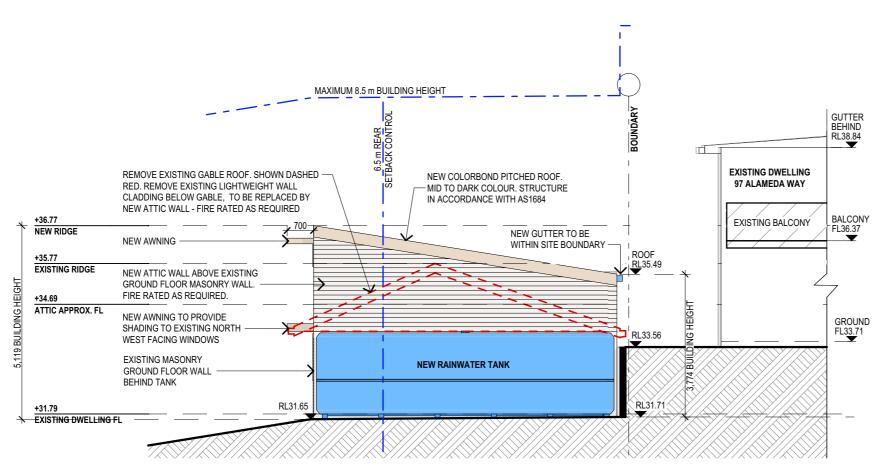

northern beaches THIS PLAN IS TO BE READ IN **CONJUNCTION WITH** THE CONDITIONS OF DEVELOPMENT CONSENT DA2021/0377

SOUTHEAST ELEVATION 1:100

NOTES (E & OE)

- All structures including stormwater & drainage to engineer's details
 Do not obtain dimensions by scaling drawings.
 All dimensions are to be checked on site prior to starting work.

- . These drawings are to be read in conjunction with all other consultant's drawings and specifications.

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	REV:	DATE:	DESCRIPTION:		
	Α	03/06/2021	FOR COUNCIL - CHANGE TO PITCHED ROOF		
	В	03/06/2021	FOR COUNCIL - FIRE RATED WALL NOTES		
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PROJECT DETAILS: PROPOSED ALTERATIONS AND ADDITIONS 156 WARRIEWOOD RD, WARRIEWOOD NSW 2102	DATE: 03/21	DRAWN BY:
DRAWING TITLE: ELEVATIONS SHEET 1	JOB No: 880/21	CHECKED BY:
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BASIX REQUIREMENTS


NO REQUIREMENTS FOR THIS PROPOSED DEVELOPMENT REFER TO THE CERTIFICATE ATTACHED TO THIS APPLICATION

SCALE:

DRAWING No:


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DA.06

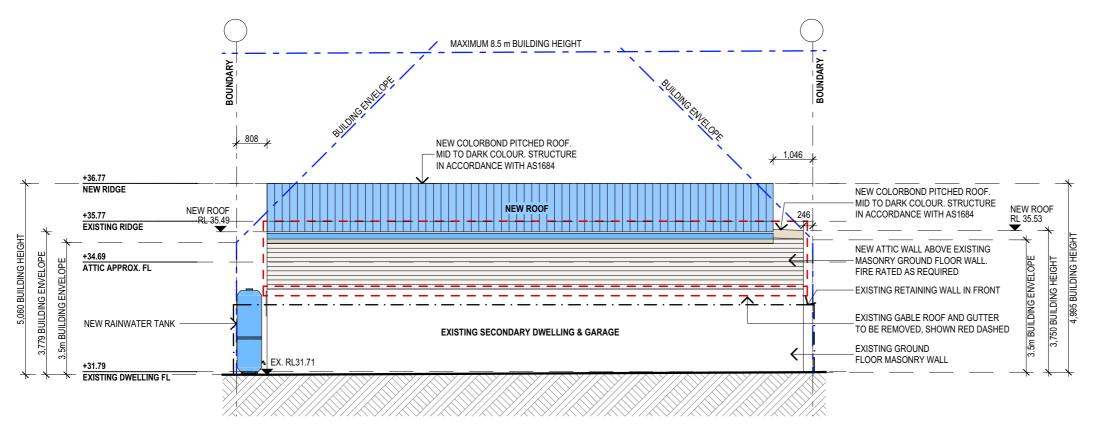

NORTHEAST ELEVATION

1:100

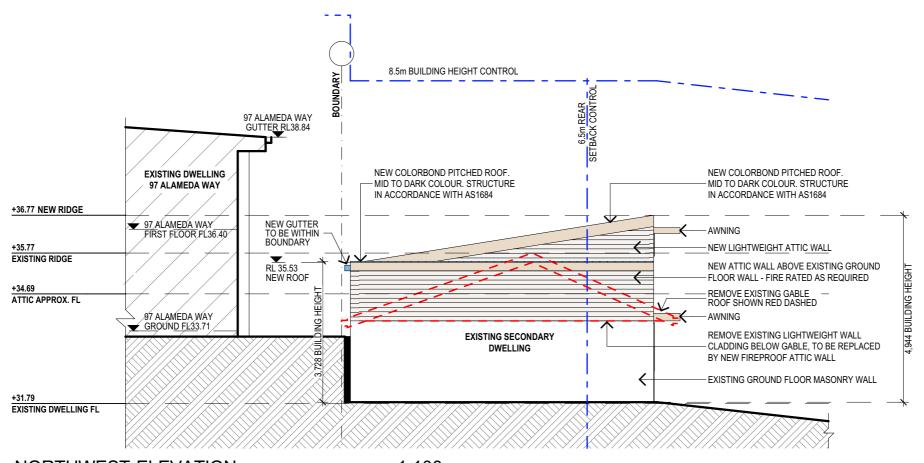

northern beaches

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> > DA2021/0377

NORTHWEST ELEVATION 1:100

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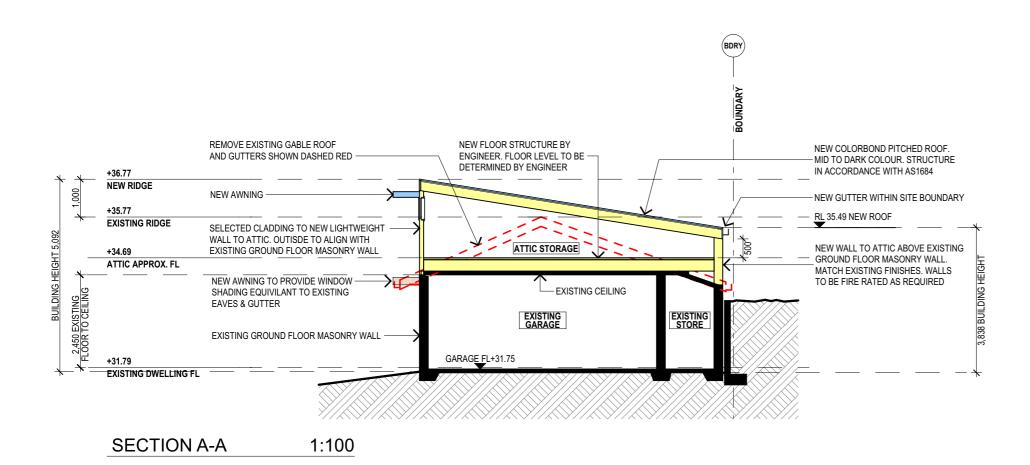
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7	PROJECT DETAILS: PROPOSED ALTERATIONS AND ADDITIONS 156 WARRIEWOOD RD, WARRIEWOOD NSW 2102	DATE: 03/21	DRAWN BY: MS	SCALE: 1:100 @ A3
	DRAWING TITLE: ELEVATIONS SHEET 2	JOB No: 880/21	CHECKED BY:	DRAWING No: DA.07





THIS PLAN IS TO BE READ IN **CONJUNCTION WITH** THE CONDITIONS OF DEVELOPMENT **CONSENT**

DA2021/0377

BASIX REQUIREMENTS

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SPECIFICATION NOTES

PROVIDE PLASTERBOARD LINING

- INSTALL TO MANUFACTURERS SPECIFICATIONS & AS 2589

EXTERNAL WALLS: - BRICK VENEER WALLS WITH SELECTED BRICKS TO DWELLING.

- LIGHTWEIGHT TIMBER CLADDING OR SIMILAR TO SINGLE GARAGE/GYM.
- GROUND FLOOR TO BE REINFORCED CONCRETE SLAB IN ACCORDANCE WITH AS2870.
- FIRST FLOOR TO BE TIMBER FRAMED FINISHED WITH T&G HARDWOOD FLOORING.

SHALL BE INSTALLED TO COMPLY WITH AS1684 AS AMENDED FOR TIMBER COMPONENTS OR AS3620 FOR LIGHTWEIGHT STEEL FRAMING SECTIONS OR AS PER THE NASH ALTERNATIVES TO AS 3623.

PROFILED STEEL ROOF:

- DESIGN AND INSTALLATION SHALL BE IN ACCORDANCE WITH AS/NZS 1562

COLORBOND ROOF CLADDING

CONCRETE BLOCKS OR BRICKS: TO COMPLY WITH TO AS4455 MANSORY BUILDING BLOCKS/PAVER.

BRICK AND BLOCKWORK:

CONSTRUCTION OF MASONRY BUILDINGS SHALL BE AS PER AS3700 OR AS4773.

- TIMBER TO COMPLY WITH AS1170.2 OR AS4055. ALL WORKMANSHIP AND MATERIALS SHALL BE IN ACCORDANCE WITH AS1684 AND 1720 AS APPLICABLE.

- TIMBER FRAMING:
 TO COMPLY WITH NCC VOL.2 PART 3.4
- GROUND FLOOR TIMBERS SHALL BE ONLY OF HARDWOOD, CYPRESS PINE OR PRESSURE TREATED RADIATA OR CANADA PINE BELOW A HEIGHT OF 300mm ABOVE FINISHED GROUND LEVEL AND MUST NOT BE BUILT INTO BRICKWORK.
- SUBFLOOR VENTILATION SHALL CONFORM TO NCC VOL.2 PART 3.4.1.
 IN BUSHFIRE PRONE AREAS SPECIAL CONDITIONS APPLY.
 WHERE TERMITE BARRIERS NEED TO BE INSPECTED, 400mm CLEARANCE IS REQUIRED BETWEEN THE
- UNDERSIDE OF BEARER AND GROUND SURFACE.
- USE TREATED TIMBER WHERE REQUIRED FOR DURABILITY.
 DO NOT USE TIMBER UNSUITABLE FOR EXPOSURE TO MOISTURE IN EXPOSED LOCATION. - PROVIDE STRUCTURE BRACING IN ACCORDANCE WITH AS1684
- PROVIDE STRUCTURE TIEDOWN IN ACCORDANCE WITH AS1684 USE GALVANISED FIXINGS WHERE EXPOSED TO WEATHER.

- TERMITE CONTROL:
 TO BE IN ACCORDANCE WITH TO AS3660.1
- SHALL BE IN ACCORDANCE WITH NCC VOL.2 PART 3.1.3 OR VOL.1 PART B1.4.

FLASHING AND CAPPINGS:

- SELECTION AND INSTALLATION OF METAL RAINWATER GOODS REFER TO AS2180
- FLASH PROJECTIONS ABOVE THE ROOF WITH TWO PART FLASHINGS CONSISTING OF AN APRON FLASHING AND OVER FLASHING, WITH AT LEAST 100mm OVERLAP.
- PROVIDE FOR INDEPENDENT MOVEMENT BETWEEN ROOF AND PROJECTION

- 40% OF NEW OR ALTERED LIGHT FIXTURES TO BE FITTED WITH FLUORESCENT, COMPACT FLUORESCENT, OR LIGHT-EMITTING-DIODE (LED) LAMPS

DOOR & WINDOWS:

- ALL FRAMED WINDOWS SHALL BE INSTALLED IN ACCORDANCE WITH AS2047-48 FOR ALUMINIUM WINDOWS AND AS2047 FOR TIMBER WINDOWS. - ALUMINIUM FRAMED WINDOWS AND DOORS
- WEATHER STRIPPING IS TO BE PROVIDED TO ALL EXTERNAL WINDOWS AND DOORS.

AS PER AS 1657: FIXED PLATFORMS, WALKWAYS, STAIRWAYS AND LADDERS. TO COMPLY WITH ALL RELEVANT SECTIONS OF NCC AUSTRALIA.

- MATERIALS TO BE USED FOR SURFACES OF FLOORS, STAIR LANDING, STEPS AND NOSINGS SHALL BE IN ACCORDANCE WITH THE CLASSIFICATIONS FOR SLIP RESISTANCE AS APPLY IN AS4586 AND HB198.

STORMWATER:

EAVES GUTTERS, VALLEY GUTTERS AND DOWPIPES

- TO COMPLY WITH AS/NZS 2179 FOR METAL AND AS1273 FOR UPVC COMPONENTS.
- NEW DOWNPIPES TO BE CONNECTED INTO EXISTING STORMWATER LINE

- COLORBOND GUTTERS AND DOWNPIPES
- MINIMUM SLOPE OF FAVES AND GUTTERS 1:200

-NCC VOL.1 PARTS B 1.4, D 3.12, F1.13 OR NCC VOL.2 PART 3.6

-NCC VOL 2 PART 3.7.2, FIRE/SMOKE DETECTORS COMPLYING WITH THE REQUIREMENTS OF THE LOCAL GOVERNMENT ACT AND/OR STATE OR TERRITORY REGULATIONS MUST BE FITTED IN THE LOCATIONS REQUIRED AND APPROVED BY THE AUTHORITY AND SHALL BE INSTALLED IN ACCORDANCE WITH AS3786. - INSTALLATIONS IN BUILDINGS OTHER THAN CLASS 1 AND 10 MUST BE INSTALLED AND MANAGED TO COMPLY WITH NCC SPEC. E2.2a.

- MULTIPLE ALARMS WITHIN HOUSES AND SOLE OCCUPANCY UNITS MUST BE HARD WIRED AND INTERCONNECTED.

- ALL WASTE SHALL BE TAKEN AWAY BY TRUCKS TO A SUITABLE LANDFILL OR RECYCLE DEPOT.
- ALL WASTE SHALL BE COVERED DURING TRANSPORTATION.
- WASTE GENERATED DURING CONSTRUCTION SHALL BE PLACED IN STEEL BINS AND TAKEN AWAY BY AN APPROVED CONTRACTOR TO A APPROVED LANDFILL SITE.

- A FILTER CLOTH SYSTEM SHALL BE INSTALLED TO STOP ANY SEDIMENT ENTERING COUNCILS STORMWATER SYSTEM.

ALL PLANS ARE TO BE READ IN CONJUNCTION AND COMPLY WITH THE BASIX CERTIFICATE, BUSHFIRE AND GEOTECH REPORTS.

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ROJECT DETAILS:	
ROPOSED ALTERATIONS AND ADDITIONS	
56 WARRIEWOOD RD, WARRIEWOOD NSW 2102	

1	PROPOSED ALTERATIONS AND ADDITIONS 156 WARRIEWOOD RD, WARRIEWOOD NSW 2102	DATE: 03/21	DRAWN BY: MS	SCALE: 1:100 @ A3
1	DRAWING TITLE: SECTION	JOB No: 880/21	CHECKED BY:	DRAWING No: DA.08