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BUSHFIRE HAZARD ASSESSMENT



Site Details:
Lot 4
DP (Unknown)
(Parent Lot/DP 31/5464)
House No. (Unknown)
Warriewood Road
Warriewood NSW 2102

Report Prepared for: Mr Holl & Ms Nield C/- Rawson Homes Pty Ltd Building F, Level 2, Suite 1 1 Homebush Bay Drive Rhodes NSW 2138

Construction of a two storey dwelling

Executive Summary

As required by Northern Beaches Council a bushfire risk assessment has been carried out in accordance with the procedures and requirements outlined in *Planning for Bushfire Protection* (2006) *Addendum – Appendix 3* (2010) as issued by the NSW Rural Fire Service (RFS). A summary of the findings of this assessment are provided below. Subject to the recommendations proposed in this report, the proposed development has the potential to comply with the aims and objectives of *Planning for Bushfire Protection* (2006).

Site Address	
	Lot 4 DP (Unknown)
	(Parent Lot/DP 31/5464)
	House No. (Unknown)
	Warriewood Road
	Warriewood NSW 2102

GPS Coordinates	
Latitude:	-33.687224
Longitude:	151.300439

Aspect		
	Nort	h

Fire Danger Index Applied	
	FDI 100

Vegetation Classifications							
North	Managed	East	Managed Land	South	Managed	West	Managed
	Land		Lallu		Land		Land

Distance to Vegetation							
North	>140m	East	>140m	South	>140m	West	>140m

Effective	Slope						
North	0-5°	East	N/A	South	N/A	West	N/A
	Downslope						

Bushfire Attack Level								
North	BAL-LOW	East	BAL-LOW	South	BAL-LOW	West	BAL-LOW	

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1. Project Brief

We have been engaged by Rawson Homes Pty Ltd to assess the threat posed to the development in the event of a bushfire. Current fire maps prepared by Northern Beaches Council in accordance with the requirements of Section 146 of the *Environmental Planning and Assessment Act 1979* (as amended) (EPAA) indicate that the site is situated within a bushfire prone area (BPA). The aim of this report is to identify the Bushfire Attack Level (BAL) to which the proposed development should be constructed under *AS 3959-2009: Construction of buildings in bushfire-prone areas* and the NSW variations as contained within *Addendum: Appendix 3* of *Planning for Bushfire Protection* (2010) by the NSW Rural Fire Service to outline the provisions required to facilitate the fighting of bushfires.

The site is located at Lot 4, DP (Unknown), (Parent Lot/DP 31/5464), Warriewood Road, Warriewood NSW 2102.

This report will supplement the development application to Northern Beaches Council for the proposed development of a new dwelling and has been prepared in accordance with the procedures and requirements contained within *Planning for Bushfire Protection* (2006) – *A Guide for Councils, Planners, Fire Authorities and Developers'* with *Addendum: Appendix 3* (2010) as issued by the NSW Rural Fire Service.

The report relies upon the following information:

- Inspection of the site
- Details of the proposed dwelling as produced by Rawson Homes Pty Ltd (See Appendix 2)

2. Introduction

As required by Northern Beaches Council and in accordance with the requirements of Section 79BA of EPAA, a bushfire assessment of the proposed development has been carried out. This was done in accordance with the procedures and requirements contained within *AS 3959–2009* and *Addendum: Appendix 3* (2010) of *Planning for Bushfire Protection* (2006) as issued by the NSW Rural Fire Service. The findings have been outlined in this report to determine compliance with the Building Code of Australia.

The assessment of the site found that any development on the site is <u>not</u> at significant risk of bushfire attack and accordingly, construction to a Bushfire Attack Level of **BAL-LOW** to all elevations of the proposed dwelling is recommended.

3. The Proposed Development

The proposed development is a two storey dwelling. Internally the dwelling will feature a living room, dining, kitchen, leisure, four bedrooms with three bathrooms and garage. The development will have a building footprint area totalling 154.91m^2 . Landscaped areas are proposed to cover approximately 201.35m^2 (51.22%) of the site.

The building will be on a reinforced concrete slab with timber frames and timber roof trusses. A brick, cladding and rendered finish veneer with a colorbond sheet roof covering will form the façade of the dwelling.

4. Assessment of Site Characteristics

The site is located in suburb of Warriewood, within Northern Beaches Local Government Area. The site is situated on Warriewood Road, which will also provide access to the property. The site borders onto vacant lots ready for construction on the eastern, southern and western aspects. The northern aspect of the site faces a roadway, then onto managed lands.

The site is rectangular in shape, with a street frontage of 15.97 metres along Warriewood Road, with the total subject lot size being 393.1m².

The development site has a downward slope from the front of the property to the rear. Figure 1 below displays the allotment boundaries as given by the NSW Government 'SixMaps' website. The satellite image is dated, and does not accurately reflect the current surrounding landscape of the allotment.



Figure 1 – Aerial Mapping showing the lot boundary (NSW SixMaps 2019)

All aspects of the subject site face towards vacant lots ready for the construction of similar dwellings or public infrastructure assets such as roadways and footpaths. These properties and assets present reduced vegetation forms (i.e. maintained lawns and gardens) as well as areas of non-vegetation (i.e. dwellings, roads, paths, ancillary structures) and as such, are not considered to harbour any predominant vegetation formations which are described in *Planning for Bushfire Protection* (2006). Any future developments within this area should also come under the R3 – Medium Density Residential planning codes as per Pittwater Local Environmental Plan 2014 and should present with similar sized dwellings and managed landscaping.



Figure 2 - Photograph showing the northern aspect of the site



Figure 3 – Photograph showing the eastern aspect of the site



Figure 4 - Photograph showing the southern aspect of the site



Figure 5 – Photograph showing the western aspect of the site

As seen within Figures 2-5, all aspects of the site look towards a landscape that is classified as 'Managed Land' as defined within *AS 3959-2009*. This landscape surrounds the entire site from a 140m distance, with no prominent vegetation formations in this area. As such this vegetation was noted in accordance with the Site Methodology procedure given in Section A3.5 of *Addendum: Appendix 3* of *Planning for Bushfire Protection* (2010) however it was not considered to warrant any BAL construction requirements as specified in Table 2.4.2 of *AS 3959-2009*.

4.1 Surrounding Vegetation Types

The fuel categories in *Planning for Bushfires Protection* are described using botanical terminology, such as "forest" and "grassy woodland". It should be noted that when used for bushfire hazard assessment these terms refer to the fuel production capacity and flammability of different vegetation types. Therefore their meaning and application for bushfire hazard assessment may differ from their use in a strictly botanical context.

There are not any prominent forms of vegetation within a 140m distance of the dwelling location. This is based on measurements taken during the site inspection and supplemented by satellite image data from Nearmap. Figure 6 displays a 140m radius surrounding the site.



Figure 6 – 140m radius of the proposed dwelling (Nearmap 2019)

Using the information provided on the site plan produced by Rawson Homes Pty Ltd and by measuring distances as part of the site inspection, the distance between the proposed developments façade to predominant vegetation was determined and is given in Table 2.

Table 2: Setbacks from vegetation

Facade	Distance to Predominant Vegetation
Northern	>140m
Eastern	>140m
Southern	>140m
Western	>140m

4.2 Category of Bushfire Attack

In accordance with the Table 2.4.2 of *AS 3959-2009*, all elevations of the proposed development have been determined as being located within an area of a Bushfire Attack Level considered LOW (BAL-LOW). This is due to there being insufficient risk to warrant specific Bushfire construction requirements. This is predicated on low threat vegetation and non-vegetated areas surrounding the site. Table 3 outlines the construction requirements for the proposed development elevations.

Table 3: BAL construction requirements for the development

Elevation	Level of Construction as per AS 3959-2009
Northern	BAL – LOW
Eastern	BAL – LOW
Southern	BAL – LOW
Western	BAL – LOW

5. Construction and Landscaping Recommendations

This site has been assessed to be within an area that will require a bushfire attack level of **BAL-LOW for all elevations of the dwelling**. Attached as an Appendix 1 are the construction requirements for BAL-LOW from Section 4 of Australian Standard *AS3959-2009: Construction of buildings in bushfire prone areas.*

However, even though the dwelling is not located within 140m of bushfire threatening vegetation, the following construction and landscaping techniques are recommended to mitigate the risk of potential ember attack from this vegetation:

- Using non-combustible gutter and valley guards in the dwelling to limit the accumulation of debris in gutters.
- Storage of combustible materials as far from the dwelling as possible

6. Conclusion

In conclusion, construction standards for building within bushfire-prone areas are set out in Australian Standard *AS 3959–2009: Construction of Buildings in Bushfire Prone Areas. Addendum: Appendix 3* (2010) of *Planning for Bushfire Protection* (2006) provides a procedure for determining the category of bushfire attack and the appropriate level of construction. It is considered that the proposed dwelling is <u>not</u> at particular risk warranting a specific construction standard as given in *AS 3959-2009*, hence a **BAL-LOW rating** is recommended to the proposed development.

However, even though the development is not located within 140m of bushfire threatening vegetation, the following recommendations are made for the dwelling to mitigate the risk of ember attack:

- Using non-combustible gutter and valley guards in the dwelling to limit the accumulation of debris in gutters.
- Storage of combustible materials as far from the dwelling as possible

Craig Hardy

MBA; M.App.Sc.(Env.Toxicology); B.App.Sc.(Env.Health) Accredited Certifier – Building Surveying A2 – 0167

BPAD-D Certified Practitioner - 24168

February 2019

7. References

- Nearmap Pty Ltd (2019) PhotoMaps by Nearmap. Available: http://maps.au.nearmap.com/. Last accessed 28/02/2019
- NSW Rural Fire Service (2006) Planning for Bushfire Protection, A Guide for Councils, Planners, Fire Authorities, Developers and Home Owners. NSW Rural Fire Service, Lidcombe NSW.
- NSW Rural Fire Service (2010) *Planning for Bushfire Protection: Addendum Appendix 3*. NSW Rural Fire Service, Lidcombe NSW.
- NSW State Government. (2019). SixMaps. Available: https://maps.six.nsw.gov.au/. Last accessed 28/02/2019
- Ramsay C & Dawkins D (1993) Building in Bushfire Prone areas Information and Advice. CSIRO and Standards Australia.
- Standards Australia (2009) Australian Standard AS 3959–2009:
 Construction of Buildings in Bushfire-Prone Areas. SAI Global Ltd, Sydney.

8. Appendices

- 1. Construction Levels for BAL-LOW from *AS 3959-2009: Construction of buildings in bushfire-prone areas.*
- 2. Proposed Development Plans as produced by Rawson Homes Pty Ltd job no. A/8854, Issue B, Dated 09/11/2018



ADDENDUM TO

SPECIFICATION

BUSHFIRE CONSTRUCTION REQUIREMENTS FOR BUSHFIRE ATTACK LEVEL BAL-LOW



Owner/s	
Address	
Development Consent Number:	
Construction Certificate:	
Complying Development Certificate Number:	

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SECTION 4 CONSTRUCTION FOR BUSHFIRE ATTACK LEVEL LOW (BAL—LOW)

This Standard does not provide construction requirements for buildings assessed in bushfire-prone areas in accordance with Section 2 as being BAL—LOW.

'Text deleted'

The Bushfire Attack Level BAL—LOW is based on insufficient risk to warrant specific bushfire construction requirements. It is predicated on low threat vegetation and non-vegetated areas (see Clause 2.2.3.2).

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ADDENDUM TO SPECIFICATION

"Bushfire Attack Level - LOW (BAL-LOW)"





APPENDICES

BUSHFIRE CONSTRUCTION REQUIREMENTS APPENDICES D, F, G, AND H of AS3959-2009





AS 3959—2009 102


APPENDIX D ILLUSTRATIONS

(Normative)

The following illustrations (Figures D1 to D4) support requirements of this Standard:
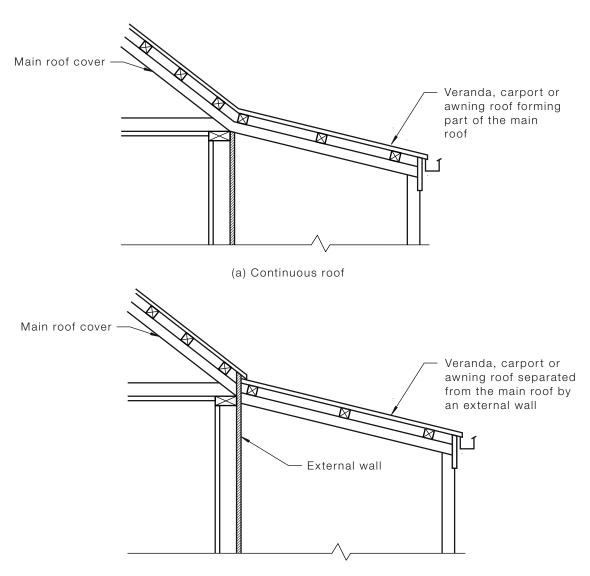
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(b) Continuous roof with veranda, carport or awning roof separated from main roof


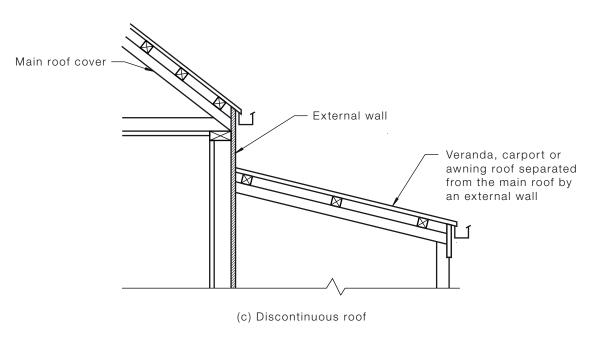



FIGURE D1 VERANDA, CARPORT OR AWNING ROOFS SHOWING CONTINUOUS AND DISCONTINUOUS ROOF TYPES

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AS 3959—2009 104

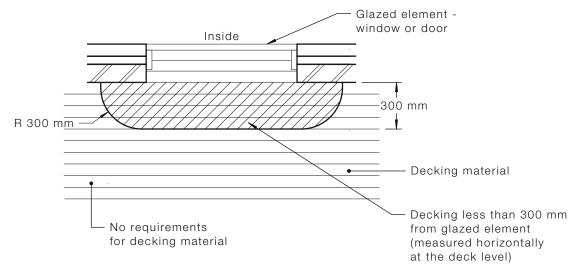

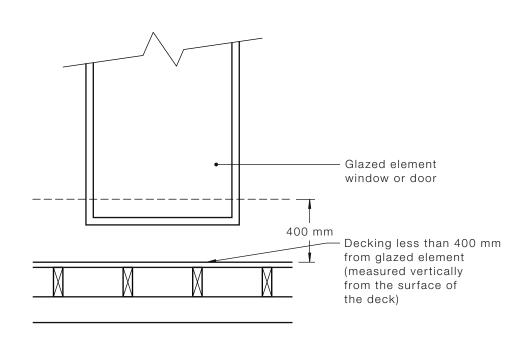(a) Plan view



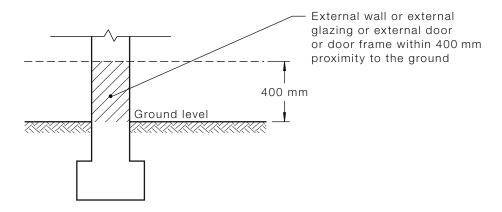
(b) Elevation view

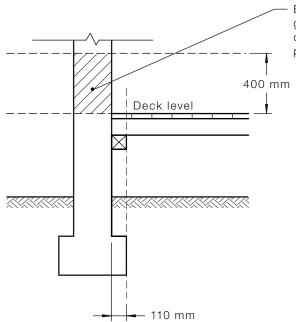
A1

FIGURE D2 DECKING WITHIN HORIZONTAL AND VERTICAL LIMITS OF GLAZED ELEMENTS


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External wall or external glazing or external door or door frame within 400 mm proximity to the deck



DIMENSIONS IN MILLIMETRES

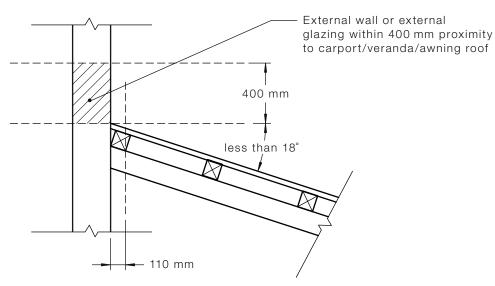FIGURE D3 EXTERNAL WALLS OR EXTERNAL GLAZING, OR EXTERNAL DOORFRAMES WITHIN LIMITS ABOVE GROUND, DECKS, CARPORT ROOFS

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AS 3959—2009 106

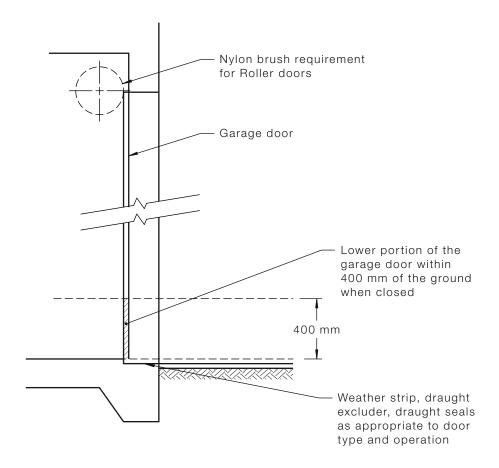


FIGURE D4 VEHICLE ACCESS DOORS (GARAGE DOORS)

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APPENDIX F

BUSHFIRE-RESISTING TIMBER

(Normative)

F1 GENERAL

A3

A2

A2

Bushfire-resisting timber is timber that is in solid, laminated or reconstituted form is deemed to be acceptable to withstand exposure up to a BAL—29 condition.

Timber may be 'bushfire-resisting' by means of one or more of—

- (a) the inherent properties of the material itself;
- (b) being impregnated with fire-retardant chemicals; or
- (c) the application of fire-retardant coatings or substrates.

F2 TESTING

The following apply:

- (a) To satisfy the requirements for bushfire-resisting timber, timber shall be tested in accordance with AS/NZS 3837 and shall meet the following criteria:
 - (i) The maximum heat release rate shall be not greater than 100 kW/m².
 - (ii) The average heat release rate for 10 min following ignition shall be not greater than 60 kW/m² when the material is exposed to an irradiance level of 25 kW/m².
- (b) Where the timber has been altered by chemicals, the test samples shall be subjected to the regime of accelerated weathering described in Paragraph F3 except that where the timber is protected from the weather, as described in AS 1684.2 and AS 1684.3 (for example, cladding protected by a veranda), accelerated weathering of the test samples is not required before being tested to AS/NZS 3837.

External timbers are deemed to be protected if they are covered by a roof projection (or similar) at 30 degrees or greater to the vertical and they are well detailed and maintained (painted or stained and kept well ventilated).

NOTE: The purpose of testing is to assess timber performance rather than to simulate a bushfire. The irradiance set for the test is not to be considered to be correlated to the BAL.

F3 ACCELERATED WEATHERING

Where accelerated weathering is required before testing to AS/NZS 3837, external fire-retardant-coated substrates shall be subjected to the ASTM D2898 Method B weathering regime, with the water flow rate modified to be the same as that within ASTM D2898 Method A.

F4 BUSHFIRE-RESISTING SPECIES

Some species have been tested and have met the requirements of Paragraph F2 above.

NOTE: For bushfire-resisting species, see Appendix H.

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APPENDIX G

EXPLANATION OF BUSHFIRE ATTACK LEVELS (BALs)

(Informative)

G1 GENERAL

A1

To determine the construction requirements for a building site, the threat or risk of bushfire attack needs to be assessed.

G2 1999 and 2009 EDITIONS OF AS 3959

The 1999 edition of AS 3959 provided four levels of risk: Low, Medium, High, Extreme.

This Standard provides six levels of risk: BAL—LOW, BAL—12.5, BAL—19, BAL—29, BAL—40, BAL—FZ.

The BAL system of levels (see Paragraph G4) is based on the potential exposure of the site to heat flux exposure thresholds, expressed as kW/m² (see Table G1). Because the site assessment methodology has changed, it is NOT appropriate to compare the construction requirements from a level in the 1999 edition with those of a level in this Edition.

G3 RADIANT HEAT THRESHOLDS OF PAIN AND IGNITION

In a bushfire, radiant heat levels may be unsafe for humans and could also ignite combustible materials in the vicinity. Table G1 provides an indication of the potential effects of radiant heat levels on both humans and selected materials to assist the reader in understanding the implications of the different BALs.

TABLE G1
TYPICAL RADIANT HEAT INTENSITIES
FOR VARIOUS PHENOMENA

Phenomena	kW/m ²
Pain to humans after 10 s to 20 s	4
Pain to humans after 3 s	10
Ignition of cotton fabric after a long time (piloted) (see Note 2)	13
Ignition of timber after a long time 13 (piloted) (see Note 2)	13
Ignition of cotton fabric after a long time (non-piloted) (see Note 3)	25
Ignition of timber after a long time (non-piloted) (see Note 3)	25
Ignition of gaberdine fabric after a long time (non-piloted) (see Note 3)	27
Ignition of black drill fabric after a long time (non-piloted) (see Note 3)	38
Ignition of cotton fabric after 5 s (non-piloted) (see Note 3)	42
Ignition of timber in 20 s (non-piloted) (see Note 3)	45
Ignition of timber in 10 s (non-piloted) (see Note 3)	55

NOTES:

- 1 Source AS 1530.4—2005.
- 2 Introduction of a small flame to initiate ignition.
- 3 Flame not introduced to initiate ignition.

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G4 BUSHFIRE ATTACK LEVELS (BALs) EXPLAINED

The 2009 edition of AS 3959 (this Standard) explains Bushfire Attack Levels (BALs) as follows:

(a) **BAL—LOW** The risk is considered to be **VERY LOW**.

There is insufficient risk to warrant any specific construction requirements but there is still some risk.

(b) **BAL—12.5** The risk is considered to be **LOW**.

There is a risk of ember attack.

The construction elements are expected to be exposed to a heat flux not greater than 12.5 kW/m^2 .

(c) **BAL—19** The risk is considered to be **MODERATE**.

There is a risk of ember attack and burning debris ignited by wind borne embers and a likelihood of exposure to radiant heat.

The construction elements are expected to be exposed to a heat flux not greater than 19 kW/m^2 .

(d) BAL—29 The risk is considered to be HIGH.

There is an increased risk of ember attack and burning debris ignited by windborne embers and a likelihood of exposure to an increased level of radiant heat.

The construction elements are expected to be exposed to a heat flux not greater than 29 kW/m^2 .

(e) BAL—40 The risk is considered to be VERY HIGH.

There is a much increased risk of ember attack and burning debris ignited by windborne embers, a likelihood of exposure to a high level of radiant heat and some likelihood of direct exposure to flames from the fire front.

The construction elements are expected to be exposed to a heat flux not greater than 40 kW/m^2 .

(f) **BAL—FZ** The risk is considered to be **EXTREME**.

There is an extremely high risk of ember attack and burning debris ignited by windborne embers, and a likelihood of exposure to an extreme level of radiant heat and direct exposure to flames from the fire front.

The construction elements are expected to be exposed to a heat flux greater than 40 kW/m^2 .

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A2

APPENDIX H BUSHFIRE-RESISTING SPECIES

(Informative)


The following species have been tested and have met the requirements of Paragraph F2, Appendix F:

Standard trade name	Botanical name
Ash, silvertop	Eucalyptus sieberi
Blackbutt	Eucalyptus pilularis
Gum, red, river	Eucalyptus camaldulensis
Gum, spotted	Corymbia maculata
	Corymbia henryi
	Corymbia citriodora
Ironbark, red	Eucalyptus sideroxylon
Kwila (Merbau)	Intsia bijuga
Turpentine	Syncarpia glomulifera

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ADDENDUM TO SPECIFICATION "Appendices D, F, G and H of AS3959-2009"



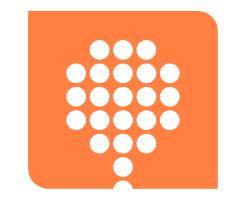

RAWSON HOMES

- EST 1978 -

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- * ALL DIMENSIONS ARE TO STRUCTURAL FRAMES ONLY **EXCLUDING FINISHED SURFACES**

RAWSON HOMES

Builder's licence No. 33493C

1 HOMEBUSH BAY DRIVE, BLDG. F LEVEL 2, SUITE 1 RHODES NSW 2138 TELEPHONE 02 8765 5500 FAX 02 8765 8099



MR. T. HOLL & MS. K. J. NIELD

SITE ADDRESS:

LOT 4 (DP UNREG.) WARRIEWOOD ROAD WARRIEWOOD NSW 2102 HOUSE TYPE

HUNTLEY 27 MODEL: MAJESTIC FACADE: DOUBLE GARAGE

SPECIFICATION: LUX

DRAWING TITLE:

COVER SHEET

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SCHEDULE OF DRAWINGS:

SHEET	<u>CONTENTS</u>
01	COVER SHEET
02	SITE PLAN
03	GROUND FLOOR
04	FIRST FLOOR
05	ELEVATIONS 1-2
06	ELEVATIONS 3-4
07	SECTIONS
08	WET AREA DETAILS
09	SLAB SETOUT PLAN (NOT IN SET)
10	SITE ANALYSIS & SEDIMENT PLAN
11	SHADOW DIAGRAMS
KD	KITCHEN DETAILS

AMENDMENTS							
ISS	DESCRIPTION	BY	DATE				
Α	APPLICATION PLANS (VAR:1-10)	PG	11.09.18				
В	SUBMISSION PLANS (VAR:11-28) + (C1,C2)	PG	09.11.18				

SUBMISSION PLANS - DA

A008854

SIGNATURE:			
DRAWN BY:	DATE DRAWN:	CHECKED BY:	APPROVED FOR
DD	12.11.18	QC	CONSTRUCTION:
COUNCIL AREA:		SCALE:	
PITTWATER			

DRWG No:

01

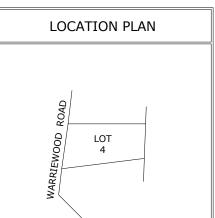
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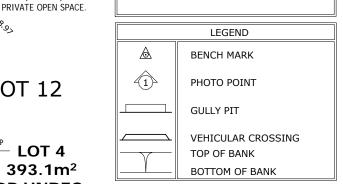
В

BEFORE STARTING WORK ON SITE CHECK FOLLOWING:

- 1. SERVICE LOCATIONS
- 2. SEWER CONNECTION POSITION
- 3. DRIVEWAY ALIGNMENT & LEVELS

DP • INDICATES DOWNPIPE LOCATION





ĺ	ABBREVIATIONS
	EB - ELECTRICAL BOX EM - ELECTRICAL METER GM - GAS METER H - HYDRANT R - HYDRANT RECYCLED KO - KERB OUTLET LP - LIGHT POLE LH - LAMP HOLE MH - MAN HOLE PP - POWER POLE SH - SHRUB SMH - SEWER MAN HOLE SIO - SEWER INSPECTION OPENING SV - STOP VALVE SR - STOP VALVE SR - STOP VALVE SVP - SEWER VENT PIPE SWP - STORM WATER PIT T - TREE TP - TELECOMMUNICATIONS PIT VER - VERANDAH WT - WATER TAG WM - WATER METER
	WMR - WATER METER RECYCLED WC, GC, EC, TC - SERVICE CONDUIT W/C - WATER CLOSET

SITE NOTES:



WARNING **UNREGISTERED PLAN**

N2 WIND CATEGORY 1m FALL ACROSS BUILDING ENVELOPE


DRIVEWAY & PATH TO COMPLY WITH AS2890

EXISTING TREES GREATER THAN 8m IN HEIGHT WITHIN 3m OF THE PROPOSED BUILDING OR ANY TREES WITHIN PROPOSED DRIVEWAY TO BE REMOVED BY OWNER PRIOR TO CONSTRUCTION

GENERAL SITING NOTES:

- ALL PROPOSED FINISH FLOOR LEVELS AND CUT/FILL REQUIREMENT SUBJECT TO CONFIRMATION UPON COMPLETION OF ARCHITECTURAL PLANS
- ALL PROPOSED FINISH FLOOR LEVELS ARE SUBJECT TO CONFIRMATION WITH STEPDOWNS NOMINATED PRIOR TO EXCAVATION BY BUILDER, EXCAVATOR AND/OR CONCRETOR
- ALL FLOOR AREA CALCULATIONS ARE TO BE CONFIRMED UPON THE COMPLETION OF FINAL ARCHITECTURAL PLANS
- ALL ALLOWANCES FOR STEPS/STAIRS THAT MAY BE REQUIRED ARE SUBJECT TO FINAL ARCHITECTURAL PLANS
- ALL ALLOWANCES FOR RETAINING WALLS ARE SUBJECT TO FINAL ARCHITECTURAL PLANS

SITE CALCULATIONS DA						
GROUND FLOOR	101.73	m²				
FIRST FLOOR	102.81	m²				
TOTAL LIVING AREA	204.54	m²				
SITE AREA	393.10	m²				
BUILDING FOOTPRINT	154.91	m²				
DRIVEWAY & PATH	36.84	m²				
CROSSOVER	10.90	m²				
TOTAL LANDSCAPE AREA	201.35	m²				
LANDSCAPE AREA (%)	51.22	%				
FLOOR SPACE RATIO	0.52	:1				
SITE COVERAGE	39.41	%				

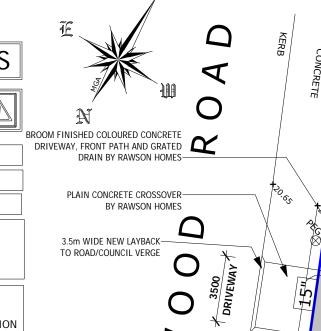

LOT 12 6302 431 6 **PROPOSED** PORCH ري. زک RESIDENCE REAR 6500 FFL: 19.810 RL: 19.000 DEB 500 LOT 4 LOUNGE 393.1m² HTP4 DP UNREG. 29.365 33' 7942 REAR FIRST FLOOR LOT 3 VACANT (A): EASEMENT TO DRAIN WATER 1.5 WIDE

//GARAGE

1.5%

3242

RL: 20.000 CUT 500

1500

SCALE: 1:200

7043

GARAGE

12.28%

7043

LOT 5

37'

-RETAINING WALL BY OWNER AFTER HANDOVER IF REQUIRED

238°

RL: 19.250 FILL 250

05

24m² (6m x 4m) PRINCIPAL

DRIVEWAY GRADIENT



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RAWSON HOMES

Builder's licence No. 33493C

BM 3 NAIL IN KERB RL 20.00 (ASSUMED)

BENCH MARK

1 HOMEBUSH BAY DRIVE, BLDG. F LEVEL 2, SUITE 1 **RHODES NSW 2138** TELEPHONE 02 8765 5500 FAX 02 8765 8099




CLIENT:

MR. T. HOLL & MS. K. J. NIELD	
SITE ADDRESS:	
LOT 4 (DP UNREG.)	
WARRIEWOOD ROAD	
WARRIEWOOD NSW 2102	


HOUSE TYPE		DRAWN BY:	DATE DRAWN:	CHECKED BY:	APPROVED FOR
MODEL:	EL: HUNTLEY 27	DD	12.11.18	QC	CONSTRUCTION:
FACADE:	MAJESTIC				
	DOUBLE GARAGE	COUNCIL AREA:		SCALE:	
		PITTWATER		1 : 200	
A008854		02	В		
		AUUUU	J T	02	ט

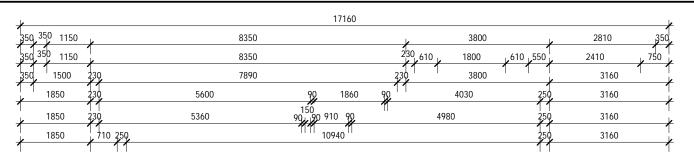
- WC DOORS TO BE FITTED WITH LIFT-OFF HINGES
- WINDOW OPENING SIZES TO BE CHECKED BEFORE FRAMES ARE CONSTRUCTED
- FRAMES & TRUSSES TO SATISFY AS 1684 SAA TIMBER FRAMING
- ROOF SPACE TO BE VENTILATED BY EAVE VENTS
- HEIGHT OF ALL SQ. SETS 2400mm FROM FFL UNLESS OTHERWISE SHOWN TO GROUND FLOOR
- HEIGHT OF ALL INTERNAL DOORS 2340mm FROM FFL TO **GROUND FLOOR**




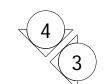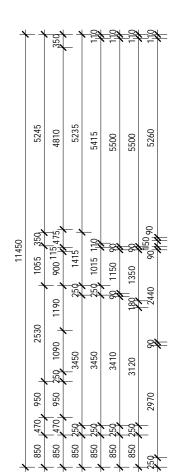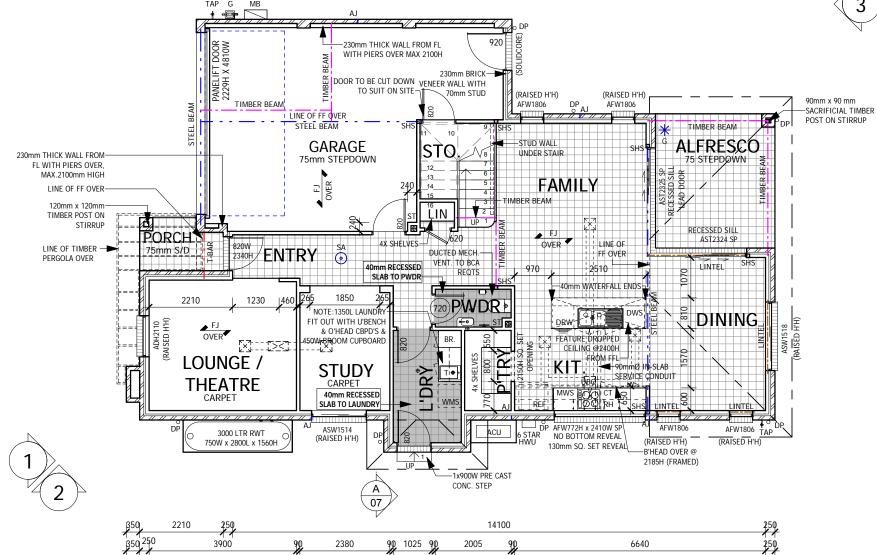NOTE: LOCATION OF GAS AND ELECTRICAL METERS TO BE DETERMINED BY CONTRACTOR ON SITE TO NEAREST POINT OF CONNECTION









1800

1800

2300

WARRIEWOOD NSW 2102

1050

900

1230 90 1010

2470

8050

8050

1310 [610 590]

#	#=	. [` [` [g50	-	
2550	2550	2500	2500	2475	1000	2500	
<i>**</i>			250	,	1150	g50,	_
2000				`	006	·	
1440 99 680 99 2	4300	4300		3575	2650	3200	50
1440			7000	250	1430		11.450
1000	000	760	F		14	~	
- **	- 24	60 120 60 120		4050	1810	4550	
2970	2120	2120				~	
25	520	520	250 600	0 250 REF	1310		
250	820	850	850 250 6	850	850	820	_

FLOOR AREAS

101.73 m²

102.81 m²

39.43 m²

2.83 m²

11.22 m²

GROUND FLOOR

FIRST FLOOR

GARAGE

PORCH

ALFRESCO

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3900

4550

6460

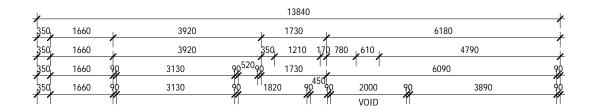
6460

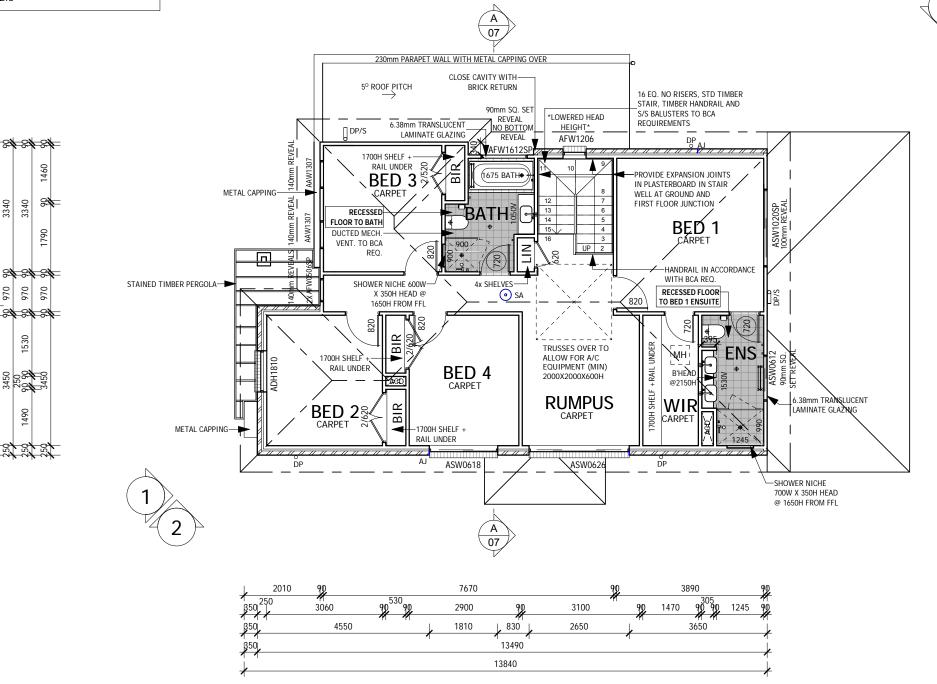
CLIENT:
MR. T. HOLL & MS. K. J. NIELD
SITE ADDRESS:
LOT 4 (DP UNREG.)
WARRIEWOOD ROAD

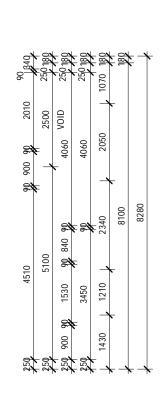
7		TOTAL		258.01 m ²	
HOUSE TYPE MODEL: HUNTLEY 27 FACADE: MAJESTIC TYPE: DOUBLE GARAGE SPECIFICATION: LUX	DRAWN BY: DD COUNCIL AREA PITTWAT		QC SCALE:	APPROVED FOR CONSTRUCTIO	
DRAWING TITLE: GROUND FLOOR	JOB No: A0088	54	DRWG No:	ISSUE:	

- WINDOW OPENING SIZES TO BE CHECKED BEFORE FRAMES ARE CONSTRUCTED.
- FRAMES & TRUSSES TO SATISFY AS 1684 SAA TIMBER FRAMING CODE
- ROOF SPACE TO BE VENTILATED BY EAVE VENTS
- HEIGHT OF ALL SQ. SETS 2150mm FROM FFL UNLESS OTHERWISE SHOWN TO FIRST FLOOR
- HEIGHT OF ALL INTERNAL DOORS 2040mm FROM FFL TO FIRST FLOOR

NOTE:RESTRICTORS TO BE FITTED TO ALL 1st FLOOR OPENABLE WINDOWS WITH A SILL HEIGHT LESS THAN 1.7m ABOVE FFL IN ACCORDANCE WITH BCA CLAUSE 3.9.2.5







2500

2000

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STAIR VOID

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MR. T. HOLL & MS. K. J. NIELD

SITE ADDRESS:


LOT 4 (DP UNREG.)

WARRIEWOOD ROAD

WARRIEWOOD NSW 2102

	HOUSE TYPE		DRAWN BY:	DATE DRAWN:	CHECKED BY:	APPROVED FOR
	MODEL:	HUNTLEY 27	DD	12.11.18	QC	CONSTRUCTION:
	FACADE:	MAJESTIC				
	TYPE:	DOUBLE GARAGE	COUNCIL ARE	A:	SCALE:	
	SPECIFICATION:		PITTWAT	ER	1 :	: 100
	DRAWING TITLE	:	JOB No:		DRWG No:	ISSUE:
FIRST FLOOR		A0088	54	04	В	

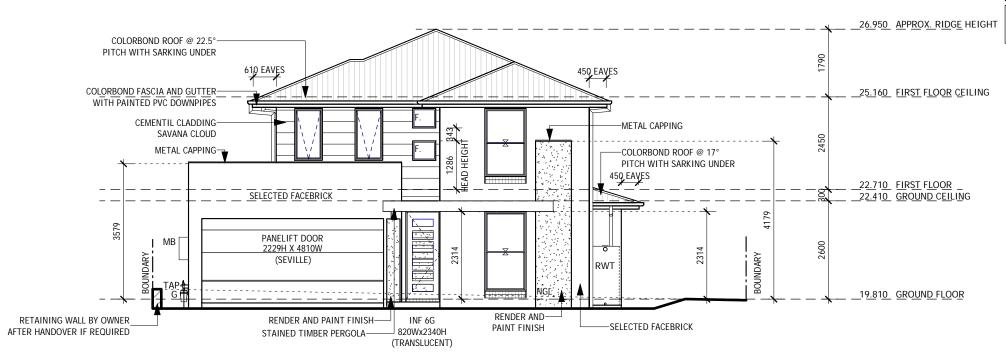NOTE: NYLON MESH FLYSCREENS TO ALL OPENING WINDOWS & STACKER DOORS (EXCLUDING HINGED DOORS)



ELEVATION 1



ELEVATION 2

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MR. T. HOLL & MS. K. J. NIELD SITE ADDRESS: LOT 4 (DP UNREG.) WARRIEWOOD ROAD WARRIEWOOD NSW 2102

	HOUSE TYPE MODEL: HUNTLEY 27 FACADE: MAJESTIC	DRAWN BY:	DATE DRAWN: 12.11.18	CHECKED BY: QC	APPROVED FOR CONSTRUCTION:
TYPE:	BOURLE OADAGE	COUNCIL AREA		SCALE:	: 100
DRAWING TITLE: ELEVATIONS 1-2		JOB No: A0088	54	DRWG No:	ISSUE:

NOTE: NYLON MESH FLYSCREENS TO ALL OPENING WINDOWS & STACKER DOORS (EXCLUDING HINGED DOORS)

CHECKED BY: APPROVED FOR

1:100

ISSUE:

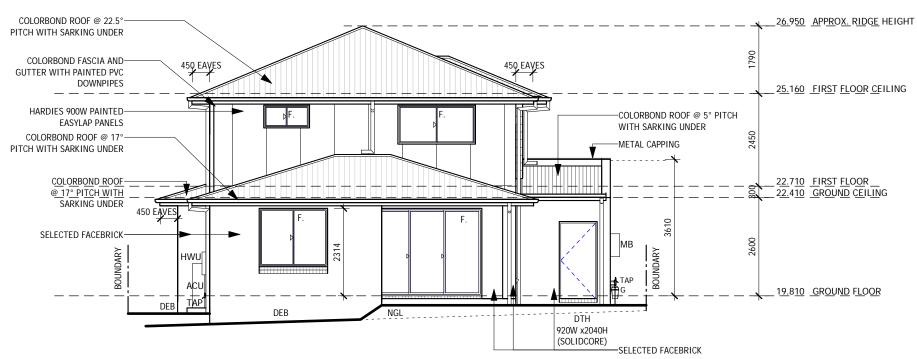
В

QC


DRWG No:

06

SCALE:



ELEVATION 3

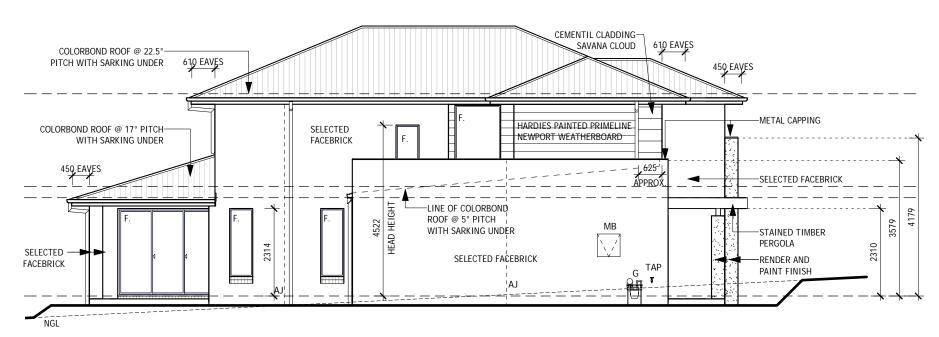

ELEVATION 4

NOTES

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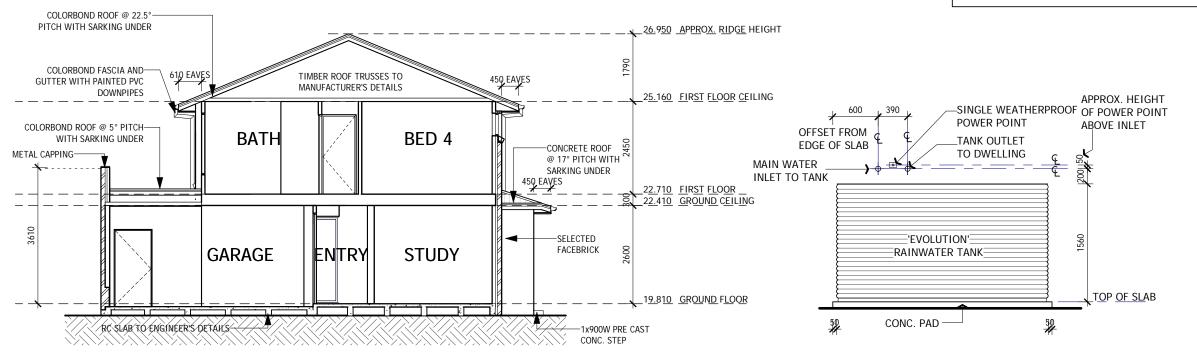
MR. T. HOLL & MS. K. J. NIELD

SITE ADDRESS:
LOT 4 (DP UNREG.)
WARRIEWOOD ROAD
WARRIEWOOD NSW 2102

HOUSE TYPE		DRAWN BY:	DATE DRAWN:
MODEL:	HUNTLEY 27	DD	12.11.18
FACADE: TYPE: SPECIFICATION	Majestic Double Garage : Lux	COUNCIL AREA	-
DRAWING TITLE		JOB No: A0088	54

- R2.5 THERMAL BATTS TO EXTERNAL WALLS INCLUDING INTERNAL WALL BETWEEN GARAGE & HOUSE (EXCLUDES EXTERNAL WALLS OF GARAGE).
- R4.1 THERMAL BATTS TO CEILINGS WITH ROOF OVER (EXCLUDING CEILINGS OVER GARAGE, PORCH, ALFRESCO).
- R2.0 INSULATION TO INTERNAL WALL AS INDICATED ON PLANS

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SECTION A-A

SCALE: 1:100

245 DEEP x 45 EDGE BEAM
BOLTED TO BRICKWORK

245 DEEP x 45 JOISTS BETWEEN

RAINWATER TANK DETAIL

SCALE: 1:50

PERGOLA DETAIL

SCALE: 1:50

eld 8	BASIX COMMITMENTS					
54 Ni	PROJECT DETAILS			STORMWATER	ENERGY	LIGHTING
088	Site area	393	m²	Rainwater tank to collect at least 172m ² of rain run off from roof area	ACTIVE COOLING/HEATING 3-phase	Applicant must provide a window or skylight for natural lighting to 2
S/A0	Roof area	172.0	m²	Rainwater tank to be connected to all toilets with in the development	Cooling system with day/night zoning for bedrooms & living areas with an EER 3.0 - 3.5	bathrooms/toilets
E E	number of bedrooms	4		Rainwater tank to be connected to cold water tap to supply water to the washing machine	Heating system with day/night zoning for bedrooms & living areas with an EER 3.5 - 4.0	COOKING (KITCHEN APPLIANCES)
0B I	Total area of vegetation (garden & lawn)	201	m²	Rainwater to be connected to at least one outdoor tap for garden watering	VENTILATION	Install a gas cooktop and electric oven
Q N	ABSA Certificate Number (if applicable)	0003442589		Rainwater to have a capacity of at least 3000L	At least 1 Bathroom: individual fan, ducted to façade or roof: manual switch on/off	DESIGN ENHANCEMENT
TS A	Net conditioned floor area	170	m²	WATER	Kitchen: individual fan, ducted to façade or roof: manual switch on/off	Install a fixed outdoor clothes drying line
RAC	Net Unconditioned floor area	5	m²	All showers with in the development are to have a minimum rating of 3 star showerheads	Laundry: natural ventilation only, or no laundry.	INSULATION
NO	Concession claimed (if applicable)	N/A		Each toilet is to have a flushing system of no less than a 4 star rating	HOT WATER	External wall [including garage]: R2.5
S/C	Cooling load (if applicable)	24	MJ/m²/pa	All basin taps to have a minimum rating of 3 star rating	Gas instantaneous with a performance of 6 stars	Ceiling [excluding garage & alfresco]: R4.1
Ĭ	Heating load (if applicable)	35	MJ/m²/pa	All taps in the kitchen are to have a minimum rating of 3 star		

NOTES

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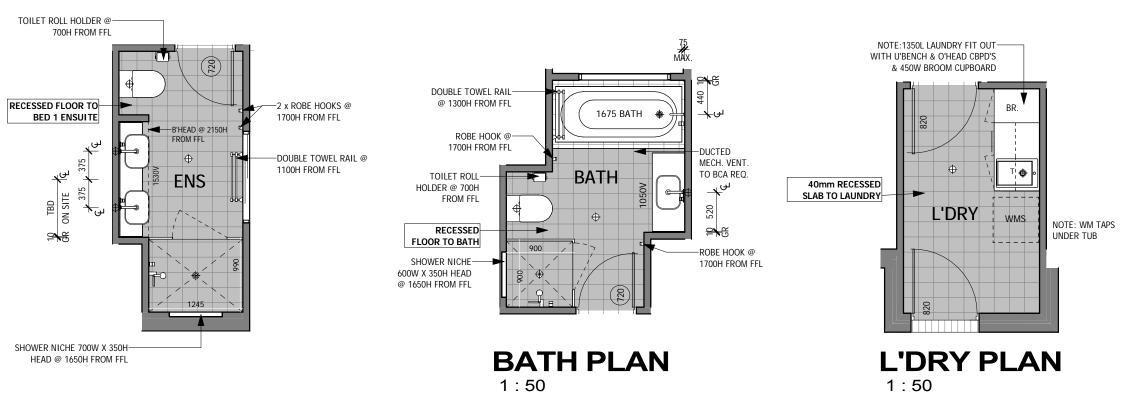
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MR. T. HOLL & MS. K. J. NIELD	
SITE ADDRESS:	
LOT 4 (DP UNREG.)	
WARRIEWOOD ROAD	
WARRIEWOOD NSW 2102	


CLIENT:

HOUSE TYPE	1	DRAWN BY:	DATE DRAWN:		APPROVED FOR
MODEL: HUNTLEY 27		DD	12.11.18	QC	CONSTRUCTION:
FACADE: MAJESTIC	<u> </u>				
TYPE: DOUBLE GARAGE	10	COUNCIL AREA:		SCALE:	
SPECIFICATION: LUX	F	PITTWATI	ER	As inc	dicated
DRAWING TITLE:	J	JOB No:		DRWG No:	ISSUE:
SECTIONS		A0088!	54	07	В
	MODEL: HUNTLEY 27 FACADE: MAJESTIC TYPE: DOUBLE GARAGE SPECIFICATION: LUX DRAWING TITLE:	MODEL: HUNTLEY 27 FACADE: MAJESTIC TYPE: DOUBLE GARAGE SPECIFICATION: LUX DRAWING TITLE:	MODEL: HUNTLEY 27 FACADE: MAJESTIC TYPE: DOUBLE GARAGE SPECIFICATION: LUX DRAWING TITLE: JOB No:	MODEL: HUNTLEY 27 FACADE: MAJESTIC TYPE: DOUBLE GARAGE SPECIFICATION: LUX DRAWING TITLE: DOD 12.11.18 COUNCIL AREA: PITTWATER JOB NO:	MODEL: HUNTLEY 27 FACADE: MAJESTIC TYPE: DOUBLE GARAGE SPECIFICATION: LUX DRAWING TITLE: DO 12.11.18 OC COUNCIL AREA: PITTWATER As inc. DRWG No: DRWG No:



BED 1 ENSUITE PLAN

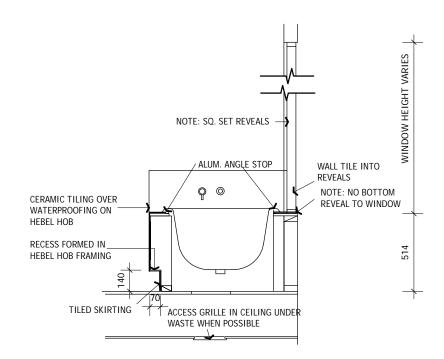1:50




BATH HOB DETAIL

SCALE: 1:25


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MIRROR EDGE DETAIL

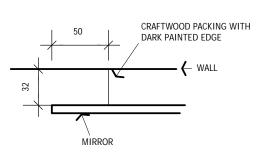SCALE: 1:25



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PROVIDE SKIRTING TILE TO PERIMETER

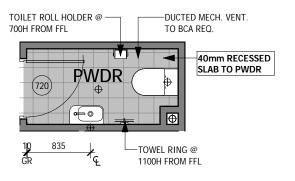• TILED SPLASHBACK OVER LAUNDRY TUB

• PROVIDE 2100 HIGH TILES TO SHOWER RECESS

• 1900H SHOWER HEAD FROM FFL TO UNDERSIDE

• 340H TILED SPLASHBACKS ABOVE VANITIES

WITH FLOATING MIRROR OVER ON 32mm

• PROVIDE KICKER TO BATH HOB 140H x 70W

• SMART FLOOR WASTE TO ALL WET AREAS

BOARD, 130mm FROM SIDE OF VANITY, MAX.

• WALL MOUNTED TAPS & SPOUT TO VANITIES &

500 OVER BATH & SKIRTING TILE TO PERIMETER

LAUNDRY / WC

BATHROOM

WALLS OF LAUNDRY

OF SHOWER HEAD

FLOATING VANITIES

HEIGHT 880mm

& BENCH @ 650mm HIGH

PWDR PLAN

1:50

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Builder's licence No. 33493C

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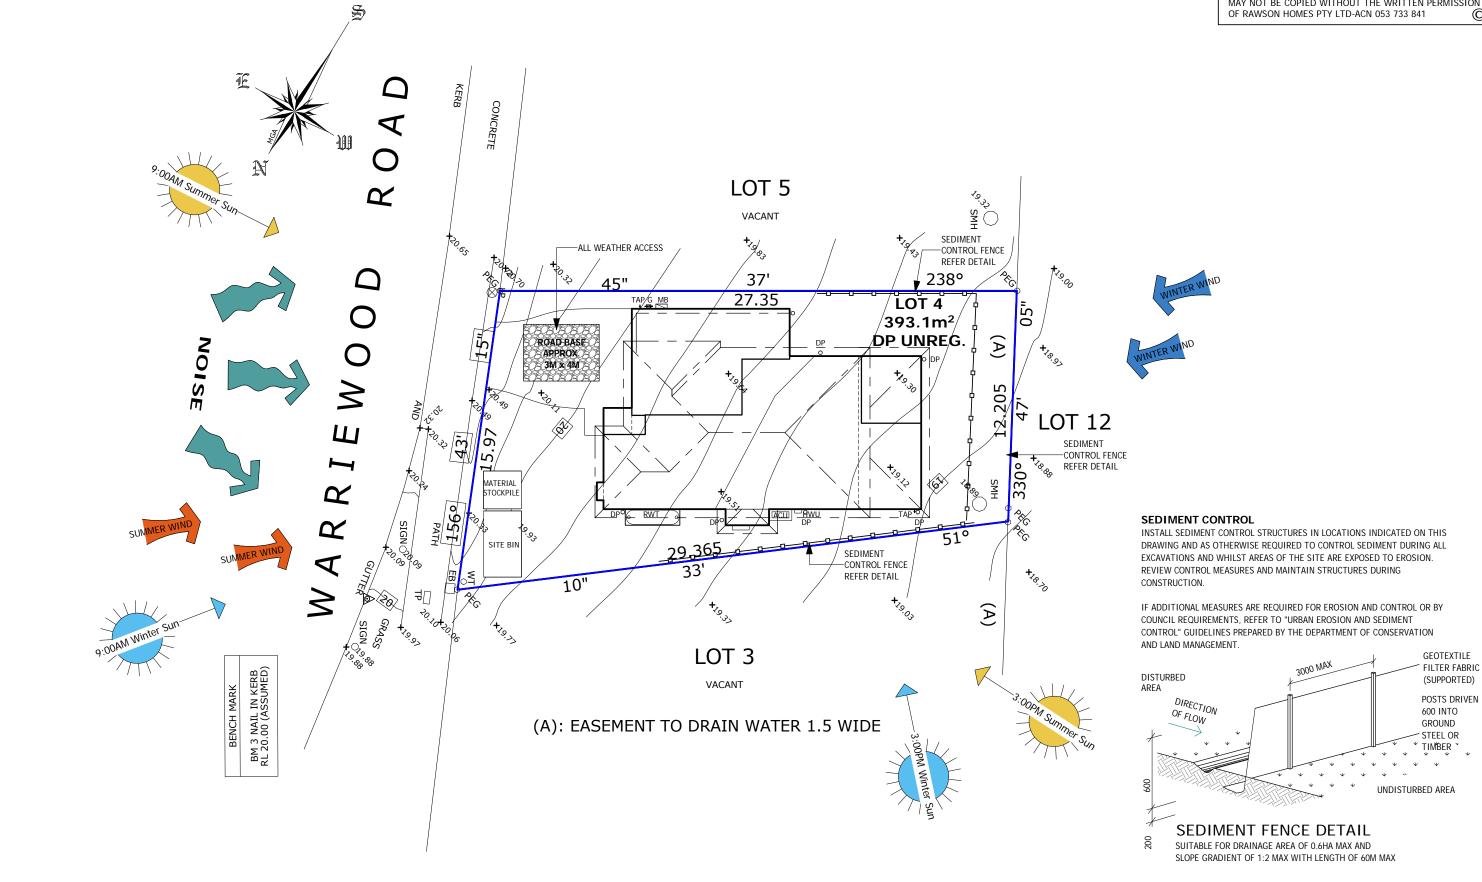


CLIENT:

MR. T. HOLL & MS. K. J. NIELD
SITE ADDRESS:
LOT 4 (DP UNREG.)
WARRIEWOOD BOAR

WARRIEWOOD ROAD WARRIEWOOD NSW 2102

HOUSE TYPE		DRAWN BY:	DATE DRAWN:		APPROVED FOR CONSTRUCTION:
MODEL:	HUNTLEY 27	DD	12.11.18	QC	CONSTRUCTION:
FACADE:	MAJESTIC				
TYPE:	DOUBLE GARAGE	COUNCIL AREA:		SCALE:	
= .		DITTIALATED			
SPECIFICATION: LUX		PITTWATER		As indicated	
DRAWING TITLE		JOB No:		DRWG No:	ISSUE:
					_
WET AREA DETAILS		8800A	54	- 80	В
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SITE ADDRESS:

LOT 4 (DP UNREG.) WARRIEWOOD ROAD WARRIEWOOD NSW 2102

HOUSE TYPE	
MODEL:	HUNTLEY 27
FACADE:	MAJESTIC
TYPE:	DOUBLE GARAG

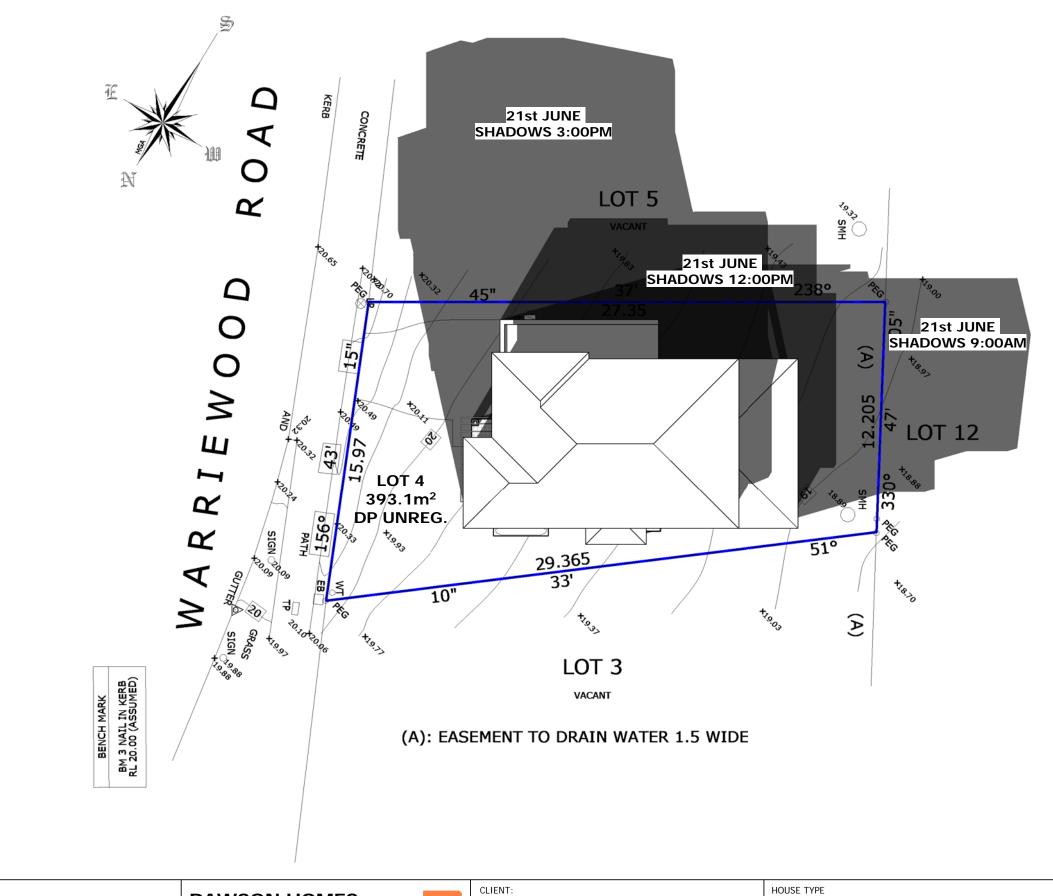
SPECIFICATION: LUX

SITE ANALYSIS & SEDIMENT PLAN

DRAWN BY: DATE DRAWN: CHECKED BY: APPROVED FOR DD 12.11.18 COUNCIL AREA: SCALE: **PITTWATER** 1:200 ISSUE:

DRWG No: A008854

10



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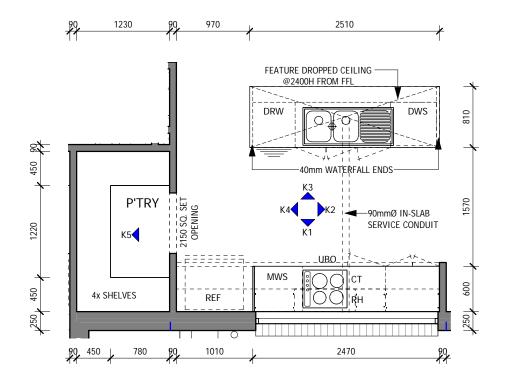
MR. T. HOLL & MS. K. J. NIELD
SITE ADDRESS:
LOT 4 (DP UNREG.)
WARRIEWOOD ROAD
WARRIEWOOD NSW 2102


HOUSE TYPE	
MODEL:	HUNTLEY 27
FACADE:	MAJESTIC
TYPE:	DOUBLE GARAGI
	1.1177


SHADOW DIAGRAMS

ODEL:	HUNTLEY 27
ACADE:	MAJESTIC
YPE:	DOUBLE GARAGE
PECIFICATION:	LUX

DRAWN BY:	DATE DRAWN:	CHECKED BY:	APPROVED FOR CONSTRUCTION:	
DD	12.11.18	QC		
COUNCIL AREA:		SCALE:		
PITTWATER		1 : 200		
JOB No:		DRWG No:	ISSUE:	
A008854		11	В	



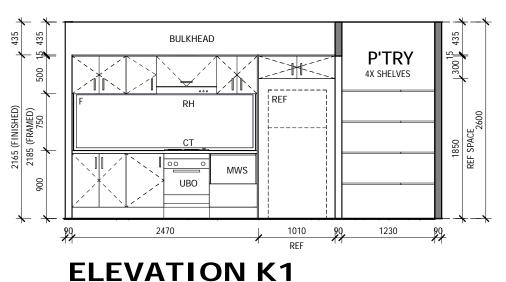

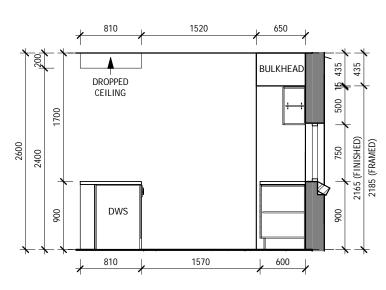



ELEVATION K2

SCALE: 1:50

KITCHEN PLAN

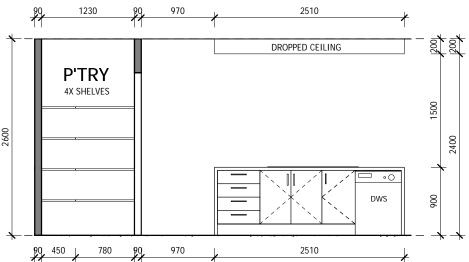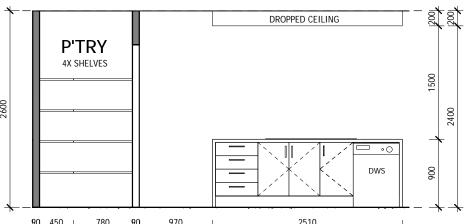
SCALE: 1:50






ELEVATION K3

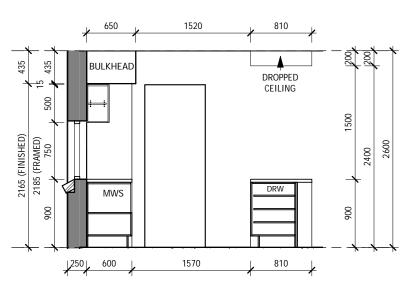SCALE: 1:50



ELEVATION K4

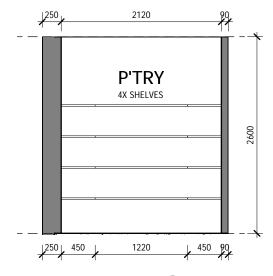SCALE: 1:50



ELEVATION K5

SCALE: 1:50

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CLIENT:

SCALE: 1:50

MR. T. HOLL &	MS. K. J. NIELD
---------------	-----------------

SITE ADDRESS: LOT 4 (DP UNREG.) WARRIEWOOD ROAD WARRIEWOOD NSW 2102

	HOUSE TYPE		DRAWN BY:	DATE DRAWN:	CHECKED BY:	APPROVED FOR
	MODEL:	HUNTLEY 27	DD	12.11.18	QC	CONSTRUCTION:
	FACADE:	MAJESTIC				
	TYPE:	DOUBLE GARAGE	COUNCIL AREA:		SCALE:	
SPECIFICATION: LUX		PITTWATER		1 : 50		
	DRAWING TITLE	:	JOB No:		DRWG No:	ISSUE:
KITCHEN DETAILS		A008854		KD	В	