

ACTION PLANS

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DEVELOPMENT APPLICATION

These plans are for Council Approval only.

NO.	DRAWING NAME
DA00	COVER
DA01	NOTATION / SAFETY NOTES
DA02	SITE ANALYSIS
DA03	SITE / ROOF / SEDIMENT EROSION / WASTE MANAGEMENT / STORMWATER CONCEPT PLAN
DA04	EXISTING LOWER GROUND FLOOR PLAN - DEMOLITION
DA05	EXISTING GROUND FLOOR PLAN - DEMOLITION
DA06	PROPOSED LOWER GROUND FLOOR PLAN
DA07	PROPOSED GROUND FLOOR PLAN
DA08	PROPOSED FIRST FLOOR PLAN
DA09	NORTH / EAST ELEVATION - (SIDE / REAR)
DA10	SOUTH / WEST ELEVATION - (PRIMARY / SIDE)
DA11	LONG / CROSS SECTION
DA12	AREA CALCULATIONS / SAMPLE BOARD
DA13	WINTER SOLSTICE 9 AM
DA14	WINTER SOLSTICE 12 PM
DA15	WINTER SOLSTICE 3 PM
DA16	BASIX COMMITMENTS

ITEM DETAILS	DEVELOPMENT APPLICATION							
ADDRESS	32 TIPPERARY AVENUE, KILLARNEY I	HEIGHTS, NSW 2086						
LOT & DP/SP	LOT 491 DP 218045							
COUNCIL	NORTHERN BEACHS COUNCIL (WAR	RINGAH)						
SITE AREA	697.7m ²							
FRONTAGE	24.585m							
CONTROLS	PERMISSIBLE / REQUIRED	EXISTING	PROPOSED	COMPLIANCE				
	m / m² / %	m / m² / %	m / m² / %					
<u>LEP</u>								
LAND ZONING	R2 – LOW DENSITY RESIDENTIAL	R2	R2	YES				
MINIMUM LOT SIZE	600m²	697.7m ²	UNCHANGED	YES				
MAXIMUM BUILDING HEIGHT	8.5m	3.68m	9.268m	NO				
<u>HAZARDS</u>								
DEVELOPMENT ON SLOPING	LANDSLIP RISK MAP - AREA B	N/A	N/A	N/A				
LAND	ENTROCE MORNING THEAT	14// (14/73	10/2				
<u>DCP</u>								
WALL HEIGHT	7.2m	7.261m	6.878m	YES				
NUMBER OF STOREYS	2	3	UNCHANGED	NO				
SIDE BOUNDARY ENVELOPE	4m	-	-	YES				
SIDE BOUNDARY SETBACKS	0.9m	N: 0.91m	N: 0.91m	YES				
	******	S: 2.35m	S: 0.9m	1,7=4				
FRONT BOUNDARY SETBACK	6.5m	10.69m	UNCHANGED	YES				
REAR BOUNDARY SETBACK	6.0m	19.279m	14.778m	YES				
LANDSCAPE OPEN SPACE	40% (279.08m²)	38%	41%	YES				
	,	(263.82m²)	(285.47m²)					
PRIVATE OPEN SPACE	60m²	51.45m²	60m²	YES				

32 TIPPERARY AVENUE, KILLARNEY HEIGHTS NSW 2087



NCC & AS COMPLIANCES SPECIFICATIONS

- EARTHWORKS PART 3.1.1 OF NCC
- EARTH RETAINING STRUCTURES PART 3.1.2 OF NCC
- DRAINAGE PART 3.1.3 OF NCC
- TERMITE-RISK MANAGEMENT PART 3.1.4 OF NCC
- FOOTINGS & SLAB PART 3.2 OF NCC INCLUDING AS 2870-2011
- MASONRY PART 3.3 OF NCC INCLUDING AS 3700:2018
- FRAMING PART 3.4 OF NCC
- SUB FLOOR VENTILATION PART 3.4.1 OF NCC
- ROOF CLADDING AND WALL-CLADDING PART 3.5 OF NCC
- GLAZING PART 3.6 OF NCC INCLUDING AS 1288
- FIRE SAFETY PART 3.7 OF NCC
- FIRE SEPARATION OF EXTERNAL WALLS PART 3.7.2 OF NCC
- FIRE PROTECTION OF SEPARATING WALLS AND FLOORS- PART 3.7.3 OF NCC - SMOKE ALARMS - PART 3.7.5 OF NCC
- WET AREAS AND EXTERNAL WATERPROOFING PART 3.8.1 OF NCC
- ROOM HEIGHTS PART 3.8.2 OF NCC
- FACILITIES PART 3.8.3 OF NCC
- LIGHT PART 3.8.4 OF NCC
- VENTILATION PART 3.8.5 OF NCC
- SOUND INSULATION PART 3.8.6 OF NCC
- STAIRWAYAND RAMP CONSTRUCTION PART 3.9.1 OF NCC
- BARRIERS AND HANDRAILS PART 3.9.2 OF NCC
- SWIMMING POOLS PART 3.10.1 OF NCC
- CONSTRUCTION IN BUSHFIRE PRONE AREAS PART 3.10.5 OF NCC
- FENCING & OTHER PROVISIONS REGS & AS1926.1 2012 - DEMOLITION WORKS - AS2601-2001 THE DEMOLITION OF STRUCTURES.
- WATERPROOFING OF WET AREAS TO COMPLY WITH AS 3740-2010
- ALL PLUMBING & DRAINAGE WORK TO COMPLY WITH AS 3500:2018
- ALL PLASTERBOARD WORK TO COMPLY WITH AS 2588:2018
- ALL STRUCTURAL STEEL WORK TO COMPLY WITH AS 4100-1992 & AS 1554
- ALL CONCRETE WORK TO COMPLY WITH AS 3600:2018 - ALL ROOF SHEETING WORK TO COMPLY WITH AS 1562.1-2018
- ALL SKYLIGHTS TO COMPLY WITH AS 4285-2019
- ALL CERAMIC TILING TO COMPLY WITH AS 3958.1-2007 & 3958.2-1992
- ALL GLAZING ASSEMBLIES TO COMPLY WITH AS 2047-2014 & 1288 - ALL TIMBER RETAINING WALLS ARE TO COMPLY WITH AS 1720.1-2010,
- AS 1720.2-2006, AS 1720.4-2006, AS 1170.1-2002 & AS 1170.4-2007
- ALL RETAINING WALLS ARE TO COMPLY WITH 3700:2018 & AS 3600:2018 - ALL CONSTRUCTION TO COMPLY WITH AS 3959:2018

IMPORTANT NOTATION FOR BUILDERS

- All dimensions are to be confirmed on-site by the builder/subcontractor, any incongruencies must be reported to the Designer in writing before the commencement of any work.
- No Survey has been made on the boundaries, all bearings, distances, and areas have been taken from the contour survey plan. A Survey must be carried out to confirm the exact boundary locations
- No construction work shall commence until a site survey confirming the site boundaries has been completed. The contractor is to ensure that the approved boundary setbacks are confirmed and used, the boundary setbacks take precedence over all other dimensions. The Survey work must be performed by a
- In the event of encountering any discrepancies on these drawings, specification, or subsequent instructions issued, the Builder/Subcontractor shall contact the designer in writing before proceeding further
- The builder/subcontractor is responsible to ensure that all materials installed on-site are fit for purpose and comply with the NCC and relevant Australian standards. The builder is to get written confirmation of material selection by the client prior to ordering
- All construction, control joints, and expansion joints in the wall, floors, other locations shall be in strict accordance with the Structural Engineering details. No joints or breaks other than specified are allowed without written permission from the Engineer.
- Measurements for the fabrication of secondary components such as windows, doors, internal frames, structural steel components, and the like, are not to be taken from these documents. Measurements must be taken on-site to suit the work as constructed.
- All structural components shall be in strict accordance with details and specifications as prepared by a structural engineer
- All existing structures need to be examined for structural adequacy, and it is the Contractor's responsibility to ensure that a certificate of structural adequacy is available prior to the start of any work.

SPECIFICATION

- "Approval" obtained by either an 'Accredited Certifying Authority' or 'Local Council'.
- The Owner will directly pay all fees associated with the following:
- Building approval from council or accredited certifier, any footpath and kerb deposits with the local council, insurance fees to Building Services Corporation, Long Service Leave levy fees and approval fees by water
- sewerage authority. All other fees are to be paid by the builder. The amount of any local authority deposits which are forfeited due to damage or other causes, will be deducted from payments due to the builder. -The Builder is to provide at his/her own expense adequate Public Risk Insurance and arrange indemnification under the Workers Compensation Act. Works insurance to be as stated in the contract conditions.
- All tenderers are to visit the site to satisfy themselves as to the nature and extent of the Works, facilities available and difficulties entailed in the works as Variations will not be allowed due to work arising owing to neglect of this clause.
- These drawings shall be read in conjunction with all structural and other consultant's drawings and specifications and with any such written instructions as may be issued during the course of the contract. - Set out dimensions shown on this drawing shall be verified by the builder on site before commencement of any work. Dimensions shall not be obtained by scaling the drawings. Use only figured dimensions. All dimensions are in millimetres.
- The Builder is to ensure all construction, levels and other items comply with the conditions ofthe Building Approval.
- Any detailing in addition to what is supplied shall be resolved between the Owner and the Builder to the Owner's approval, except for any structural details or design which is to be supplied by the Engineer. - All work to be carried out in a tradesman like manner and in accordance with the standards, codes and regulations of the Standards Association of Australia, National construction Code of Australia and any statutory authority having jurisdiction over the works.
- All structural work is to be in accordance with the structural details prepared by a suitably qualified structural engineer. Including but not limited to all piers, footings, concrete slabs, retaining walls, steelworks, formwork, underpinning, additional structural loads, timber framing, wind bracing and associated connections. Builder to obtain, prior to finalising the tender unless previously obtained by owners.
- All brickwork is to be selected by owner and is to comply with AS 1640. All masonry is to comply with AS
- Provide all metalwork and flashings necessary to satisfactorily complete the works.
- All timber construction to be in accordance with AS 1684 "Timber Framing Code". Level & Grade where necessary under timber floors to provide a minimum clearance of 300mm under bearers or 400mm under joists. Adequate precautions shall be taken to ensure that the surface &/or seepage water does not collect or remain under floor area.
- Sustainable timbers and not rainforest or old growth timber will be use. Recycled timber or second hand
- timbers are to be sourced and used in preference to plantation timbers, if available and suitable. - All glazing installed is to comply with AS 1288, 2047 and in accordance with manufacturers recommendations.
- All wall and ceiling linings to be plasterboard and villaboard or equal in wet areas. A breathable wall wrap is to be provided to all external walls. Timber cladding is to be battened out from timber frame to provide an 'air' gap to prevent condensation. Workmanship is to comply with the relevant Australian Standards or installed In accordance with manufacturer's specification. All bathrooms and wet areas to be waterproofed with a flexible membrane to manufacturer's specification and to AS 3740 and Part 3.8.1 of the Building Code of Australia Housing Provisions.
- All Architraves and skirtings to the profile as selected by owner, and painted or stain finish as selected. - All plumbing and drainage work to be installed and completed by a licensed tradesman and in accordance
- with the statutory body having authority over the works. Connect all waste to Sydney Water sewer line. - Connect all stormwater to existing system or street drainage system in accordance with AS 3500 and part 3.1.2 Drainage of the Building Code of Australia Housing Provisions.
- Smoke detector alarms to be installed in accordance with AS3786 and the Building Code of Australia/
- If a member which provides structural support to the work is subject to attack by Termites protection measures are to comply with AS3660 and be installed to manufacturer's specification.
- Stairs and Balustrades to comply with part 3.9.1 & 3.9.2 of the Building Code of Australia Housing Provisions. Provide a handrail along the full length of the flight and a slip resistant finish to the edge of the nosings to comply with 3.9.1 and 3.9.2 of the NCC. No horizontal elements to facilitate climbing between
- 150mm and 760mm where floor to level below in more than 4m. - Electrical works to be in accordance with SAA wiring rules and be done by a licenced tradesperson.
- Obtain electrical layout prior to proceeding. All electrical power (GPO's) and light outlets to be determined - Painting: All paints or other coatings shall be of the best quality materials & of approved manufacture. All
- used. External joinery intended to be painted shall be primed on all faces at the place of assembly. Where new work or alteration work adjoins existing painted surfaces allow for repainting existing surfaces to provide uniform appearance
- ZERO-VOC or LOW-VOC paints and primers only are to be used.
- Any work indicated on the plans but not specified and any item not shown on the plans which is obviously necessary as part of proper construction and/or finish, is to be considered as shown and specified and is to
- undertaken at the Builder's expense.
- Variations will not be permitted without prior written approval by the owners. - The Builder shall provide sediment and siltration control measures as required by Council and maintain them throughout the duration of the works.
- A legible copy of the plans bearing approval stamps, must be maintained on the job site at all times.
- Hours of construction shall be restricted to the times as required by the building approval - The Builder is to arrange for all inspections required by the relevant authorities and/or lending institutions, to their requirements.
- The Builder is to obtain approval for interruptions to existing services and minimise the duration and number ofinterruptions. Any interruptions to existing services and equipment is to be undertaken by appropriately qualified tradespersons.
- The Builder shall restore, reinstate or replace any damage to existing structures or landscaping caused by the construction works or workmen.
- Provide protection to existing trees to remain, or as required by the Approval Conditions.

THIS SET OF DRAWING SHOULD BE READ & KEPT IN ITS ENTIRETY. NO INDIVIDUAL PAGE SHOULD BE SEPARATED FROM THE REST OF THE SET. EACH NOTATION LISTED ON THIS PAGE APPLY TO ALL PAGES OF THIS SET.

GENERAL NOTATION

- Approved means by the 'relevant local authority' or council
- The owner will directly pay the fees associated with the following:
- building approval from council, footpath and kerb deposits with the local council, insurance fee to building services corporation, long service leave service levy fee and approval fee by water and sewerage authority. all other fees are to be paid by the builder the amount of any local authority deposits which are forfeited due to damage or other cause will be deducted from the payments due to the builder
- The builder is to provide at his/her own expense adequate public risk insurance and arrange indemnification under the workers compensation act. works insurance to be stated in the contract conditions
- All work to be carried out in a tradesmen like manner and in accordance with the standards codes and regulations of the standards association of Australia, building code of Australia and any statutory authority having jurisdiction over the work
- All tenderers are to visit the site to satisfy themselves as to the nature and extent of the works, facilities available and difficulties entailed in the works as variations will not be allowed due to work arising owing to neglect of this clause.
- All work and materials to comply with the current Australian standards at the time of commencement were applicable.
- These drawings shall be read in conjunction with all structural and other consultants drawings and specifications and with any such written instructions as may be issued during the course of the contract. Set out dimensions shown on this drawing shall be verified by the builder on site before commencement of any work, dimensions should not be obtained by scaling the drawings, use only figured dimensions, all dimensions are in millimetres.
- The builder is to ensure all construction, levels and other items comply with the conditions of the building
- The builder is to comply with all ordinances, local authority regulations and the requirements of all services supply authorities having jurisdiction over the works.
- All plumbing and drainage work to be installed and completed by a licenced tradesman and in accordance with the statutory body having authority over the works. connect all waste to Sydney water sewer line
- All new downpipes are to be connected to the existing storm water system.
- All power and stormwater outlet locations shall be determined onsite by the owner. - Smoke detector alarm to be installed in accordance with as3786 and the building code of Australia.
- Electrical work to be in accordance with SAA wiring rules and be done by a licenced tradesman - Any detailing in addition to what is supplied shall be resolved between the owner and the builder to the
- owner's approval, except for any structural details or design which is supplied by the engineer. - All timber sizes and concrete details to be confirmed by the builder prior to commencement of any work. - All structural work is to be in accordance with the structural details prepared by a structural engineer(i.e.) piers, footings, concrete slabs, retaining walls, steelwork, formwork, underpinning, additional structural loads, timber framing, wind bracing and associated connections. builder to obtain prior to finalising tender - Any work indicated on the plans but not specified, and any item not shown on the plan which is obviously
- necessary as a part of construction and/or finish is to be considered as shown and specified, and is to be done as part of the contract. variations will not be permitted without the written consent of the owner. - The builder shall provide sediment and siltration control measures as required by council and maintain
- them through the duration of the works. - A legible copy of the plans bearing approval stamps must be maintained on the job at all times. hours of construction will be restricted to the times as required by the building approval.
- The builder is to arrange for all inspections required by the authorities and lending institutions to their requirements
- The builder is to obtain approval for interruptions to existing services and minimise the duration and number of interruptions. any interruptions with existing services and equipment to be attended to by the
- The builder shall restore, reinstate or replace any damage caused to existing structures or landscaping by construction work or workmen. provide protection to existing trees to remain as required by approval
- All brickwork is to be selected by owner and is to comply with as1640
- All masonry to comply with as3700
- All metalwork and flashing items necessary to satisfactory complete work shall be provided.
- All gutters, downpipes to be colorbond.
- All timber construction to be in accordance with the Australian standard 1684 "timber framing code"
- All glazing installed to comply with as1288, 2047 and in accordance with manufacturers recommendation
- All wall and ceiling linings to be plasterboard or cement render as selected and villa board in wet areas, to comply with the relevant Australian standards or installed in accordance with manufacturers specification.
- All bathrooms and wet areas to be adequately waterproofed to manufacturers speciation and as3740 and part 3.8.1 of the building code of Australia housing provisions Stairs and balustrades to comply with part 3.9.1 & 3.9.2 of the building code of Australia housing
- Termite protection measures to comply with as 3660 and be installed to manufacturers specification. - Any detailing additional to that supplied, shall be resolved between the owner and the builder to the owners approval. except for any structural details or design which is to be supplied by the structural

NCC & AS COMPLIANCE SPECIFICATIONS

- Earthworks part 3.1.1 of NCC
- Earth retaining structures part 3.1.2 of NCC
- Drainage part 3.1.3 of NCC
- Termite-risk management part 3.1.4 of NCC
- Footings & slab part 3.2 of NCC including as 2870-2011
- Masonry part 3.3 of ncc including as 3700:2018
- Framing part 3.4 of NCC - Sub floor ventilation - part 3.4.1 of NCC
- Roof cladding and wall-cladding part 3.5 of NCC
- Glazing part 3.6 of NCC including as 1288
- Fire safety part 3.7 of NCC
- Fire separation of external walls part 3.7.2 of NCC
- Fire protection of separating walls and floors- part 3.7.3 of NCC - Smoke alarms - part 3.7.5 of NCC
- Wet areas and external waterproofing part 3.8.1 of NCC
- Room heights part 3.8.2 of NCC - Facilities - part 3.8.3 of NCC
- Light part 3.8.4 of NCC
- Ventilation part 3.8.5 of NCC
- ition part 3.8.6 of NCC Sound insul
- Stairway and ramp construction part 3.9.1 of NCC Barriers and handrails - part 3.9.2 of NCC
- Swimming pools part 3.10.1 of NCC
- Construction in bushfire prone areas part 3.10.5 of NCC - Fencing & other provisions - regs & AS 1926.1 2012
- Demolition works AS 2601-2001 the demolition of structures.
- Waterproofing of wet areas to comply with AS 3740-2010 - All plumbing & drainage work to comply with AS 3500:2018
- All plasterboard work to comply with AS 2588:2018
- All structural steel work to comply with AS 4100-1992 & AS 1554
- All concrete work to comply with AS 3600:2018
- All roof sheeting work to comply with AS 1562.1-2018 - All skylights to comply with AS 4285-2019
- All ceramic tiling to comply with AS 3958.1-2007 & 3958.2-1992 - All glazing assemblies to comply with AS 2047-2014 & 1288
- All timber retaining walls are to comply with AS 1720.1-2010.
- AS 1720.2-2006, AS 1720.4-2006, AS 1170.1-2002 & AS 1170.4-2007 - All retaining walls are to comply with 3700:2018 & AS 3600:2018
- All construction to comply with AS 3959:2018

SAFTEY NOTES

THESE NOTES MUST BE READ AND UNDERSTOOD BY ALL INVOLVED IN THE PROJECT. THIS INCLUDES (but is not excluded to): OWNER, BUILDER, SUB-CONTRACTORS, CONSULTANTS, RENOVATORS, OPERATORS, MAINTENORS, DEMOLISHERS.

1. FALLS, SLIPS, TRIPS

a) WORKING AT HEIGHTS

DURING CONSTRUCTION

Wherever possible, components for this building should be prefabricated off-site or at ground level to minimise the risk of workers falling more than two metres. However, construction of this building will require workers to be working at heights where a fall in excess of two metres is possible and injury is likely to result from such a fall. The builder should provide a suitable barrier wherever a person is required to work in a situation where falling more than two metres is a possibility.

DURING OPERATION OR MAINTENANCE

For houses or other low-rise buildings where scaffolding is appropriate: Cleaning and maintenance of windows, walls, roof or other components of this building will require persons to be situated where a fall from a height in excess of two metres is possible. Where this type of activity is required, scaffolding, ladders or trestles should be used in accordance with relevant codes of practice, regulations or legislation. For buildings where scaffold, ladders, trestles are not appropriate: Cleaning and maintenance of windows, walls, roof or other components of this building will require persons to be situated where a fall from a height in excess of two metres is possible. Where this type of activity is required, scaffolding, fall barriers or Personal Protective Equipment (PPE) should be used in accordance with relevant codes of practice, regulations or legislation.

b) SLIPPERY OR UNEVEN SURFACES

FLOOR FINISHES Specified

If finishes have been specified by designer, these have been selected to minimise the risk of floors and paved areas becoming slippery when wet or when walked on with wet shoes/ feet. Any changes to the specified finish should be made in consultation with the designer or, if this is not practical, surfaces with an equivalent or better slip resistance should be chosen.

FLOOR FINISHES By Owner If designer has not been involved in the selection of surface finishes. the owner is responsible for the selection of surface finishes in the pedestrian trafficable areas of this building. Surfaces should be selected in accordance with AS HB 197:1999 and AS/ NZ 4586:2004.

STEPS, LOOSE OBJECTS AND UNEVEN SURFACES

Due to design restrictions for this building, steps and/ or ramps are included in the building which may be a hazard to workers carrying objects or otherwise occupied. Steps should be clearly marked with both visual and tactile warning during construction, maintenance, demolition and at all times when the building operates as a workplace. Building owners and occupiers should monitor the pedestrian access ways and in particular access to areas where maintenance is routinely carried out to ensure that surfaces have not moved or cracked so that they become uneven and present a trip hazard. Spills, loose material, stray objects or any other matter that may cause a slip or trip hazard should be cleaned or removed from access ways. Contractors should be required to maintain a tidy work site during construction, maintenance or demolition to reduce the risk of trips and falls in the workplace. Materials for construction or maintenance should be stored in designated areas away from access ways and work areas.

2. FALLING OBJECTS

LOOSE MATERIALS OR SMALL OBJECTS

Construction, maintenance or demolition work on or around this building is likely to involve persons working above ground level or above floor levels. Where this occurs one or more of the following measures should be token to ovoid objects falling from the area where the work is being carried out onto persons below.

- 1. Prevent or restrict access to areas below where the work is being carried out.
- 2. Provide toeboards to scaffolding or work platforms 3. Provide protective structure below the work area. 4. Ensure that all persons below the work area have Personal

Protective Equipment (PPE).

BUILDING COMPONENTS During construction, renovation or demolition of this building, parts of the structure including fabricated steelwork, heavy panels and many other components will remain standing prior to or after supporting parts are in place. Contractors should ensure that temporary bracing or other required support is in place at all times when collapse which may injure persons in the area is a possibility. Mechanical lifting of materials and components during construction, maintenance or demolition presents a risk of falling objects. Contractors should ensure that appropriate lifting devices are used, that loads are properly secured and that access to areas below the load is prevented or restricted.

3. TRAFFIC MANAGEMENT

For building on a major road, narrow road or steeply sloping road: Parking of vehicles or loading/ unloading of vehicles on this roadway may cause a traffic hazard. During construction, maintenance or demolition of this building designated parking for workers and loading areas should be provided. Trained traffic management personnel should be responsible for the supervision of these areas. For building where onsite loading/ unloading is restricted: Construction of this building will require loading and unloading of materials on the roadway. Deliveries should be well planned to ovoid congestion of loading areas and trained traffic management personnel should be used to supervise loading/ unloading areas. For all buildings: Busy construction and demolition sites present a risk of collision where deliveries and other traffic are moving within the site. A traffic management plan supervised by trained traffic management personnel should be adopted for the work site.

4. SERVICES

Rupture of services during excavation or other activity creates a variety of risks including release of hazardous material. Existing services are located on or around this site. Where known, these ore identified on the plans but the excel location and extent of services may vary from that indicated. Services should be located using on appropriate service (such as Dial Before You Dig), appropriate excavation practice should be used and, where necessary, specialist contractors should be used. Locations with underground power: Underground power lines MAY be located in or around this site. All underground power lines must be disconnected or carefully located and adequate warning signs used prior to any construction, maintenance or demolition commencing. Locations with overhead power lines: Overhead power lines MAY be near or on this site. These pose a risk of electrocution if struck or approached by lifting devices or other plant and persons working above ground level. Where there is a danger of this occurring, power lines should be, where practical, disconnected or relocated. Where this is not practical adequate warning in the form of bright coloured tape or signage should be used or a protective barrier provided.

5. MANUAL TASKS

Components within this design with a moss in excess of 25kg should be lifted by two or more workers or by mechanical lifting device. Where this is not practical, suppliers or fabricators should be required to limit the component mass. All material packaging, building and maintenance components should clearly show the total moss of packages and where practical all items should be stored on site in a way which minimises bending before lifting. Advice should be provided on safe lifting methods in all areas where lifting may occur. Construction, maintenance and demolition of this building will require the use of portable tools and equipment. These should be fully maintained in accordance with manufacturer's specifications and not used where faulty or (in the case of electrical equipment) not carrying a current electrical safety tag. All safety guards or devices should be regularly checked and Personal Protective Equipment should be used in accordance with manufacturer's specification.

6. HAZARDOUS SUBSTANCES

ASBESTOS

For alterations to a building constructed prior to 1990:

If this existing building was constructed prior to:

1990 - it therefore may contain asbestos

1986 - it therefore is likely to contain asbestos either in cladding material or in fire retardant insulation material. In either case, the builder should check and, if necessary, take appropriate action before demolishing, culling, sanding, drilling or otherwise disturbing the existing structure.

POWDERED MATERIALS Many materials used in the construction of this building con cause harm if inhaled in powdered form. Persons working on or in the building during construction, operational maintenance or demolition should ensure good ventilation and wear Personal Protective Equipment including protection against inhalation while using powdered material or when sanding, drilling, cutting or otherwise disturbing or creating

The design of this building may include provision for the inclusion of treated limber within the structure. Dust or fumes from this material can be harmful. Persons working on or in the building during construction, operational maintenance or demolition should ensure good ventilation and wear Personal Protective Equipment including protection against inhalation of harmful material when sanding, drilling, cutting or using treated timber in any way that may cause harmful material lo be released. Do not burn treated timbe

VOLATILE ORGANIC COMPOUNDS Many types of glue, solvents, spray packs, paints, varnishes and some cleaning materials and disinfectants

have dangerous emissions. Areas where these are used should be kept well ventilated while the material is being used and for a period after installation. Personal Protective Equipment may also be required. The manufacturer's recommendations for use must be carefully considered at all times. SYNTHETIC MINERAL FIBRE

synthetic mineral fibre which may be harmful if inhaled or if it comes in contact with the skin, eyes or other

sensitive parts or the body. Personal Protective Equipment including protection against inhalation of harmful material should be used when installing, removing or working near bulk insulation material.

TIMBER FLOORS This building may contain timber floors which have an applied finish. Areas where finishes are applied should be kept well ventilated during sanding and application and for a period after installation. Personal Protective Equipment may also be required. The manufacturer's recommendations for use must be

Fibreglass, rockwool, ceramic and other material used for thermal or sound insulation may contain

carefully considered at all times. 7. CONFINED SPACES

EXCAVATION

Construction of this building and some maintenance on the building will require excavation and installation of items within excavations. Where practical, installation should be carried out using methods which do not require workers to enter the excavation. Where this is not practical, adequate support for the excavated area should be provided to prevent collapse. Warning signs and barriers to prevent accidental or unauthorised access to all excavations should be provided.

For buildings with enclosed spaces where maintenance or other access may be required: Enclosed spaces within this building may present a risk to persons

entering for construction, maintenance or any other purpose. The design documentation calls for warning signs and barriers to unauthorised access. These should be maintained throughout the life of the building. Where workers are required to enter enclosed spaces, air testing equipment and Personal Protective Equipment should be provided.

For buildings with small spaces where maintenance or other access may be required: Some small spaces within this building will require access by construction or maintenance workers. The design documentation calls for warning signs and barriers to unauthorised access. These should be maintained throughout the life of the building. Where workers are required to enter small spaces they should be scheduled so that access is for short periods. Manual lifting and other manual activity should be restricted in small spaces.

Public access to construction and demolition sites and lo areas under maintenance causes risk to workers and public. Warning signs and secure barriers to unauthorised access should be provided. Where electrical installations, excavations, plant or loose materials are present they should be secured when not fully supervised.

9. OPERATIONAL USE OF BUILDING RESIDENTIAL BUILDINGS


This building has been designed as a residential building. If it, at a later date, it is used or intended to be used as a workplace, the provisions of the Work Health and Safely Act 2011 or subsequent replacement Act should be applied to the new use.

NON-RESIDENTIAL BUILDINGS

For non-residential buildings where the end-use has not been identified: This building has been designed to requirements of the classification identified on the drawings. The specific, use of the building is not known at the time of the design and a further assessment of the workplace health and safety issues should be undertaken at the time of fit-out for the end-user. For non-residential buildings where the end-use is known: This building has been designed for the specific use as identified on the drawings. Where a change of use occurs at a later dale a further assessment of the workplace health and safety issues should be

10. OTHER HIGH RISK ACTIVITY

All electrical work should be carried out in accordance with Code of Practice: Managing Electrical Risks at the Workplace, AS/ NZ 3012 and all licensing requirements. All work using Plant should be carried out in accordance with Code of Practice: Managing Risks of Plant at the Workplace. All work should be carried out in accordance with Code of Practice: Managing Noise and Preventing Hearing Loss at Work, Due to the history of serious incidents it is recommended that particular care be exercised when undertaking work involving steel construction and concrete placement. All the above applies.

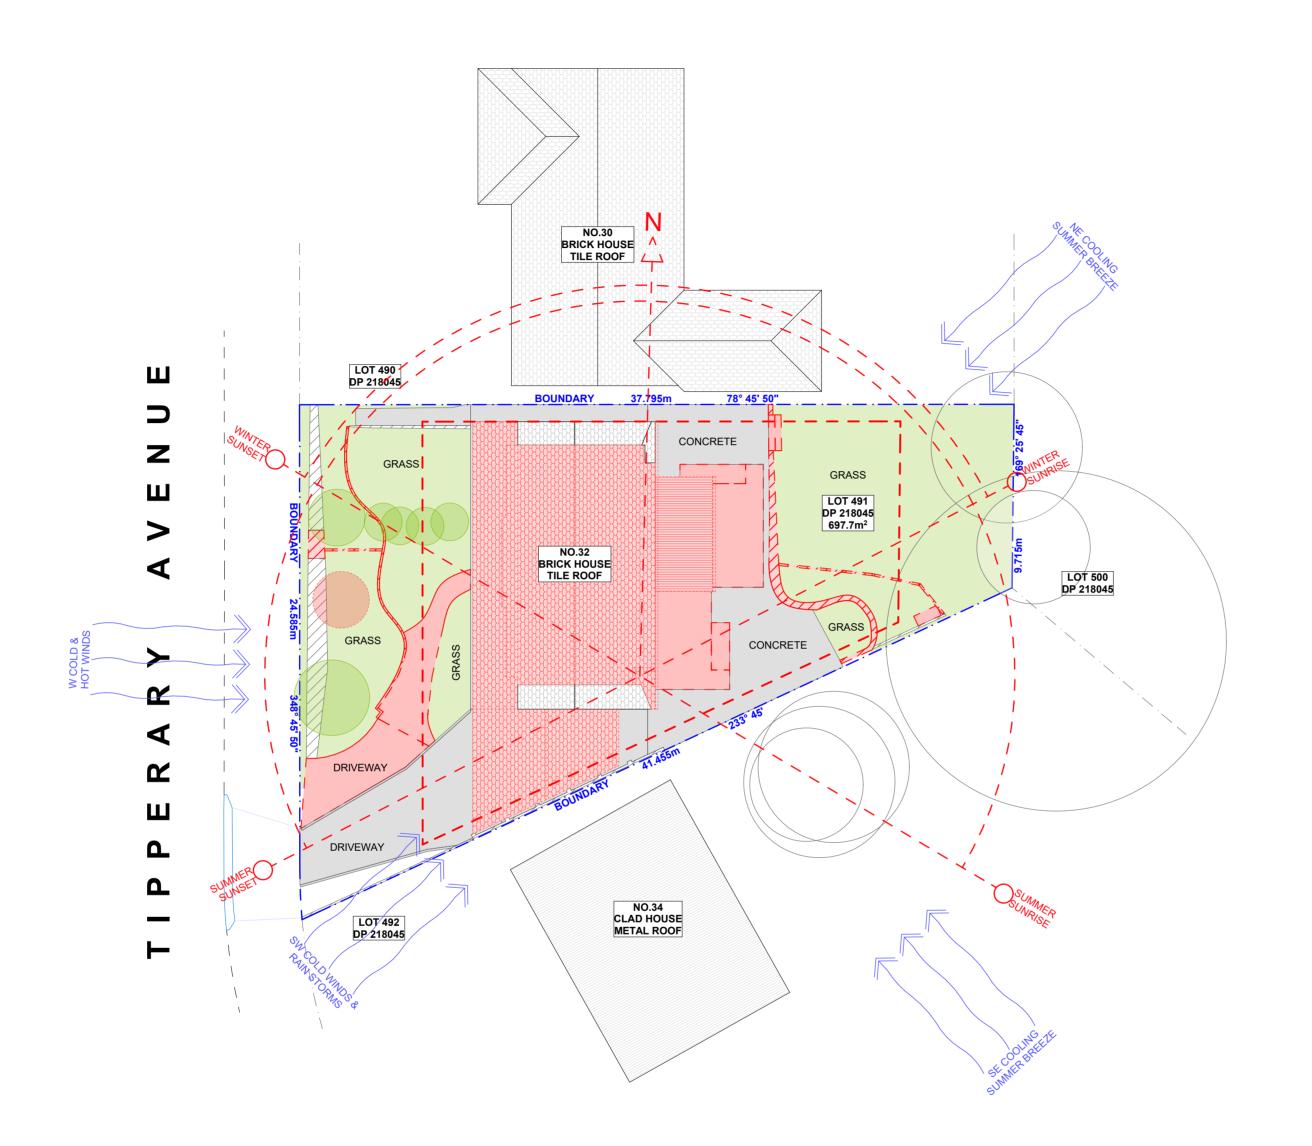







SITE ANALYSIS / ROOF DEMOLITION PLAN

1:200

CLIENT DANIELA & SAM ROSSINGTON

32 TIPPERARY

AVENUE, KILLARNEY HEIGHTS NSW 2087

PROJECT ADDRESS DATE

2024

DRAWING NO. DRAWING NAME SITE ANALYSIS **DA02**

Wednesday, 8 May

SCALE 1:200 @A2


NOTE: ALL DEMOLISHED ELEMENTS TO ENG. SPECIFICATIONS AND AS. 2601 - 2001




--- DEMOLISHED



SITE / ROOF / SEDIMENT EROSION / WASTE MANAGEMENT / STORMWATER CONCEPT PLAN

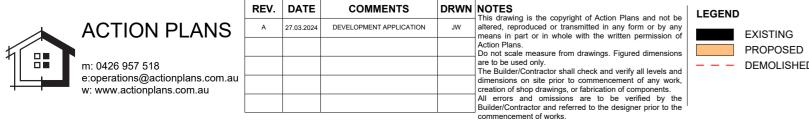

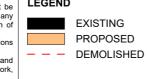

CLIENT DANIELA & SAM ROSSINGTON

PROJECT ADDRESS 32 TIPPERARY

AVENUE, KILLARNEY

HEIGHTS NSW 2087

DATE Wednesday, 8 May 2024

DA03

DRAWING NO.

DRAWING NAME

SITE / ROOF / SEDIMENT EROSION / WASTE MANAGEMENT / STORMWATER CONCEPT PLAN SCALE

NOTES REGARDING BOUNDARY

DUST CONTROL:

SEDIMENT NOTE:

SEDIMENT FENCE AREA.

SYSTEM OR WATERWAYS.

MANAGER.

STOCKPILES:

OVER STOCKPILES.

AROUND STOCKPILES.

GUTTER PROTECTION:

SITE FOR DISPOSAL.

SURVEY TO MEET THE IDENTIFICATION

REQUIREMENTS FOR COUNCIL AND NOT FOR REGISTRATION WITH THE LAND REGISTRATION SERVICES NSW NOR MAY THIS PLAN BE USED FOR ANY OTHER PURPOSE. SUBSEQUENT REGISTERED OR OTHER SURVEYS MAY AFFECT THE DEFINED BOUNDARY POSITIONS IN THIS AREA. ANY

THE INFORMATION SHOWN ON THIS PLAN IS FOR DESIGN PURPOSES ONLY. THE POSITION OF BOUNDARY LINES HAVE BEEN ESTABLISHED BY A

DIFFERENCES OF THIS NATURE ARE BEYOND THE

PURPOSES OF THIS PLAN. THIS PLAN IS FOR THE

FURTHER DEVELOPMENT IS CONTEMPLATED OR

CONSTRUCTION INTENDED THEN IT IS IMPORTANT THAT A SURVEY SET OUT IS CARRIED OUT.

TO REDUCE DUST GENERATED BY WIND ACTION, THE REMOVAL OF THE TOP SOIL IS TO BE MINIMISED. TO

PREVENT DUST GENERATION, WATERING DOWN OF

THE SITE, ESPECIALLY DURING THE MOVEMENT OF

MACHINERY IS REQUIRED. WHERE EXCAVATING INTO

ROCK, KEEP THE SURFACE MOIST TO MINIMISE DUST. CONSTRUCT A GRAVEL ENTRY/EXIT POINT USING BLUE METAL AND RESTRICT ALL VEHICLE MOVEMENTS WITHIN THE SITE TO A MINIMUM. ENSURE WIND BREAKS, SUCH AS EXISTING FENCES ARE MAINTAINED DURING THE CONSTRUCTION PHASE UNTIL NEW LANDSCAPING IS PROVIDED OR REINSTATED. PREVENT DUST BY COVERING STOCKPILES

1. ALL EROSION AND SEDIMENT CONTROL MEASURES TO BE INSPECTED AND MAINTAINED DAILY BY THE SITE

2. MINIMISE DISTURBED AREAS, REMOVE EXCESS SOIL FROM EXCAVATEDAREA AS SOON AS POSSIBLE. 3. ALL MATERIAL STOCKPILE TO BE CLEAR FROM DRAINS, GUTTERS AND FOOTPATHS, OR WITHIN

4. DRAINAGE TO BE CONNECTED TO STORMWATER AS SOON AS POSSIBLE. IF STORED ON SITE, IT MUST BE

FILTERED BEFORE RELEASING INTO STORMWATER

ALL STOCKPILES ARE TO BE KEPT ON-SITE WHERE

FOOTPATHS OR NATURE STRIPS REQUIRE COUNCIL'S

ALL STOCKPILES ARE TO BE PLACED AWAY FROM THE

DRAINAGE LINES AND STREET GUTTERS. IT IS BEST

TO LOCATE THESE ON THE HIGHEST PART OF THE SITE IF POSSIBLE. PLACE WATERPROOF COVERING

IF REQUIRED PROVIDE DIVERSION DRAIN & BANK

PROVIDE PROTECTION TO DOWNHILL GRATE IN GUTTER BY MEANS OF SAND BAGS OR BLUE METAL WRAPPED IN GEOTEXTILE FABRIC. WHEN SOIL OR SAND BUILDS UP AROUND THIS SEDIMENT BARRIER, THE MATERIAL SHOULD BE RELOCATED BACK TO THE


NOTE: ALL PROPOSED STORMWATER TO CONNECT WITH EXISTING


5. ROADS AND FOOTPATHS TO BE SWEPT DAILY.

POSSIBLE. ANY MATERIALS PLACED ON THE

THE TITLE HAVE NOT BEEN INVESTIGATED. IF

ABOVE STATED PURPOSES ONLY. RESTRICTIONS ON

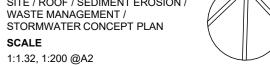

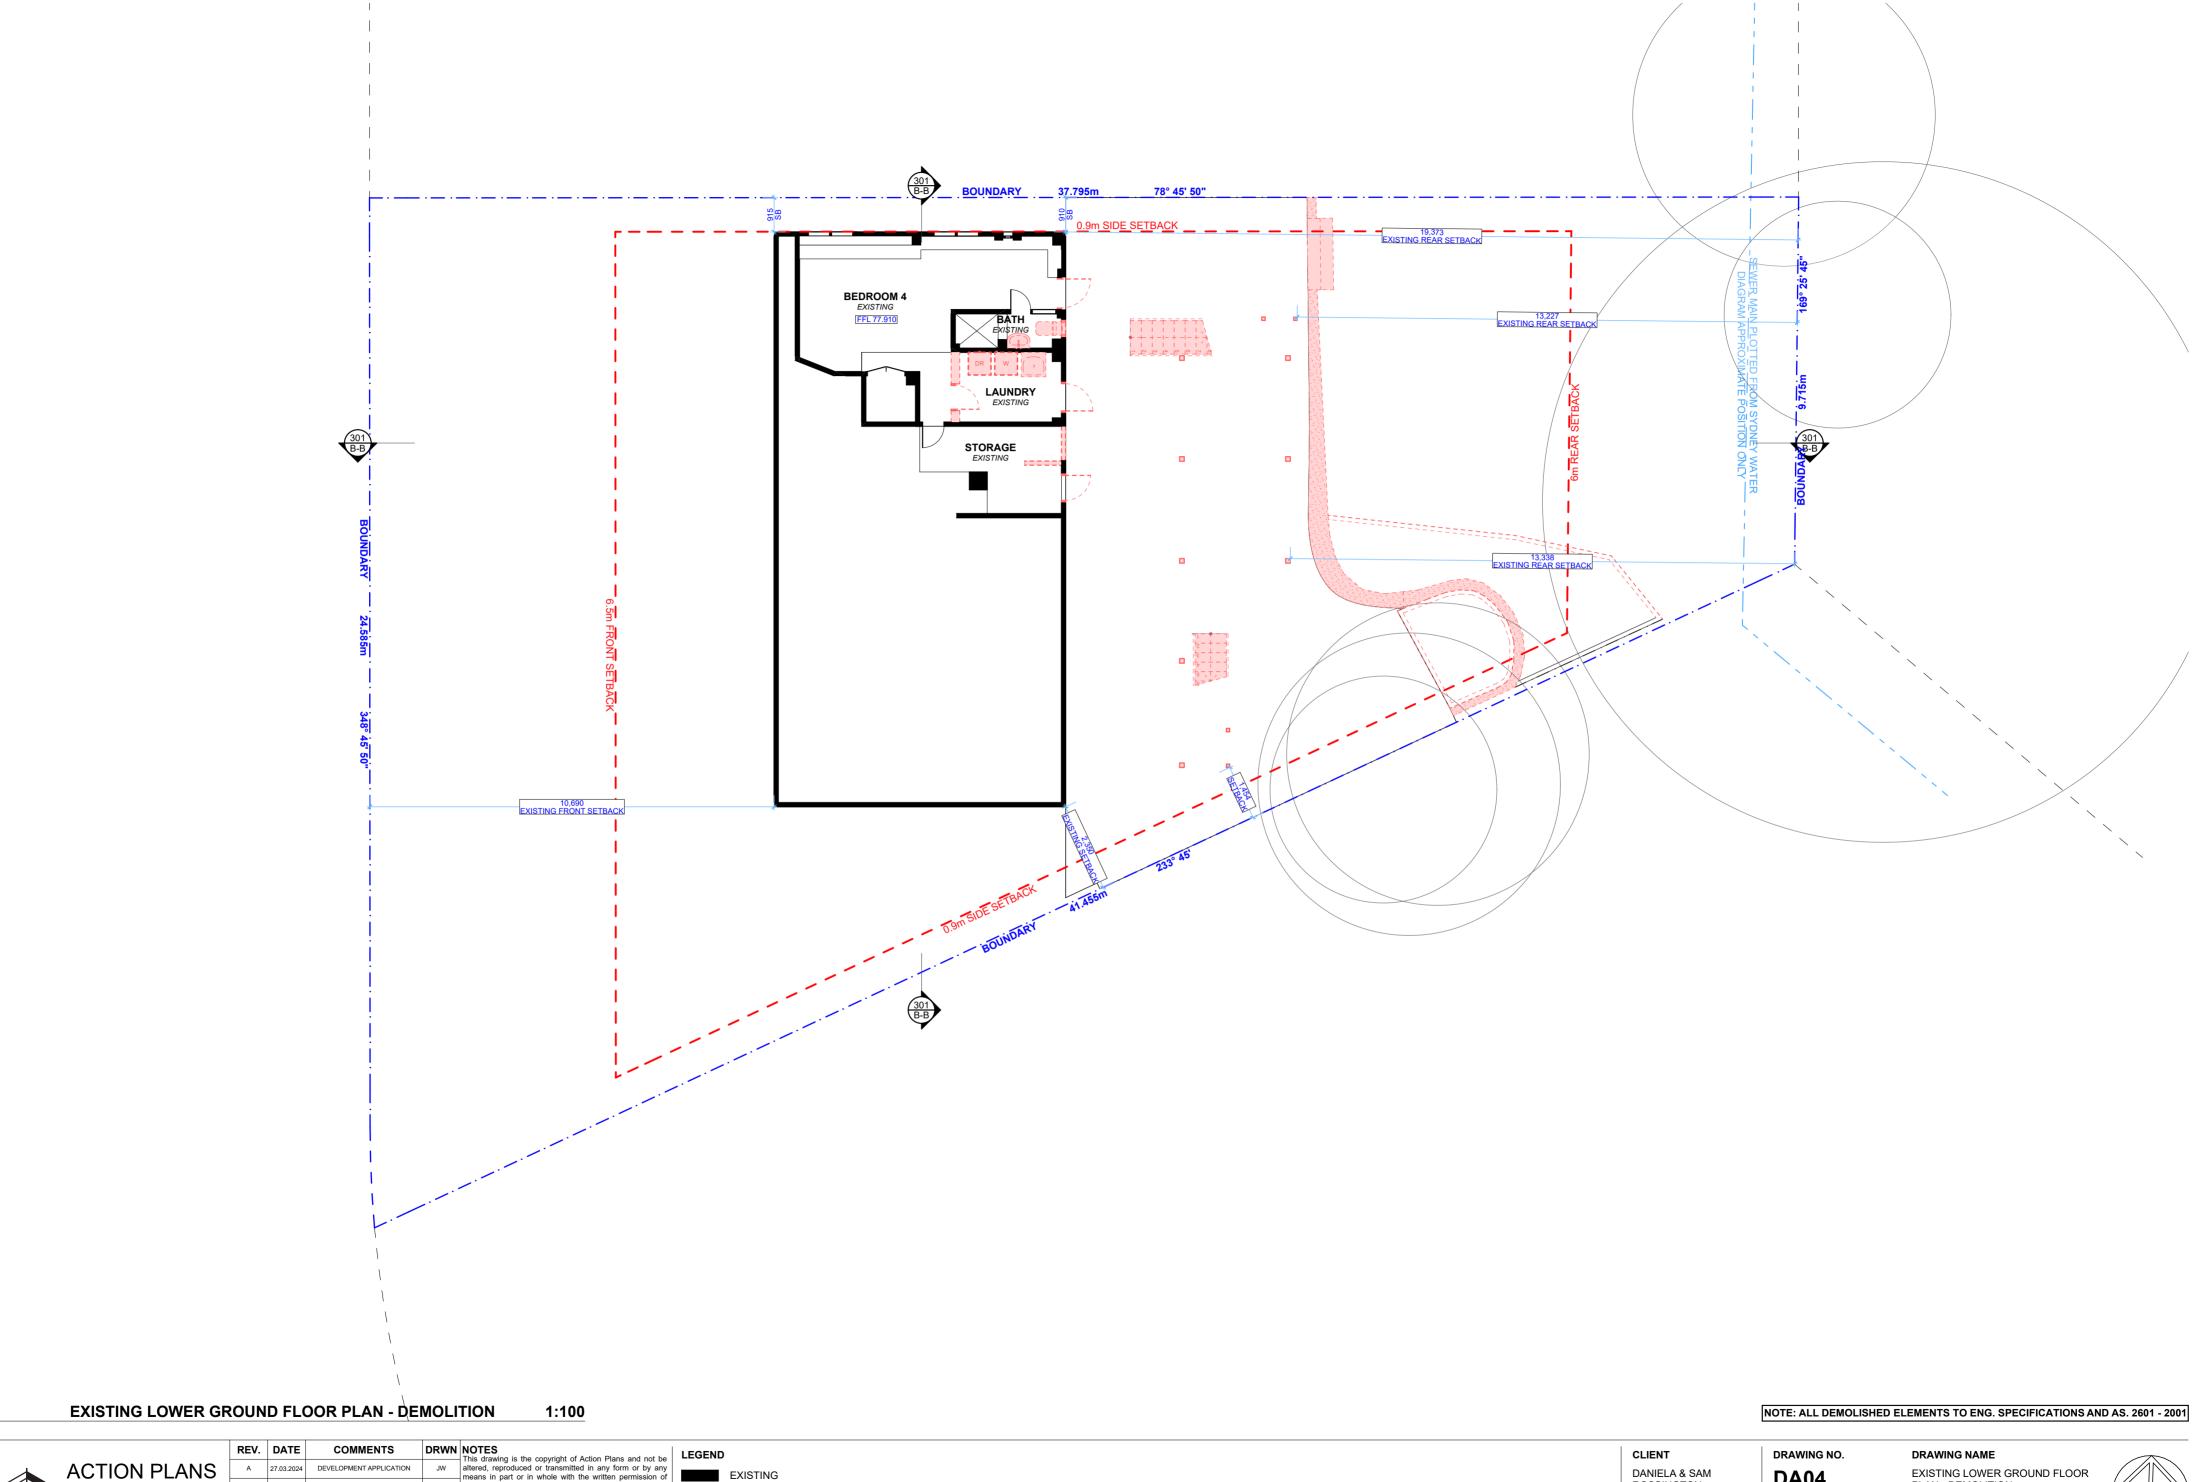

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--- DEMOLISHED

ROSSINGTON

PROJECT ADDRESS 32 TIPPERARY AVENUE, KILLARNEY HEIGHTS NSW 2087

DA04

DATE

2024


Wednesday, 8 May

EXISTING LOWER GROUND FLOOR PLAN - DEMOLITION

SCALE

1:100 @A2



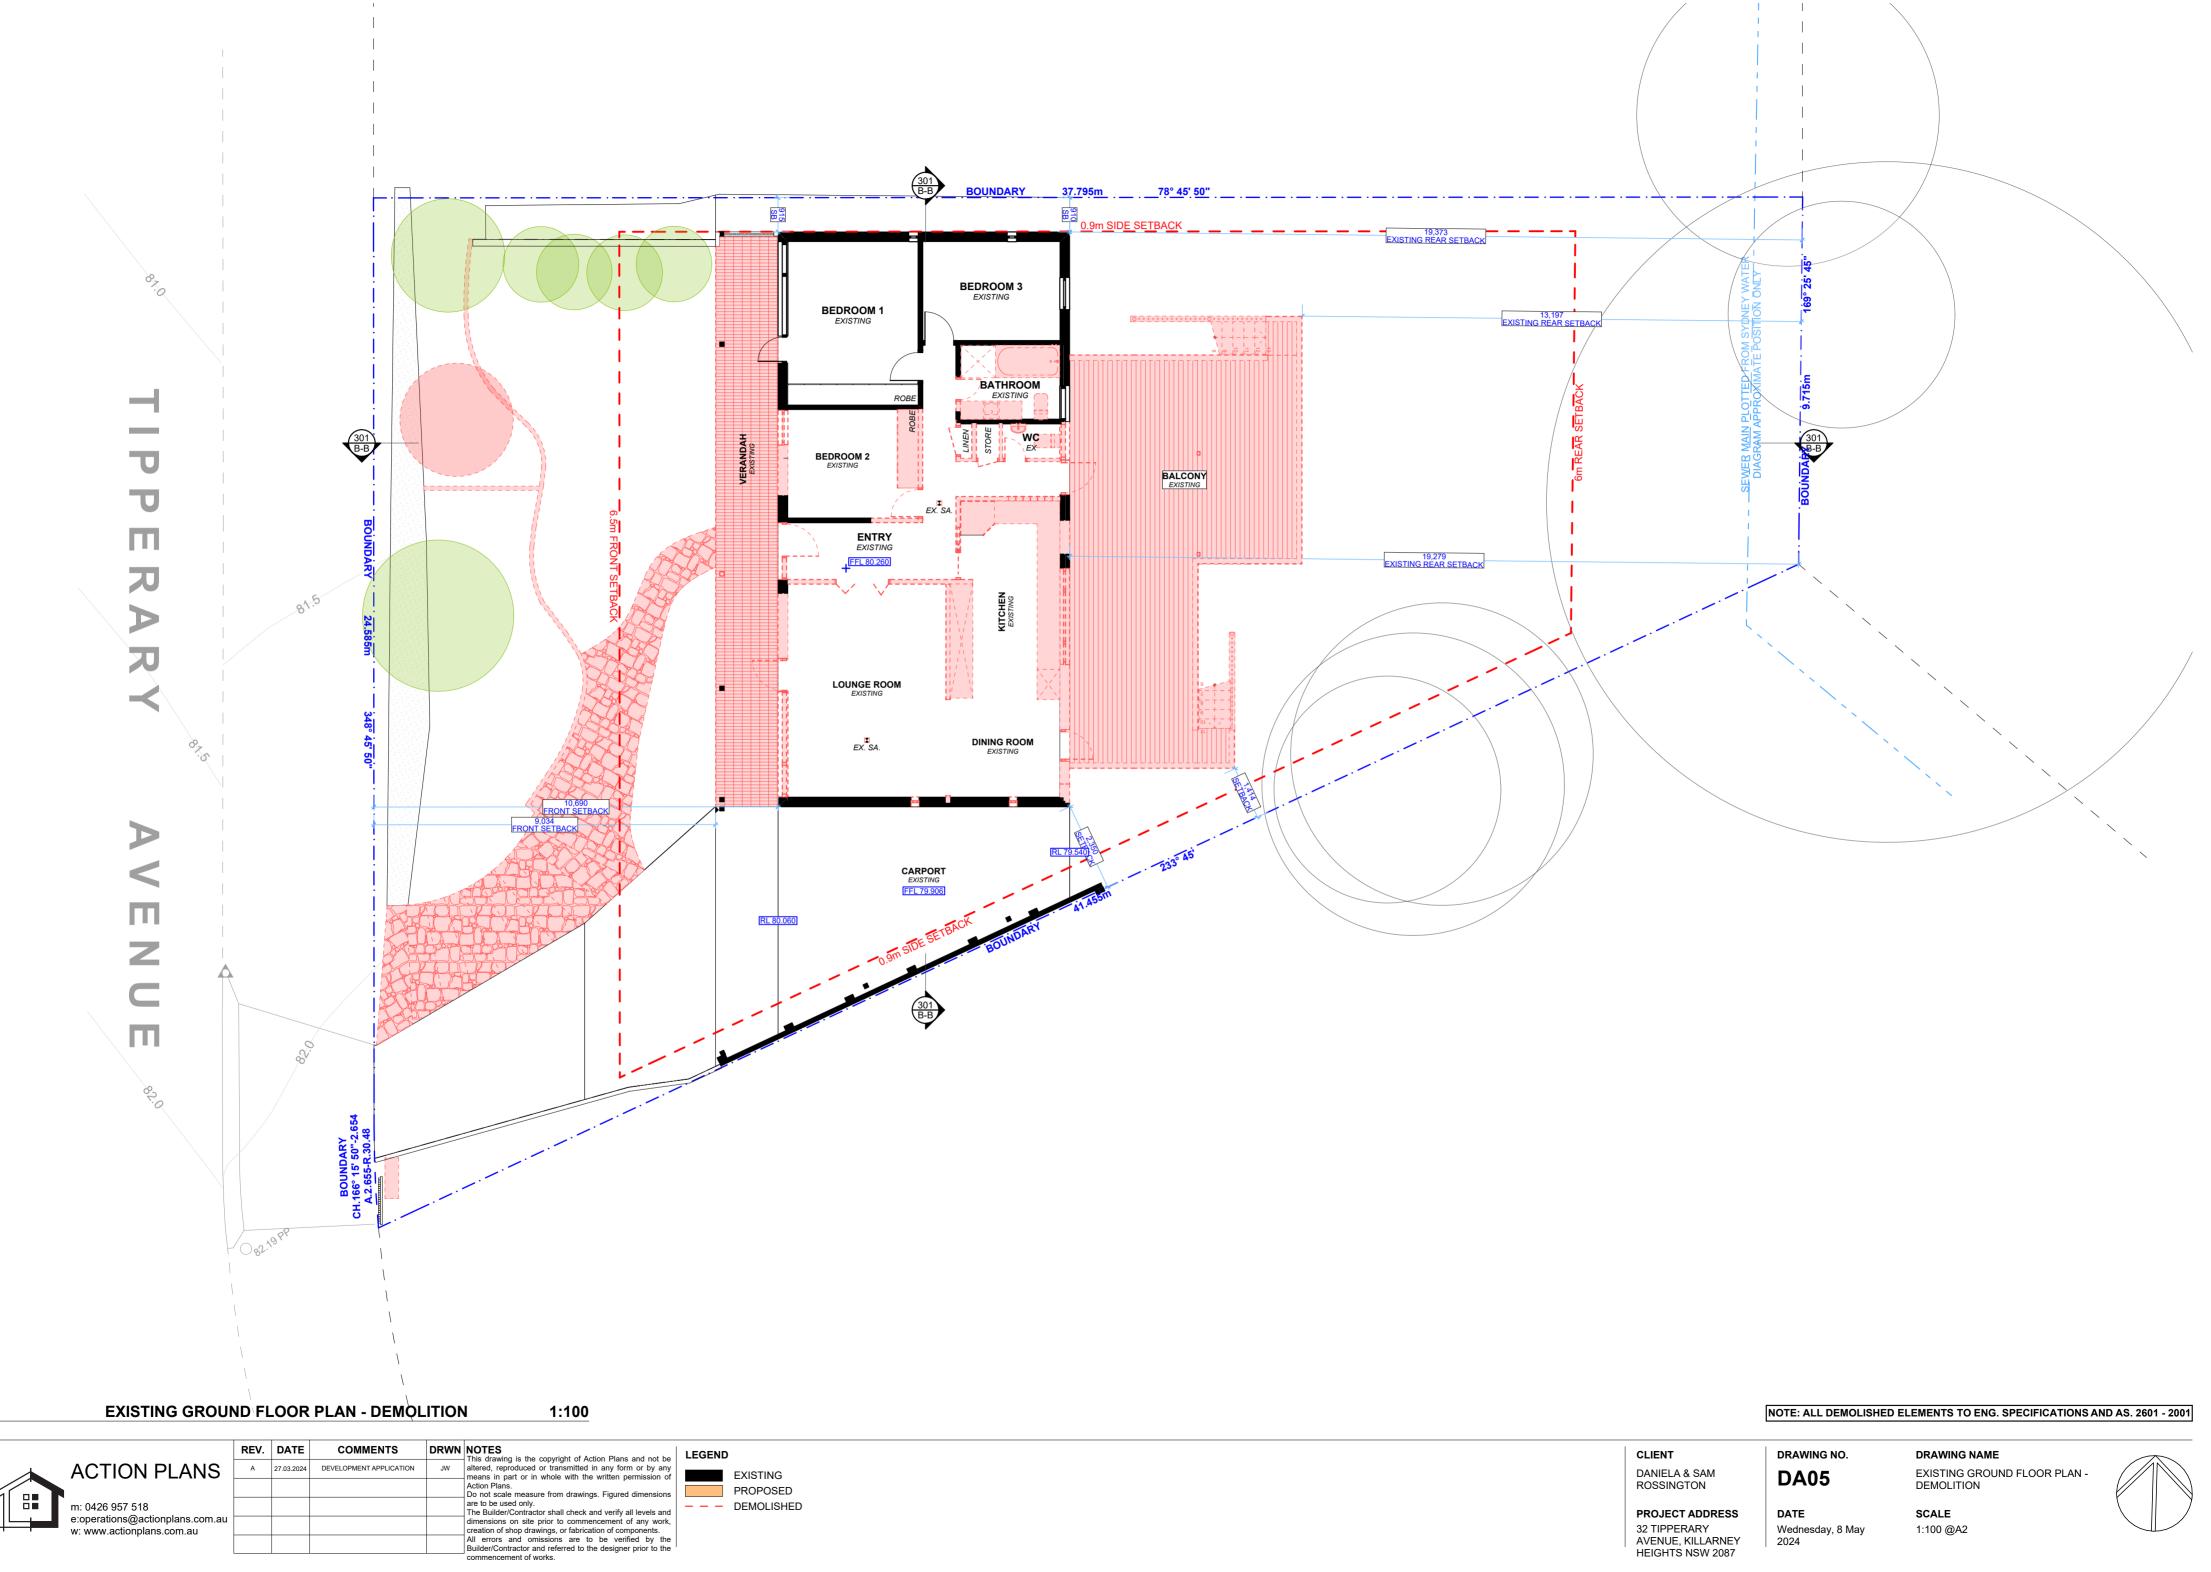


e:operations@actionplans.com.au w: www.actionplans.com.au

32 TIPPERARY AVENUE, KILLARNEY HEIGHTS NSW 2087

1:100 @A2


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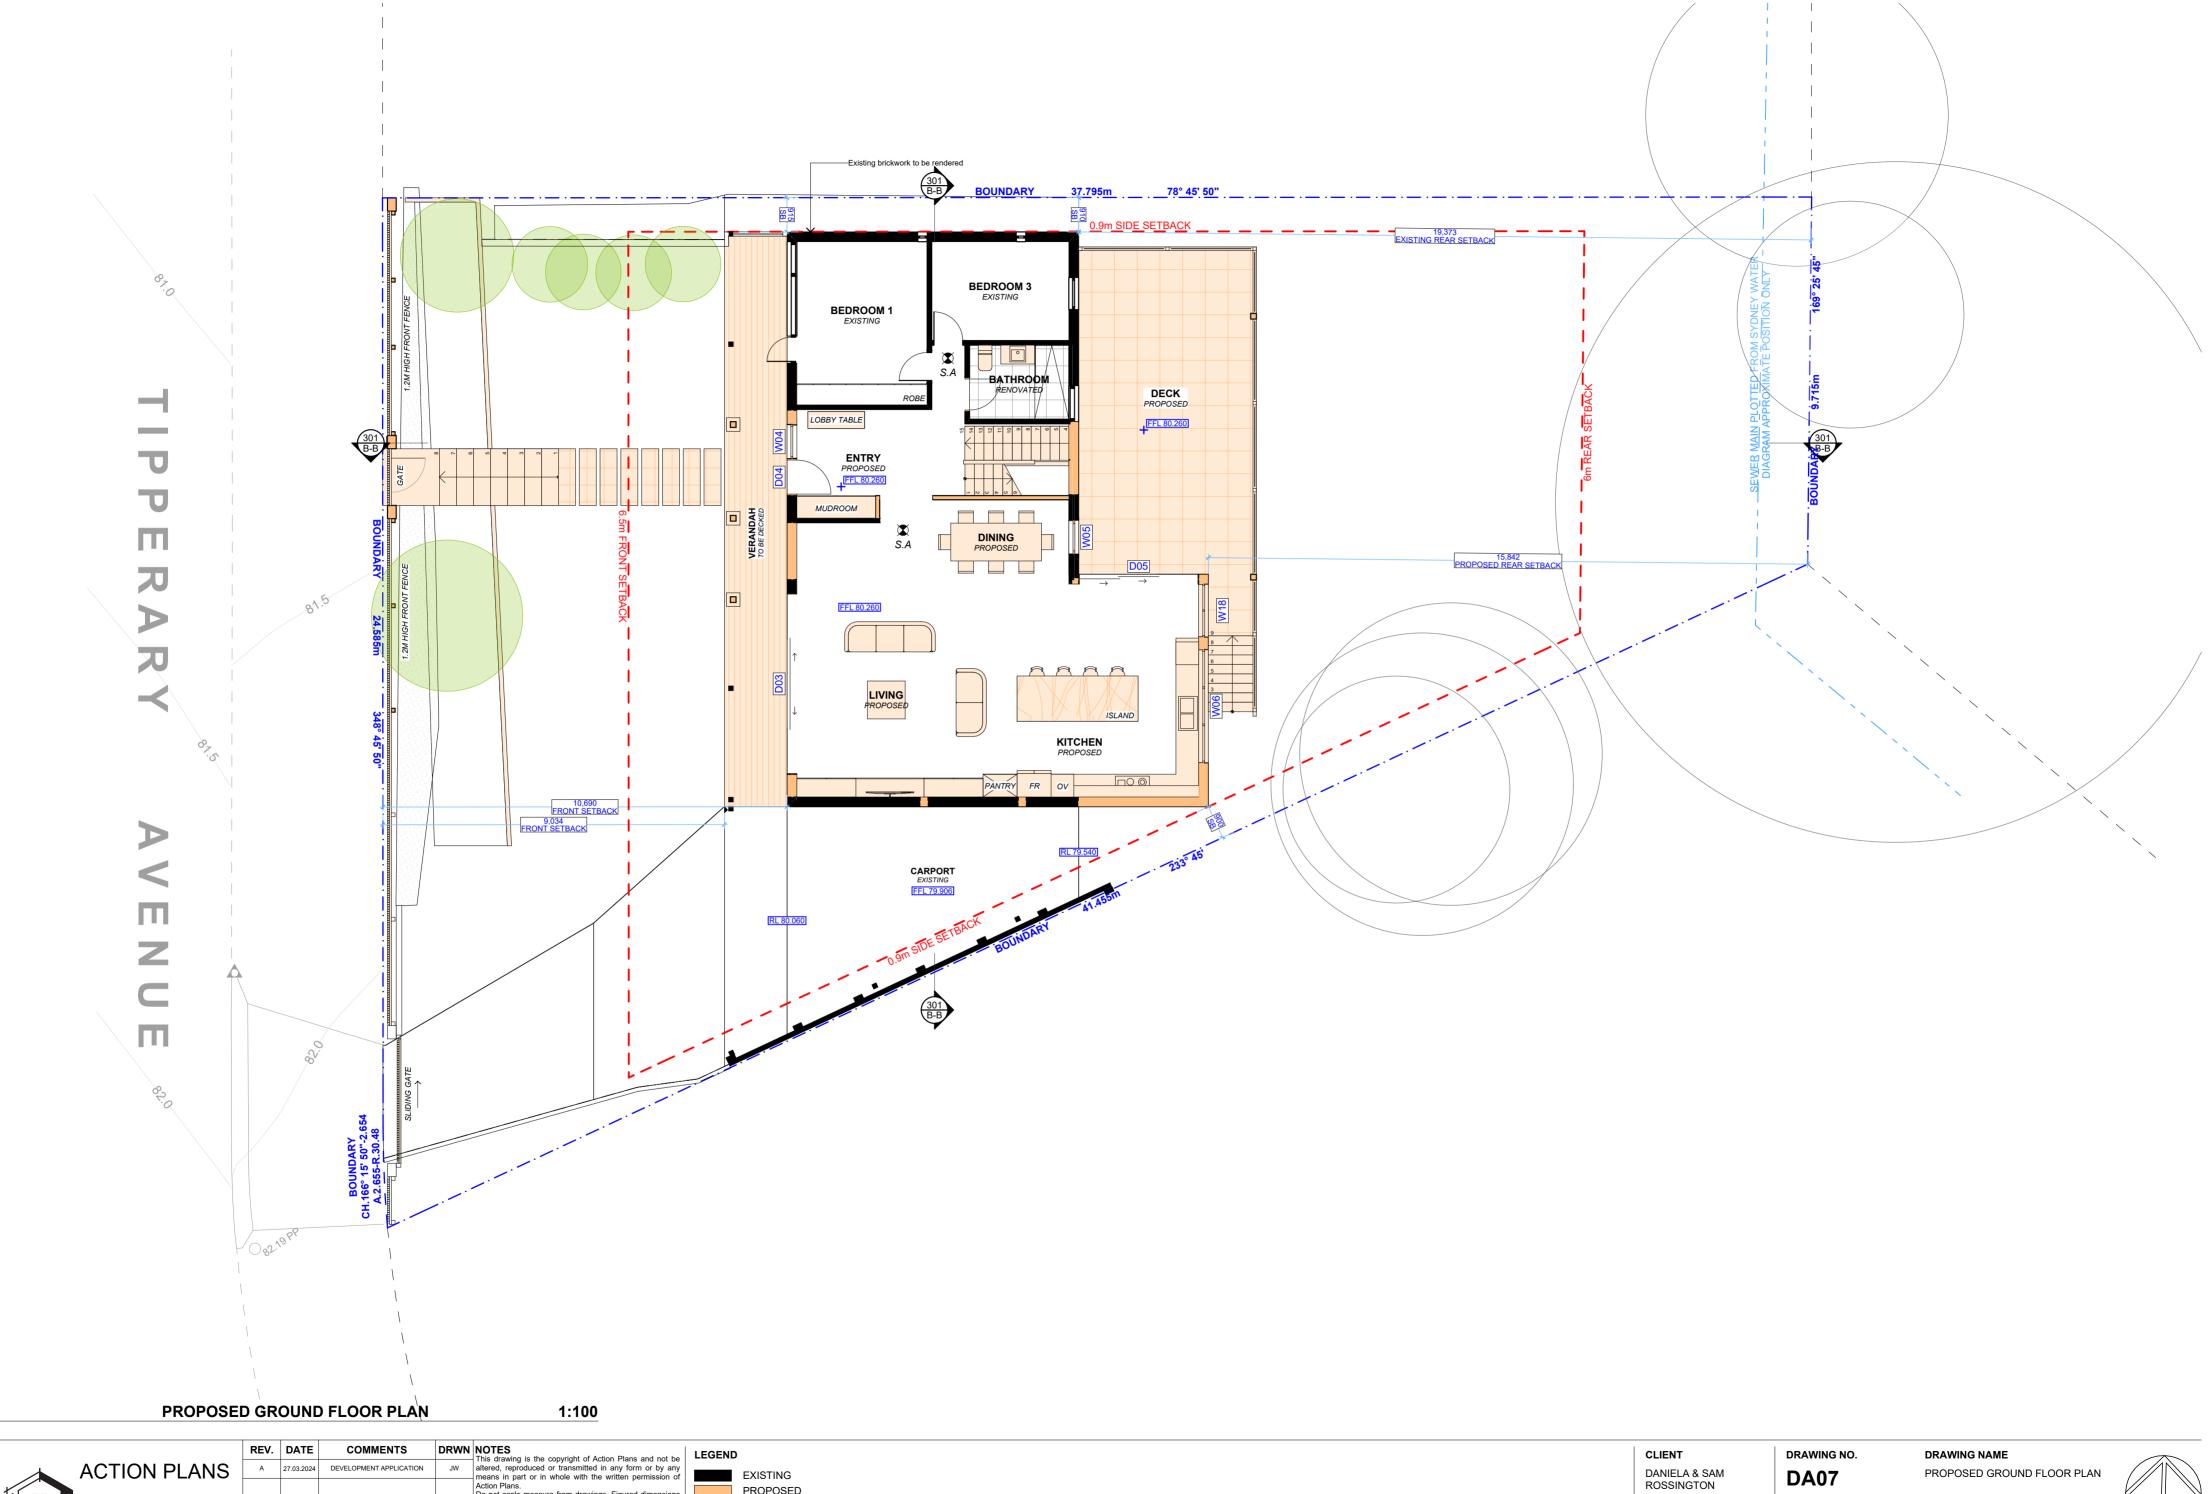
DANIELA & SAM ROSSINGTON

PROJECT ADDRESS 32 TIPPERARY AVENUE, KILLARNEY HEIGHTS NSW 2087 DA06 DATE

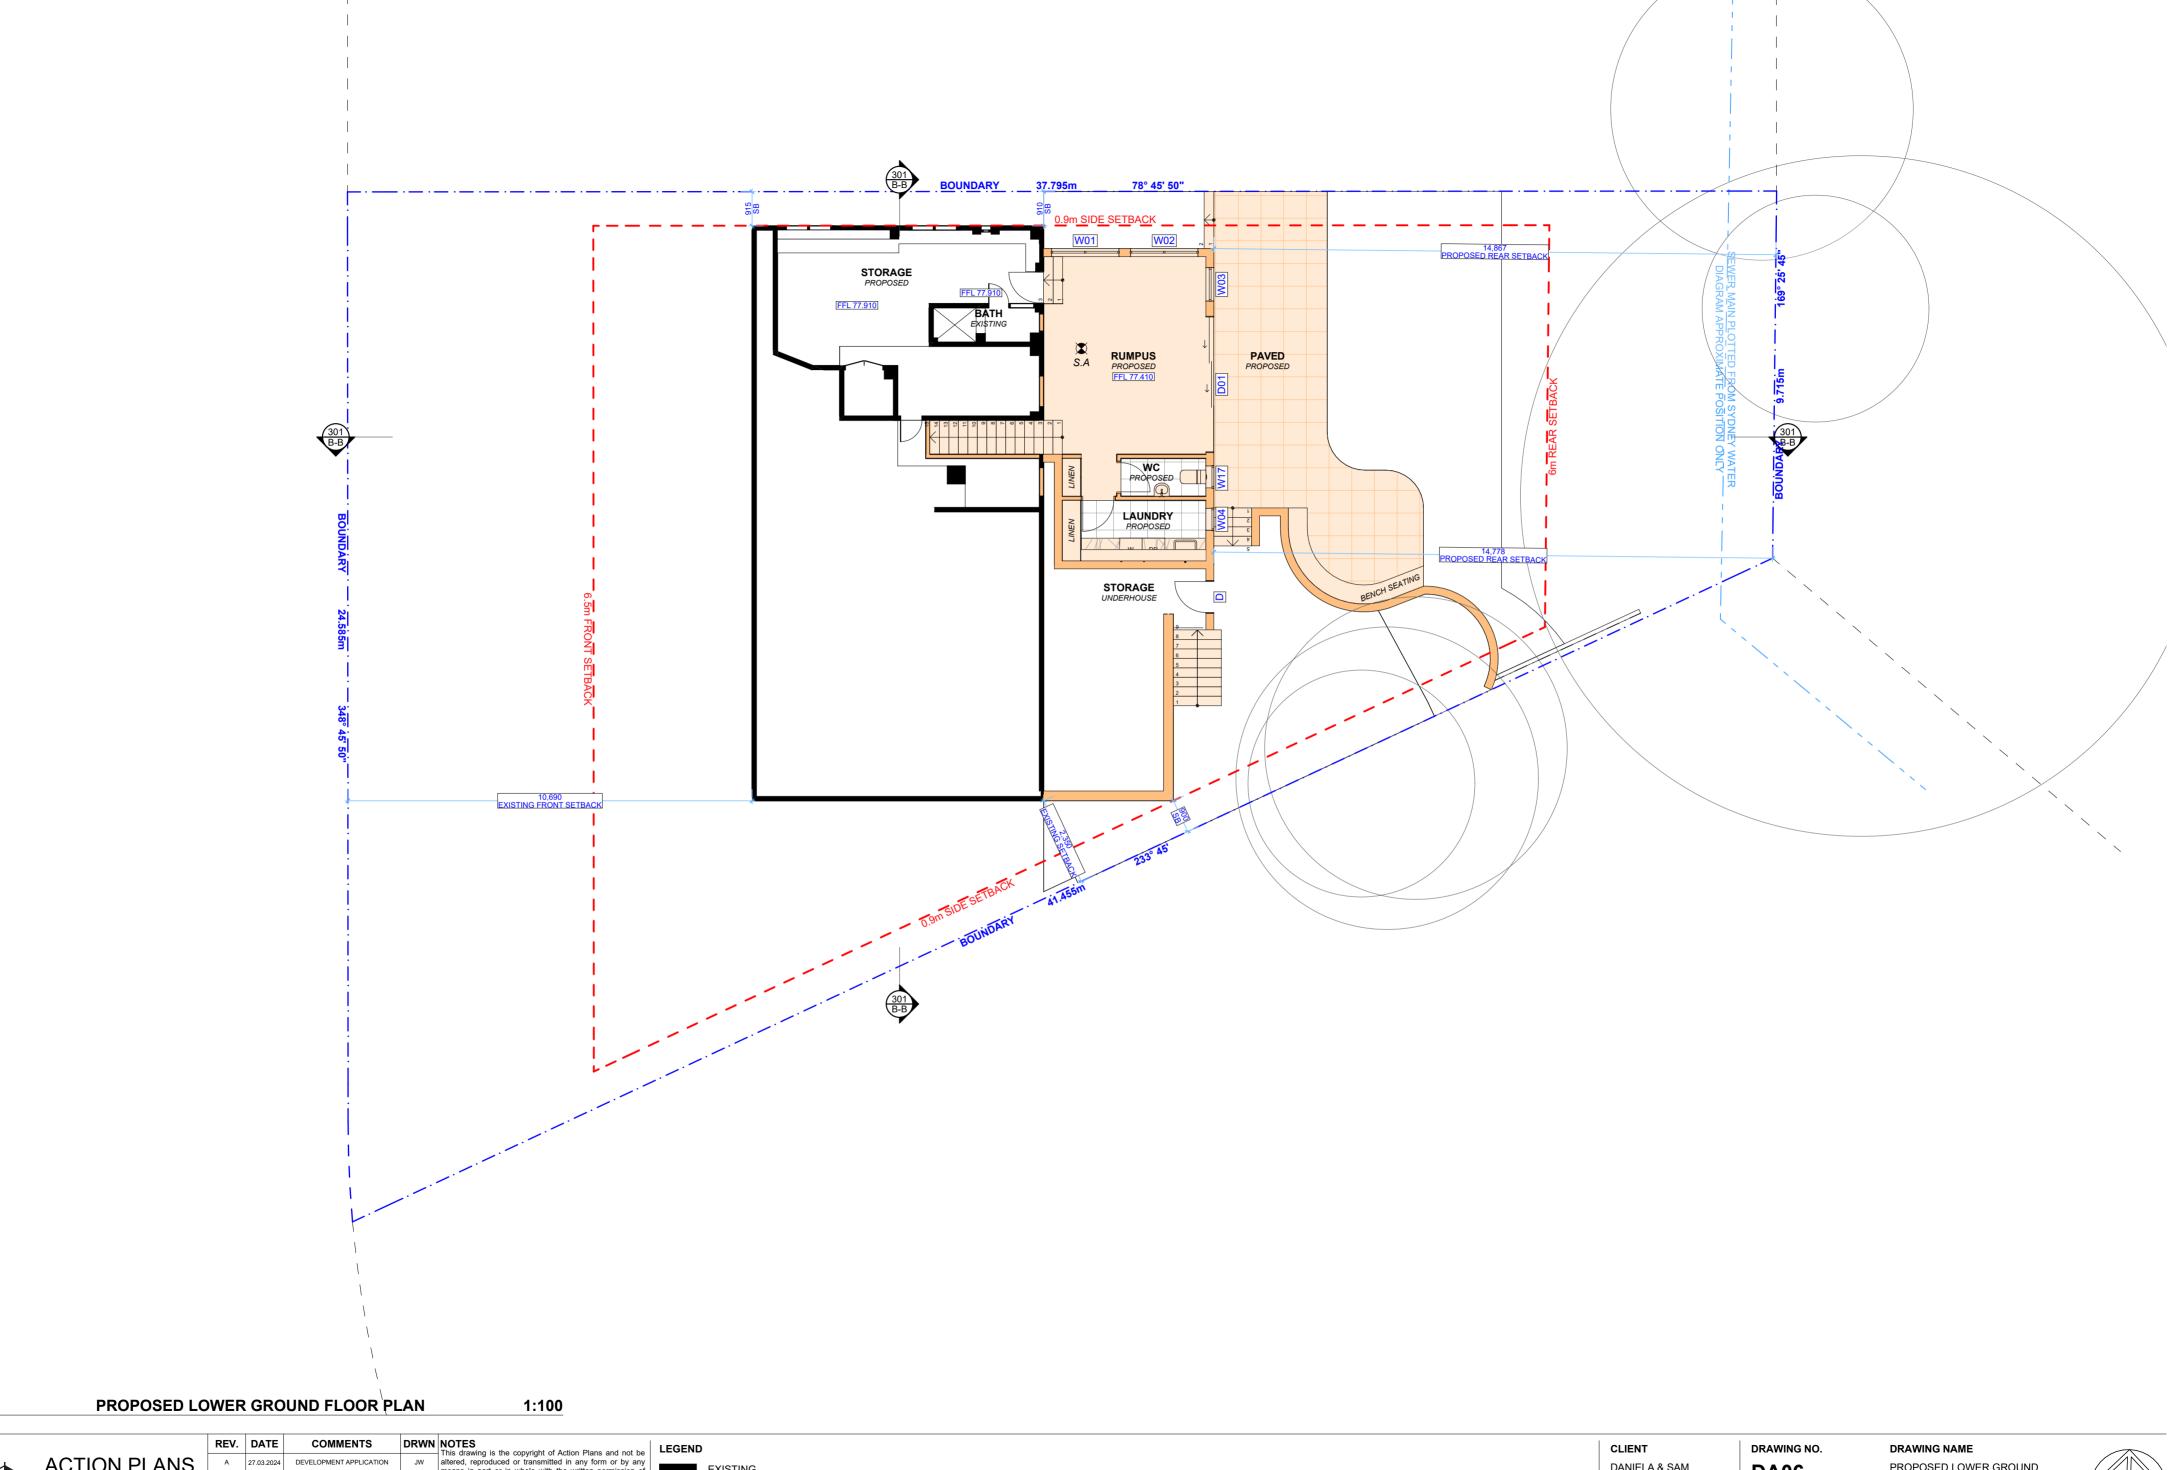Wednesday, 8 May 2024

PROPOSED LOWER GROUND FLOOR PLAN




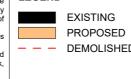

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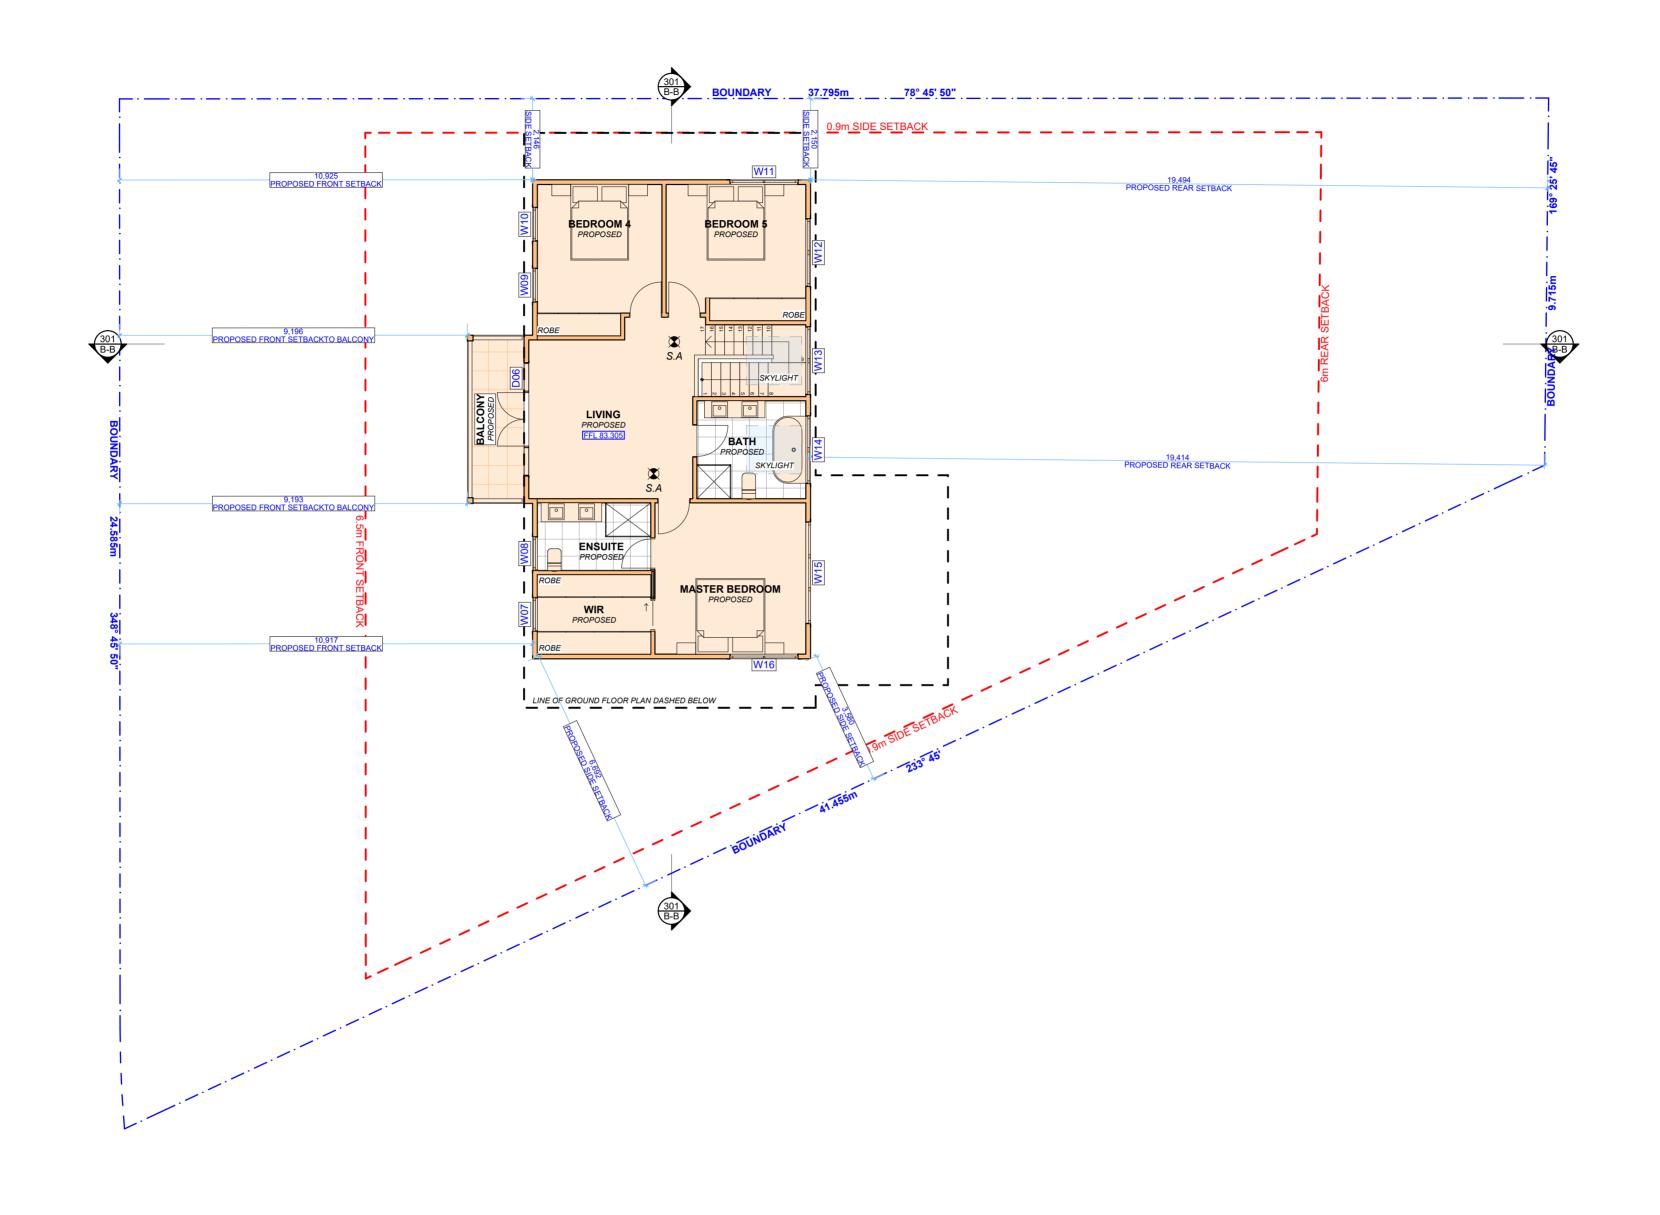


PROJECT ADDRESS 32 TIPPERARY AVENUE, KILLARNEY HEIGHTS NSW 2087

Wednesday, 8 May

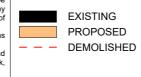DATE


2024



1 PROPOSED FIRST FLOOR PLAN 1:100



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					All errors and omissions are to be verified by the Builder/Contractor and referred to the designer prior to the
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CLIENT
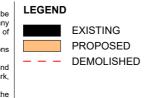
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ROSSINGTON

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HEIGHTS NSW 2087


DA08

Wednesday, 8 May 2024


DATE

DRAWING NAMEPROPOSED FIRST FLOOR PLAN



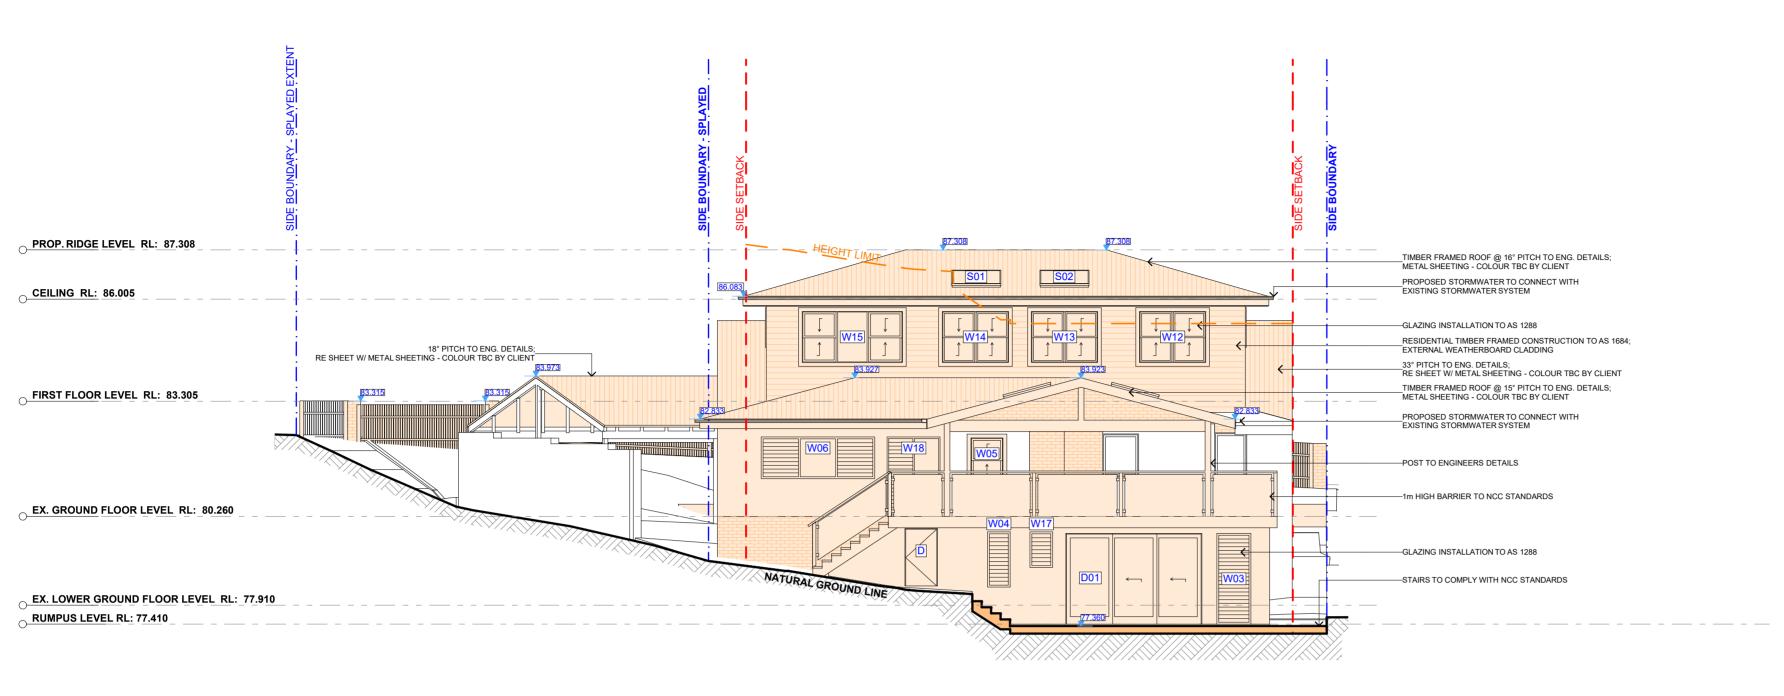

2. EAST ELEVATION - REAR 1:100

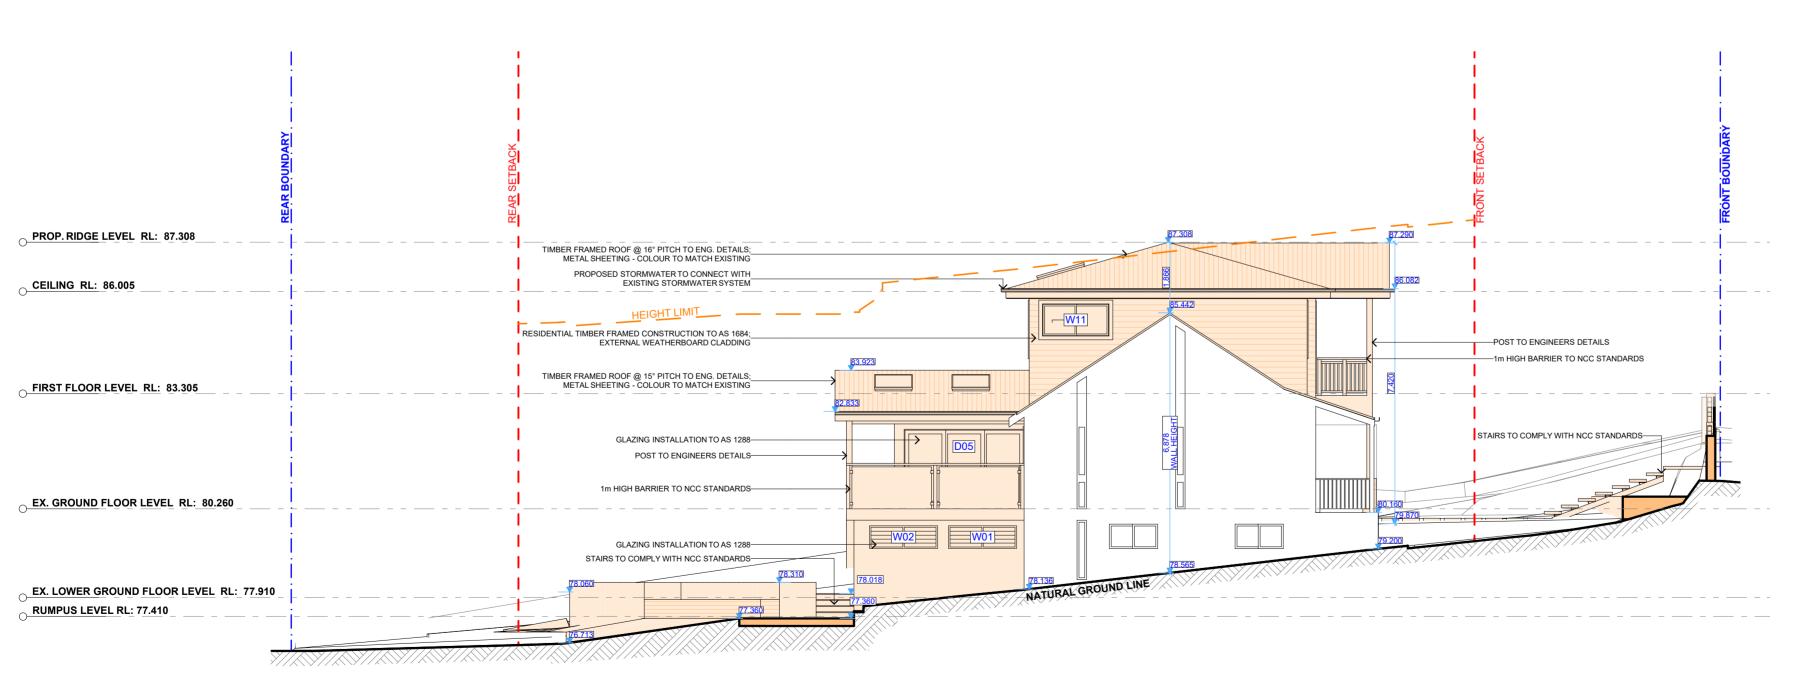

1 NORTH ELEVATION - SIDE 1:100

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#1						Action Plans. Do not scale measure from drawings. Figured dimensions		PROPOSED
" ==	m: 0426 957 518					are to be used only. The Builder/Contractor shall check and verify all levels and		DEMOLISHED
	e:operations@actionplans.com.au w: www.actionplans.com.au					dimensions on site prior to commencement of any work, creation of shop drawings, or fabrication of components.		
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PROJECT ADDRESS
32 TIPPERARY

AVENUE, KILLARNEY HEIGHTS NSW 2087 DATE
Wednesday, 8 May 2024

DRAWING NO.


NORTH / EAST ELEVATION - (SIDE / REAR)

SCALE 1:100 @A2

DRAWING NAME





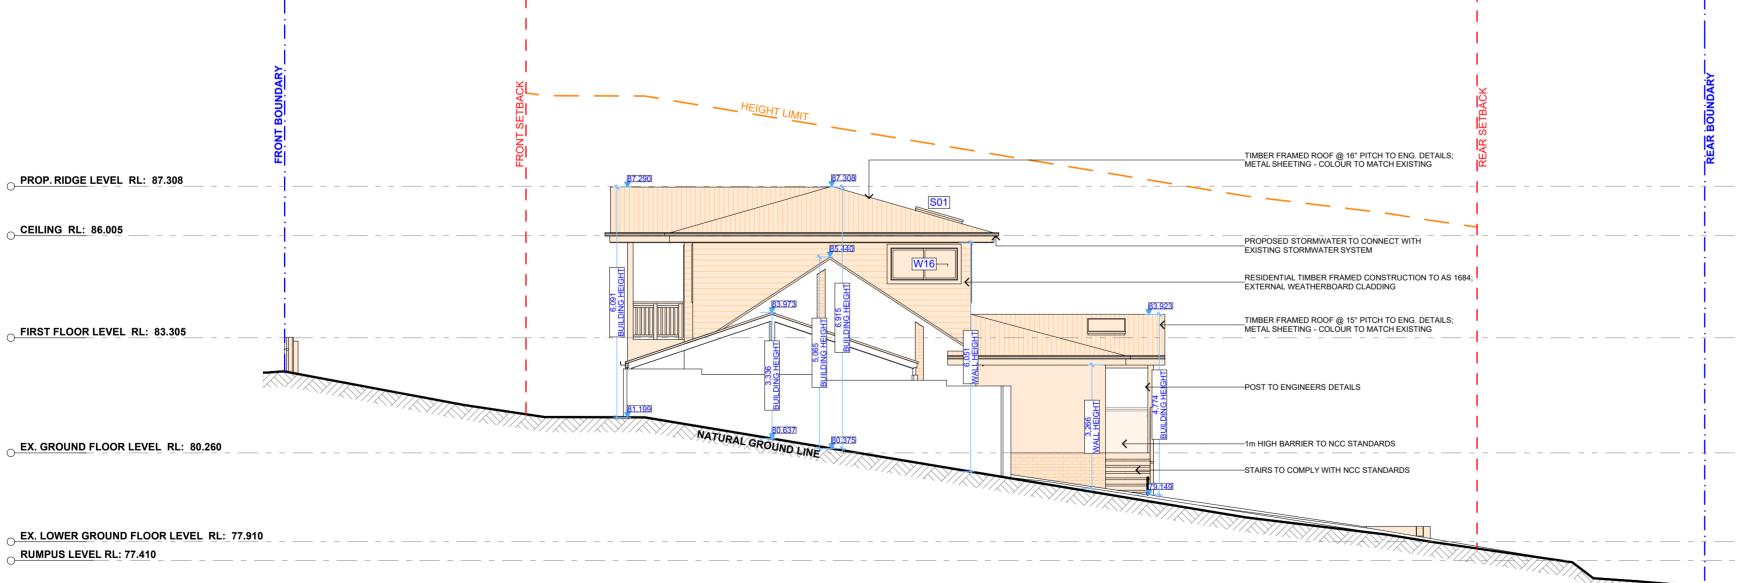

SOUTH ELEVATION - SIDE 1:100

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扣 •	1					Action Plans. Do not scale measure from drawings. Figured dimensions		PROPOSED
` == 	m: 0426 957 518					are to be used only. The Builder/Contractor shall check and verify all levels and		DEMOLISHED
<u> </u>	e:operations@actionplans.com.au w: www.actionplans.com.au					dimensions on site prior to commencement of any work, creation of shop drawings, or fabrication of components.		
	w. www.actionplane.com.ac					All errors and omissions are to be verified by the Builder/Contractor and referred to the designer prior to the		
					1	commencement of works.		


CLIENT DANIELA & SAM ROSSINGTON PROJECT ADDRESS

32 TIPPERARY


DA10 DATE Wednesday, 8 May 2024 AVENUE, KILLARNEY HEIGHTS NSW 2087

DRAWING NO.

DRAWING NAME SOUTH / WEST ELEVATION -(PRIMARY / SIDE)

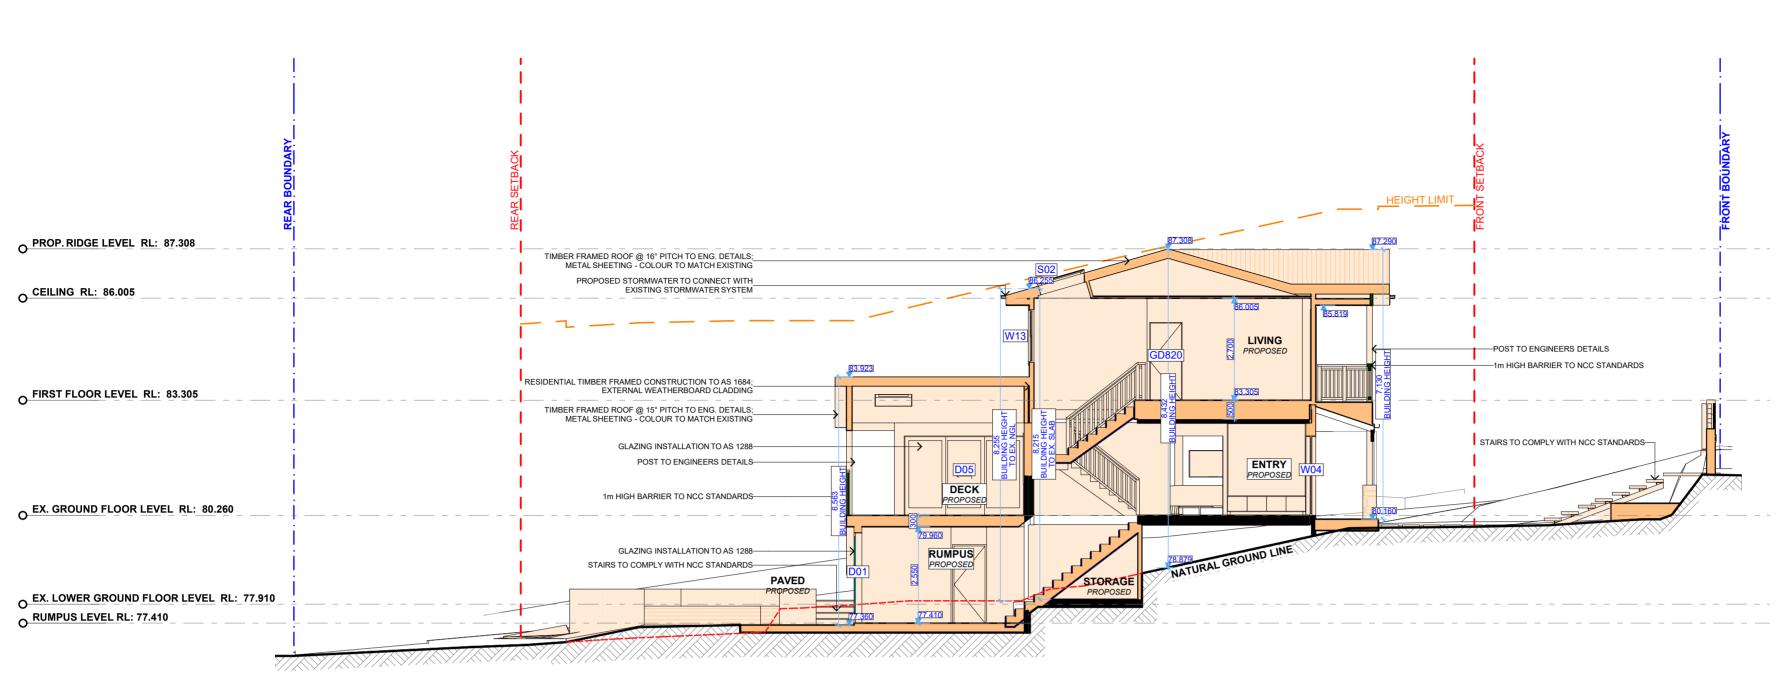

PROPOSED LONG SECTION 1:100

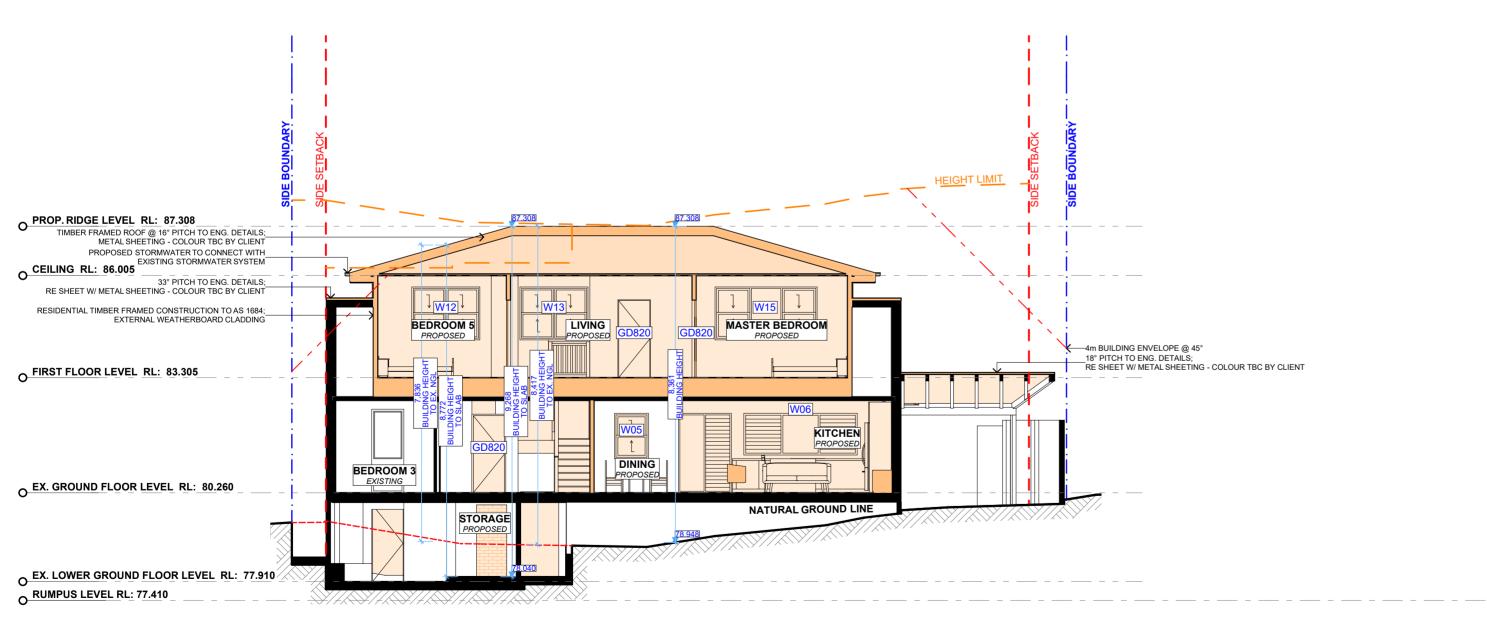

PROPOSED CROSS SECTION 1:100

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1 0						Action Plans. Do not scale measure from drawings. Figured dimensions		PROPOSED
1 8	m: 0426 957 518					are to be used only. The Builder/Contractor shall check and verify all levels and		DEMOLISHED
	e:operations@actionplans.com.au w: www.actionplans.com.au					dimensions on site prior to commencement of any work, creation of shop drawings, or fabrication of components.		
	'					All errors and omissions are to be verified by the Builder/Contractor and referred to the designer prior to the		
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32 TIPPERARY

AVENUE, KILLARNEY

HEIGHTS NSW 2087

DA11

2024

DA11 DRAWING NAME


LONG / CROSS SECTION

DATE SCAL Wednesday, 8 May 1:100

BOUNDARY 37.795m 78° 45' 50" PROPOSED LANDSCAPED AREA 123.51 m² PROPOSED LANDSCAPED AREA 161.96 m²

PROPOSED AREA CALCULATIONS

1:200

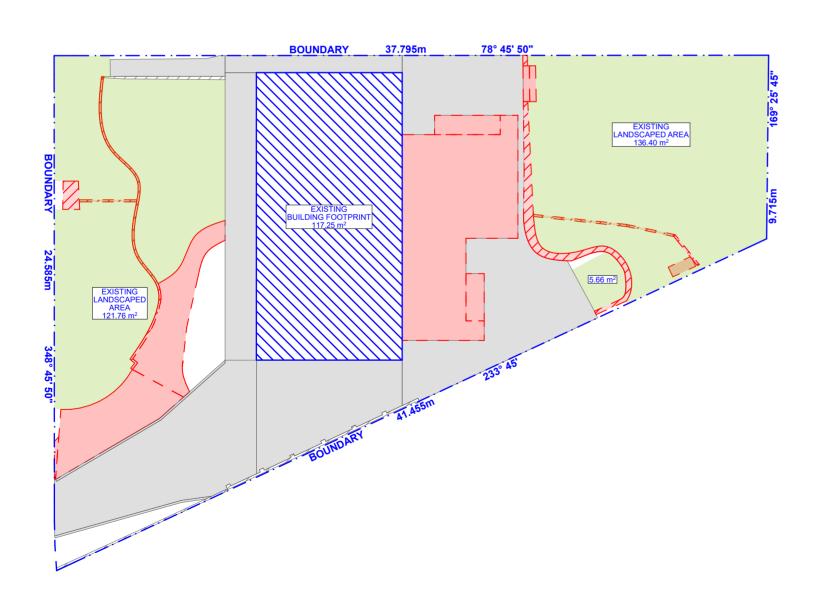

1:200

CONTROL TABLE

SITE AREA 697.7m²

REQUIRED **EXISTING PROPOSED**

51.45m²

LANDSCAPED AREA

PRIVATE OPEN SPACE

40% (279.08m²)

30.56% (213.28m²)

33.23% (231.91m²)







ALUMINIUN FRAMED WINDOWS BY STEGBAR

EXTERNAL WEATHERBOARD CLADDING -COLOUR TO BE CONFIRMED BY CLIENT

MATERAI LSAMPLE BOARD

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EXISTING AREA CALCULATIONS

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CLIENT DANIELA & SAM ROSSINGTON

PROJECT ADDRESS DATE 32 TIPPERARY Wednesday, 8 May AVENUE, KILLARNEY HEIGHTS NSW 2087 2024

METAL ROOFING -COLOUR TO BE CONFIRMED BY CLIENT


DA12

DRAWING NO.

AREA CALCULATIONS / SAMPLE BOARD

DRAWING NAME



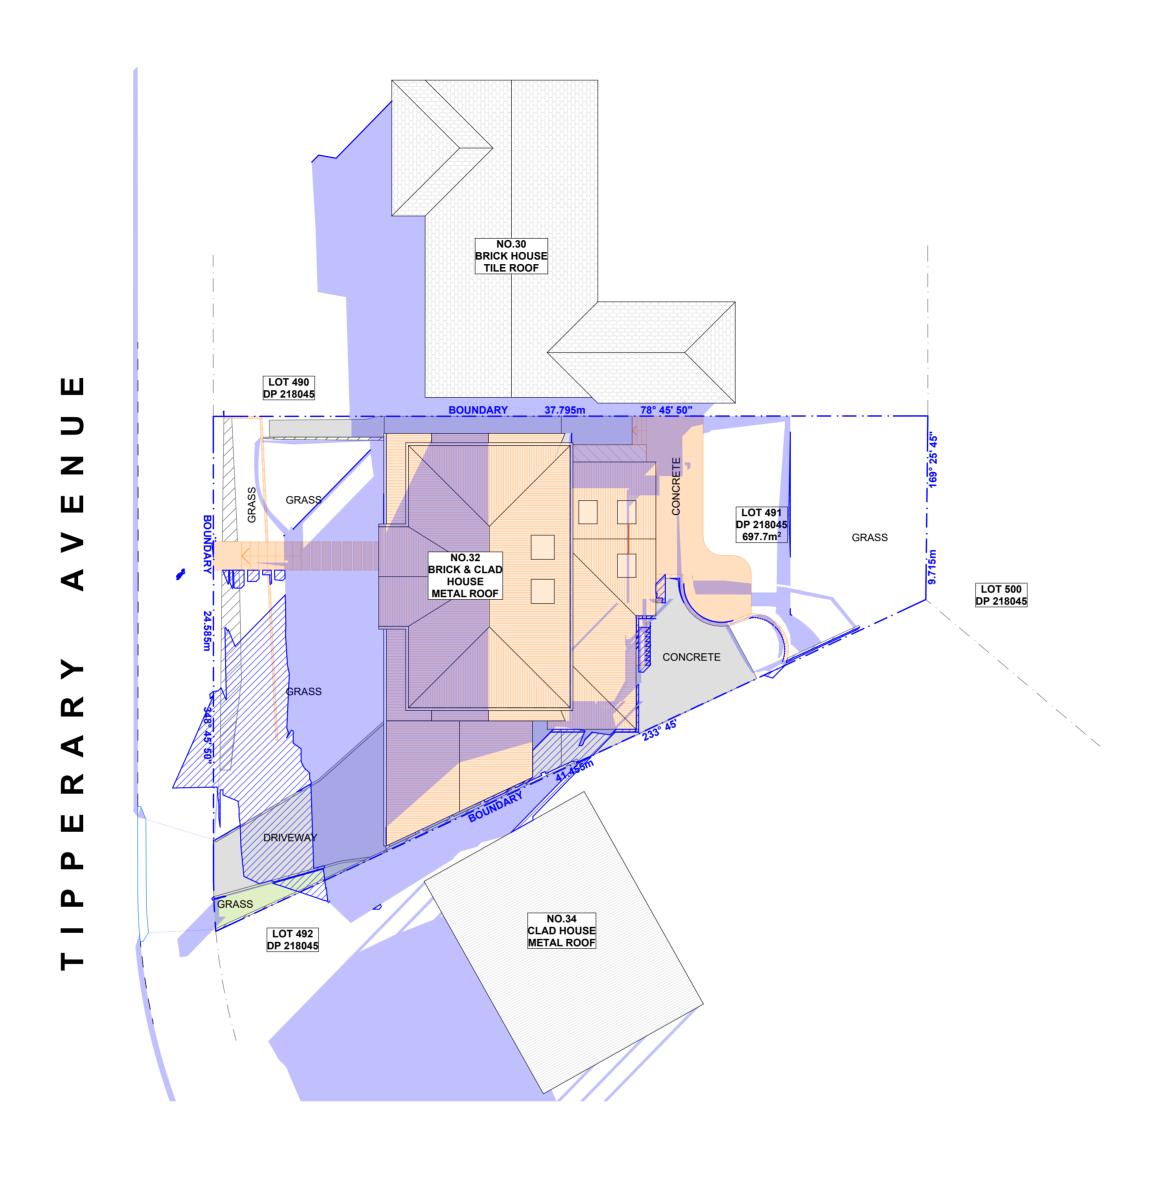

WINTER SOLSTICE 0900

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	ACTION PLANS	,
1		
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u					All errors and omissions are to be verified by the Builder/Contractor and referred to the designer prior to the commencement of works.

1:200

EXISTING SHADOWS

PROPOSED SHADOWS

CLIENT


DANIELA & SAM
ROSSINGTON

PROJECT ADDRESS
32 TIPPERARY
AVENUE, KILLARNEY
HEIGHTS NSW 2087

DA13

DATE Wednesday, 8 May 2024 **DRAWING NAME**WINTER SOLSTICE 9 AM



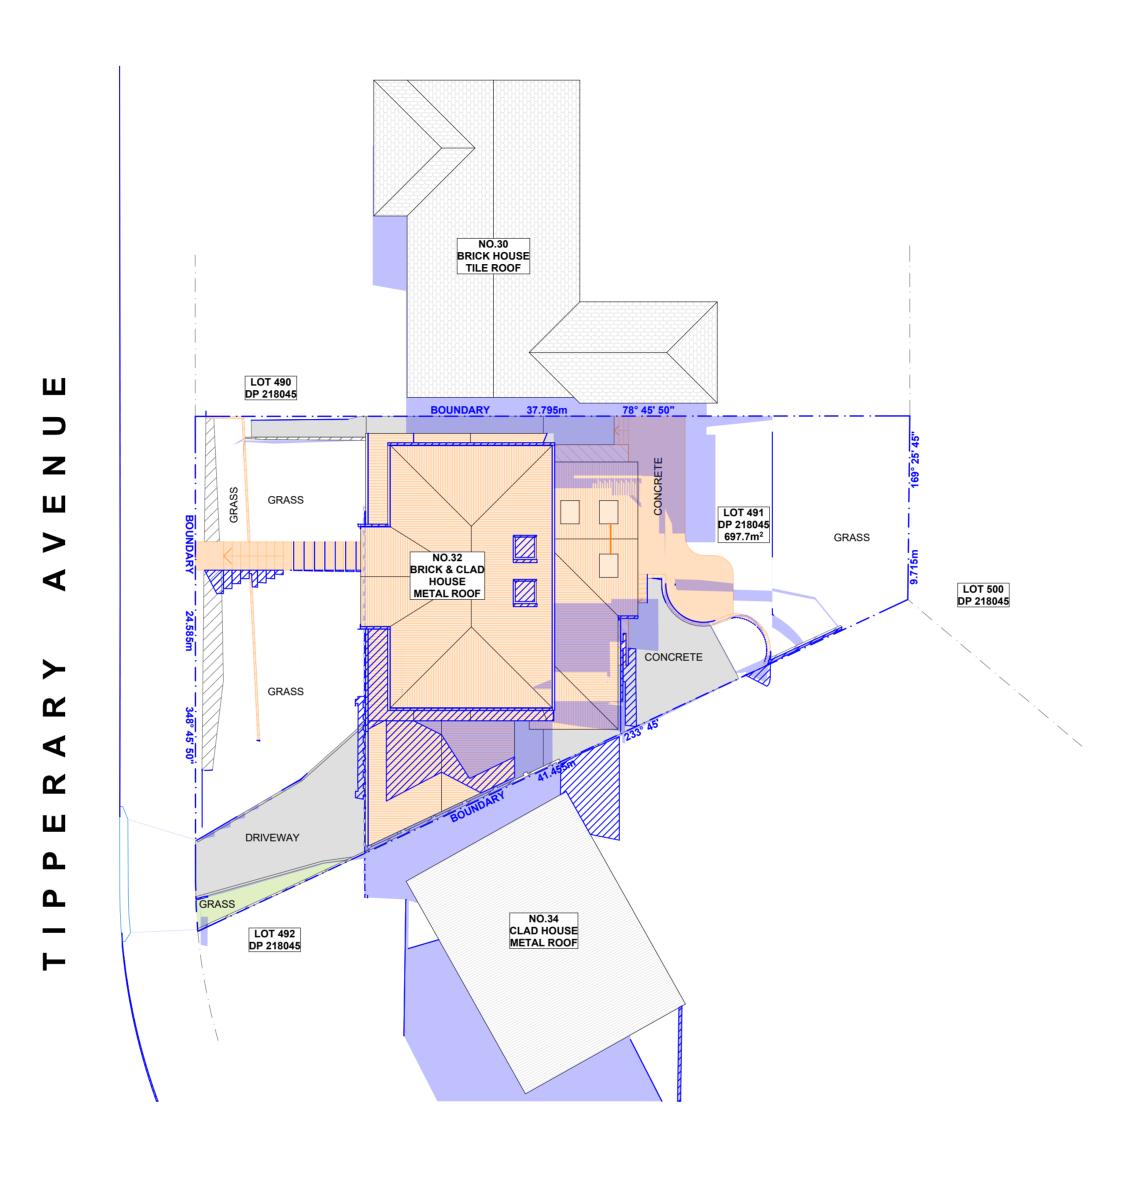

WINTER SOLSTICE 1200

ACTION PLANS

A 27.03.2024 DEVELOPMENT APPLICATION JW altered, rep means in p Action Plans Do not scal are to be us The Builder, dimensions creation of a Meyer was a creation of a All Jerry's All Je

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				All errors and omissions are to be verified by the Builder/Contractor and referred to the designer prior to the
			•	commencement of works.

1:200

LEGEND EXISTING SHADOWS
PROPOSED SHADOWS

CLIENT


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PROJECT ADDRESS
32 TIPPERARY
AVENUE, KILLARNEY
HEIGHTS NSW 2087

DATE
Wednesday, 8 May
2024

DA14 DRAWING NAME
WINTER SOLSTICE 12 PM



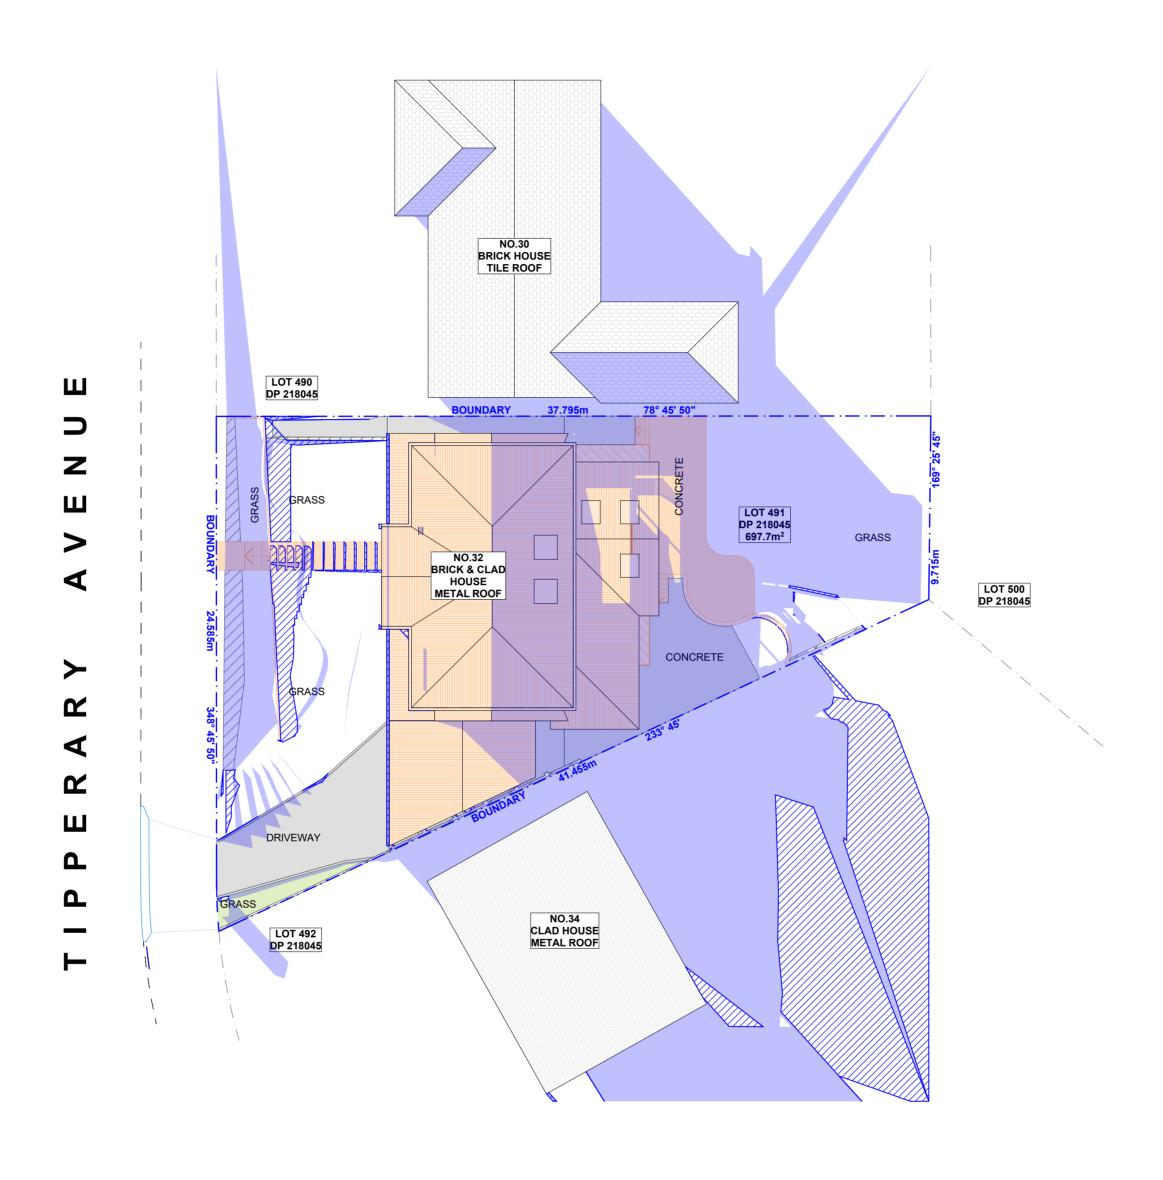

WINTER SOLSTICE 1500

1:200

ACTION PLANS

REV. DATE COMMENTS

A 27.03.2024 DEVELOPMENT APPLICATION

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				dimensions on site prior to commencement of any work, creation of shop drawings, or fabrication of components.	
				All errors and omissions are to be verified by the Builder/Contractor and referred to the designer prior to the	

EXISTING SHADOWS
PROPOSED SHADOWS

CLIENT

DANIELA & SAM
ROSSINGTON

PROJECT ADDRESS
32 TIPPERARY
AVENUE, KILLARNEY
HEIGHTS NSW 2087

DA15

DRAWING NAME

WINTER SOLSTICE 3 PM

Wednesday, 8 May 2024

DATE SCALE

1:200 @A2





Alterations and Additions

Certificate number: A487503_02

This certificate confirms that the proposed development will meet the NSW government's requirements for sustainability, if it is built in accordance with the commitments set out below. Terms used in this certificate, or in the commitments, have the meaning given by the document entitled "BASIX Definitions" dated 10/09/2020 published by the Department. This document is available at www.basix.nsw.gov.au

Secretary
Date of issue: Thursday, 07 March 2024
To be valid, this certificate must be lodged within 3 months of the date of issue.



	page 1/10
Project address	
Project name	0973_02
Street address	32 TIPPERARY AVENUE - KILLARNEY HEIGHTS 2087
Local Government Area	Northern Beaches Council
Plan type and number	Deposited Plan 218045
Lot number	491
Section number	-
Project type	
Dwelling type	Separate dwelling house
Type of alteration and addition	My renovation work is valued at \$50,000 or mo and does not include a pool (and/or spa).
N/A	N/A
Certificate Prepared by (pleas	se complete before submitting to Council or PCA)
Name / Company Name: ACTION PLA	NS PTY LTD
ABN (if applicable): 55660046711	

Glazing requirements	Show on DA Plans	Show on CC/CDC Plans & specs	Certifier Check
Windows and glazed doors			
The applicant must install the windows, glazed doors and shading devices, in accordance with the specifications listed in the table below. Relevant overshadowing specifications must be satisfied for each window and glazed door.	~	~	~
The following requirements must also be satisfied in relation to each window and glazed door:		~	~
Each window or glazed door with standard aluminium or timber frames and single clear or toned glass may either match the description, or, have a U-value and a Solar Heat Gain Coefficient (SHGC) no greater than that listed in the table below. Total system U-values and SHGCs must be calculated in accordance with National Fenestration Rating Council (NFRC) conditions.		~	~
Each window or glazed door with improved frames, or pyrolytic low-e glass, or clear/air gap/clear glazing, or toned/air gap/clear glazing must have a U-value and a Solar Heat Gain Coefficient (SHGC) no greater than that listed in the table below. Total system U-values and SHGCs must be calculated in accordance with National Fenestration Rating Council (NFRC) conditions. The description is provided for information only. Alternative systems with complying U-value and SHGC may be substituted.		~	•
For projections described in millimetres, the leading edge of each eave, pergola, verandah, balcony or awning must be no more than 500 mm above the head of the window or glazed door and no more than 2400 mm above the sill.	~	~	~
Pergolas with polycarbonate roof or similar translucent material must have a shading coefficient of less than 0.35.		~	~
Pergolas with fixed battens must have battens parallel to the window or glazed door above which they are situated, unless the pergola also shades a perpendicular window. The spacing between battens must not be more than 50 mm.		~	

Blazing require	ements						Show on DA Plans	Show on CC/CDC Plans & specs	Certifier Check
lindows and gla	zed doors glazing								
Window/door number	Orientation	Area of glass including frame (m2)	Overshadowing height (m)	Overshadowing distance (m)	Shading device	Frame and glass type			
W11	N	1.63	0	0	eave/ verandah/ pergola/balcony >=750 mm	standard aluminium, single clear, (or U-value: 7.63, SHGC: 0.75)			
W12	E	2.52	0	0	eave/ verandah/ pergola/balcony >=750 mm	standard aluminium, single pyrolytic low-e, (U- value: 5.7, SHGC: 0.47)			
W13	E	2.52	0	0	eave/ verandah/ pergola/balcony >=750 mm	standard aluminium, single pyrolytic low-e, (U- value: 5.7, SHGC: 0.47)			
W14	E	2.52	0	0	eave/ verandah/ pergola/balcony >=750 mm	standard aluminium, single pyrolytic low-e, (U- value: 5.7, SHGC: 0.47)			
W15	E	3.78	0	0	eave/ verandah/ pergola/balcony >=750 mm	standard aluminium, single pyrolytic low-e, (U- value: 5.7, SHGC: 0.47)			

Fixtures and systems	Show on DA Plans	Show on CC/CDC Plans & specs	Certifier Check
Lighting			
The applicant must ensure a minimum of 40% of new or altered light fixtures are fitted with fluorescent, compact fluorescent, or light-emitting-diode (LED) lamps.		~	~
Fixtures			
The applicant must ensure new or altered showerheads have a flow rate no greater than 9 litres per minute or a 3 star water rating.		~	~
The applicant must ensure new or altered toilets have a flow rate no greater than 4 litres per average flush or a minimum 3 star water rating.		~	~
The applicant must ensure new or altered taps have a flow rate no greater than 9 litres per minute or minimum 3 star water rating.			

timber or uPVC, double Lo-Tsol/air gap/clear, (U-value: 2.3, SHGC: 0.19) eave/
verandah/
pergola/balcony
>=900 mm

SHGC: 0.75)

eave/
verandah/
verandah/
verandah/
verandah/
pergola/balcony
>=900 mm

SHGC: 0.75)

standard
aluminium,
single clear, (or
U-value: 7.63,
SHGC: 0.75)

Glazing requir	rements						Show on DA Plans	Show on CC/CDC Plans & specs	Certifier Check
Window/door number	Orientation	Area of glass including frame (m2)	Overshadowing height (m)	Overshadowing distance (m)	Shading device	Frame and glass type			
W16	S	1.63	0	0	eave/ verandah/ pergola/balcony >=750 mm	standard aluminium, single pyrolytic low-e, (U- value: 5.7, SHGC: 0.47)			
D01	E	8.64	0	0	none	timber or uPVC, double Lo-Tsol/air gap/clear, (U-value: 2.3, SHGC: 0.19)			
D02	W	6.75	0	0	eave/ verandah/ pergola/balcony >=900 mm	standard aluminium, single clear, (or U-value: 7.63, SHGC: 0.75)			
D03	W	10.05	0	0	eave/ verandah/ pergola/balcony >=900 mm	standard aluminium, single clear, (or U-value: 7.63, SHGC: 0.75)			
D05	N	6.66	0	0	eave/ verandah/ pergola/balcony >=900 mm	standard aluminium, single clear, (or U-value: 7.63, SHGC: 0.75)			
D06	W	7.1	0	0	eave/ verandah/ pergola/balcony >=900 mm	standard aluminium, single clear, (or U-value: 7.63, SHGC: 0.75)			
W17	E //ronment	0.54	0	0	eave/ verandah/ pergola/balcony >=450 mm	standard aluminium, single clear, (or U-value: 7.63, SHGC: 0.75)	Building S	ilistainability Index www.ba	ısix.nsw.gov.aı
W18	E	2.94	0	0	eave/ verandah/	standard aluminium,			

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Construction	Show on DA Plans	Show on CC/CDC Plans & specs	Certifie Check		
Insulation requirements					
listed in the table below, except that a) addit	red construction (floor(s), walls, and ceilings/ ional insulation is not required where the are of altered construction where insulation alrea	a of new construction is less than 2m2, b)	~	•	~
Construction	Additional insulation required (R-value)	Other specifications			
concrete slab on ground floor.	nil	N/A			
floor above existing dwelling or building.	nil	N/A			
external wall: brick veneer	R1.16 (or R1.70 including construction)				
external wall: framed (weatherboard, fibro, metal clad)	R1.30 (or R1.70 including construction)				
flat ceiling, pitched roof	ceiling: R0.95 (up), roof: foil backed blanket (75 mm)	medium (solar absorptance 0.475 - 0.70)			

lazing requir	ements						Show on DA Plans	Show on CC/CDC Plans & specs	Certifier Check
Window/door number	Orientation	Area of glass including frame (m2)	Overshadowing height (m)	Overshadowing distance (m)	Shading device	Frame and glass type			
W06	E	5.28	0	0	eave/ verandah/ pergola/balcony >=900 mm	standard aluminium, single clear, (or U-value: 7.63, SHGC: 0.75)			
W07	w	1.26	0	0	eave/ verandah/ pergola/balcony >=750 mm	standard aluminium, single pyrolytic low-e, (U- value: 5.7, SHGC: 0.47)			
V08	w	1.26	0	0	eave/ verandah/ pergola/balcony >=750 mm	standard aluminium, single clear, (or U-value: 7.63, SHGC: 0.75)			
W09	w	1.26	0	0	eave/ verandah/ pergola/balcony >=750 mm	standard aluminium, single clear, (or U-value: 7.63, SHGC: 0.75)			
W10	w	1.26	0	0	eave/ verandah/ pergola/balcony >=750 mm	standard aluminium, single clear, (or U-value: 7.63, SHGC: 0.75)			

Glazing requirements	Show on DA Plans	Show on CC/CDC Plans & specs	Certifier Check			
Skylights						
The applicant must install the	~	~	~			
The following requirements	must also be satisfied in relation to each	h skylight:			~	~
Each skylight may either ma listed in the table below.	atch the description, or, have a U-value	and a Solar Heat Gain Coe	fficient (SHGC) no greater than that		~	~
Skylights glazing requirer	nents					
Skylight number	Area of glazing inc. frame (m2)	Shading device	Frame and glass type			
S01	1.625	no shading	timber, low-E internal/argon fill/clear external, (or U-value: 2.5, SHGC: 0.456)			
S02	1.625	no shading	timber, low-E internal/argon fill/clear external, (or U-value: 2.5, SHGC: 0.456)			

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					Action Plans. Do not scale measure from drawings. Figured dimensions are to be used only.
ıu					The Builder/Contractor shall check and verify all levels and dimensions on site prior to commencement of any work, creation of shop drawings, or fabrication of components.
					All errors and omissions are to be verified by the Builder/Contractor and referred to the designer prior to the commencement of works.

LEGEND

CLIENT DANIELA & SAM ROSSINGTON PROJECT ADDRESS

AVENUE, KILLARNEY HEIGHTS NSW 2087

32 TIPPERARY

DATE

DRAWING NO.

DA16

DRAWING NAME BASIX COMMITMENTS

SCALE

@A2

Wednesday, 8 May 2024