

LANDSCAPE PLAN **EROSION & SEDIMENT CONTROL** 

DATE

**BASIX REQUIREMENTS** This development is subject to the requirements of specifications contained in BASIX certificate no. - A401095-02 refer to sheet DA-13 for details

EROSION & SEDIMENT CONTROL


1. CONTRACTOR SHALL PROVIDE SEDIMENT FENCING MATERIAL DURING CONSTRUCTION TO THE LOW SIDE OF THE WORKS. TIE SEDIMENT FENCING MATERIAL TO CYCLONE WIRE SECURITY FENCE. SEDIMENT CONTROL FABRIC SHALL BE AN APPROVED MATERIAL (EG. HUMES PROPEX SILT STOP) STANDING 300mm ABOVE GROUND & EXTENDING 150mm


EXISTING DRAINS LOCATED WITHIN THE SITE SHALL ALSO BE ISOLATED BY SEDIMENT FENCING MATERIAL. 3. NO PARKING OR STOCKPILING OF MATERIALS IS PERMITTED ON THE LOWER SIDE OF THE SEDIMENT FENCE.
GRASS VERGES SHALL BE MAINTAINED AS MUCH AS PRACTICAL TO PROVIDE A BUFFER ZONE TO THE CONSTRUCTION SITE.

CONSTRUCTION ENTRY/EXIT SHALL BE VIA THE LOCATION NOTED ON THE DRAWING. CONTRACTOR SHALL ENSURE ALL

BELOW GROUND.

AMENDEMENT

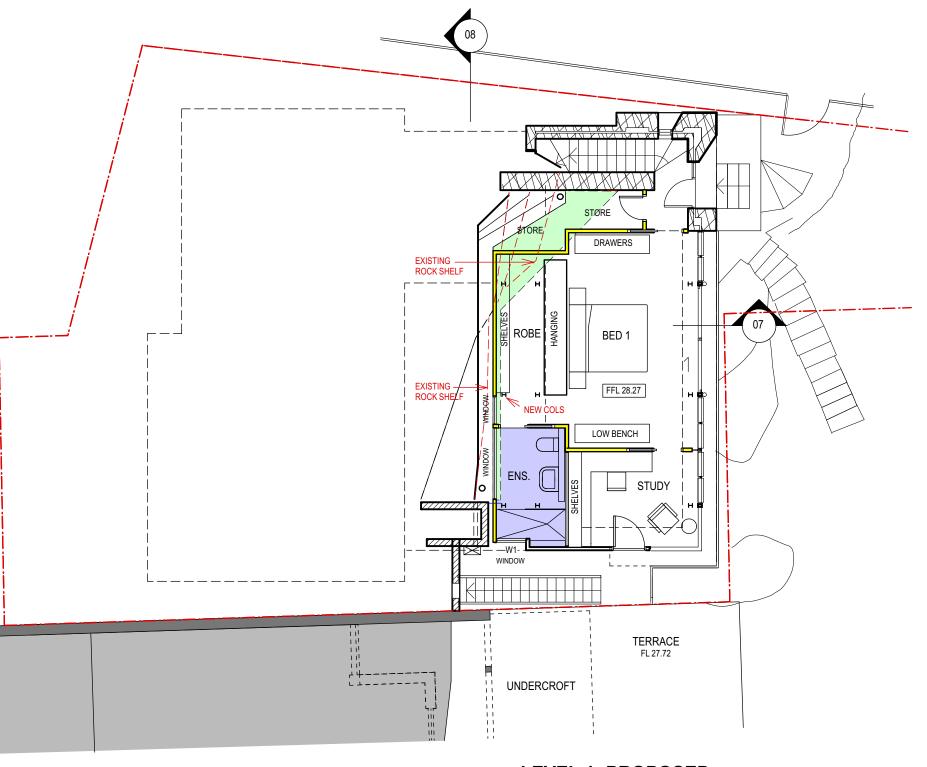

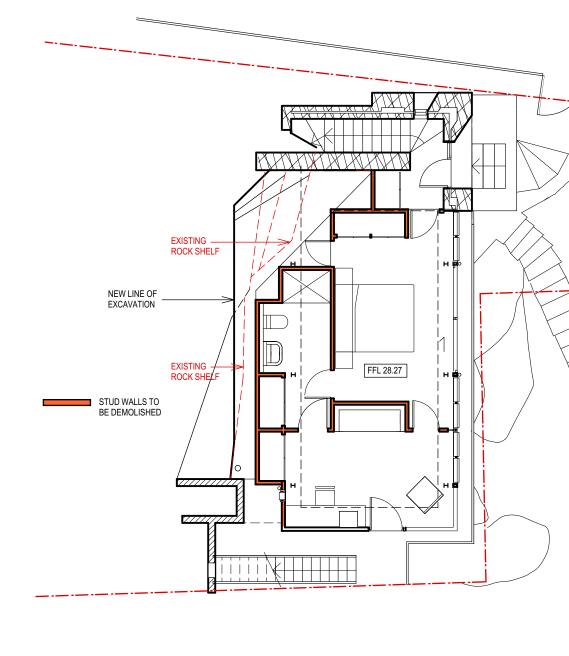

**LEVEL 1- PROPOSED** 

**LEVEL 1- EXISTING & DEMOLITION** 

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AMENDEMENT



JELTE BAKKER


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VALDIS MACENS ARCHITECTS P/L 145 OBERON STREET, COOGEE NSW 2034

Nominated Architect: Valdis Macens NSWARB reg. no. 4953 MOB: 0438 007 019 EMAIL: valdismacens@iinet.net.au

**ALTERATIONS & ADDITIONS** 17A CROWN ROAD QUEENSCLIFF 2096

**LEVEL 1 PLANS** 

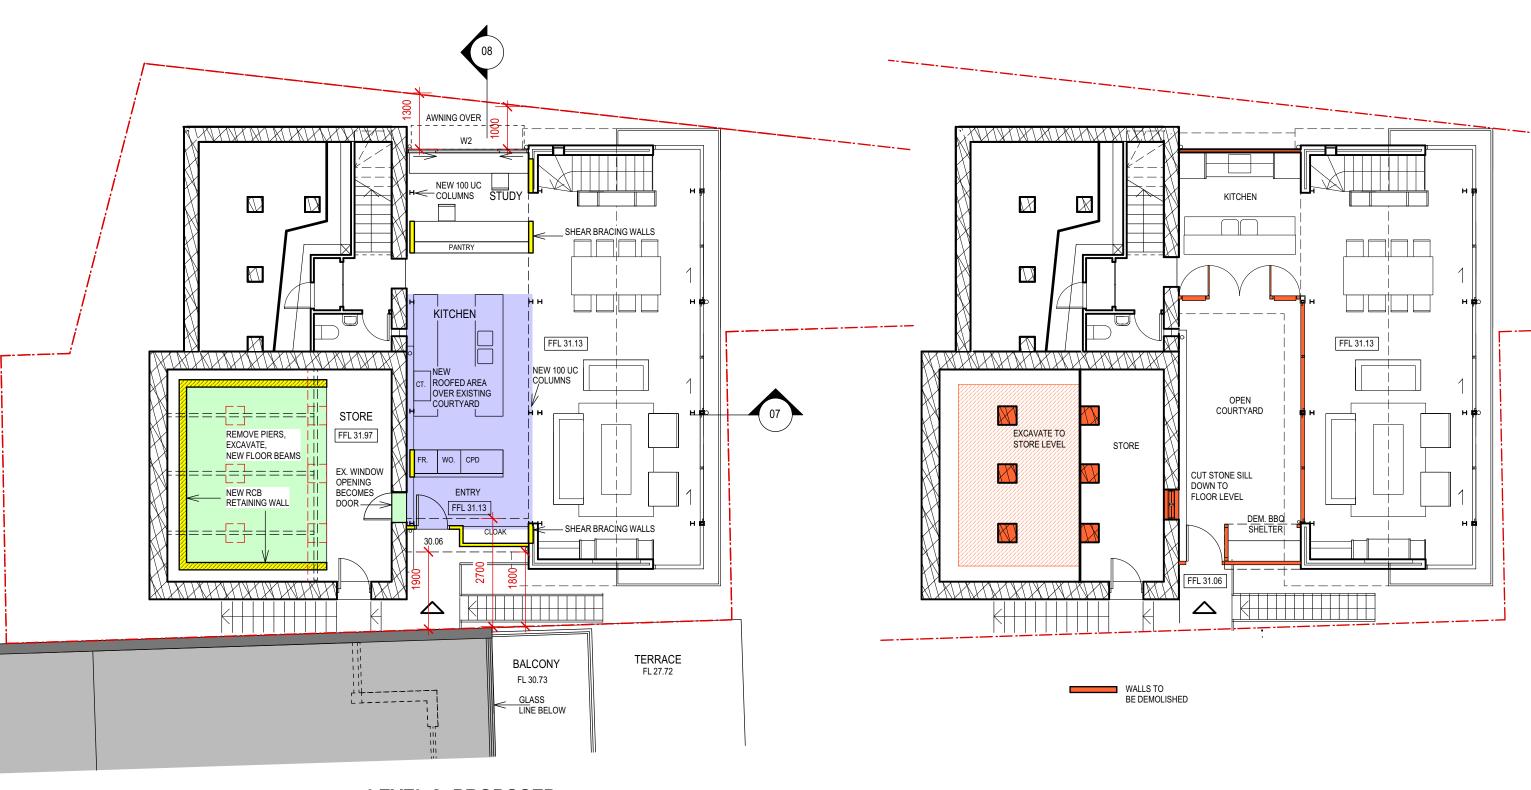

**LEVEL 2- PROPOSED** 

### **LEVEL 2- EXISTING & DEMOLITION**

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AMENDEMENT

CLIENT

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ARCHITECT

## VALDIS MACENS ARCHITECTS P/L


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ALTERATIONS & ADDITIONS
17A CROWN ROAD
QUEENSCLIFF 2096

DRAWING

## **LEVEL 2 PLANS**

SCALE 1:100 DATE DEC

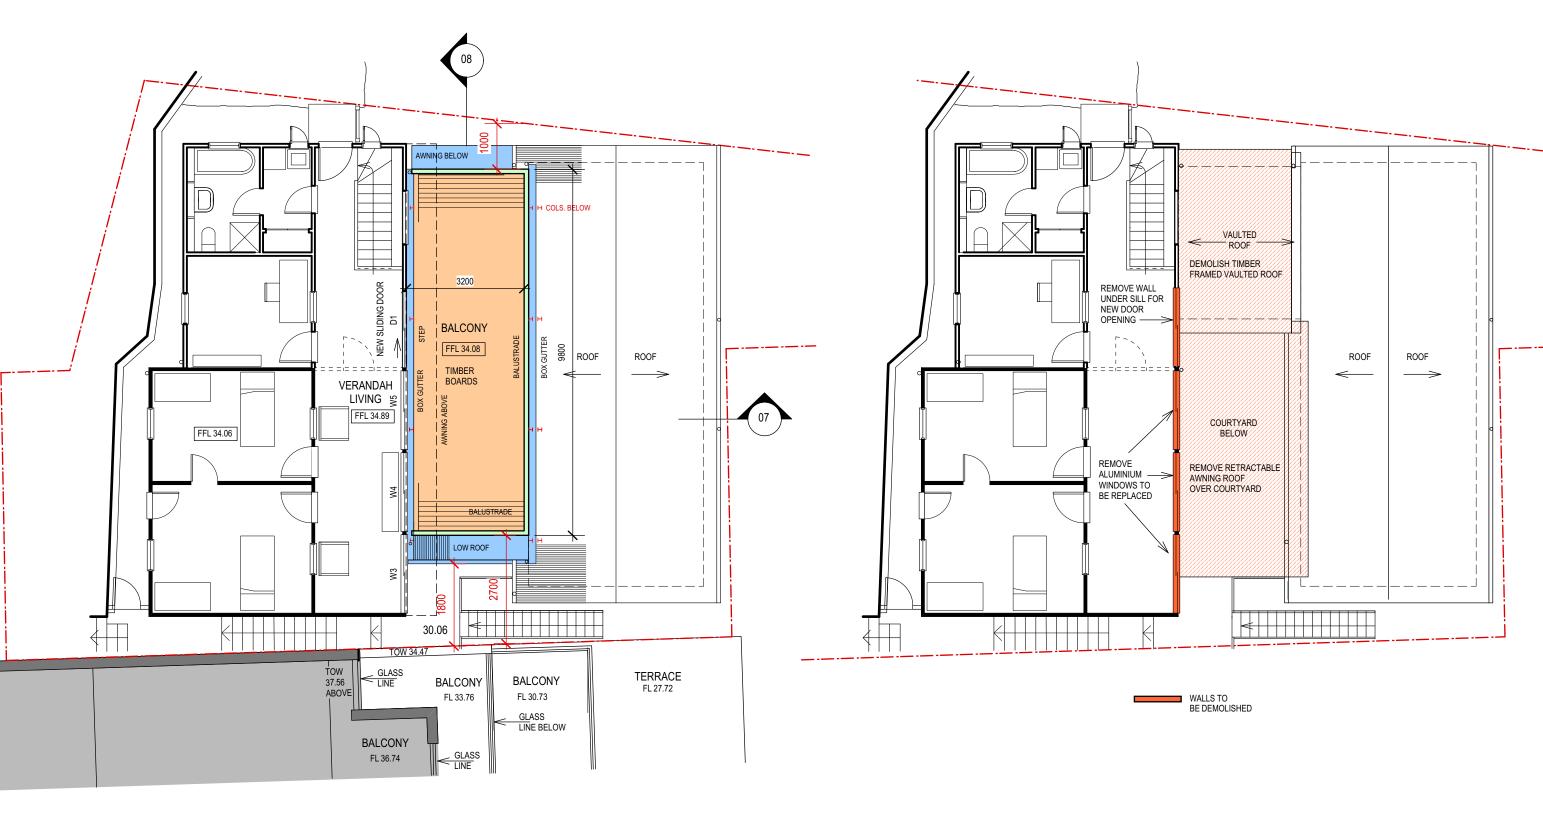

**LEVEL 3- PROPOSED** 

### **LEVEL 3- EXISTING & DEMOLITION**

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AMENDEMENT



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17A CROWN ROAD
QUEENSCLIFF 2096

DRAWING

**LEVEL 3 PLAN** 


SCALE 1:100 @ A3
DATE DECEMBER 2020
DRAWN VM DWG NO.

BER 2020 DWG NO. **DA-05** 



D.P. 5494

D.P. 130462

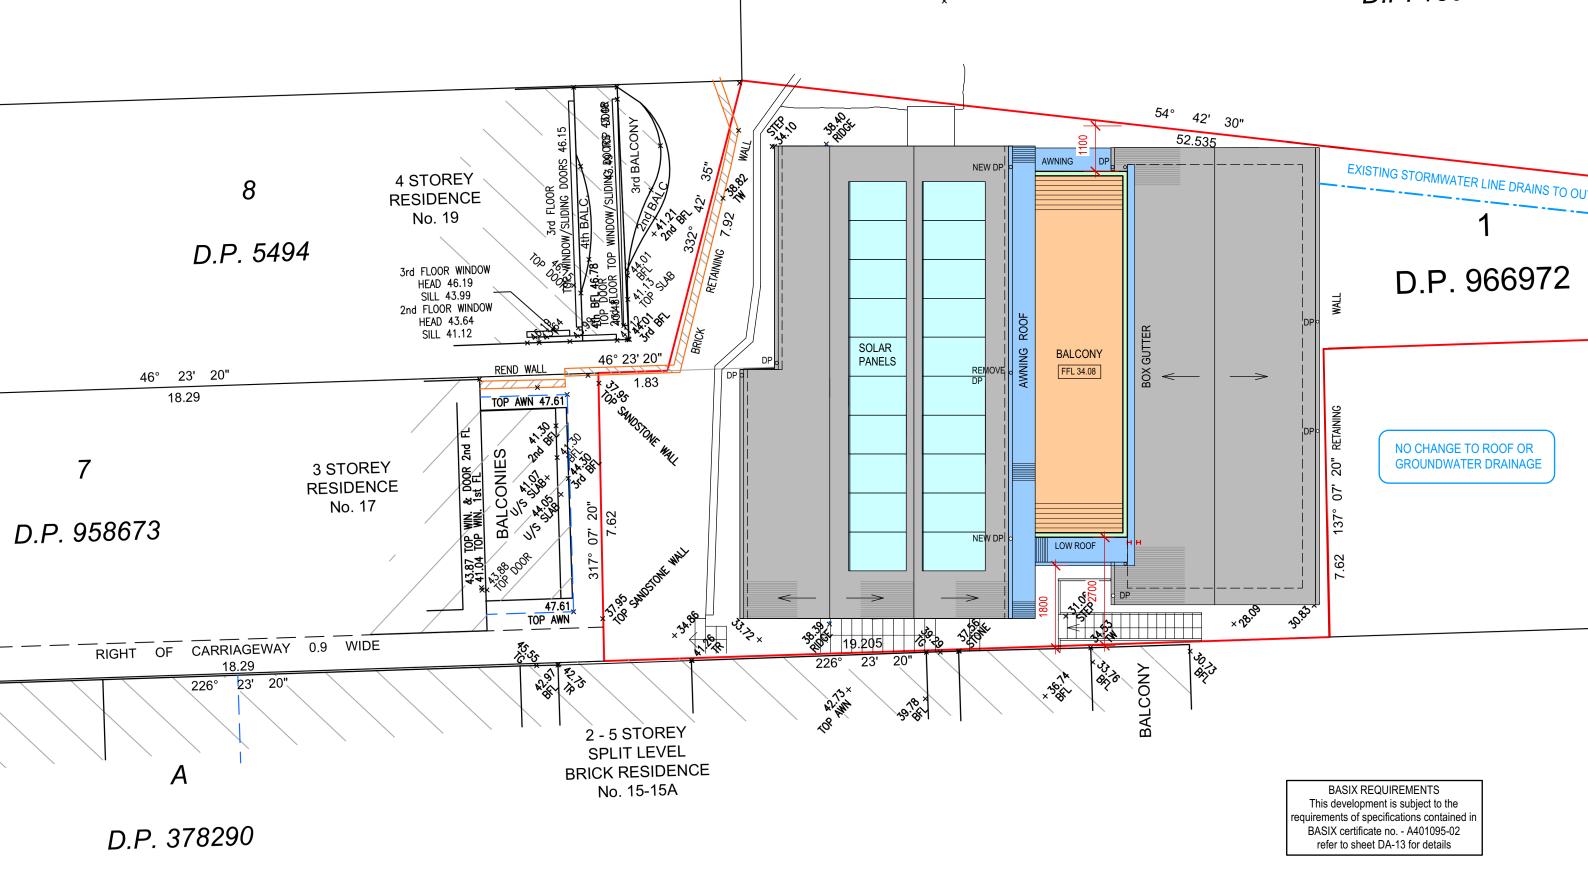

AMENDEMENT



JELTE BAKKER

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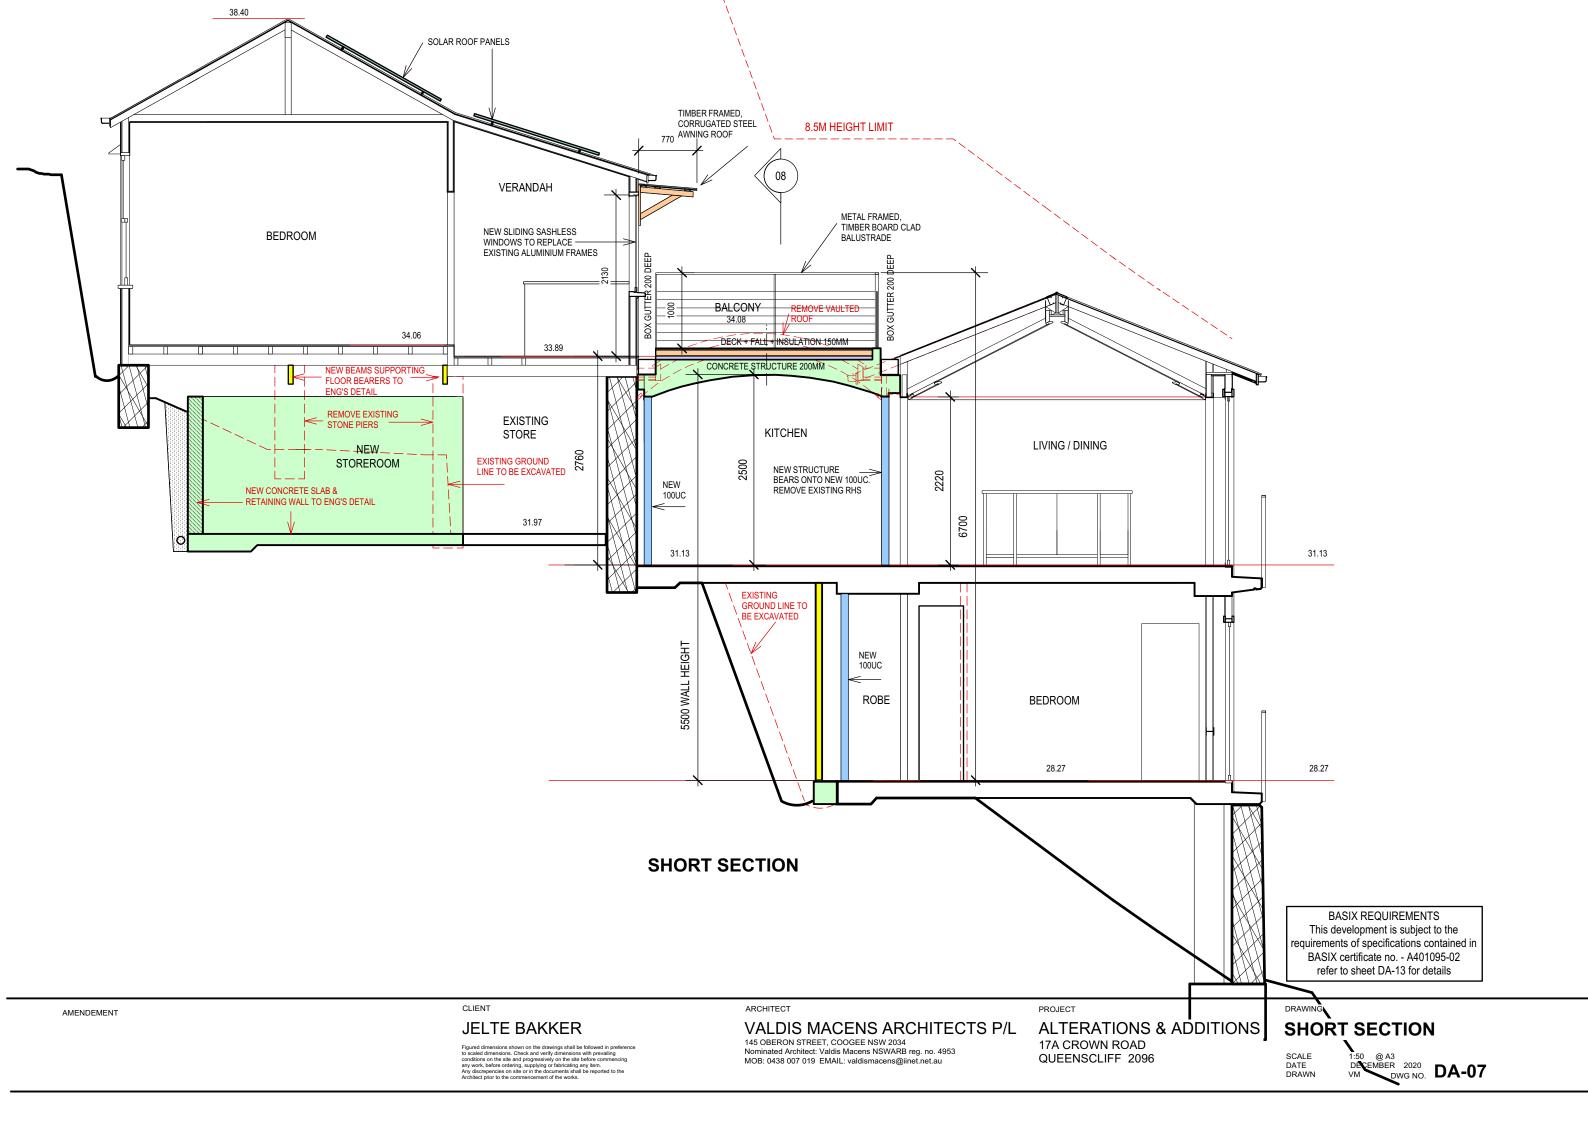
VALDIS MACENS ARCHITECTS P/L 145 OBERON STREET, COOGEE NSW 2034


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**ALTERATIONS & ADDITIONS** 17A CROWN ROAD QUEENSCLIFF 2096

STORMWATER MANAGEMENT **ROOF PLAN** 

SCALE DATE DRAWN



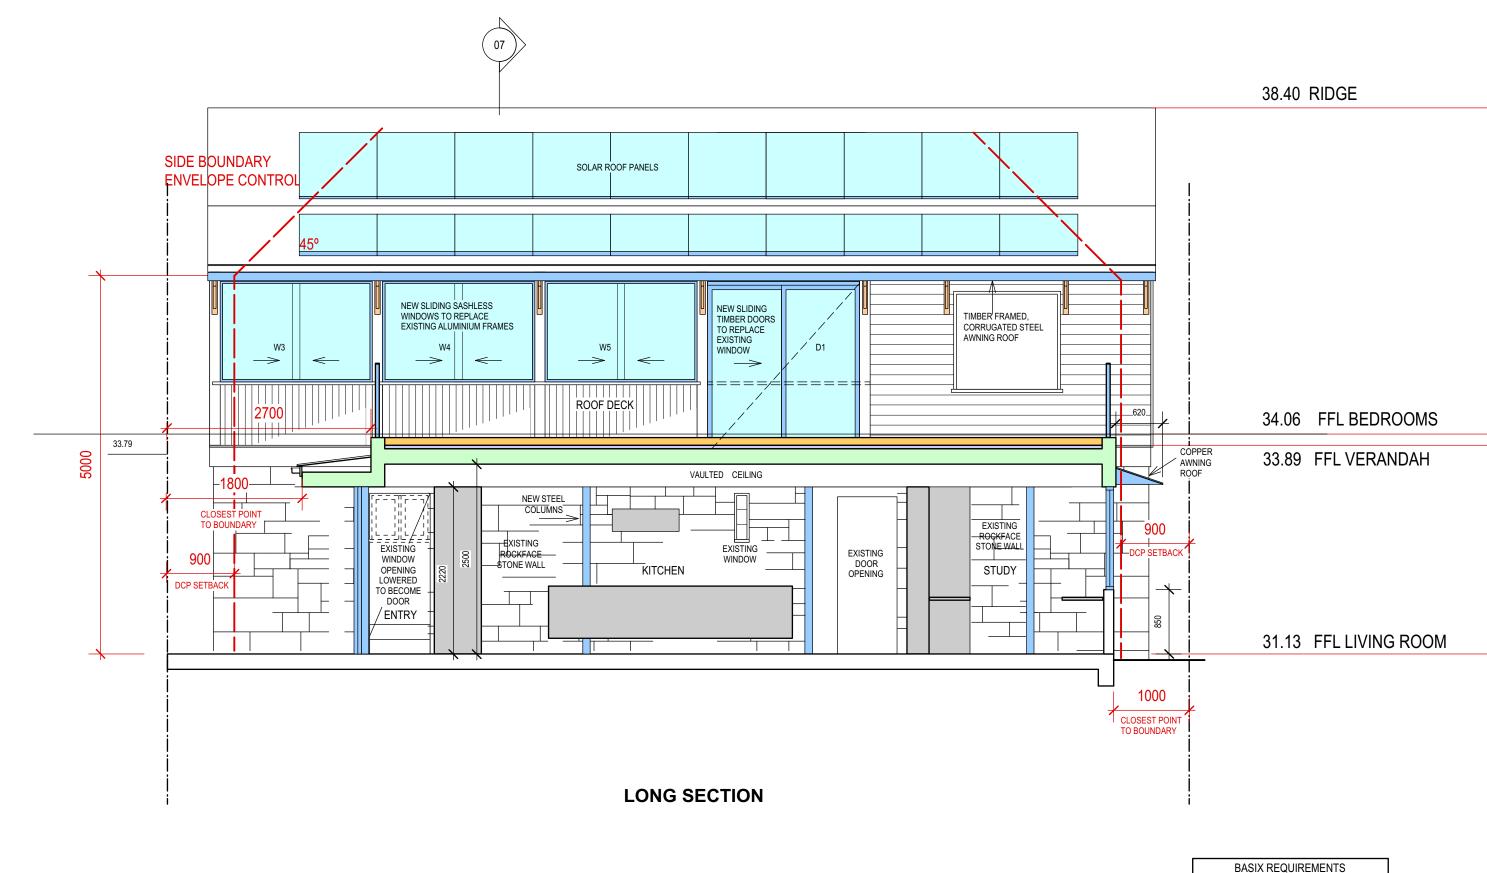

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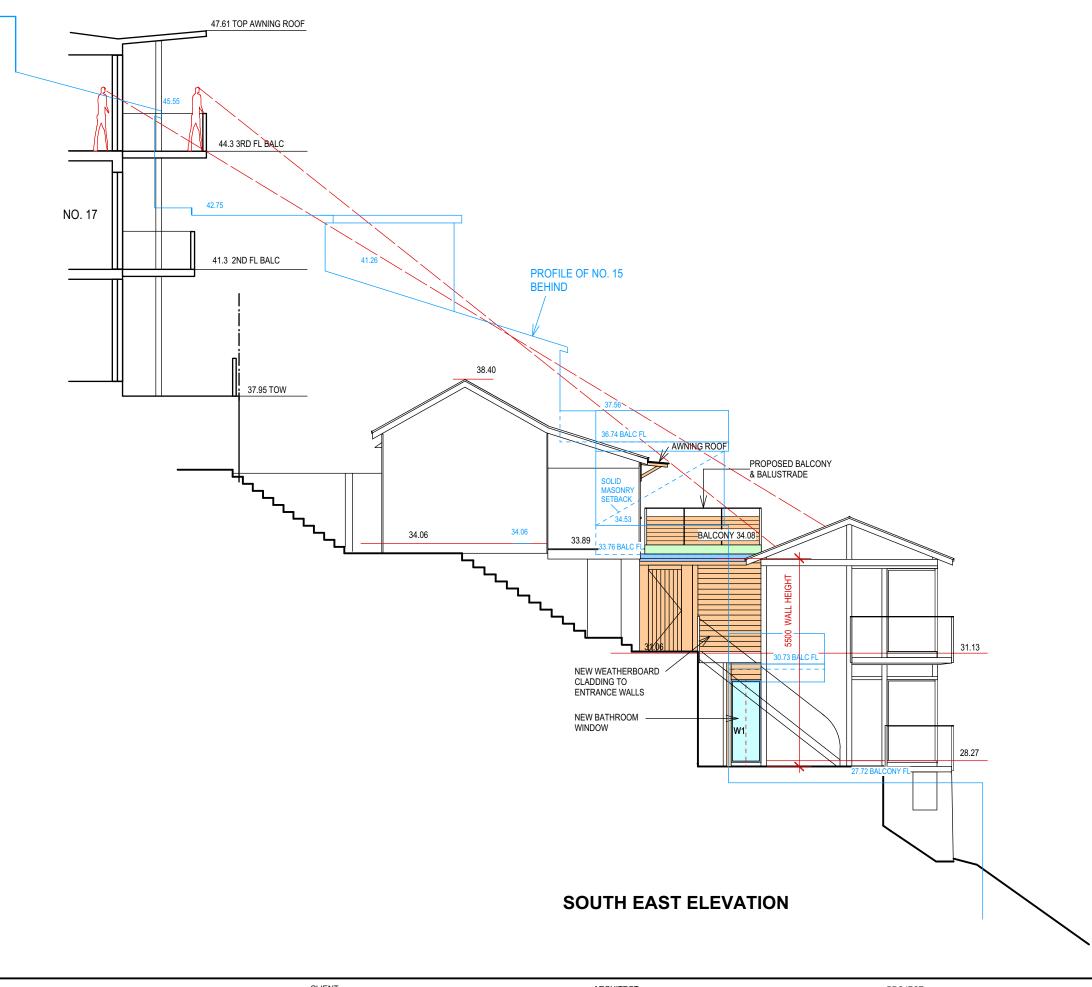
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**ALTERATIONS & ADDITIONS** 17A CROWN ROAD QUEENSCLIFF 2096

### **LONG SECTION**

SCALE DATE DRAWN



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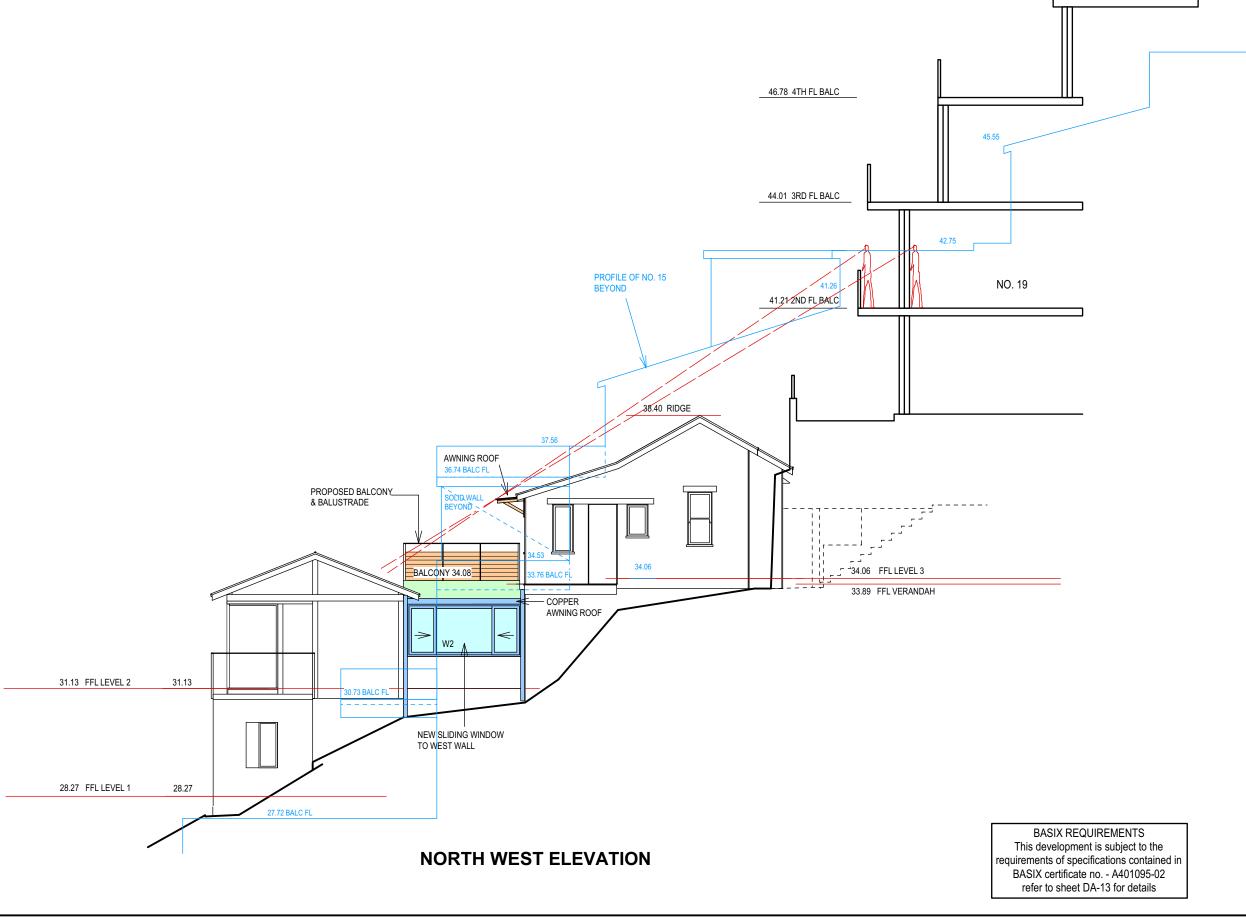
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**ALTERATIONS & ADDITIONS** 17A CROWN ROAD QUEENSCLIFF 2096

## **SOUTH EAST ELEVATION**



AMENDEMENT

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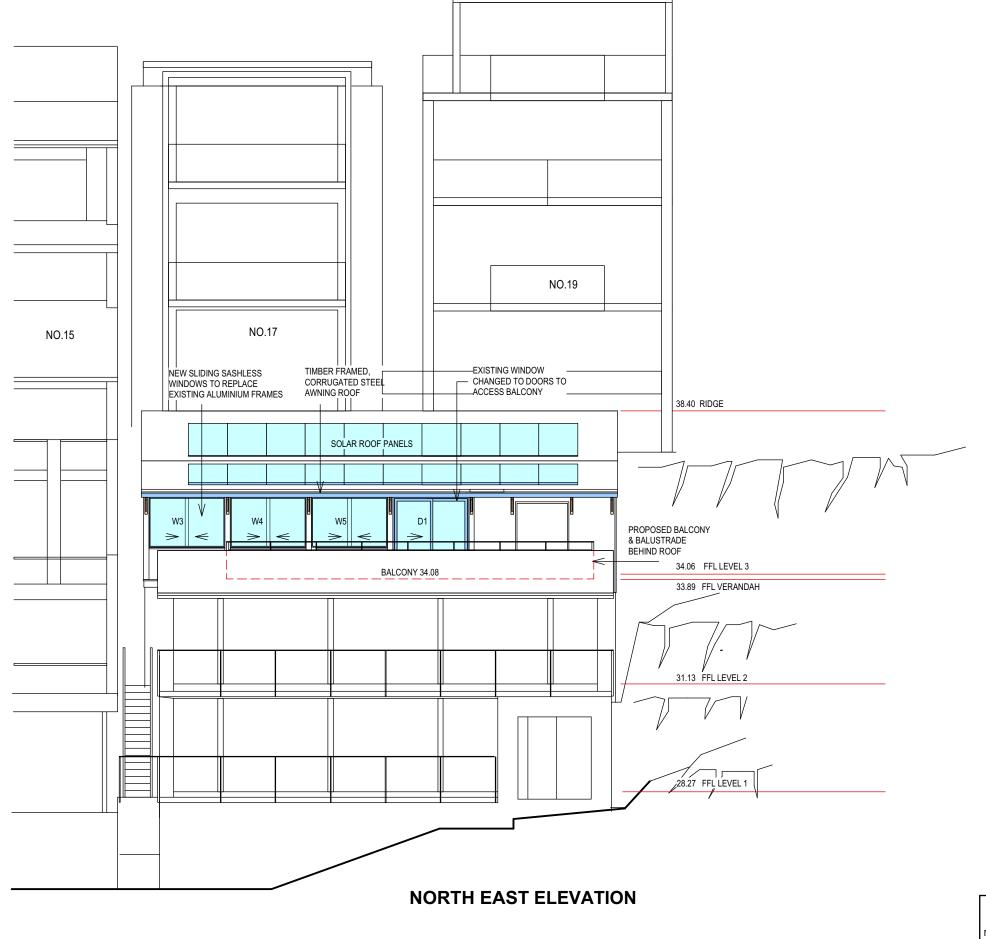
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**ALTERATIONS & ADDITIONS** 17A CROWN ROAD QUEENSCLIFF 2096

# **NORTH WEST ELEVATION**

SCALE DATE DRAWN



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AMENDEMENT

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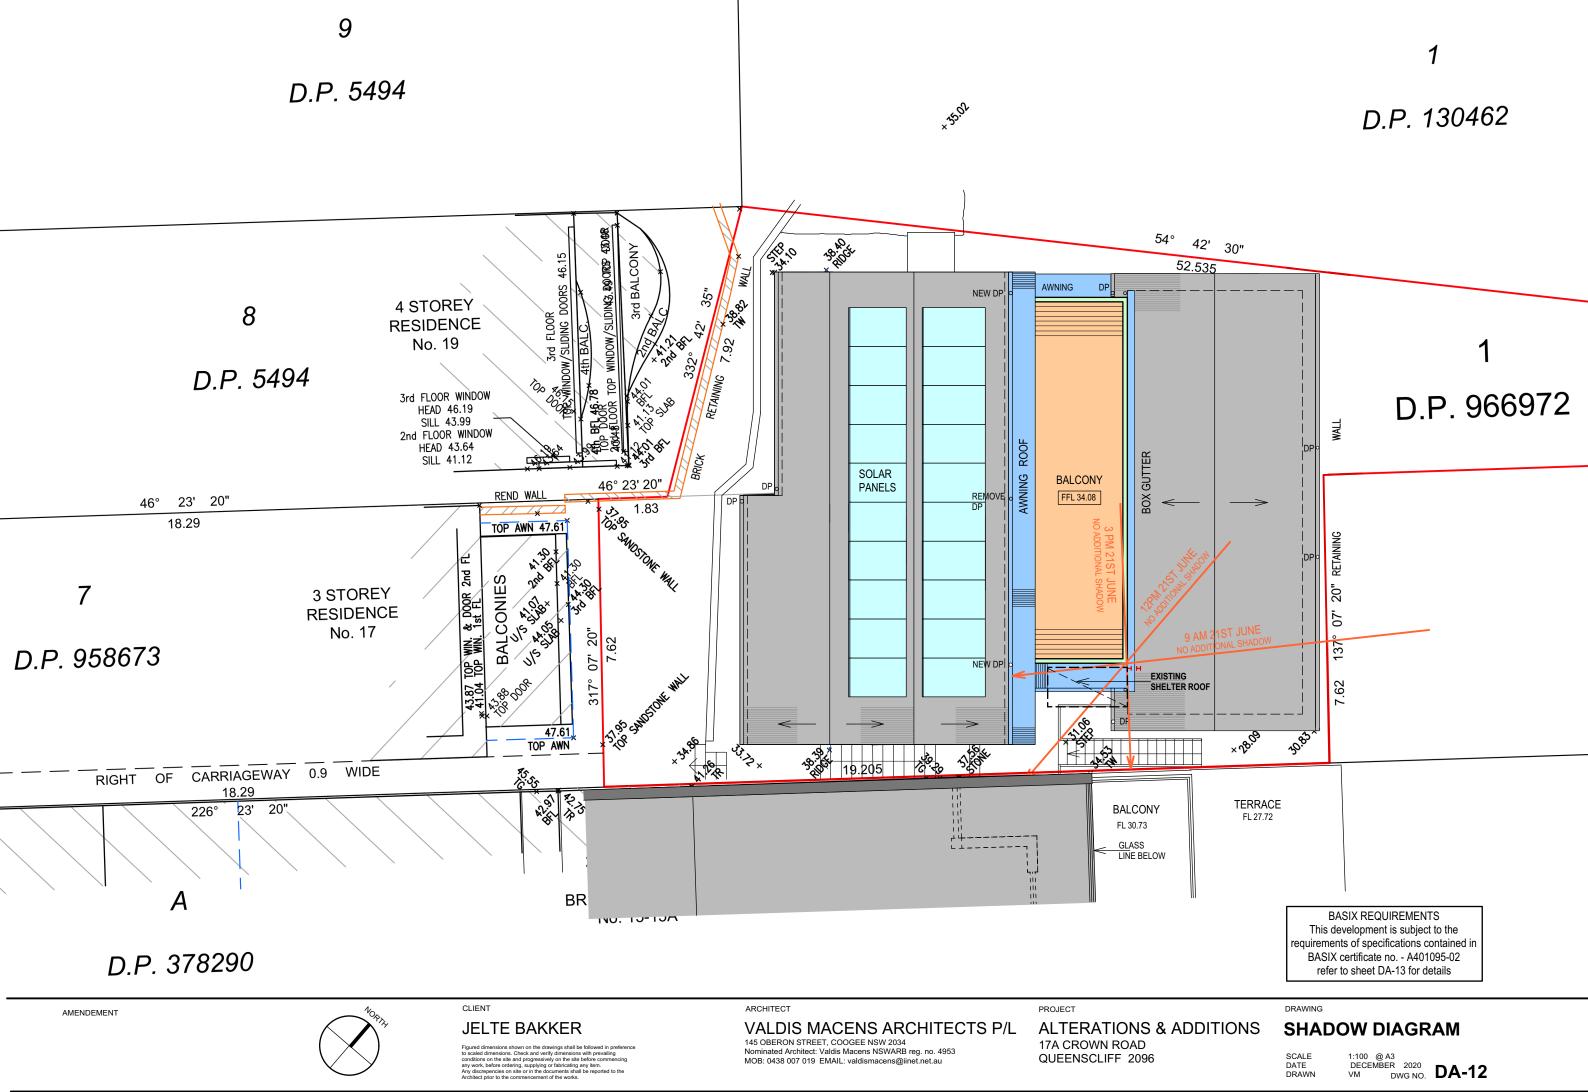
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**ALTERATIONS & ADDITIONS** 17A CROWN ROAD QUEENSCLIFF 2096

### **NORTH EAST ELEVATION**



# **BASIX** Certificate

Building Sustainability Index www.basix.nsw.gov.au

#### **Alterations and Additions**

Certificate number: A401095\_02

This certificate confirms that the proposed development will meet the NSW government's requirements for sustainability, if it is built in accordance with the commitments set out below. Terms used in this certificate, or in the commitments, have the meaning given by the document entitled "BASIX Alterations and Additions Definitions" dated 06/10/2017 published by the Department. This document is available at www.basix.nsw.gov.au

Secretary
Date of issue: Wednesday, 16, December 2020
To be valid, this certificate must be lodged within 3 months of the date of issue.

Planning, Industry & Environment

Project address				
Project name	17A Crown Road_02			
Street address	17A Crown Road Queenscliff 2096			
Local Government Area	Northern Beaches Council			
Plan type and number	Deposited Plan 577905			
Lot number	1			
Section number				
Project type				
Dwelling type	Separate dwelling house			
Type of alteration and addition	My renovation work is valued at \$50,000 or more and does not include a pool (and/or spa).			

Certificate Prepared by (please complete before submitting to Council or PCA)

Name / Company Name: The House Energy Rating Company of Aust. Pty Ltd

ABN (if applicable): 61495952256

Fixtures and systems			Show on DA Plans	Show on CC/CDC Plans & specs	Certifier Check
Lighting					
The applicant must ensure a minimum of 40% of light-emitting-diode (LED) lamps.		<b>✓</b>	<b>~</b>		
Fixtures			•		
The applicant must ensure new or altered show		V	✓		
The applicant must ensure new or altered toilet		✓	✓		
The applicant must ensure new or altered taps		✓			
Construction			Show on DA Plans	Show on CC/CDC Plans & specs	Certifier Check
Insulation requirements					
The applicant must construct the new or altered the table below, except that a) additional insula is not required for parts of altered construction	<b>~</b>	<b>√</b>	~		
Construction	Additional insulation required (R-value)	Other specifications			
concrete slab on ground floor.	nil				
floor above existing dwelling or building.	nil				
external wall: framed (weatherboard, fibro, metal clad)	R1.30 (or R1.70 including construction)				
flat ceiling, flat roof: concrete/bare internal	ceiling: R0.43 (up), roof: 50 mm foil backed polystyrene board	medium (solar absorptance 0.475 - 0.70)			

es

Glazing requ	irements						Show on DA Plans	Show on CC/CDC Plans & specs	Certifier Check
Windows and glazed doors									
The applicant must install the windows, glazed doors and shading devices, in accordance with the specifications listed in the table below. Relevant overshadowing specifications must be satisfied for each window and glazed door.					~	<b>✓</b>	<b>✓</b>		
The following requirements must also be satisfied in relation to each window and glazed door:						✓	✓		
Each window or glazed door with standard aluminium or timber frames and single clear or toned glass may either match the description, or, have a U-value and a Solar Heat Gain Coefficient (SHGC) no greater than that listed in the table below. Total system U-values and SHGCs must be calculated in accordance with National Fenestration Rating Council (NFRC) conditions.							~	<b>✓</b>	
For projections described as a ratio, the ratio of the projection from the wall to the height above the window or glazed door sill must be at least that shown in the table below.						✓	✓	✓	
Overshadowing buildings or vegetation must be of the height and distance from the centre and the base of the window and glazed door, as specified in the 'overshadowing' column in the table below.						<b>✓</b>	✓	<b>✓</b>	
Windows an	nd glazed o	doors g	lazing r	equireme	nts				
Window / door Orientation				dowing	Shading device	Frame and glass type			
no.		glass inc. frame (m2)	Height (m)	Distance (m)					
W1	SE	1.9	0	0	none	standard aluminium, single clear, (or U-value: 7.63, SHGC: 0.75)			
W2	NW	4.2	0	0	projection/height above sill ratio >=0.43	standard aluminium, single clear, (or U-value: 7.63, SHGC: 0.75)			
W3	NE	2.6	0	0	projection/height above sill ratio >=0.43	standard aluminium, single clear, (or U-value: 7.63, SHGC: 0.75)			
W4	NE	2.6	0	0	projection/height above sill ratio >=0.43	standard aluminium, single clear, (or U-value: 7.63, SHGC: 0.75)			
W5	NE	2.6	0	0	projection/height above sill ratio >=0.43	standard aluminium, single clear, (or U-value: 7.63, SHGC: 0.75)			
D1	NE	4.2	1	3	projection/height above sill ratio >=0.36	standard aluminium, single clear, (or U-value: 7.63, SHGC: 0.75)			
Legend									

In these commitments, "applicant" means the person carrying out the development.

Commitments identified with a "\rightsym" in the "Show on DA plans" column must be shown on the plans accompanying the development application for the proposed development (if a development application is to be lodged for the proposed development).

Commitments identified with a "
 " in the "Show on CC/CDC plans & specs" column must be shown in the plans and specifications accompanying the application for a construction certificate / complying development certificate for the proposed development.

Commitments identified with a "\rightarrow" in the "Certifier check" column must be certified by a certifying authority as having been fulfilled, before a final occupation certificate for the development may be issued.

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145 OBERON STREET, COOGEE NSW 2034

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17A CROWN ROAD
QUEENSCLIFF 2096

DRAWING


**FINISHES & MATERIALS** 


SCALE DATE DRAWN @ A3 DECEMBER 2020 VM DWG NO

DWG NO. **DA-13** 

### **LEVEL 1 & 2-2001 ADDITION**

### **LEVEL 3- ORIGINAL 1910 COTTAGE**

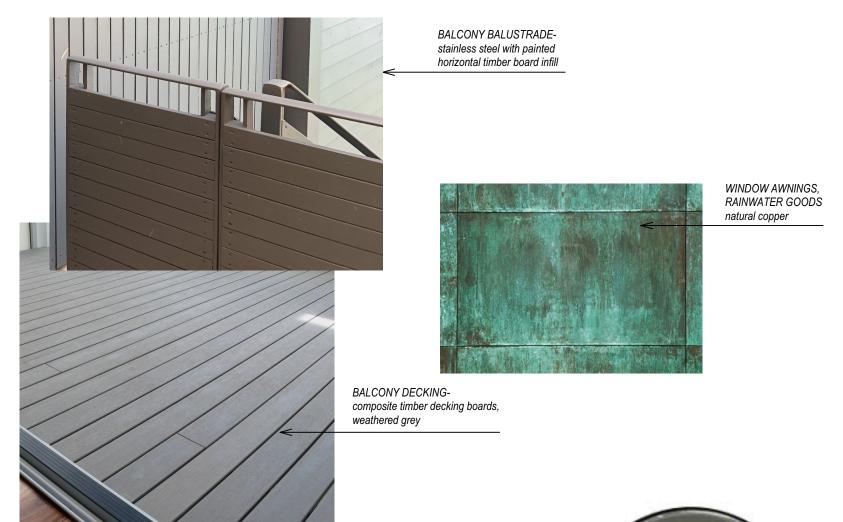

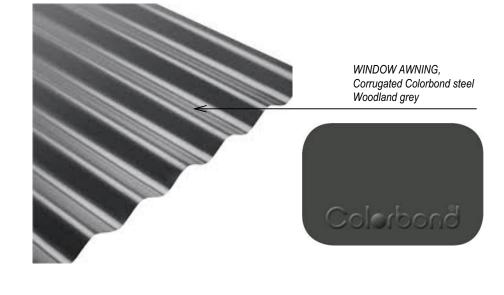



WEATHERBOARD CLADDING, ARCHITECTURAL TIMBERWORK to match existing colour, equal to Resene Black White



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st



WEATHERBOARD/ BALUSTARDE CLADDINGto match existing colourequal to Resene Tapa

AMENDEMENT

ALUMINIUM DOORS & WINDOWS-Dulux powdercoat Transformer Grey

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# **ALTERATIONS & ADDITIONS** 17A CROWN ROAD QUEENSCLIFF 2096

## **FINISHES & MATERIALS**