

Warriewood Bazem

Lot 11 Warriewood


Drawings

No	Rev	Drawing
A0000		Perspective Views, Notes, Areas
A1000		Site Plan
A1001		Landscape Plan
A2100		Ground Floor Plan
A2101		First Floor Plan
A2102		Roof Plan
A2400		Electrical Plans
A2401		Lighting Calculation
A2500		Shadow Diagrams
A3000		Elevations
A3001		Elevations
A3100		Sections
A3101		Sections 2
A6000		D & W Window Schedule

General Notes

Render 1

External colour schedule

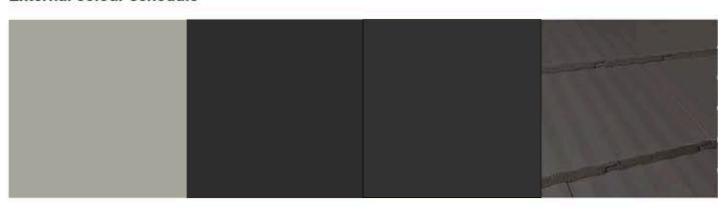

Cladding Garage Resene Foggy Grey Resene Nocturnal Monument **Boral Contour Gunmetal**

Note: colours indicative only and should not be used as a true representation of the product

Areas (for Building Permit purposes only)

	Lot 11		
Unit	Area	Measured Area	
L11-1	01 GF Living Area	61.96	
L11-1	02 FF Living Area	70.06	
L11-1	03 Garage	20.20	
L11-1	05 Porch	1.04	
		153.26 m²	
L11-2	01 GF Living Area	61.96	
L11-2	02 FF Living Area	70.06	
L11-2	03 Garage	20.20	
L11-2	05 Porch	1.04	X
		153.26 m²	
		306.52 m²	TY

NUTES Builder/Contractor shall verify job dimensions before any job commences. Figured dimensions take precedence over drawings and job dimensions. All shop drawings shall be submited to the Architect/Consultant, and manufacture shall not commence prior to return of inspected shop drawings by the Architect/Consultant.

Architect

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Rev Description

Roof

Client Details client

Project Warriewood Bazem Lot 11 Warriewood

Drawing Cover Sheets Perspective Views, Notes, Areas

Project Status PRELIMINARY - not for construction

Scale Drawn BK Checked ML Drawing Number A0000

Project Number 11268

Site Plan Lot 11 1:200

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Rev Description

Client Details client

Project Warriewood Bazem

Lot 11 Warriewood

Project Number 11268

Project Status PRELIMINARY - not for construction Scale Drawn BK Checked ML Drawing Number A1000 Revision

Site Plan





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Rev Description

Client Details client

Project Warriewood Bazem Lot 11 Warriewood

Landscape Plan

Project Status PRELIMINARY - not for construction

Scale Drawn BK Checked ML Drawing Number A1001 Revision

Project Number 11268







Project Warriewood Bazem

Lot 11 Warriewood

Project Number 11268

Note:

THE DWELLING IS TO BE

WITH AS 3660.1-2000


PROTECTED FROM TERMITE INFESTATION IN ACCORDANCE

Drawing General Arrangement Plans Ground Floor Plan

Project Status PRELIMINARY - not for construction

Scale Drawn BK Checked ML

Drawing Number A2100

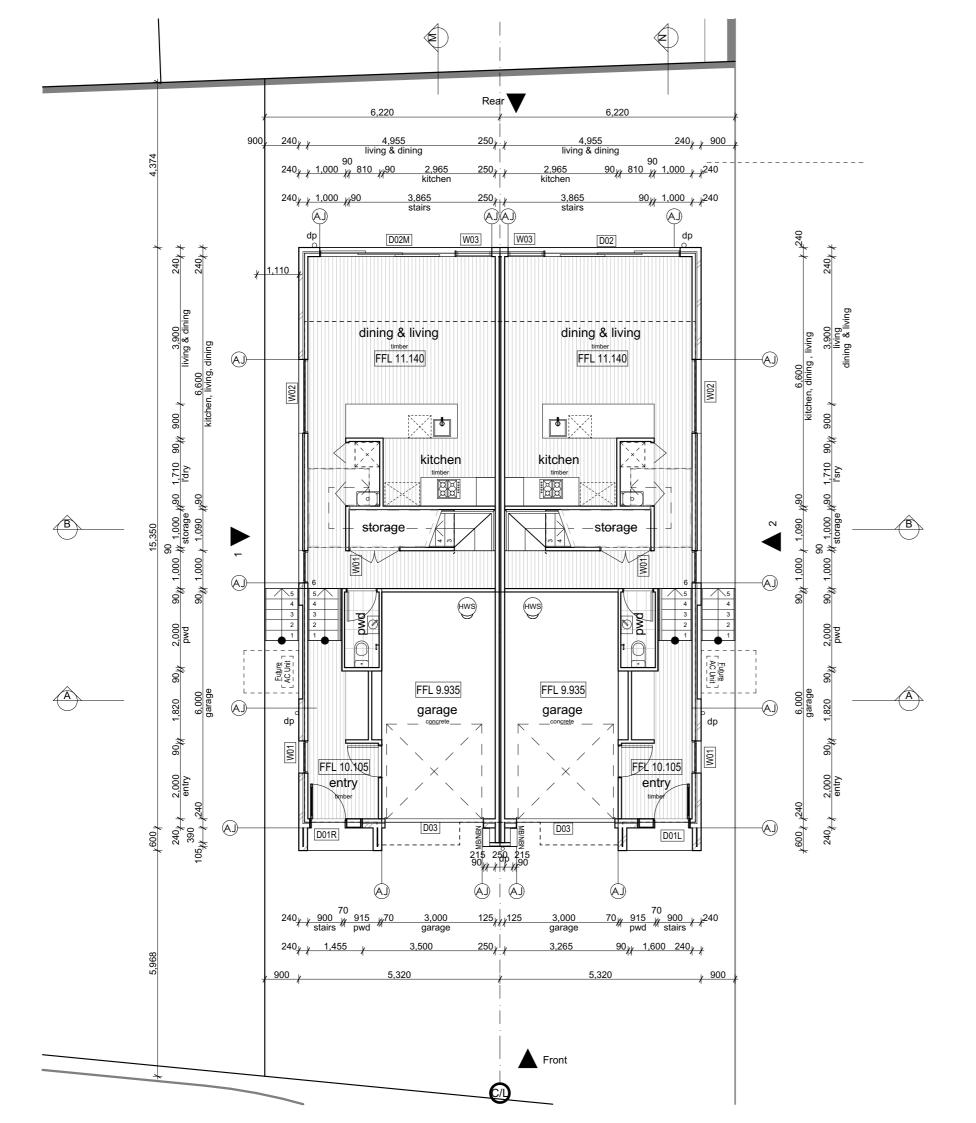




Drawing General Arrangement Plans First Floor Plan

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Drawing Number A2101



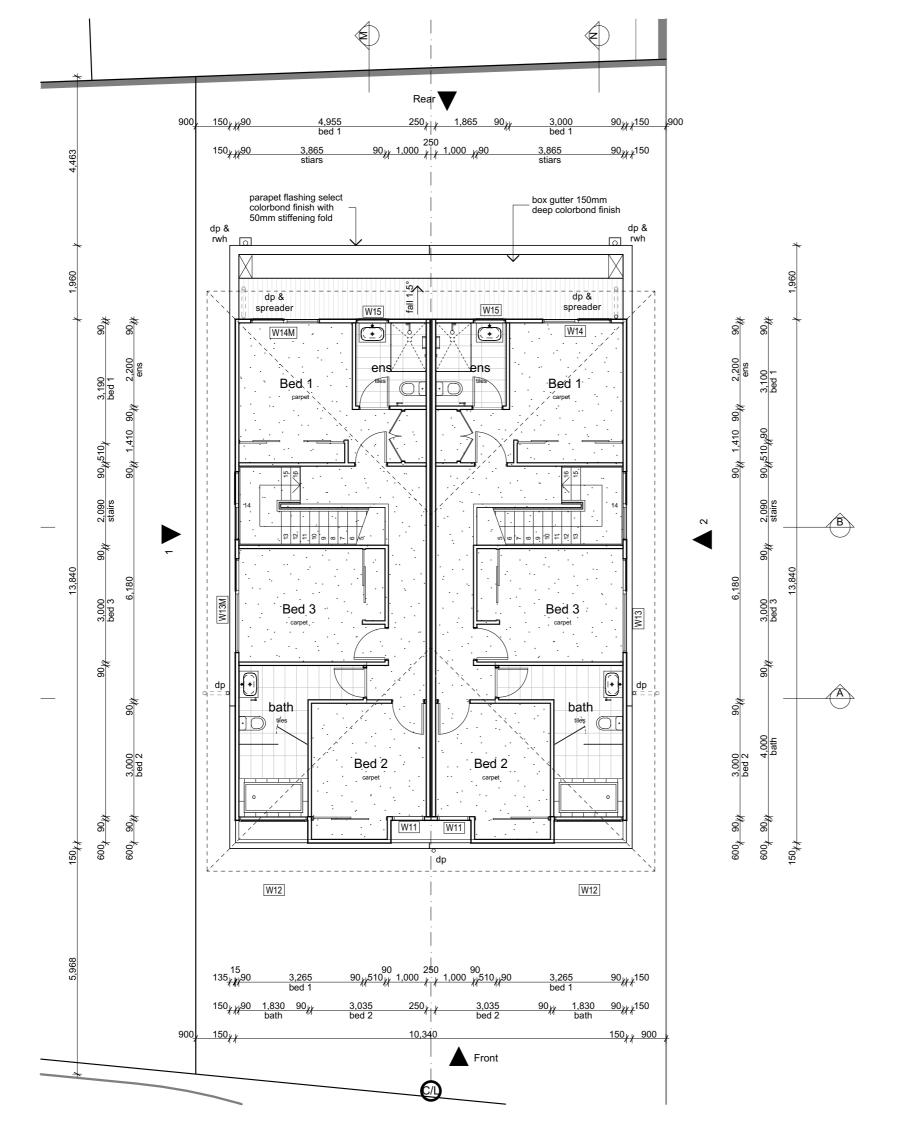

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Rev Description



Project Warriewood Bazem

Lot 11 Warriewood


Project Number 11268


Drawing General Arrangement Plans Roof Plan


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Drawing Number A2102





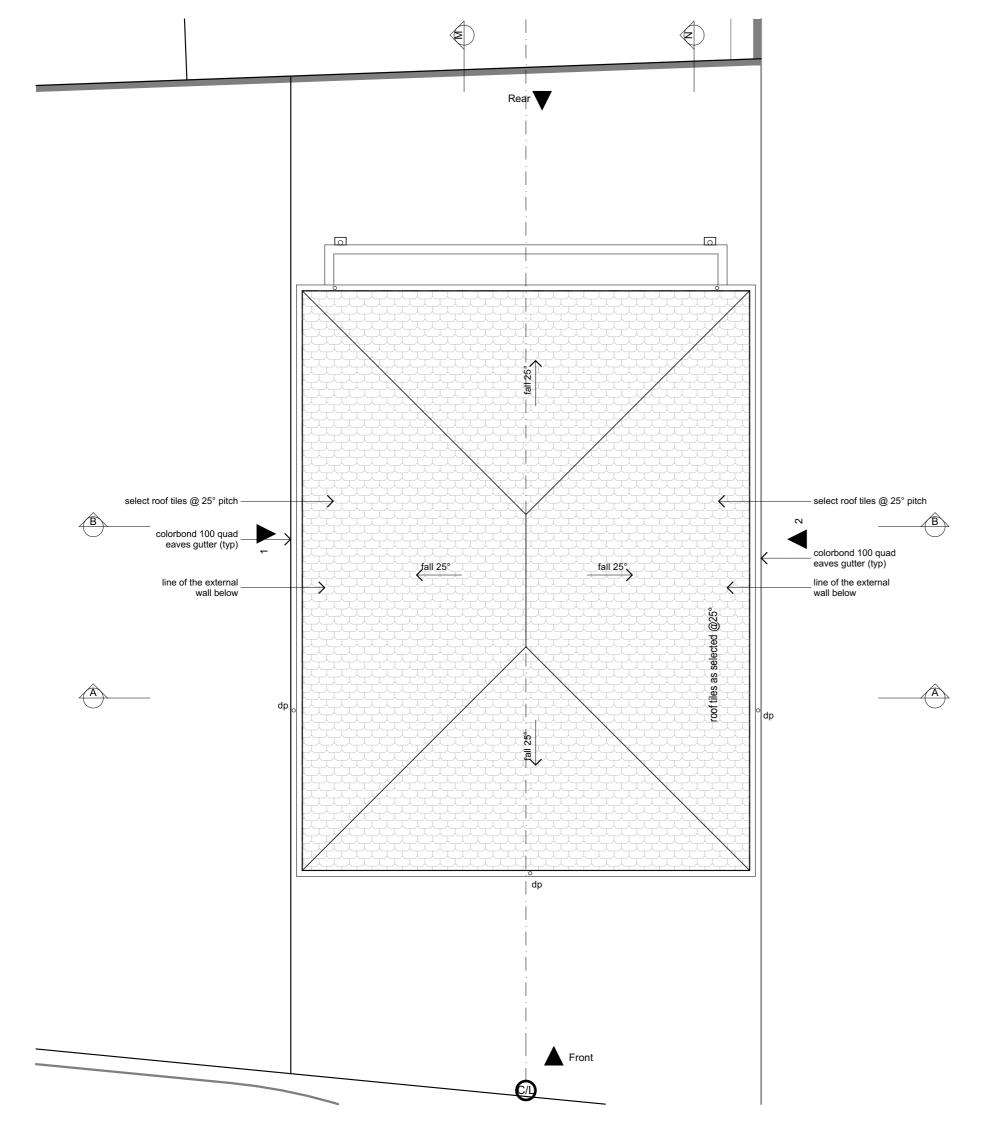

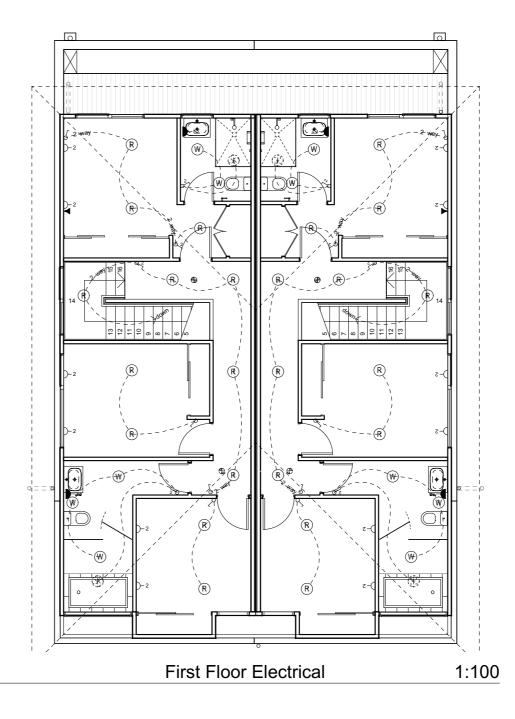

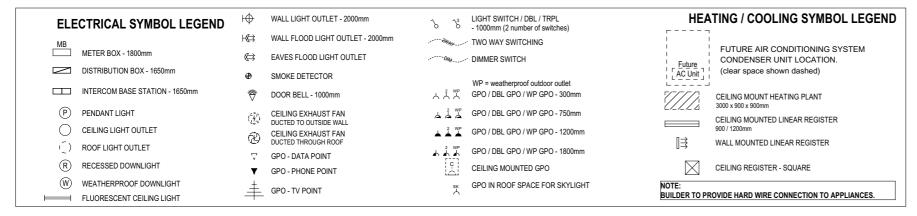

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Rev Description

Project Warriewood Bazem

Lot 11 Warriewood

Project Number 11268

Drawing Electrical Plans Electrical Plans

Project Status PRELIMINARY - not for construction

Scale Drawn BK Checked ML

Drawing Number A2400

				Danisa I saus		Adjustn	nent Fa	ctor Or	ie	Adjustment Fac	tor Two (n	/a for	Class 1)	OVER	ALL DESIGN	PASSES
	Description	Type of space	of the	Design Lamp or Illumination	Location	Adjustment Factor One		ming ntages	Design Lumen	Adjustment Factor Two	Dimmir Percenta	ng iges	Design Lumen	Lamp or Illum Den		System Share of
ID		ориос	space	Power Load	Location	Adjustment Factors	% Area	% of full power	Depreciation Factor	Adjustment Factors	% Area % c	of full ower	Depreciation Factor	System Allowance	System Design	% of Aggregate Allowance Used
1	Entry, corridor, stairs	Corridor	19.5 m²	91 W	Class 1 building									5.0 W/m²	4.7 W/m²	7% of 68%
2	living & dining	Living room	19.3 m²	52 W	Class 1 building									5.0 W/m²	2.7 W/m ²	4% of 68%
3	wc	Toilet	1.8 m²	13 W	Class 1 building									5.0 W/m ²	7.1 W/m ²	10% of 68%
4	storage	Other	2.1 m ²	13 W	Class 1 building									5.0 W/m ²	6.2 W/m ²	9% of 68%
5	kitchen	Kitchen	10.1 m ²	52 W	Class 1 building									5.0 W/m ²	5.1 W/m ²	8% of 68%
6	laundry	Laundry	1.5 m²	13 W	Class 1 building									5.0 W/m ²	8.4 W/m ²	12% of 68%
7		Other	18.5 m²	13 W	Class 10a building									3.0 W/m ²	0.7 W/m ²	100% of 23%
8	porch	Other	1.0 m ²	13 W	Class 1 building									5.0 W/m ²	12.5 W/m ²	18% of 68%
9	outside garage	Other	13.4 m²	13 W	Class 1 building									5.0 W/m ²	1.0 W/m ²	1% of 68%
10	backyard - SPOS	Verandah or balcony	41.1 m²	13 W	Verandah or balcony									4.0 W/m²	0.3 W/m²	100% of 8%
11	Stairs & corridor	Corridor	15.0 m²	65 W	Class 1 building									5.0 W/m ²	4.3 W/m ²	6% of 68%
12	bed 1	Bedroom	13.9 m²	26 W	Class 1 building									5.0 W/m ²	1.9 W/m ²	3% of 68%
13	bed 2	Bedroom	11.6 m²	26 W	Class 1 building									5.0 W/m²	2.2 W/m²	3% of 68%
14	bed 3	Bedroom	10.3 m²	26 W	Class 1 building									5.0 W/m ²	2.5 W/m ²	4% of 68%
		Bathroom	4.1 m²	26 W	Class 1 building									5.0 W/m ²	6.3 W/m ²	9% of 68%
16	bath	Bathroom	8.7 m²	26 W	Class 1 building									5.0 W/m ²	3.0 W/m ²	4% of 68%

191.9 m² 481 W Verandah or balcony

CLAIMER IN RESPECT OF THE LIGHTING CALCULATOR ator has been developed by the ABCB to assist in developing a better understanding of lighting energy efficiency parameters. While the the Lighting Calculator, if used correctly, will produce accurate results, the calculator is provided "as is" and without any representation or t, including that it is fit for any purpose or of merchantable quality, or functions as intended or at all. Your use of the Lighting Calculator is risk and the ABCB accepts no liability of any kind.



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Main Menu	LIGHTING CALCULATOR FOR USE WITH J6.2(a) VOLUME C	ONE AND 3.12.5.5 VOLUME TV	VO (First issued with NCC 2014) Help screen
	name/description 11268 Lot 11-2	Classification Class 1	
Number	of rows preferred in table below 16 (as currently displayed)	Advisory Note	Separate aggregate allowances are calculated for Class 1, 2 or 4 cases; for a verandah or balcony; or for a Class 10 building. The % of Allowance Used outcomes refer to these aggregate

				Danis I		Adjustn	nent Fa	actor Or	ne	Adjustment Fac	tor Two (n/a f	or Class 1)	OVER	ALL DESIGN	PASSES
	Description	Type of space	Floor area of the	Design Lamp or Illumination	Location	Adjustment Factor One		nming entages	Design Lumen	Adjustment Factor Two	Dimming Percentages	Design Lumen	Lamp or Illum Den		System Share of
ID		Space	space	Power Load	Location	Adjustment Factors	% Area	% of full power	Depreciation Factor	Adjustment Factors	% Area % of ful power	Depreciation Factor	System Allowance	System Design	% of Aggregate Allowance Used
1	Entry, corridor, stairs	Corridor	19.5 m²	91 W	Class 1 building								5.0 W/m²	4.7 W/m²	7% of 68%
2	living & dining	Living room	19.3 m²	52 W	Class 1 building								5.0 W/m ²	2.7 W/m ²	4% of 68%
3	wc	Toilet	1.8 m²	13 W	Class 1 building								5.0 W/m ²	7.1 W/m ²	10% of 68%
4	storage	Other	2.1 m ²	13 W	Class 1 building								5.0 W/m ²	6.2 W/m ²	9% of 68%
5	kitchen	Kitchen	10.1 m ²	52 W	Class 1 building								5.0 W/m ²	5.1 W/m ²	8% of 68%
6	laundry	Laundry	1.5 m²	13 W	Class 1 building								5.0 W/m ²	8.4 W/m ²	12% of 68%
7	garage	Other	18.5 m²	13 W	Class 10a building								3.0 W/m ²	0.7 W/m ²	100% of 23%
8	porch	Other	1.0 m ²	13 W	Class 1 building								5.0 W/m ²	12.5 W/m ²	18% of 68%
9	outside garage	Other	13.4 m²	13 W	Class 1 building								5.0 W/m ²	1.0 W/m ²	1% of 68%
10	backyard - SPOS	Verandah or balcony	39.7 m²	13 W	Verandah or balcony								4.0 W/m²	0.3 W/m²	100% of 8%
11	Stairs & corridor	Corridor	15.0 m ²	65 W	Class 1 building								5.0 W/m ²	4.3 W/m ²	6% of 68%
12	bed 1	Bedroom	13.9 m²	26 W	Class 1 building								5.0 W/m ²	1.9 W/m ²	3% of 68%
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15	Ensuite	Bathroom	4.1 m²	26 W	Class 1 building								5.0 W/m ²	6.3 W/m ²	9% of 68%
16	bath	Bathroom	8.7 m ²	26 W	Class 1 building								5.0 W/m ²	3.0 W/m ²	4% of 68%

190.5 m² 481 W Verandah or balco Class 10a building (associated with a Class 1 building) 3.0 W/m²

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are valid

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Rev Description

Project Number 11268


Project Warriewood Bazem Lot 11 Warriewood


Drawing Electrical Plans Lighting Calculation

Project Status PRELIMINARY - not for construction

Scale Drawn BK Checked ML

Drawing Number A2401

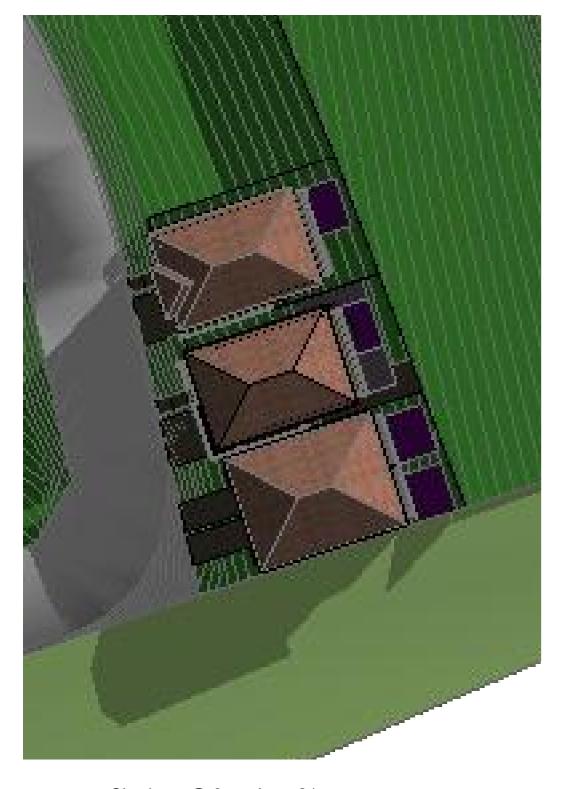

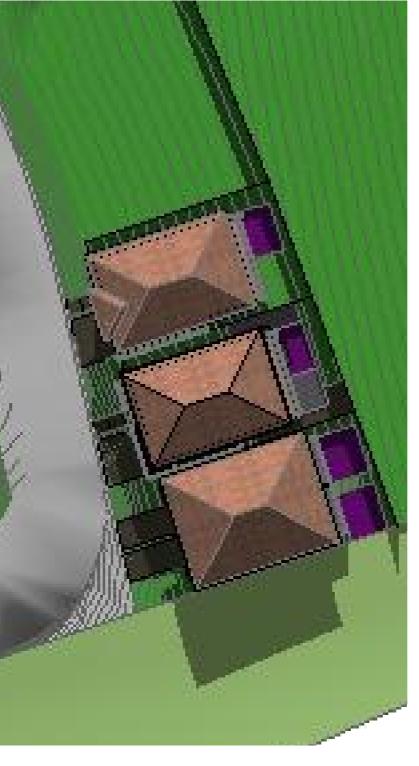



Shadows @ 9am June 21

Shadows @ 12pm June 21

Shadows @ 3pm June 21

Architect

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Rev Description

Project Warriewood Bazem


Lot 11 Warriewood

Drawing Shadow Diagram Shadow Diagrams

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Scale Drawn BK Checked ML Drawing Number A2500

11268



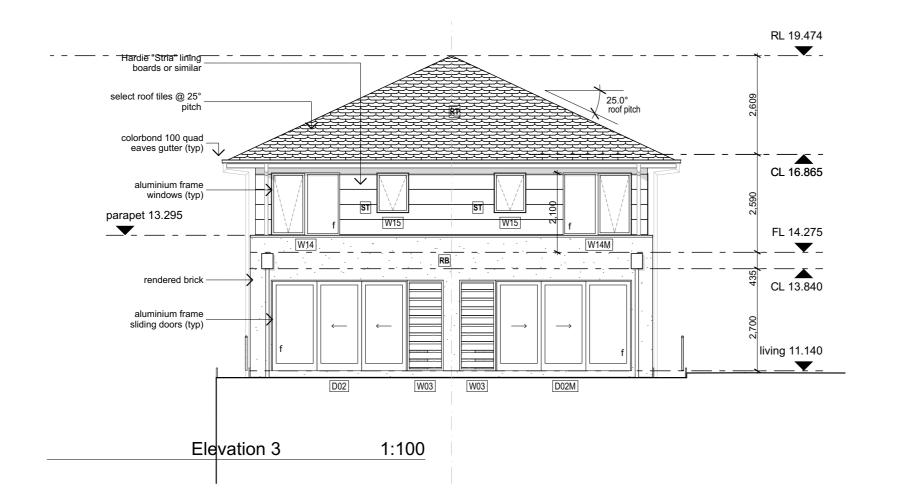

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Rev Description

Project Warriewood Bazem

Lot 11 Warriewood

Project Number 11268


Drawing Elevations Elevations


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Drawing Number A3000







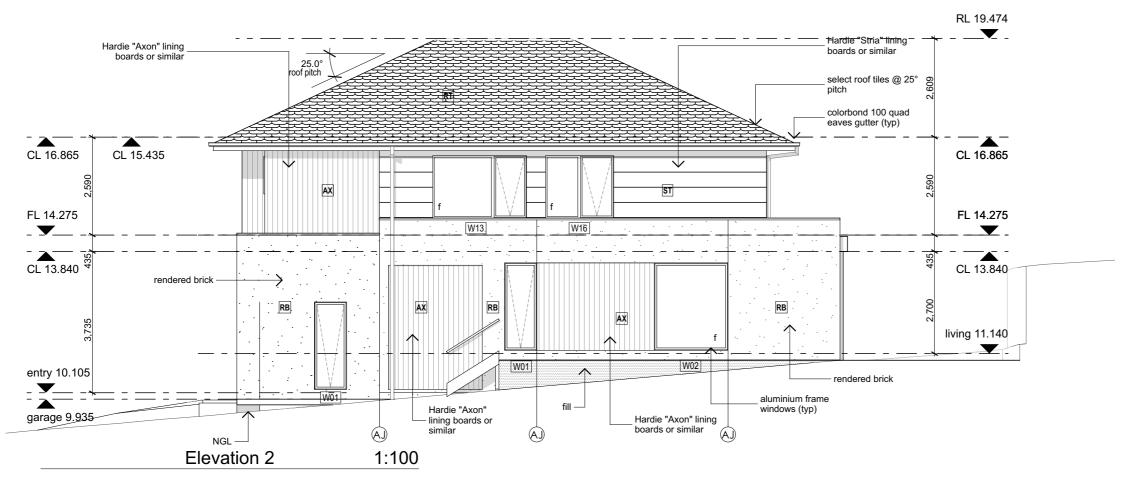
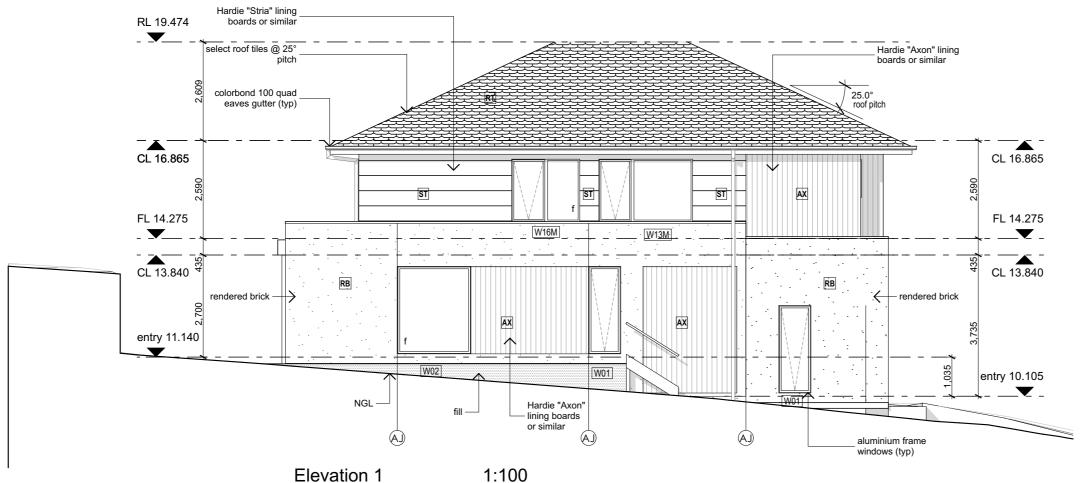
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Rev Description

Project Warriewood Bazem

Lot 11 Warriewood

Project Number 11268

Drawing Elevations Elevations

Project Status PRELIMINARY - not for construction

Scale Drawn BK Checked ML

Drawing Number A3001

NOTES

RL 19.474

CL 16.865

colorbond tray deck roofing

box gutter 350 x 150mm

parapet flashing select

parapet 13.295

colorbond finish with

50mm stiffening fold

@ 1.5° fall

Rev Description

Project Warriewood Bazem Lot 11 Warriewood


Project Number 11268

Drawing Sections

Sections 2 Project Status PRELIMINARY - not for construction

Drawn BK Checked ML Drawing Number A3101

Revision

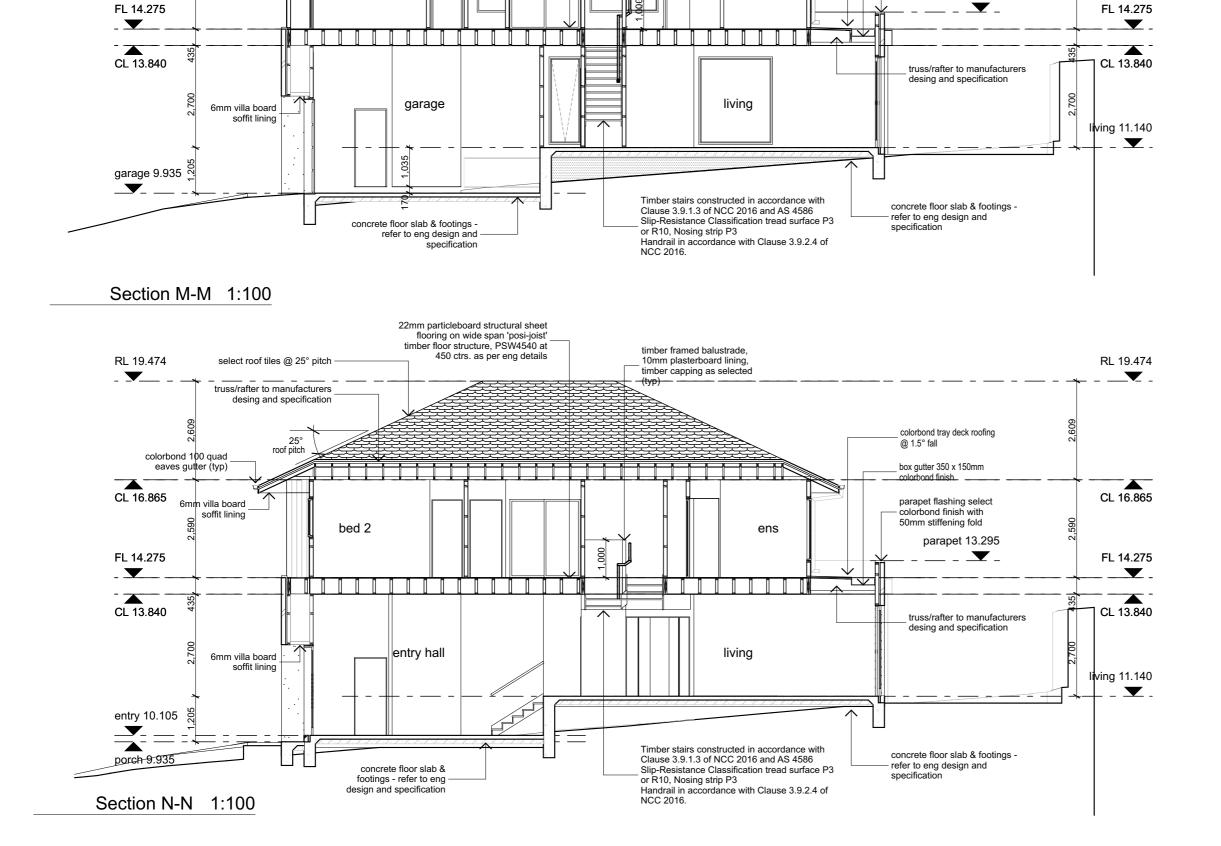

timber framed balustrade,

10mm plasterboard lining, timber capping as selected

25° roof pitch

ens

22mm particleboard structural sheet flooring on wide span 'posi-joist' timber floor structure, PSW4540 at

RL 19.474

CL 16.865

colorbond 100 quad

eaves gutter (typ)

6mm villa board


soffit lining

select roof tiles @ 25° pitch truss/rafter to manufacturers desing and specification

25° roof pitch

bed 2

450 ctrs. as per eng details

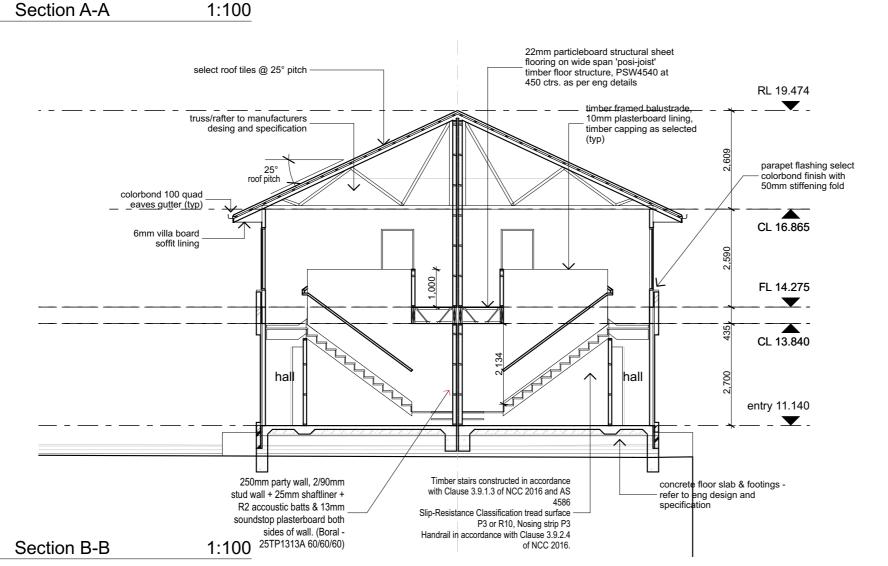



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Rev Description

Project Warriewood Bazem

Lot 11 Warriewood

Project Number 11268

Drawing Sections Sections

Project Status PRELIMINARY - not for construction

Drawing Number A3100

Revision

Drawn BK Checked ML

Window Schedule								
D	W01	W01	W02	W03	W11	W12	W13	W13M
N x H Size	850×2,315	850×2,315	1,950×2,315	950×2,400	850×2,050	1,810×1,027	2,480×1,650	2,480×1,650
tud opening								
Window head height	1,365	2,400	2,400	2,400	2,100	2,100	2,100	2,100
Elevations	* 850 * * * * * * * * * * * * * * * * * * *	850	1,950	* 950 * * * * * * * * * * * * * * * * * * *	* 850 * F	1,810 x	2,480	2,480
Quantity	2	2	2	2	2	2	1	1

D W x H Size Stud opening Window head height	W14 1,810×1,650	W14M 1,810×1,650	W15	W16	W16M
Stud opening	1,810×1,650	1,810×1,650			
			850×1,057	1,800×1,650	1,800×1,650
Nindow head height	I				
Williaow lieau lieigiit	2,100	2,100	2,100	2,100	2,100
Elevations	1,810	1,810	* 850 *	1,800	1,800
Quantity	1	1	2	1	1

Door Schedule	D01L	D01R	D02	D02M	D03
W x H Size	920×2,340	920×2,340	3,600×2,400	3,600×2,400	2,600×2,506
Stud opening					
Door head height	2,340	2,340	2,400	2,400	1,281
3D Front View	7 920 A	920 A			2,600
Quantity	1	1	1	1	2
Note					



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Rev Description

A Street name changed, skylight SK1 deleted, W14 deleted

By Date 15.12.2015.

Client Details client


Project Warriewood Bazem


Lot 11 Warriewood

Drawing D & W Schedule D & W Window Schedule Project Status PRELIMINARY - not for construction

Scale Drawn BK Checked ML

Drawing Number A6000 Revision

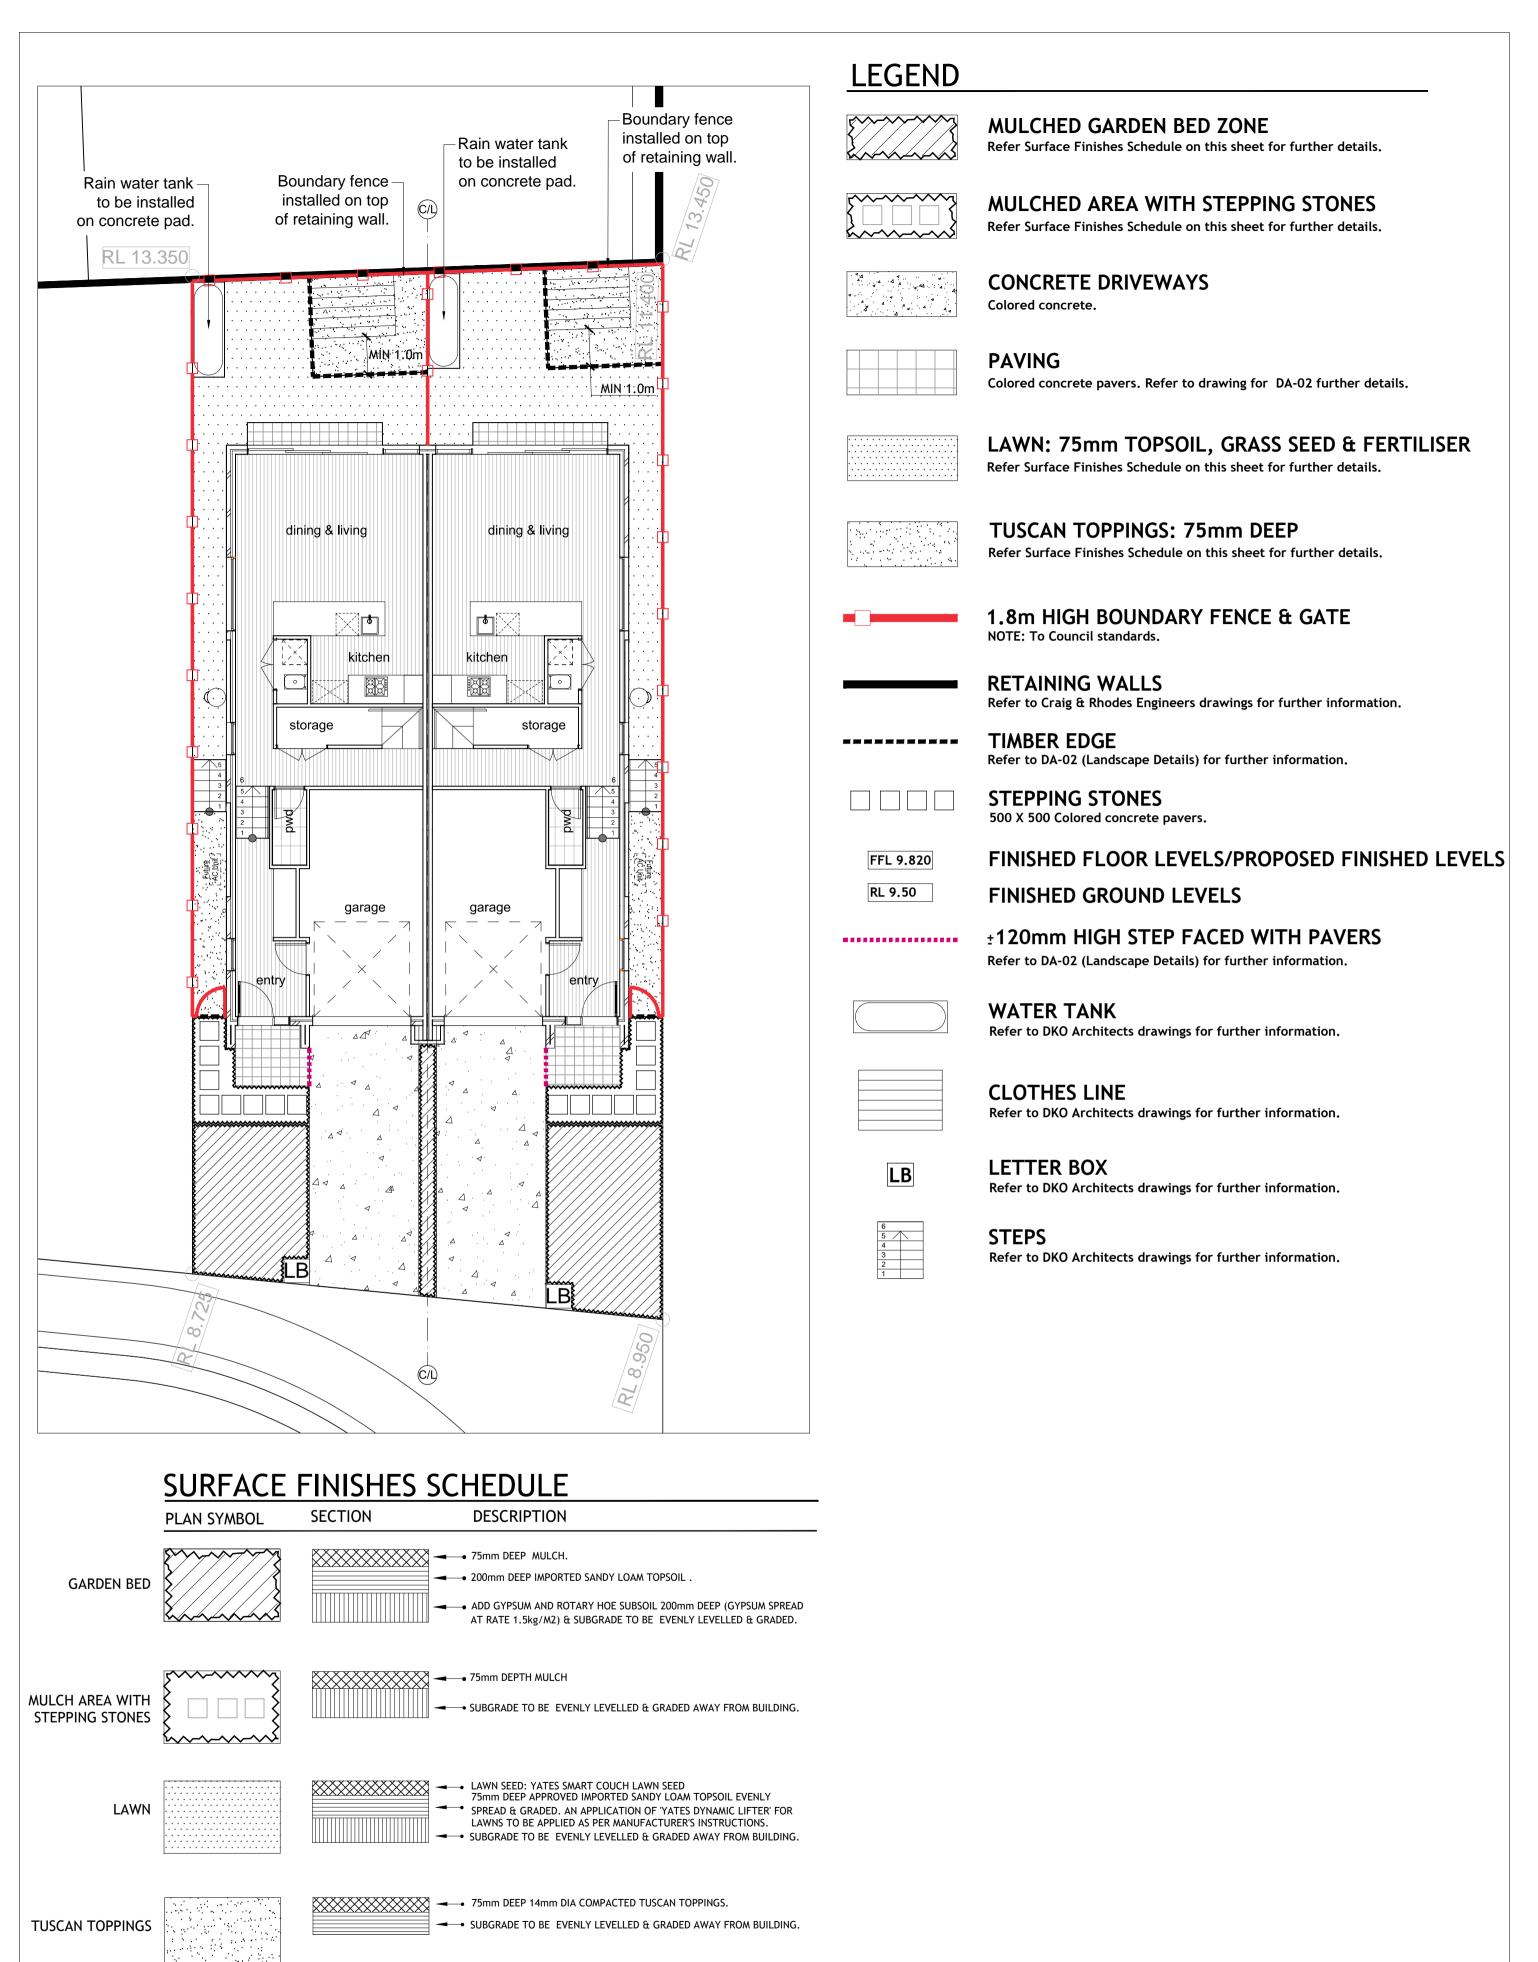

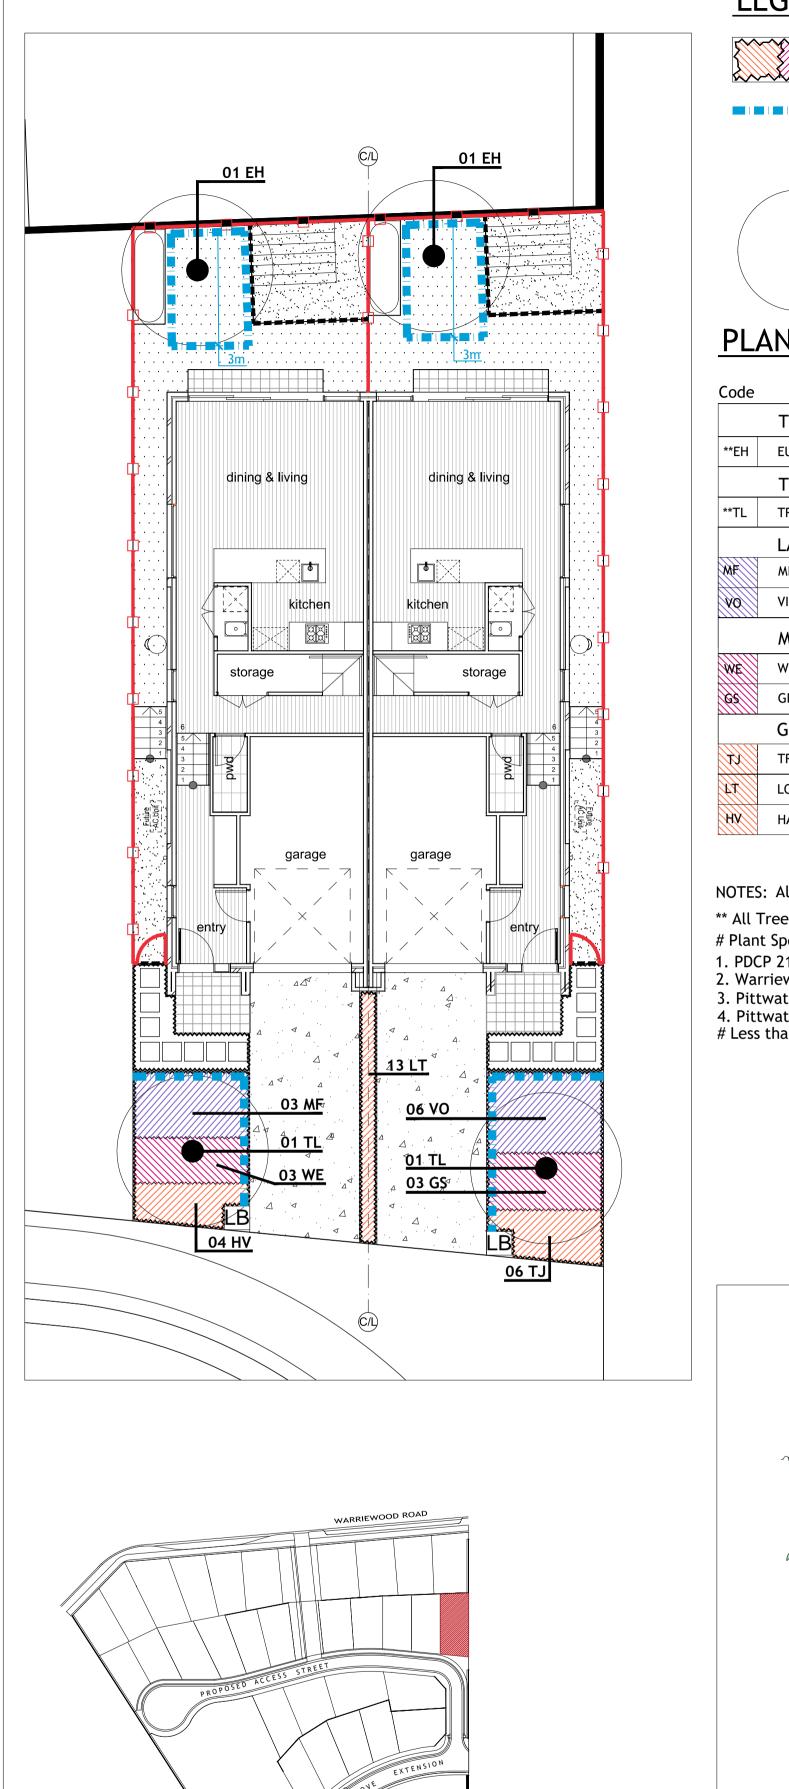


LEGEND

PROPOSED PLANTING

Refer to Plant Schedule on this sheet for further details.

ROOT CONTROL BARRIER

TYPE: Rootstop SIZE: 1000mm (DEEP) x 50mm (THICK) x 3000mm (MIN. LENGTH) SUPPLIER/MANUFACTURER: ARBORGREEN-TEL. 1300 760 642 NOTES: Installed as per supplier/manufacturer instructions. Contractor to provide written confirmation stating all Root control

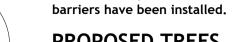


PROPOSED TREES Refer to Plant Schedule on this sheet for further details.

PLANT SCHEDULE

			Height &		Pot Size/	
Code	Botanical Name	Common Name	Width	Spacing	Bag Size	Quantity
	TREES (REAR YARDS)					
**EH	EUCALYPTUS haemastoma	Broad leaved Scribbly gum	12-15m x 5m	As shown	1.8m/45 Litre	02
	TREES (FRONT GARDENS)					•
**TL	TRISTANIOPSIS laurina	Kanooka Gum	12m x 4-6m	As shown	1.8m/45 Litre	02
	LARGE SHRUBS					
MF	MICHELIA figo	Port Wine Magnolia	2.5m x 2m	As shown	200mm	03
vo	VIBURNUM odoratissimum	Sweet Viburnum	4-6m x 4m	As shown	200mm	06
	MEDIUM SHRUBS					
WE	WESTRINGIA 'Wynyabbie gem'	Westringia Wynyabbie Gem	1.5m x 1.2m	As shown	200mm	03
65	GREVILLEA sericea	Pink Spider Flower	1.5x 1.5m	As shown	200mm	03
	GROUNDCOVERS & TUFTED	PLANTS				
TX	TRACHELOSPERMUM jasminoides	Star Jasmine	0.5m x 1m	As shown	200mm	06
F4	LOMANDRA 'Tanika'	Tanika	0.7m x 0.7m	As shown	200mm	13
HV	HARDENBERGIA violacea 'Meema'	Native Sarsparilla	0.5x 1.0m	As shown	200mm	04

NOTES: All 45 Litre Trees planted in the rear of lots to have Root control barriers.

- ** All Trees to be Planted as 45 Litre container. Refer to installation detail on DA-02.
- # Plant Species have been selected from the following sources:
- PDCP 21 Control D16.5 Landscaped Areas for Newly Created Individual Allotments-Plant lists;
 Warriewood Valley Landscape Masterplan and Urban Design Guidelines-Plant List
- 3. Pittwater Council-Native Plants for Your Garden-Lowlands Plant List;
- 4. Pittwater Council-Prelodgement Report-Recommended Plants;
- # Less than 20% of the shrub species are exotic species and within the 30% allowable range.

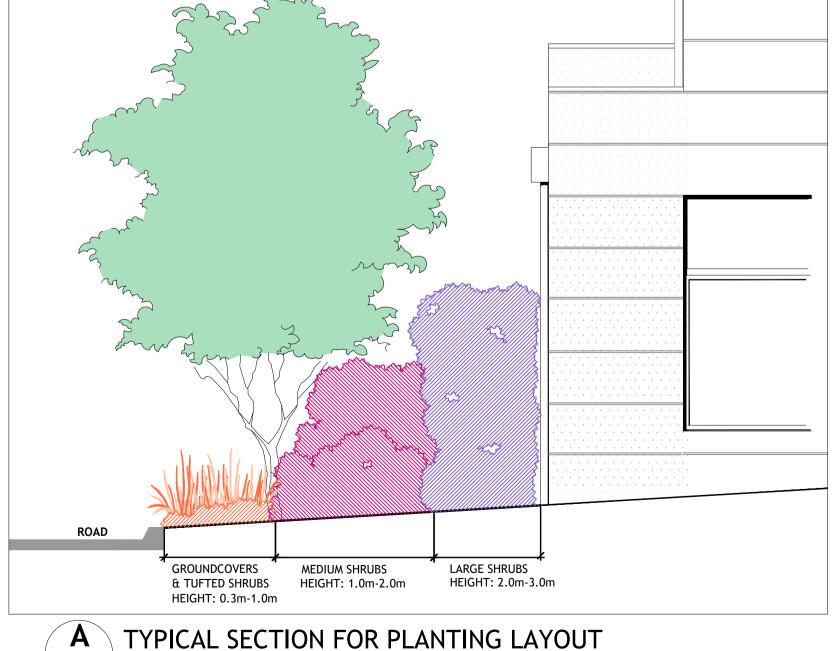

WARRIEWOOD LOT 11


DA APPROVAL DRAWING No. DA-01 **REVISION**

FOR: E & P COMELLI PTY LTD FILE NAME DRAWING SURFACE FINISHES & PLANTING PLAN SCALE 1:100 @ A1 DRAWN WL DATE 30/09/2019 JOB NUMBER 19-046 Lot 11-Landscape Plan

E-mail: office@hla.net.au | http://www.hla.net.au

HAMILTON LANDSCAPE ARCHITECTS PTY LTD Site Planning | Urban Design | Landscape Architecture 1 York Place, Carlton VIC 3053 - Australia | Tel: +61 03 9348 2800

SITE CONTEXT PLAN

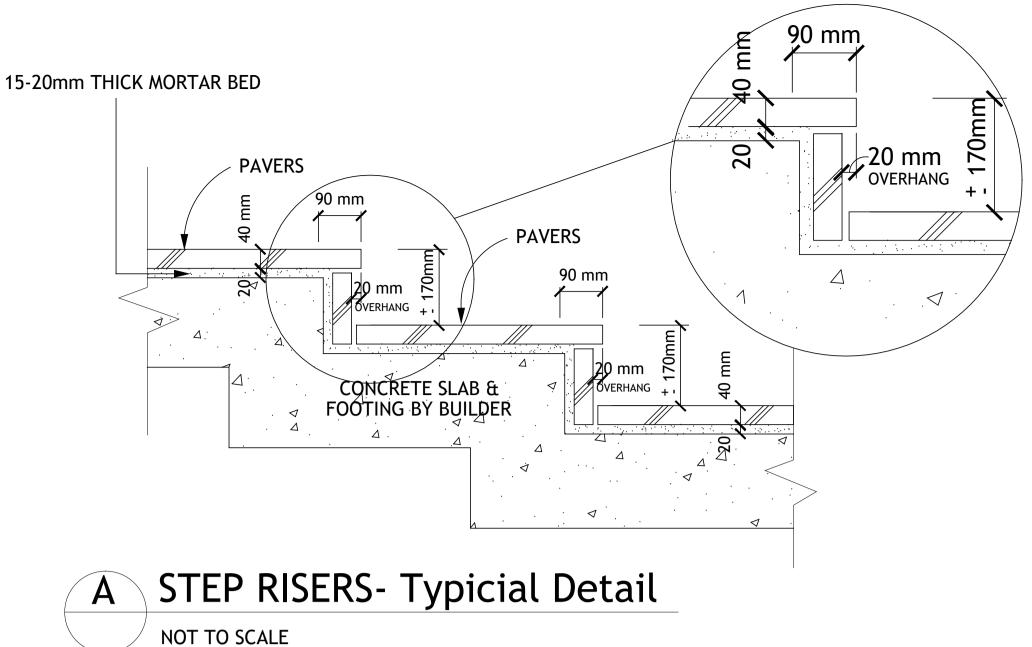



SURFACE FINISHES SCHEDULE

PLAN SYMBOL

SECTION

DESCRIPTION

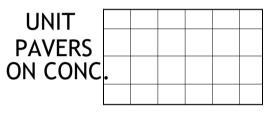


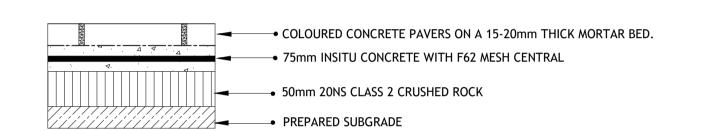

A. NOTE: CONCRETE FOOTINGS FOR FRONT STEPS TO BE DOWELLED INTO HOUSE SLAB & CONCRETE DRIVEWAY.


CONFIRM & OBTAIN APPROVAL ON-SITE WITH BUILDER, THE DOWELLING METHOD, PRIOR TO WORKS BEING UNDERTAKEN.

B. NOTE: EXPANSION & CONTROL JOINTS TO ALL ADJOINING CONCRETE WORKS. CORKING TO BE INSTALLED AT ALL CONNECTIONS TO THE HOUSE, PATHS & DRIVEWAYS.

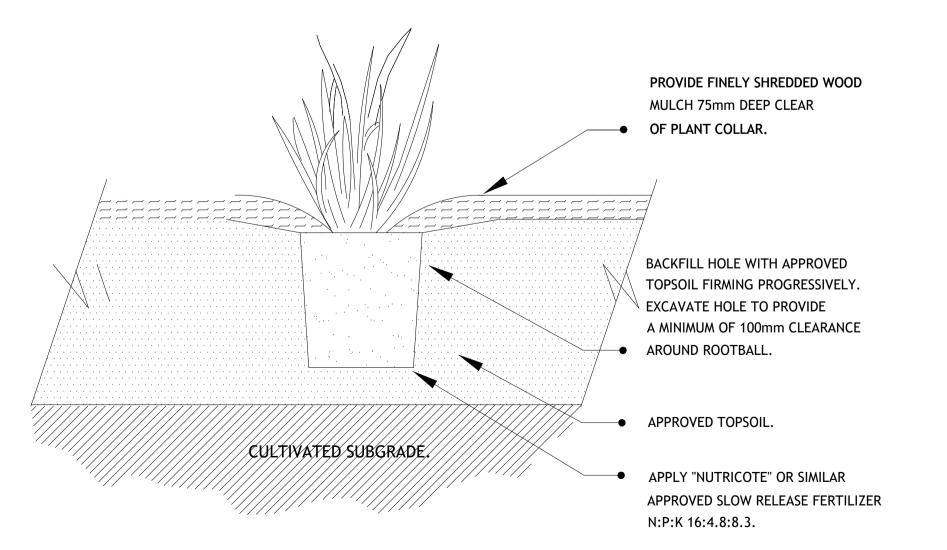



NOT TO SCALE

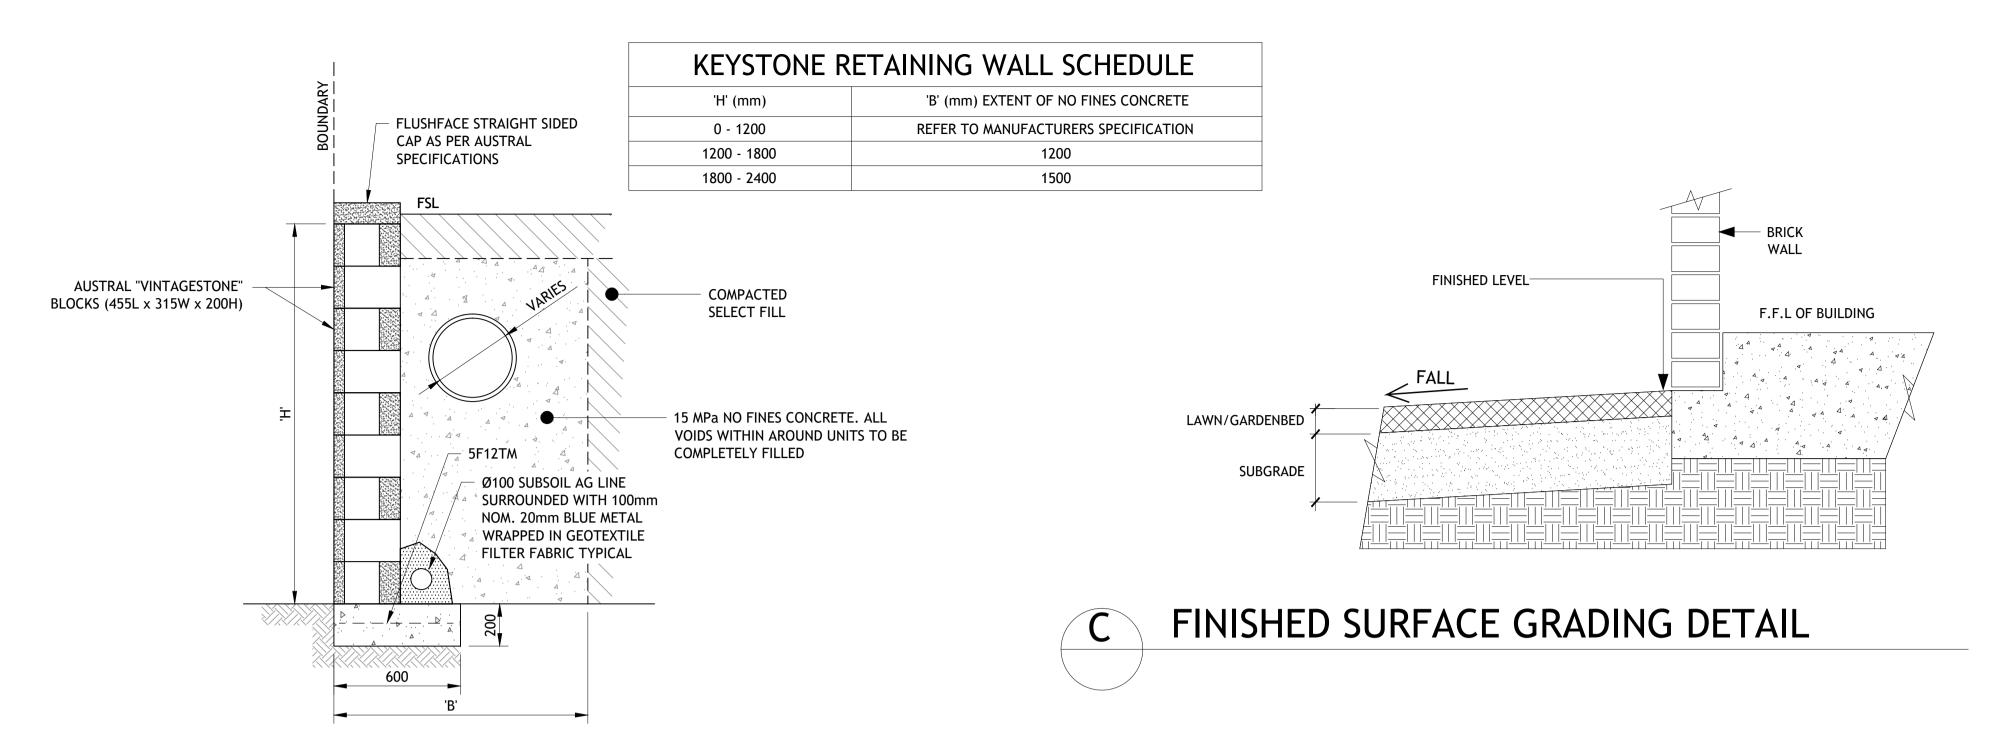

TYPICAL KEYSTONE BLOCK

RETAINING WALL

NOTE: THE ABOVE DETAIL HAS BEEN PREPARED AND PROVIDED BY CRAIG & RHODES ENGINEERS & HAS BEEN APPROVED BY COUNCIL AS PART OF THE CIVIL ENGINEERING WORKS.

\bigcirc \Leftrightarrow 2 No 50x50x2100mm LONG HARDWOOD STAKES POINTED AT ONE END AND CLEARANCE OF FREE OF KNOTS, SPLINTERS AND MULCH FROM TRUNK. STAKES ARE TO BE DRIVEN 900mm INTO THE GROUND, CLEAR OF THE TREE STAKING SETOUT PLAN. ◆15mm FLATHEAD GALVANIZED STAPLES. MULCH IS NOT TO BE IN CONTACT WITH TRUNK. FIGURE - EIGHT 50MM PLASTIC TIES STAPLED TO ALL STAKES BACKFILL AROUND ROOTBALL WITH • • TOP OF ROOT BALL LEVEL TO MATCH FINISHED SURFACE LEVEL OF ADJACENT APPROVED TOPSOIL (75mm HIGH) TO FORM 1500mm O 'SAUCER' FOR WATERING. MULCH AREA. → 75mm DEPTH APPROVED MULCH NOTE: CONTRACTOR SHALL BE LIABLE FOR ROOTBALL ANY DAMAGES TO SERVICES DURING THE LANDSCAPE WORKS. PROVIDE A MINIMUM OF 150mm APPROVED SITE TOPSOIL AROUND ROOTBALL. LIGHTLY COMPACT PROGRESSIVELY TO CULTIVATED & REMOVE ANY AIR POCKETS. PREPARED SUBGRADE MOUND BASE OF HOLE 100mm TO PREVENT SETTLEMENT. APPLY 'OSMOCOTE' FERTILIZER AS PER MANUFACTURERS INSTRUCTIONS OR NEAREST APPROVED EQUIVALENT.

E ADVANCED TREE PLANTING DETAIL- 45 Litres Tree

NOTE : CONTRACTOR SHALL BE LIABLE FOR ANY DAMAGES TO SERVICES DURING THE

LANDSCAPE WORKS.

MAINTENANCE & ESTABLISHMENT PERIOD

THE WHOLE OF THE WORKS SHALL BE UPHELD AGAINST ANY DEFECTS DUE TO FAULTY AND/OR POOR WORKMANSHIP AND MAINTAINED FOR A PERIOD OF12 MONTHS.

THE FOLLOWING IS A BREAKDOWN OF ALL MAINTENANCE ITEMS INCLUDING WATERING TO BE COMPLETED.

TREES: ALL TREE STAKING TO BE MAINTAINED AS PER THE TREE PLANTING DETAILS AT ALL TIMES. STAKES & TIES TO BE STRAIGHTENED AND REPLACED TO ENSURE STABILITY. ALL TREES ARE TO BE OF SOUND STRUCTURE AND DISPLAY GOOD HEALTH AND ARE FREE OF DISEASE AND PESTS. IF ANY SPRAYING OR TREATMENT FOR PEST AND DISEASE CONTROL IS REQUIRED, THESE SHOULD BE COMPLETED AS PER MANUFACTURER'S INSTRUCTIONS.

ANY DEAD OR POOR PERFORMING TREES SHALL BE REPLACED IMMEDIATELY. TREE STAKES NEED TO BE REGULARLY MONITORED AND RELOCATED AWAY FROM TREE BRANCHES IF THEY ARE DAMAGING THE TREES. MULCH BOWLS AT THE BASE OF EACH TREE ARE TO BE WEED-FREE AT ALL TIMES AND MULCH DEPTHS REGULARLY MAINTAINED AS PER INSTALLATION TREE DETAIL.


GARDEN BEDS & PLANTING: HERBICIDE SPRAY & REMOVE ALL WEEDS, ROCKS AND RUBBISH FROM THE SITE ON A MONTHLY BASIS. FULL COVERAGE OF PLANTS TO BE REQUIRED AT THE END OF THE MAINTENANCE PERIOD. ALL MULCHED AREAS TO BE MAINTAINED AT THE NOMINATED DEPTHS AS PER THE INSTALLATION DETAILS. ANY DEAD OR POOR PERFORMING PLANTS WITHIN THE GARDEN BEDS SHALL BE REPLACED IMMEDIATELY, AT THE EXPENSE OF THE CONTRACTOR. SPRAYING OF ALL PLANTS FOR PEST AND DISEASE CONTROL TO COMPLETED ON AN 'AS NEEDS' BASIS. ANY SPRAYING OF PLANTS SHALL BE COMPLETED IN ACCORDANCE WITH THE MANUFACTURERS INSTRUCTIONS.THE SAFETY AND PRECAUTION INSTRUCTIONS ARE TO BE READ, UNDERSTOOD AND APPLIED.


GRASS SEEDED LAWNS: ALL LAWN AREAS ARE TO BE HERBICIDED ONCE PER MONTH, WITH ALL WEEDS, ROCKS AND RUBBISH REMOVED OFF-SITE. A RED-DYE IS TO BE MIXED WITH THE HERBICIDE TREATMENT TO CONFIRM A MONTHLY APPLICATION. MOW ALL AREAS & BRUSH-CUT ALL ADJOINING EDGES - 12 TIMES PER YEAR. THE HEIGHT OF GRASS IS NOT TO EXCEED 120MM HIGH. THE AVERAGE GRASS HEIGHT OF 40-60MM HIGH IS REQUIRED AT ALL TIMES. THE TIMES OF THE YEAR REQUIRING MOWING MAY VARY DEPENDING ON THE SEASON, HOWEVER THE NOMINATED HEIGHT OF GRASS IS TO BE ADHERED TOO. TOP-SOILING AND RE-SEEDING OF BARE AREAS IS TO BE COMPLETED. REGULAR FERTILIZING OF SEEDED LAWNS SHALL BE COMPLETED AS PER THE MANUFACTURERS INSTRUCTIONS. THE OWNER IS TO REGULARLY MONITOR THE IRRIGATION SYSTEM, ENSURING THE CORRECT QUANTITY AND DISTRIBUTION OF WATER TO ALL PLANTS IS BEING UNDERTAKEN. ADJUSTMENTS TO THE WATERING REGIME WILL NEED TO BE REGULATED THROUGHOUT THE YEAR, DEPENDING ON THE SEASON.

IRRIGATION SYSTEM: THE OWNER IS TO REGULARLY MONITOR THE IRRIGATION SYSTEM, ENSURING THE CORRECT QUANTITY AND DISTRIBUTION OF WATER TO ALL PLANTS IS BEING UNDERTAKEN. ADJUSTMENTS TO THE WATERING REGIME WILL NEED TO BE REGULATED THROUGHOUT THE YEAR, DEPENDING ON THE SEASON.

REGULAR MONITORING AND ASSESSMENT OF ALL IRRIGATION MATERIALS AND FIXTURES IS TO BE COMPLETED, ENSURING WATER IS BEING DISTRIBUTED TO ALL PLANTS AND TURF AREAS. REGULAR MONITORING OF THE CONTROL BOX TIMER IS TO BE COMPLETED.



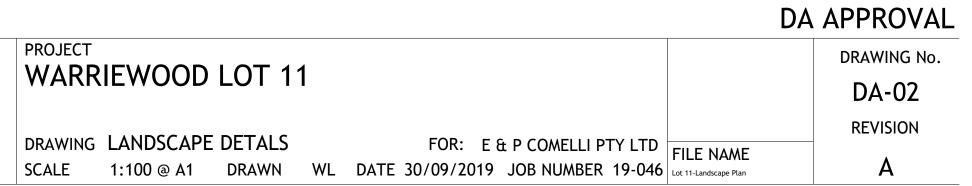

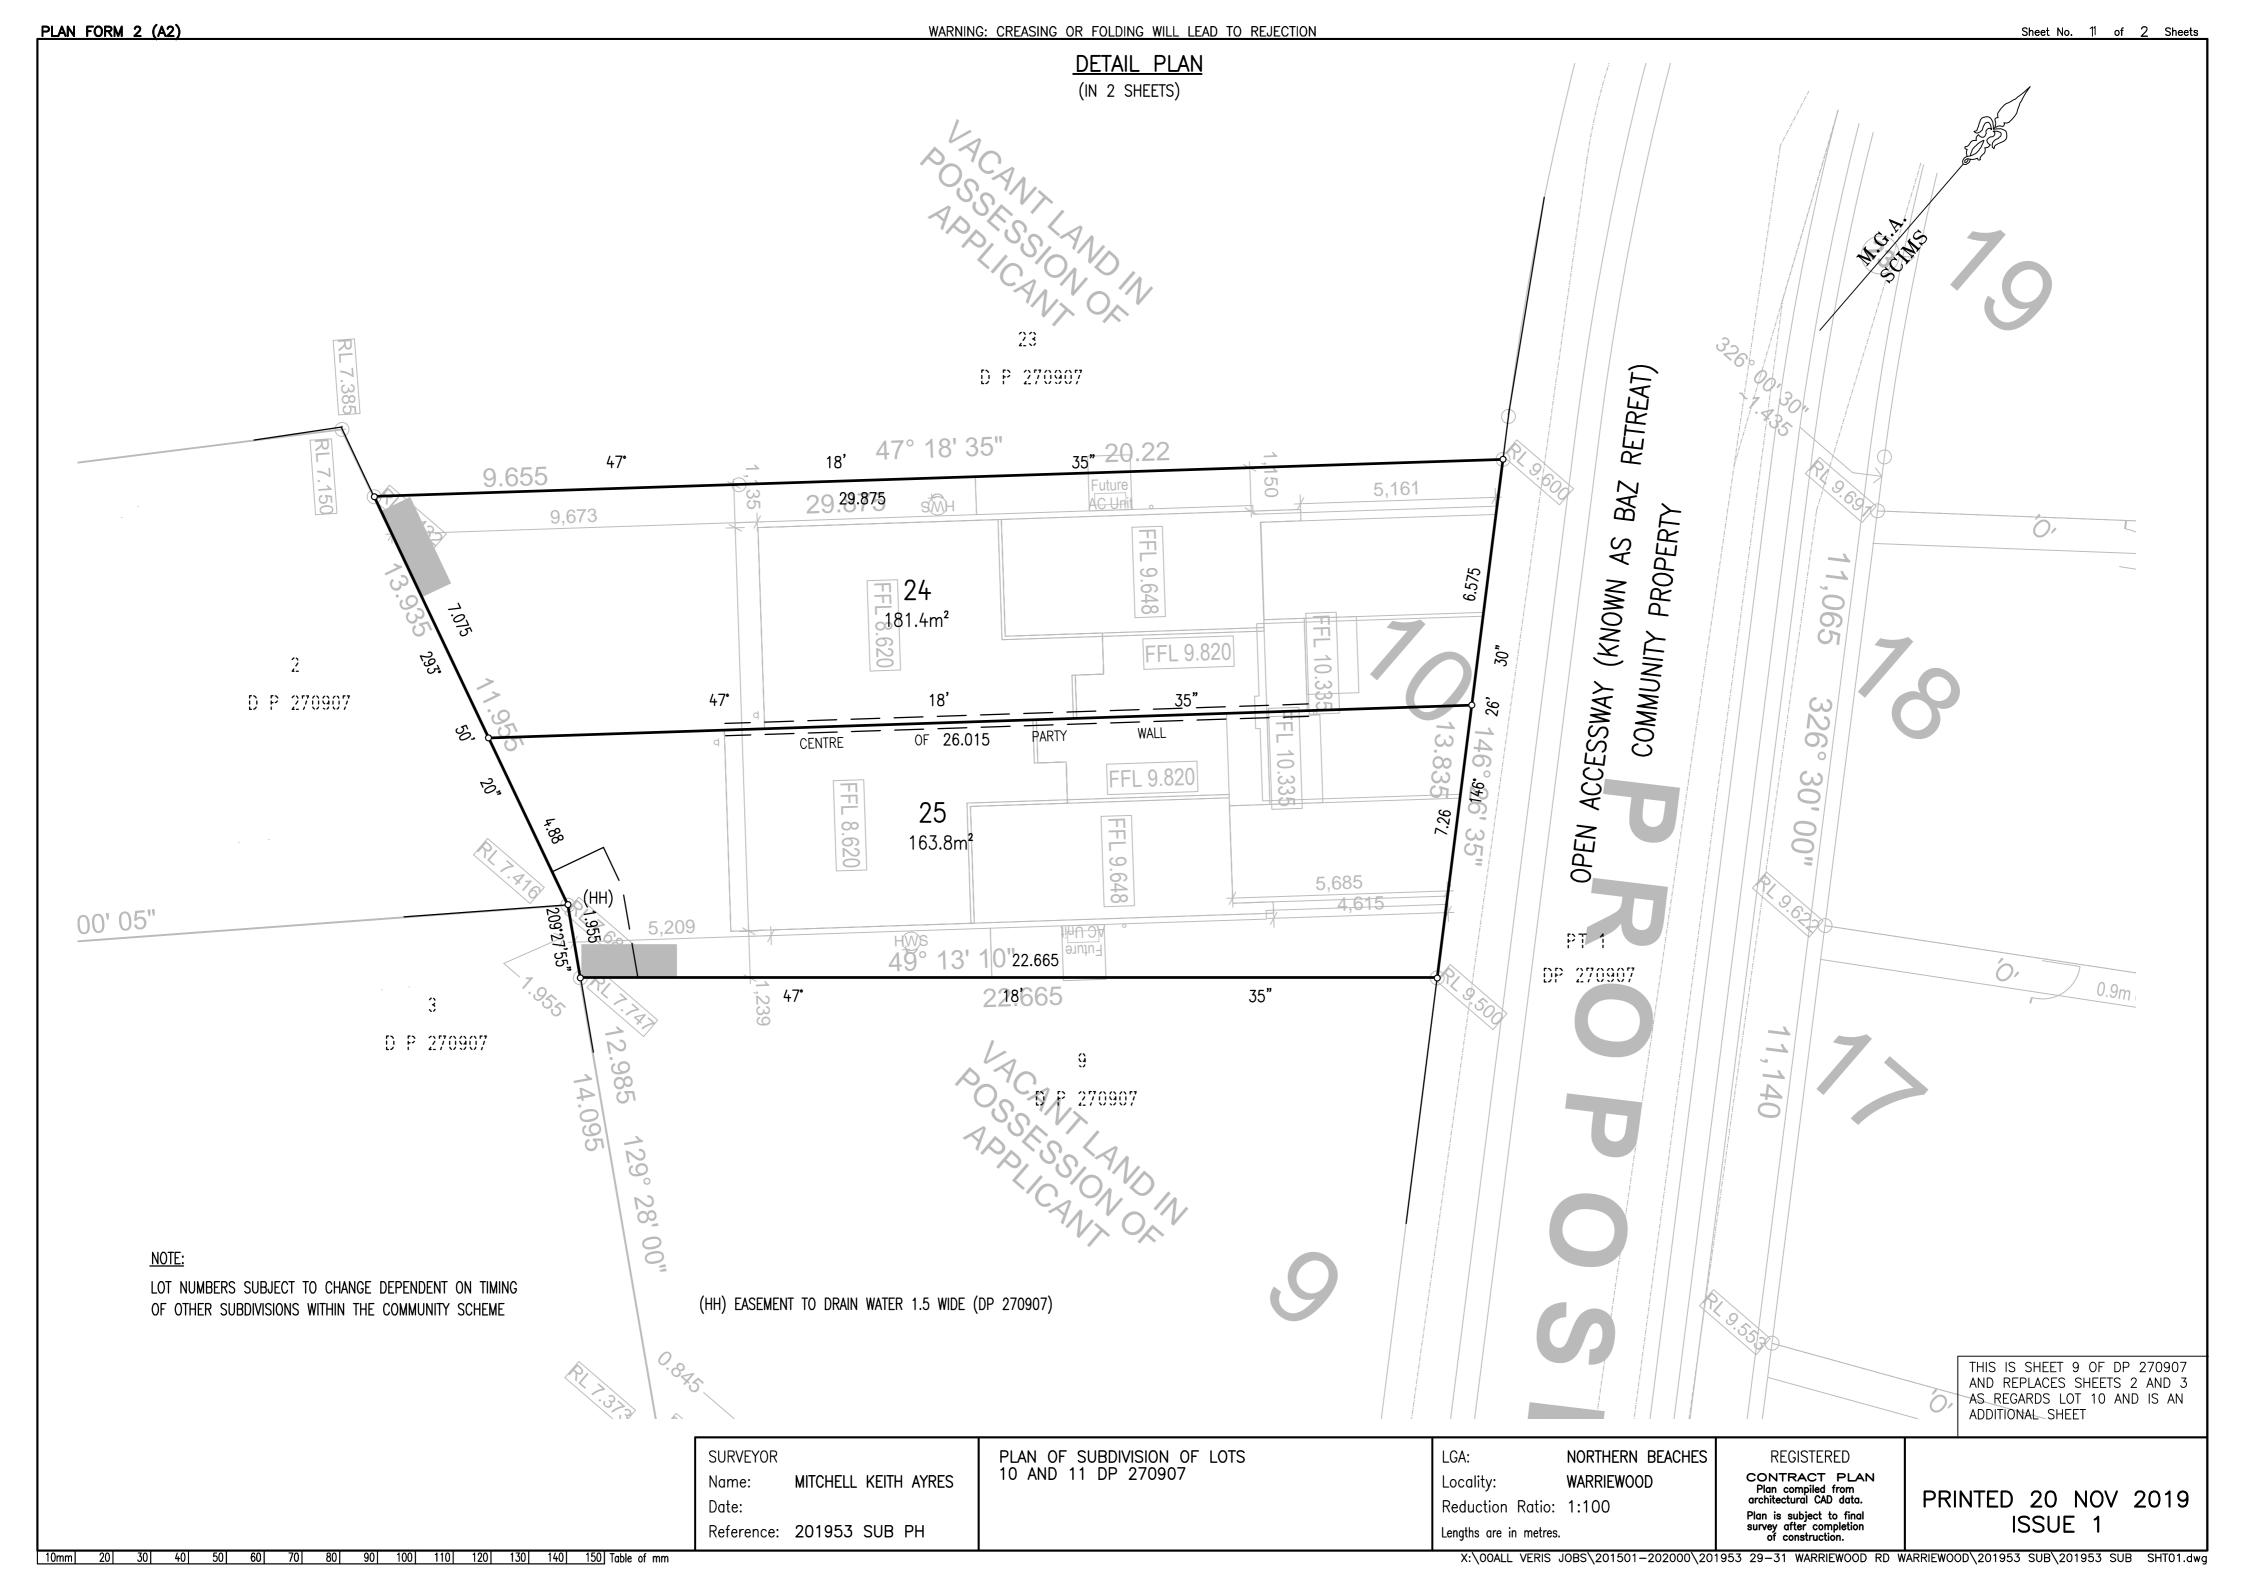

- (0) EASEMENT FOR ACCDESS CONSTRUCTION & MAINTENANCE 0.9 WIDE (DP 270907)
- (W) EASEMENT FOR ACCESS, MAINTENANCE & SUPPORT 0.9 WIDE (DP 1206507)

THIS IS SHEET 10 OF DP 270907 AND REPLACES SHEETS 2 AND 4 AS REGARDS LOT 11 AND IS AN ADDITIONAL SHEET

SURVEYOR

Name: MITCHELL KEITH AYRES

Date:

Reference: 201953 SUB PH

PLAN OF SUBDIVISION OF LOTS 10 AND 11 DP 270907

LGA: NORTHERN BEACHES
Locality: WARRIEWOOD

Reduction Ratio: 1:100

Lengths are in metres.

REGISTERED

CONTRACT PLAN
Plan compiled from architectural CAD data.

Plan is subject to final survey after completion of construction.

PRINTED 20 NOV 2019 ISSUE 1