Rapíd Plans www.rapídplans.com.au P.O. Box 6193 Frenchs Forest DC NSW 2086 Fax: (02) 9905-8865 Mobíle: 0414-945-024 Emaíl: gregg@rapídplans.com.au




ORAWING No.	DESCRIPTION	REV	ISSUED DATE
DA1000	Cover Sheet	-	- 1-10-2020
DA1001	A4 NOTIFICATION PLAN	-	- 1-10-2020
DA1002	SITE SURVEY	-	- 1-10-2020
DA1003	SITE SURVEY 2	-	- 1-10-2020
DA1004	SITE PLAN	-	- 1-10-2020
DA1005	Existing Ground Floor Plan	-	- 1-10-2020
DA1006	Existing Roof Plan	-	- 1-10-2020Mike Pa
DA1007	Demolition Ground Floor Plan	-	- 1-10-2020
DA1008	Demolition Roof Plan	-	- 1-10-2020
DA1009	Excavation & Fill Plan	-	- 1-10-2020
DA1010	Landscape Open Space Plan Existing	-	- 1-10-2020
DA1011	Landscape Open Space Existing 2	-	- 1-10-2020
DA1012	Landscape Open Space Plan Proposed	-	- 1-10-2020
DA1013	Landscape Open Space Proposed 2	-	- 1-10-2020
DA1014	Landscape Plan	-	- 1-10-2020
DA1015	Landscape Plan 2	-	- 1-10-2020
DA1016	Sediment & Erosion Plan	-	- 1-10-2020
DA1017	Waste Management Plan	-	- 1-10-2020
DA1018	Waste Management Plan 2	-	- 1-10-2020 hton S
DA1019	Stormwater Plan	-	- 1-10-2020
DA1020	Stormwater Plan 2	-	- 1-10-2020
DA2001	GROUND FLOOR	-	- 1-10-2020
DA2002	GROUND FLOOR 2	-	- 1-10-2020
DA2003	GROUND FLOOR 3	-	- 1-10-2020
DA2004	ROOF PLAN	-	- 1-10-2020
DA3000	SECTION 1	-	- 1-10-2020
DA3001	SECTION 2	-	- 1-10-2020
DA3002	SECTION 3	-	- 1-10-2020
DA4000	ELEVATIONS 1	-	- 1-10-2020
DA4001	ELEVATIONS 2	-	- 1-10-2020
DA4002	ELEVATIONS 3	-	- 1-10-2020
DA5000	PERSPECTIVE	-	- 1-10-2020
DA5001	MATERIAL & COLOUR SAMPLE BOARD	-	- 1-10-2020



BUILDING DESIGNERS ASSOCIATION OF AUSTRALIA



A C C R E D I T E D BUILDING DESIGNER

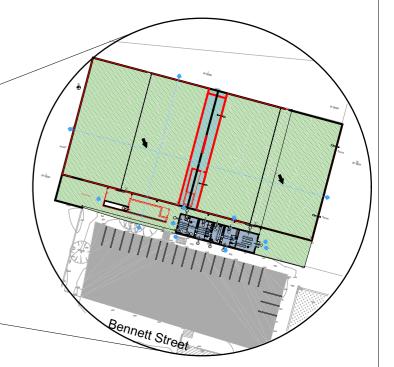



Project summary		
Project name	Harbord Bowling Cl	lub
Street address	4/0 Bennett Street Curl Curl 2096	
Local Government Area	Northern Beaches Council	
Plan type and plan number	deposited 601758	
Lot no.	4	
Section no.	-	
Project type	separate dwelling h	ouse
No. of bedrooms	0	
Project score		
Water	4 0	Target 40
Thermal Comfort	V Pass	Target Pass
Energy	✓ 51	Target 50

Certificate Prepared by

Name / Company Name: Rapid Plans

ABN (if applicable): 43150064592

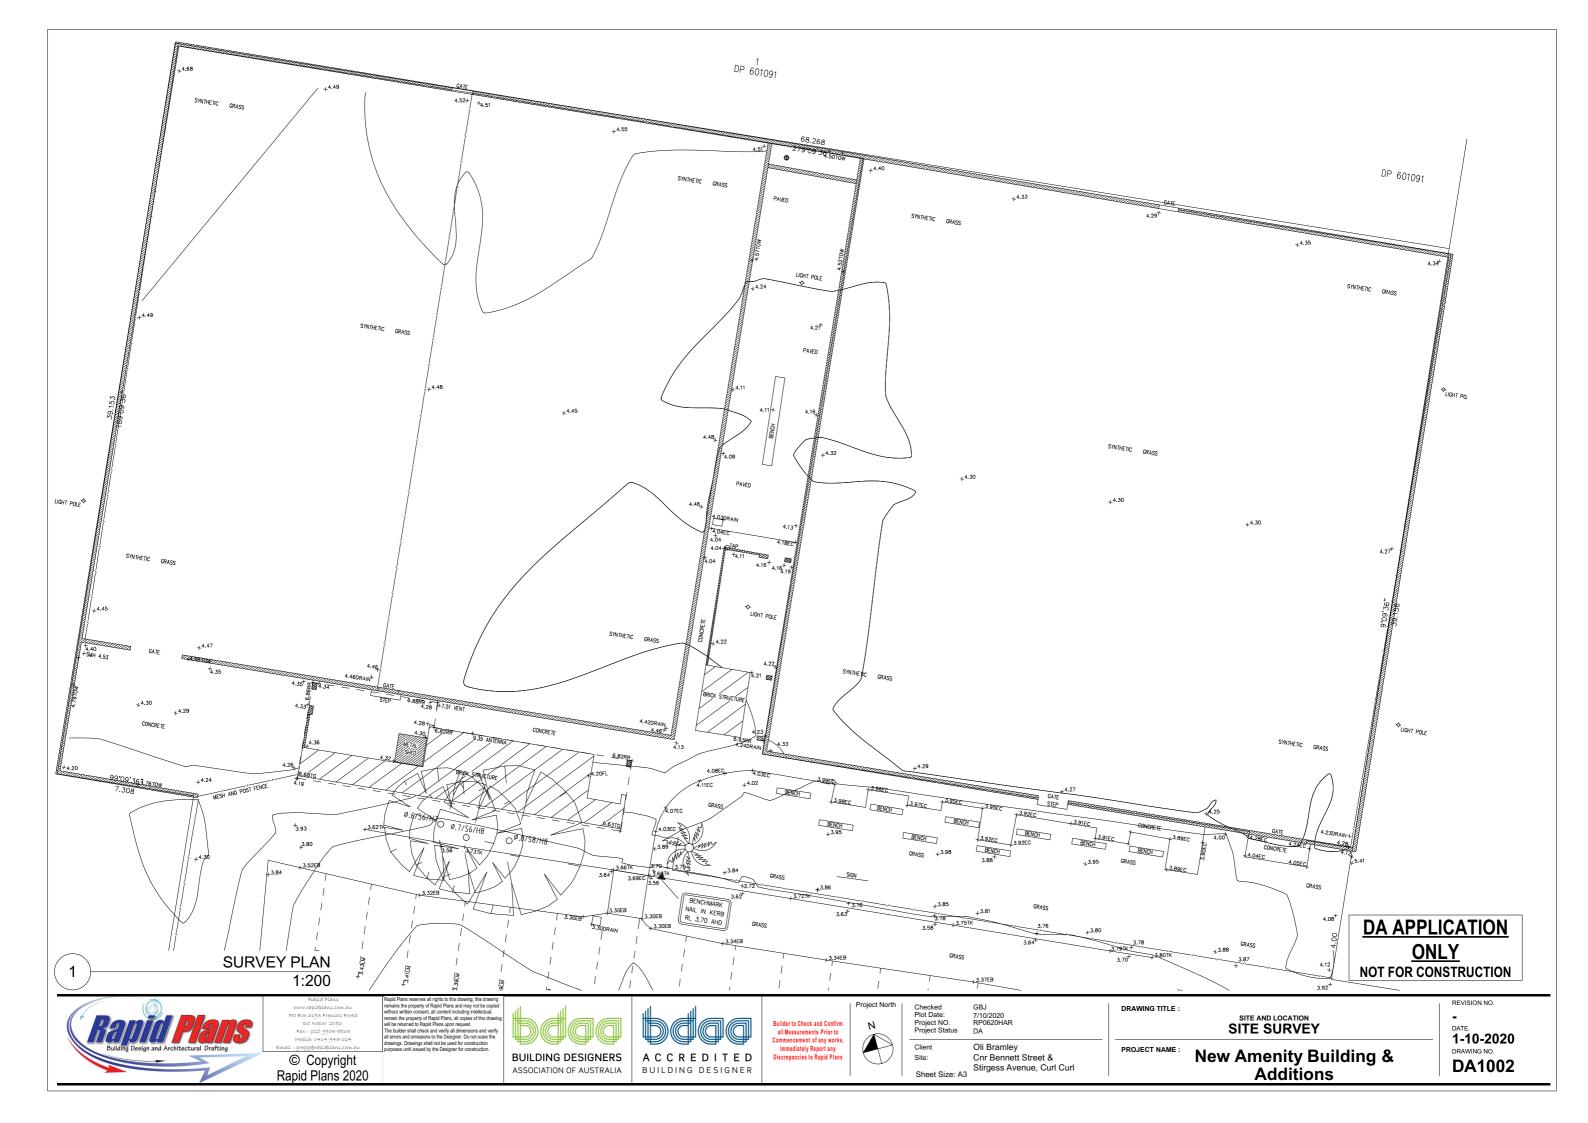

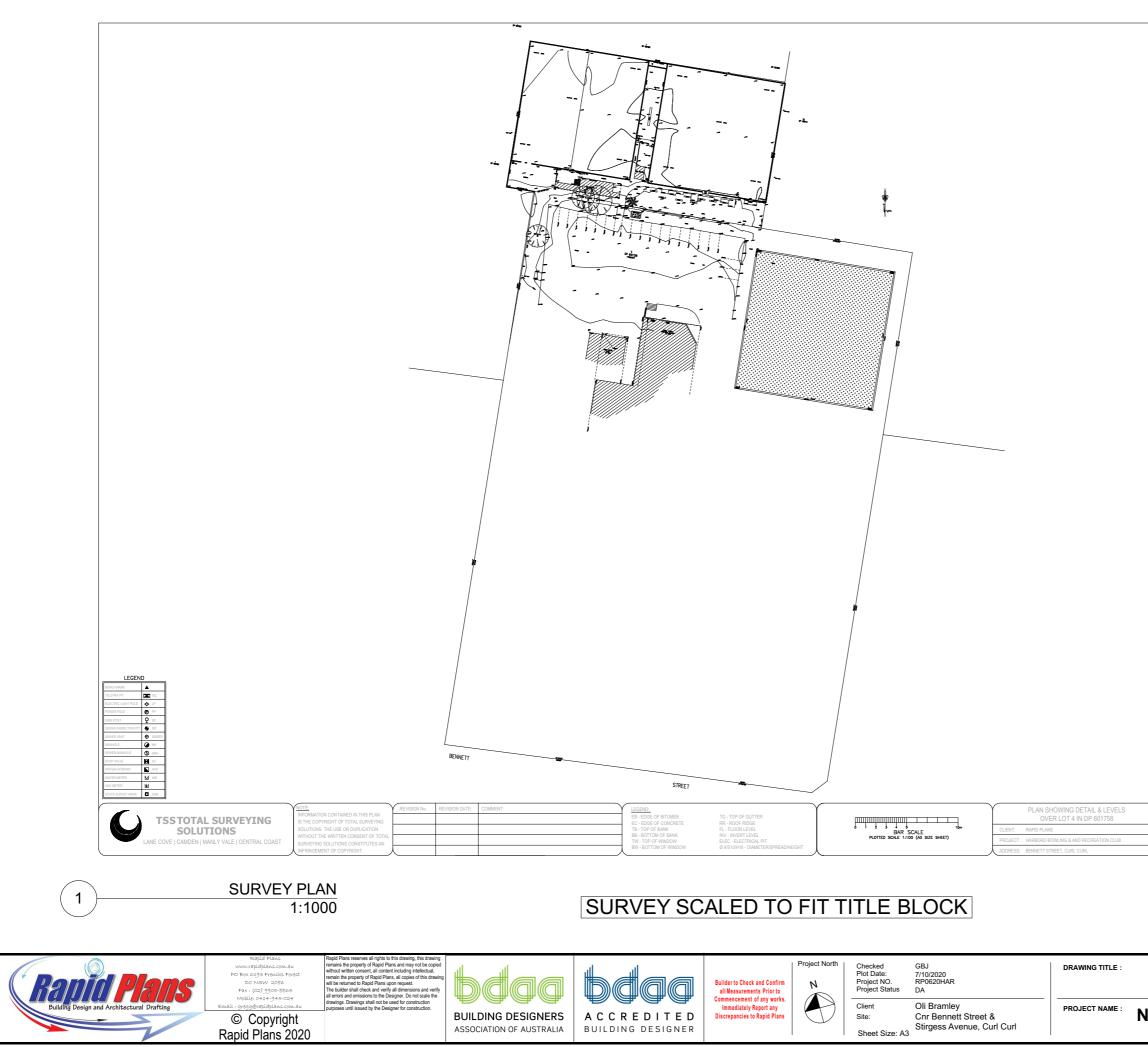

New Amenity Building & Additions

REVISION NO.

DRAWING NO.

DATE. 1-10-2020

DA1003


-


DA APPLICATION <u>ONLY</u> NOT FOR CONSTRUCTION


Y JOB No.: 200643	LGA:NORTHERN BEACH
PLAN No.: 200643-1	DATUM: AHD
DATE: 11/05/2020	SCALE: 1:100@A0
DRAWN: FS	CONT. INTERVAL: 0.25m
CHK: XX	SHEET 1 OF 3

SITE AND LOCATION

	Paul Johnston Registered Surveyor № 5878
JOB No.: 200643	LGA:NORTHERN BEACHES
PLAN No.: 200643-1	DATUM: AHD
DATE: 11/05/2020	SCALE: 1:100@A0
DRAWN: FS	CONT. INTERVAL: 0.25m

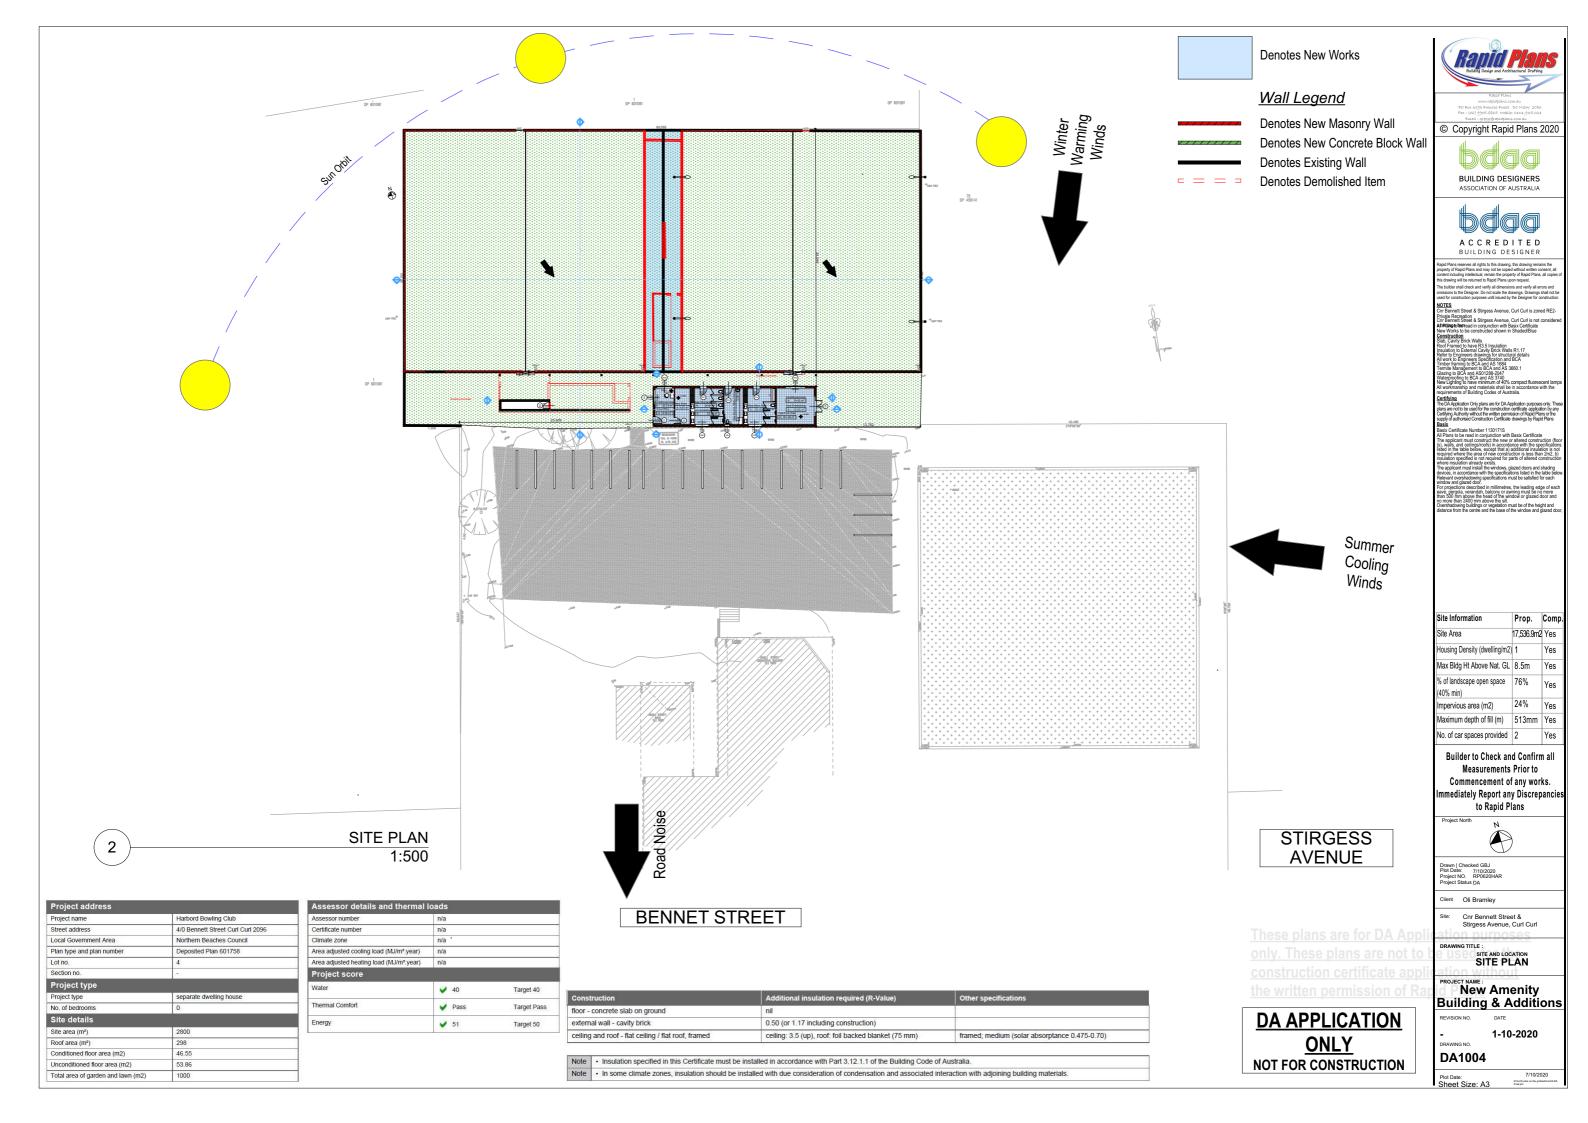

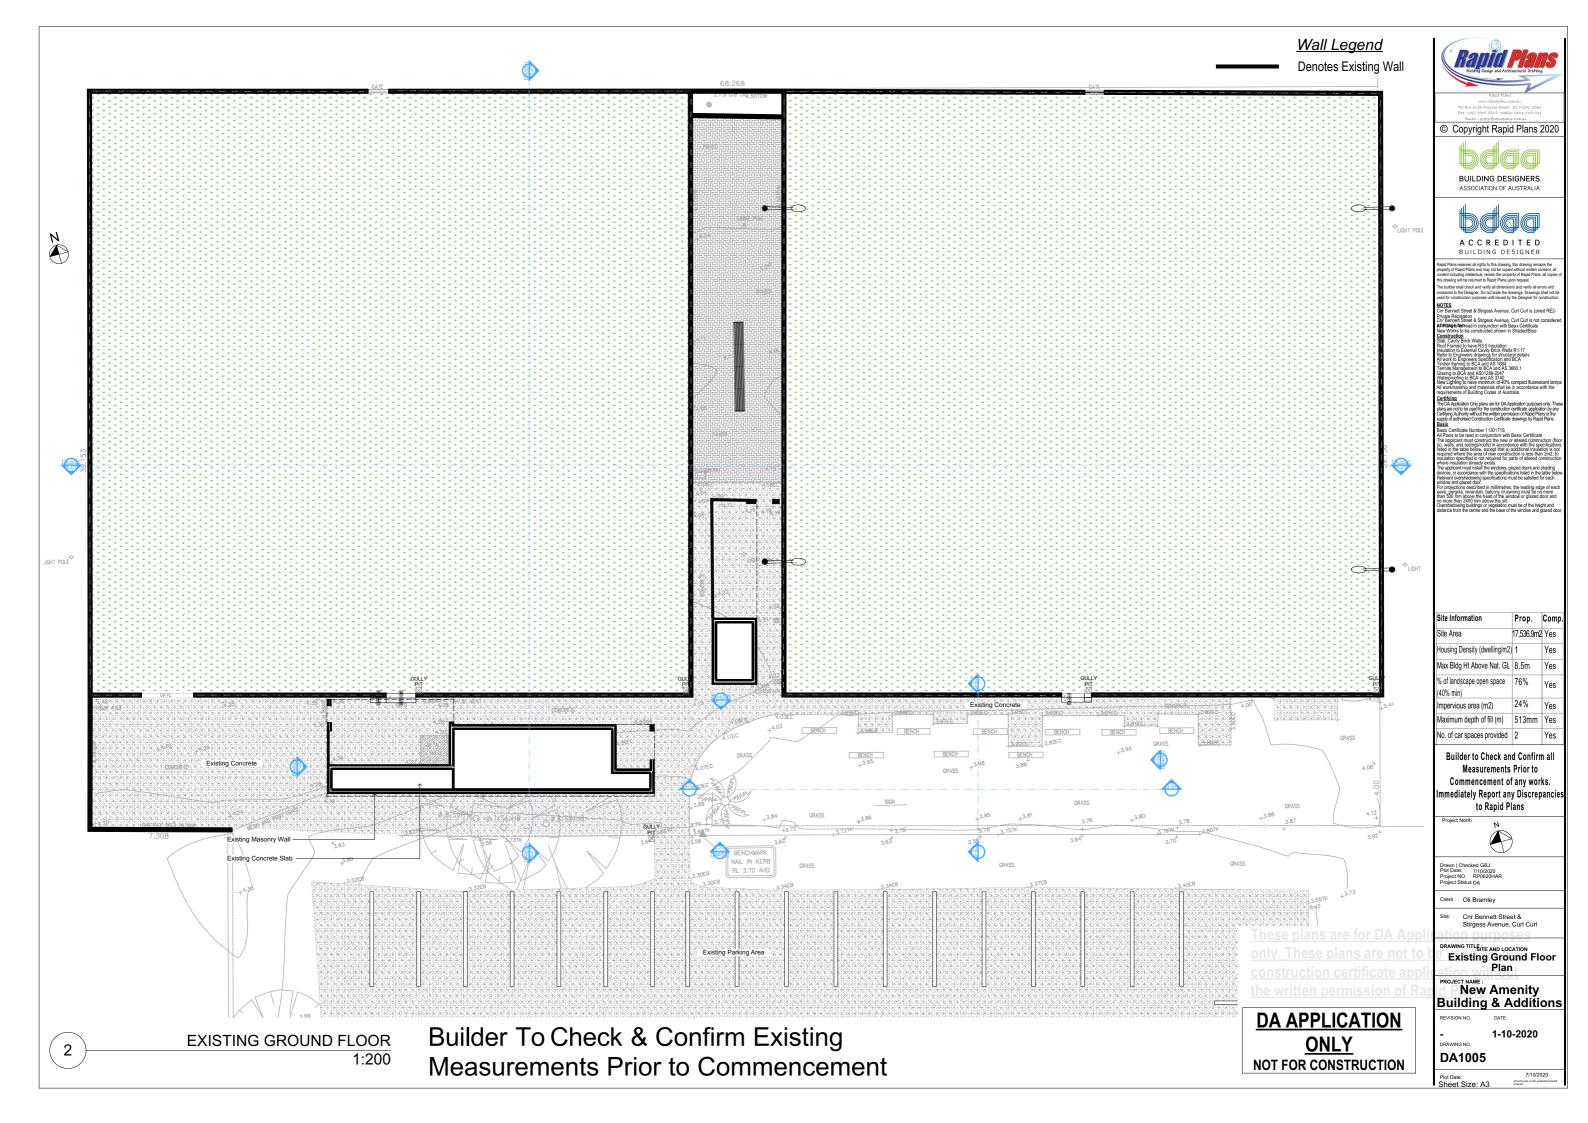

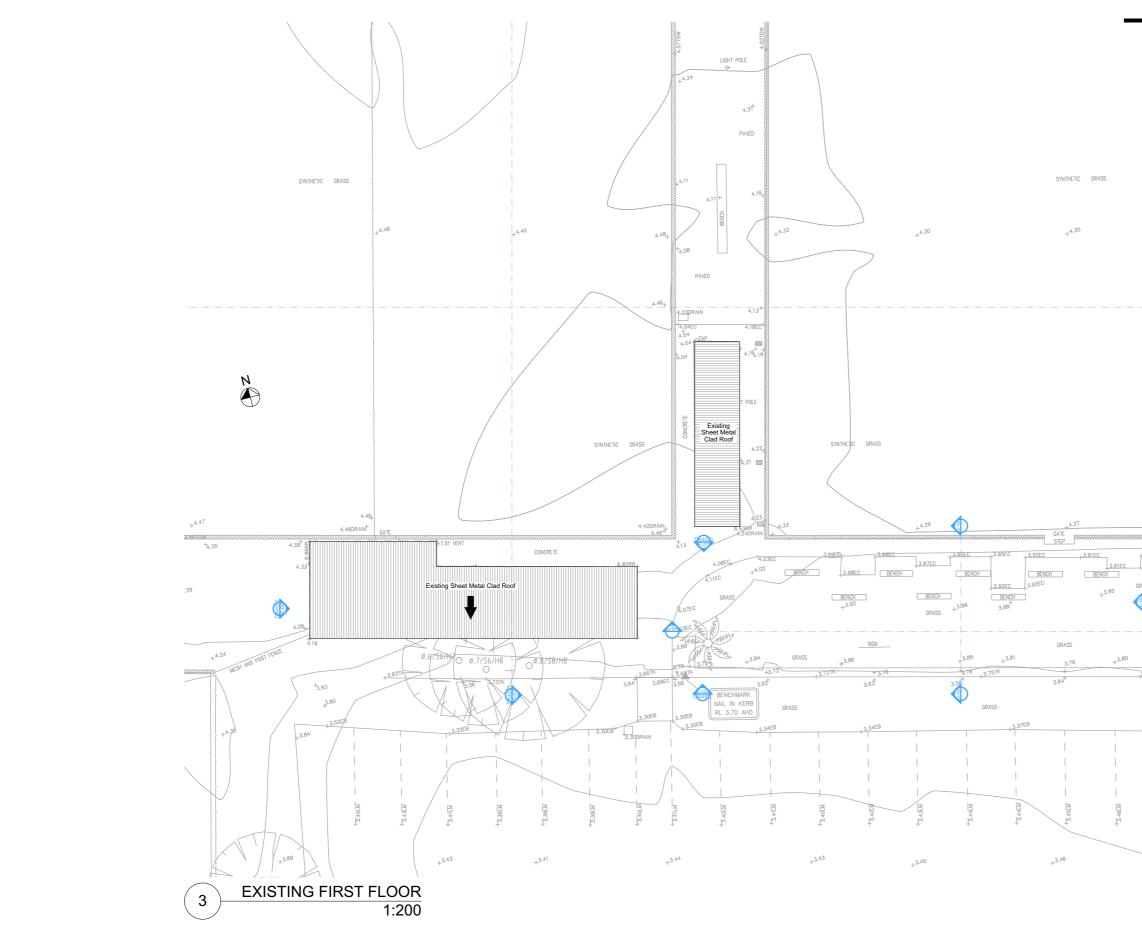

Builder To Check & Confirm Existing Measurements Prior to Commencement

-conucre te	• Denotes Existing Wall	Rest Provide State of the State	to Halve Jobe Local - 46-024 I Plans 2 I Plans 2 IGNERS USTRALIA IGNERS USTRALIA I Conference I Conferenc	In the all and the second seco
	J.GAEC	Site Information	Prop.	Comp.
BENCH	1 8050	Site Area	17,536.9m2	Yes
ISS I	- <u>3.89EC</u>	Housing Density (dwelling/m2)	1	Yes

3.78

3.70

-,<u>3,</u>40EB | |

+<u>250</u>

. <u>These plans are for DA A</u> <u>only. These plans are not</u> <u>construction certificate a</u> the written permission of



 Site Information
 Prop.
 Comp

 Site Area
 17,536.9m2
 Yes

 Housing Density (dwelling/m2)
 1
 Yes

 Max Bldg Ht Above Nat. GL
 8.5m
 Yes

 % of landscape open space (40% min)
 76%
 Yes

 Impervious area (m2)
 24%
 Yes

 Maximum depth of fill (m)
 513mm
 Yes

 No. of car spaces provided
 2
 Yes

Builder to Check and Confirm all Measurements Prior to Commencement of any works. Imediately Report any Discrepancie to Rapid Plans

Project North



Drawn | Checked GBJ Plot Date: 7/10/2020 Project NO. RP0620HAR Project Status DA

ent Oli Bramley


Cnr Bennett Street & Stirgess Avenue, Curl Curl


RAWING TITLE : SITE AND LOCATION Existing Roof Plan





- 1-10-2020 DRAWING NO. DA1006

Plot Date: Sheet Size: A3 7/10/2020 D'Archi jobs on the golifactions 22 " Final pin

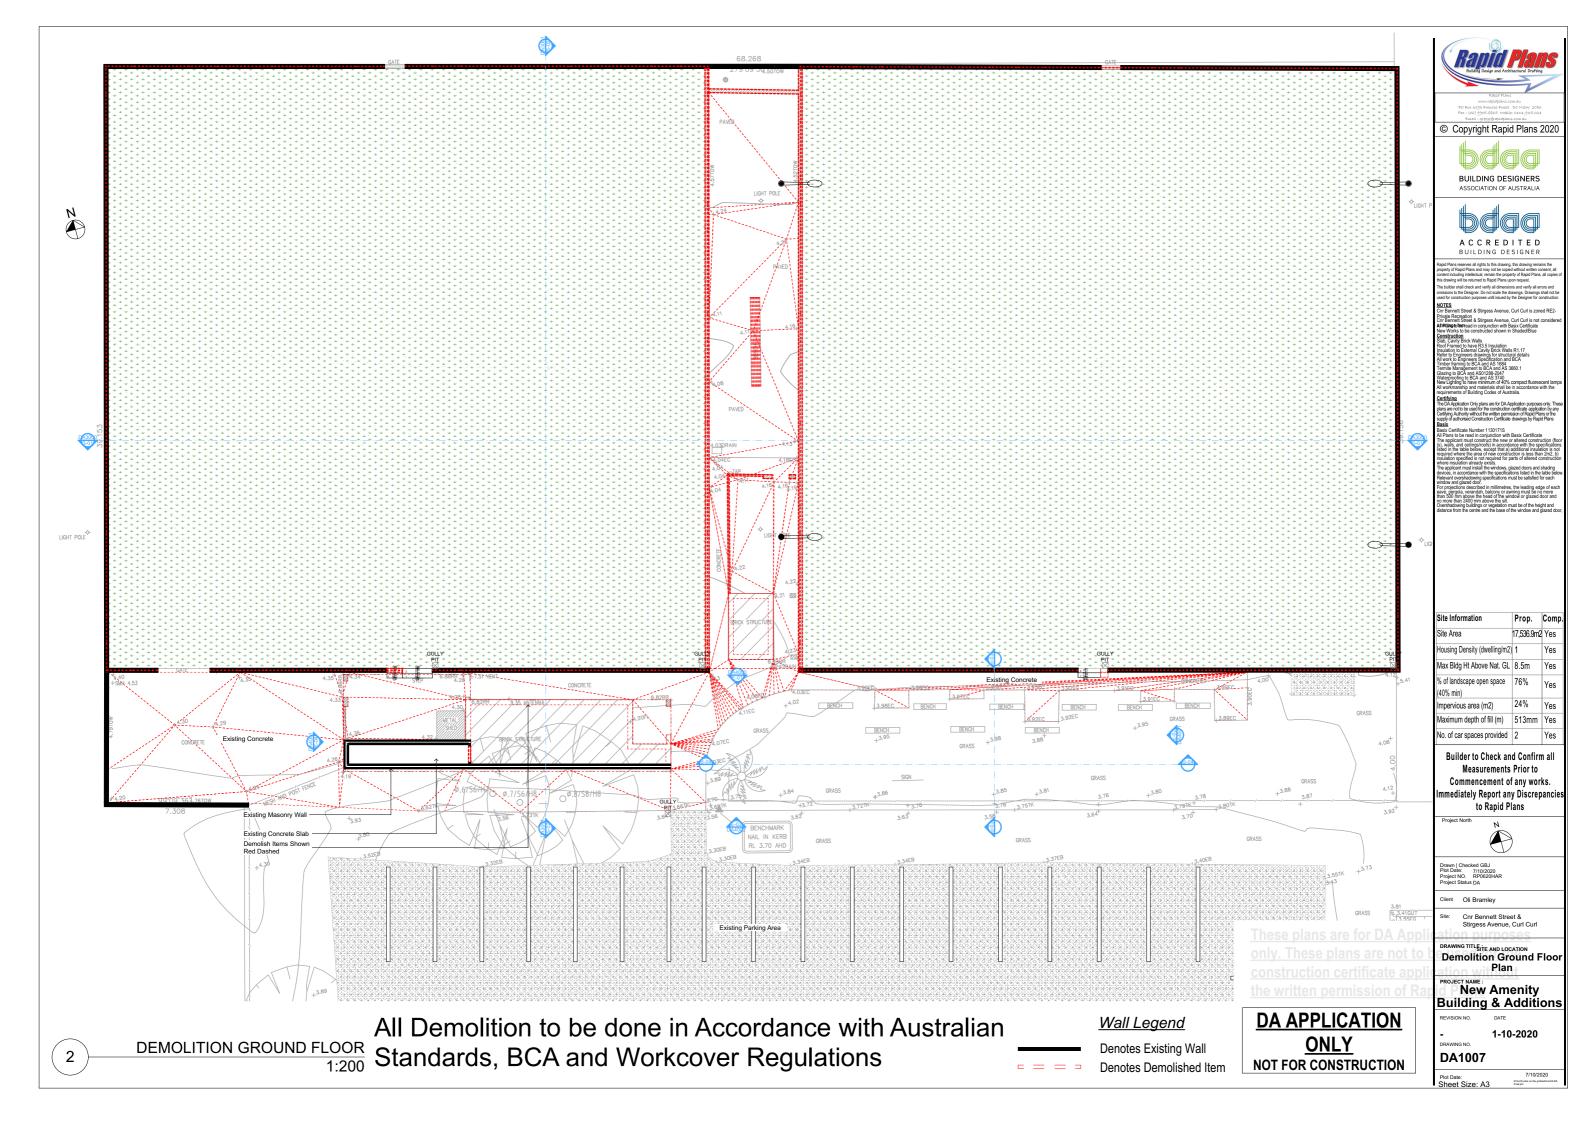

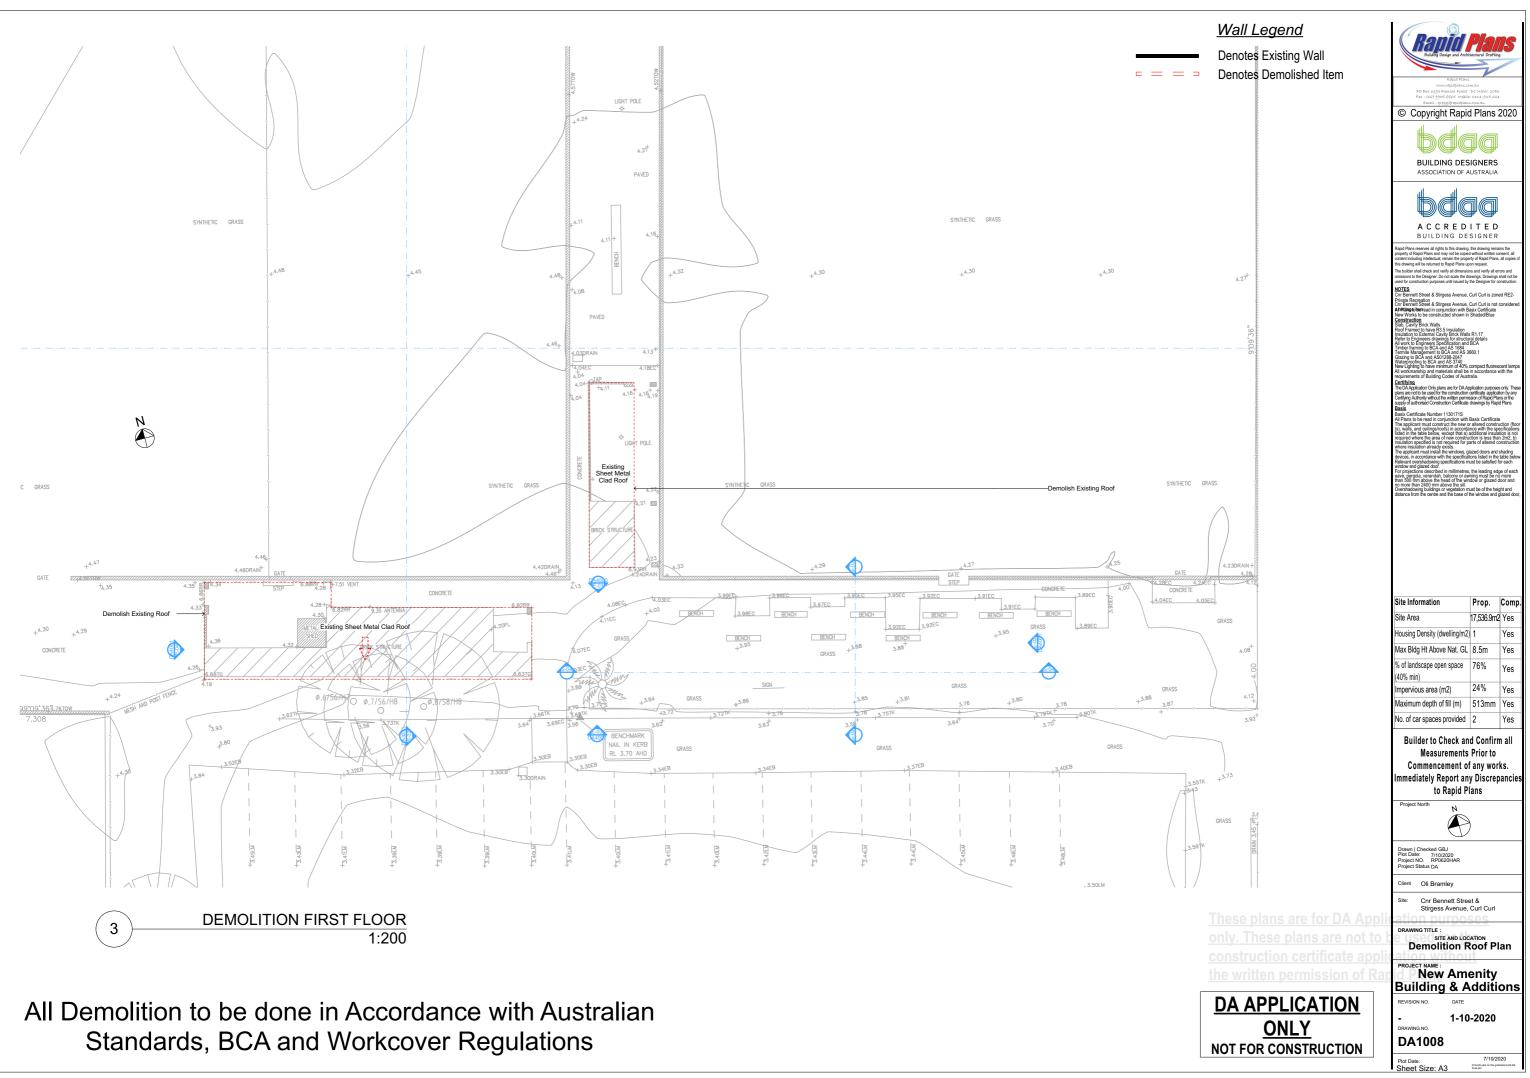

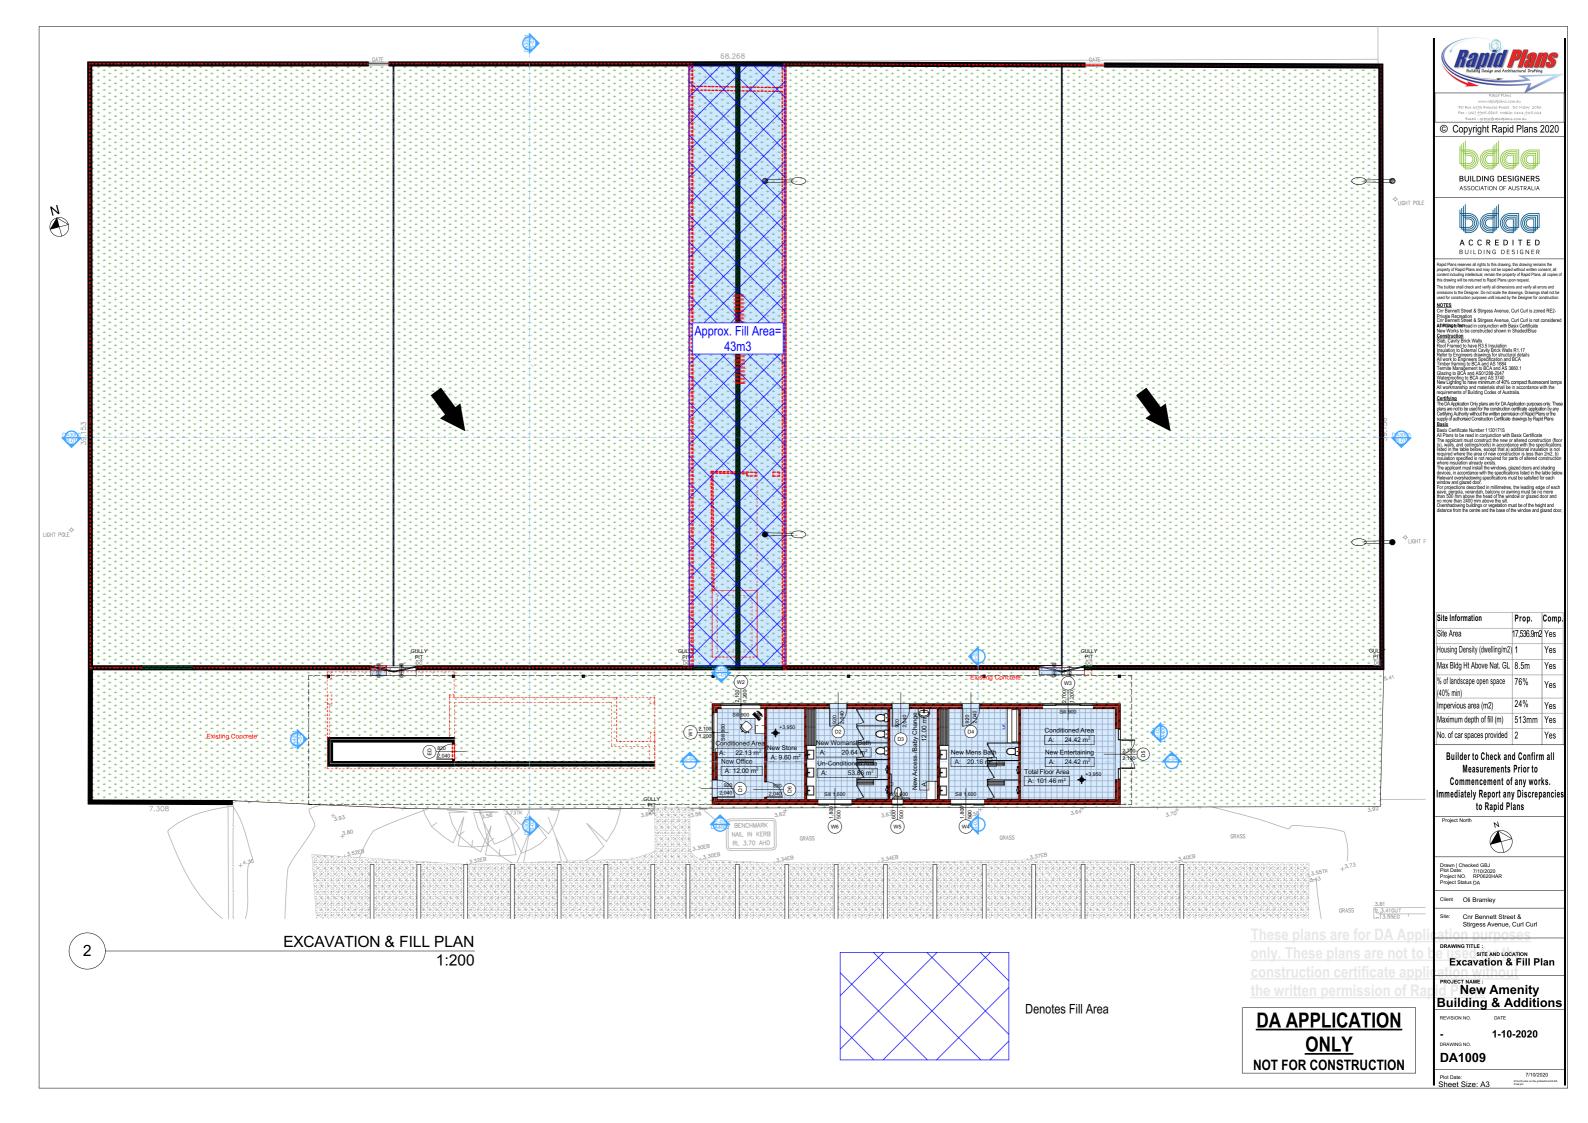

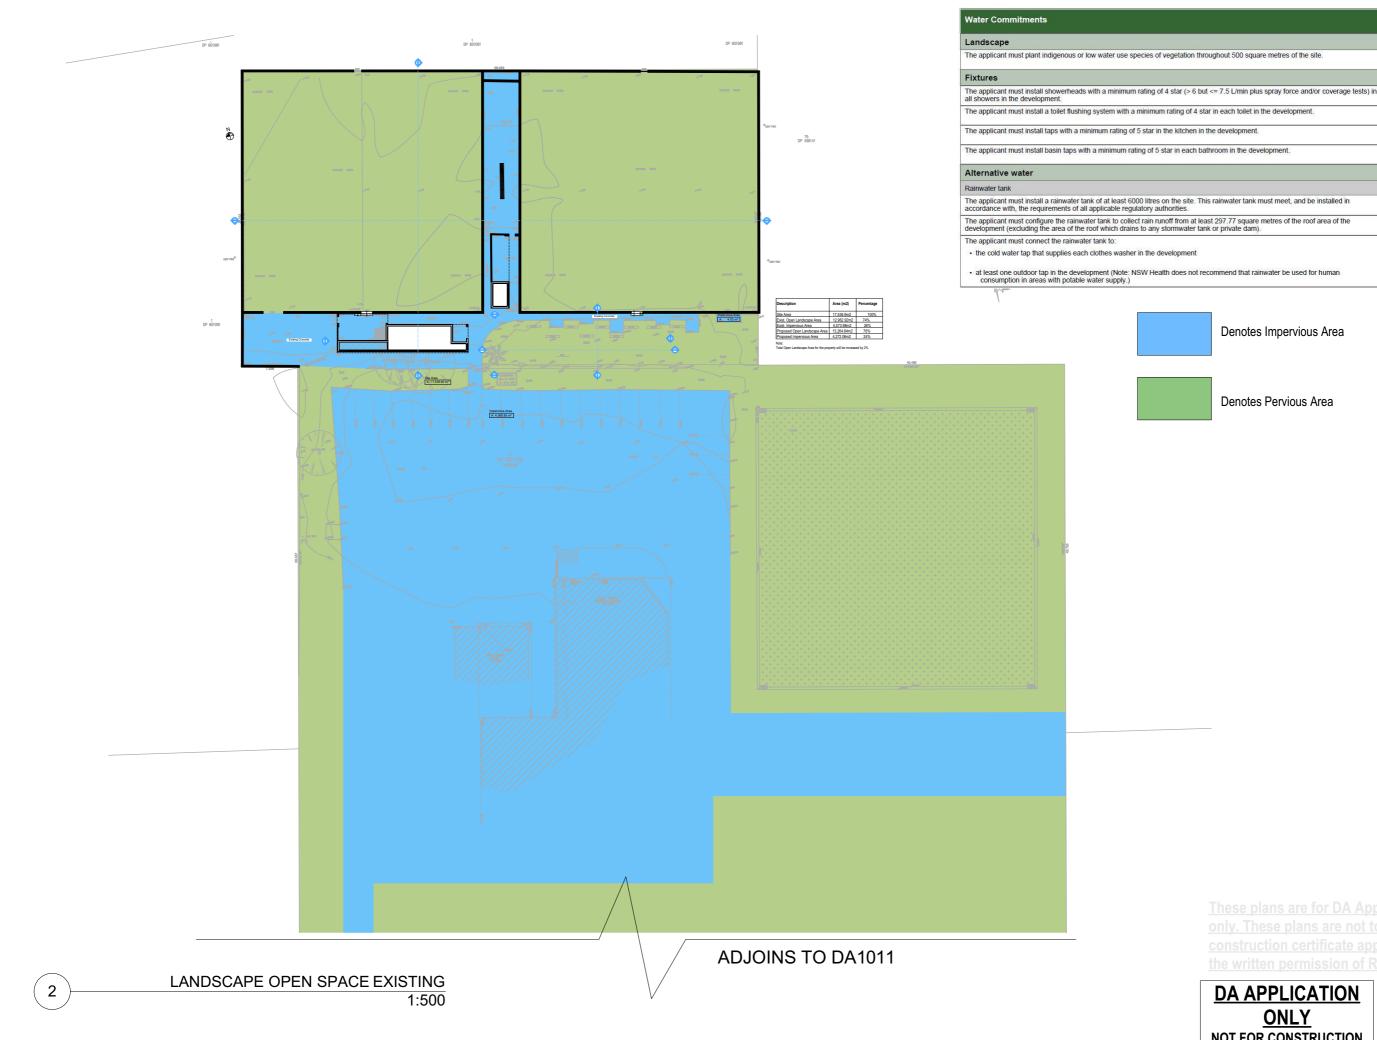

Denotes Impervious Area

Denotes Pervious Area

DA APPLICATION

ONLY

NOT FOR CONSTRUCTION

Rapid P © Copyright Rapid Plans 2020 " GPGPG BUILDING DESIGNERS ASSOCIATION OF AUSTRALIA dqq A C C R E D I T E D BUILDING DESIGNER erves all rights to this drawing, this draw s and verify all errors The bind and a strange of the strang Altimeter and in conjur w Works to be construct anstruction ab, Cavity Brick Walls r to Engineers drawings for ork to Engineers Specifica er framing to BCA and AS tructural deta n and BCA S 3660.1 shadowing projections described in millimetres, the leading edge of ex e, pergola, verandah, balcony or awning must be no more 1500 mm above the head of the window or glazed door and vore than 2400 mm above the sill. Site Information Prop. Comp 17,536.9m2 Yes Site Area Yes ousing Density (dwelling/m2) 1 Max Bldg Ht Above Nat. GL 8.5m Yes 6 of landscape open space 76% Yes (40% min) 24% Yes mpervious area (m2) laximum depth of fill (m) 513mm Yes No. of car spaces provided 2 Yes

Builder to Check and Confirm all Measurements Prior to Commencement of any works. mmediately Report any Discrepancie to Rapid Plans



Drawn | Checked GBJ Plot Date: 7/10/2020 Project NO. RP0620HAF Project Status DA

ient Oli Bramley

Site:

Cnr Bennett Street & Stirgess Avenue, Curl Curl







Sheet Size: A3


Plot Date

7/10/2020 D'Archijobs on Final.pin


Landscape	
The applicant must plant indigenous	or low water use species of vegetation throughout 500 square metres of the site.
Fixtures	
The applicant must install showerhe all showers in the development.	ads with a minimum rating of 4 star (> 6 but <= 7.5 L/min plus spray force and/or coverage tests) in
The applicant must install a toilet flu	shing system with a minimum rating of 4 star in each toilet in the development.
The applicant must install taps with a	a minimum rating of 5 star in the kitchen in the development.
The applicant must install basin taps	with a minimum rating of 5 star in each bathroom in the development.
Alternative water	
Rainwater tank	
	r tank of at least 6000 litres on the site. This rainwater tank must meet, and be installed in f all applicable regulatory authorities.
	water tank to collect rain runoff from at least 297.77 square metres of the roof area of the he roof which drains to any stormwater tank or private dam).
The applicant must connect the rain	vater tank to:

 at least one outdoor tap in the development (Note: NSW Health does not recommend that rainwater be used for human consumption in areas with potable water supply.)

ADJOINS TO DA1010

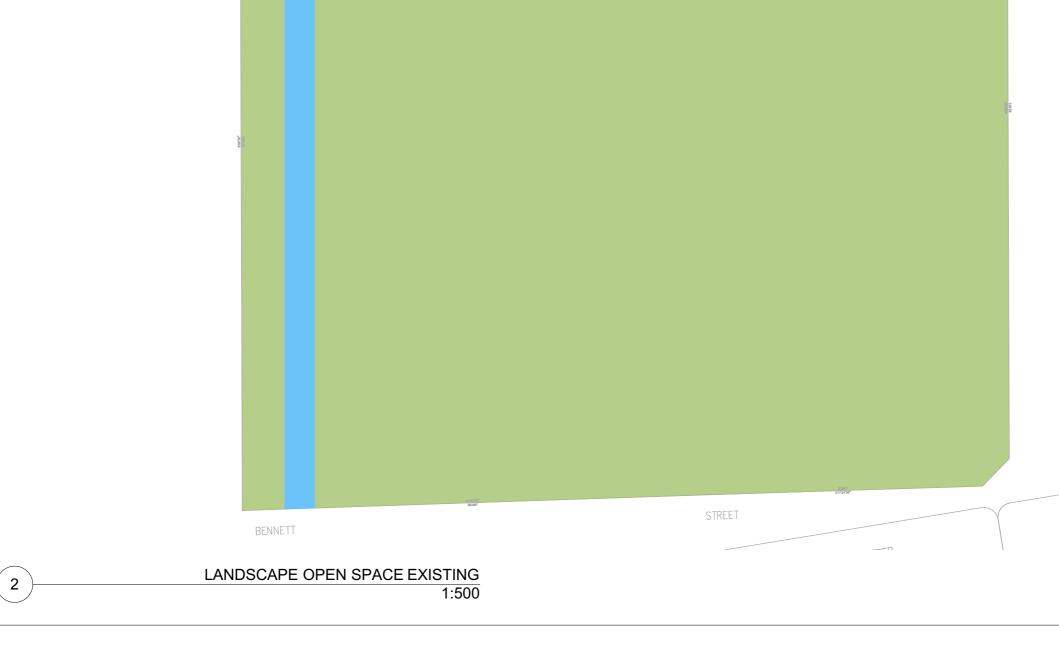

	Denotes Impervious Area	Rapid Buldin Design and Archi		15
		www.rapidplans.cr PO Box 619x Frenchs Forest Fax : (02) 9905-8865 Mpkily Email : gregg@rapidplan	DC NSW 2084	
	Denotes Pervious Area	© Copyright Rapio	d Plans :	2020
		BUILDING DES ASSOCIATION OF A		
		Rapid Plans reserves all rights to this drawing, property of Rapid Plans and may not be copie content including intellectual, remain the prope	, this drawing rema d without written co rty of Rapid Plans,	nsent, all
		this drawing will be returned to Rapid Plans up The builder shall check and verify all dimensio omissions to the Designer. Do not scale the dr used for construction purposes until issued by	ion request. ns and verify all en awings. Drawings	ors and shall not be
		NOTES Crr Bennett Street & Stirgess Avenue, Private Recreation Crr Bennett Street & Stirgess Avenue, AtPetingeriser ead in conjunction with B New Works to be constructed shown in <u>Construction</u> Siab, Cavity Britch Walls Roof Framed to have R3.5 Institution.	Curl Curl is not asix Certificate Shaded/Blue	considered
		Stab, Cavity Brick Walls Roof Frandt of have R3.5 Installion Insulation to External Cavity Brick Walls Refer to Engineers Specification and Timber framing to BCA and R3 1684 Termite Management to BCA and R3 5 Gazard to BCA and R4 Star R4 Gazard to BCA and R4 Star R4 Gazard to BCA and R4 Star R4 Hand R4 R4 R4 R4 R4 R4 Workmarkhan and materials shall be requirements of Building Codes of Aust Cavitation	ral details BCA 660.1 compact fluores in accordance v ralia.	cent lamps /ith the
		Certifying The DA Application Only plans are for DA Application plans are not to be used for the construction Certifying Authority without the written permis supply of authorised Construction Certificate Basix	plication purpose certificate applicat ssion of Rapid Pla drawings by Rapi	s only. These ion by any ns or the d Plans
		A pair and a certificate Number 11301735 All Plans to be read in onjunction with The applicant must construct the new of (s), walks, and collings/roots/in accords listed in the table below, except that a), required where the area of new constru- insulation specified is not required forp where insulation already vesits, news, g devices, in accordance with the specifica- fetimes, in accordance with the specifications on perference of the standard standard standard standard standard devices, in accordance with the specifications on	Basix Certificate r altered constru- ince with the sp additional insula ction is less that arts of altered o	iction (floor scifications tion is not n 2m2, b) onstruction
		The applicant has insear the wholeves, you devices, in accordance with the specifical Relevant overshadowing specifications me window and glazed door. For projections described in millimetres eave, pergola, verandah, belacony or aw than 500 mm above the head of the win on more than 2400 mm above the sill. Overshadowing buildings or vegetation m distance from the center and the base of	, the leading edg ming must be no idow or glazed o	e of each more loor and
		Site Information	Prop.	Comp.
		Site Area	Prop. 17,536.9m2	· · · ·
		Housing Density (dwelling/m2)		Yes
		Max Bldg Ht Above Nat. GL		Yes
		% of landscape open space	8.5m 76%	Yes
		(40% min) Impervious area (m2)	24%	Yes
		Maximum depth of fill (m)	513mm	Yes
		No. of car spaces provided	2	Yes
		Builder to Check an Measurements Commencement of Immediately Report an to Rapid P	Prior to f any wor y Discrep	ks.
		Project North)	
		Drawn Checked GBJ Plot Date: 7/10/2020 Project NO. RP0620HAR Project Status DA		
		Site: Cnr Bennett Stree Stirgess Avenue,		
The	<u>se plans are for DA Appli</u> . These plans are not to b	DRAWING TITLEITE AND LOC		309
	struction certificate applic written permission of Rap	PROJECT NAME : New Ame	g 2 enity	
<u> </u>	APPLICATION	Building & A REVISION NO. DATE		ons
	ONLY	DRAWING NO.	-2020	
NOT	FOR CONSTRUCTION	DA1011 Plot Date:	7/10/20 Diversit jobs on the gali Final pin	
		Sheet Size: A3	⊧inai.pin	

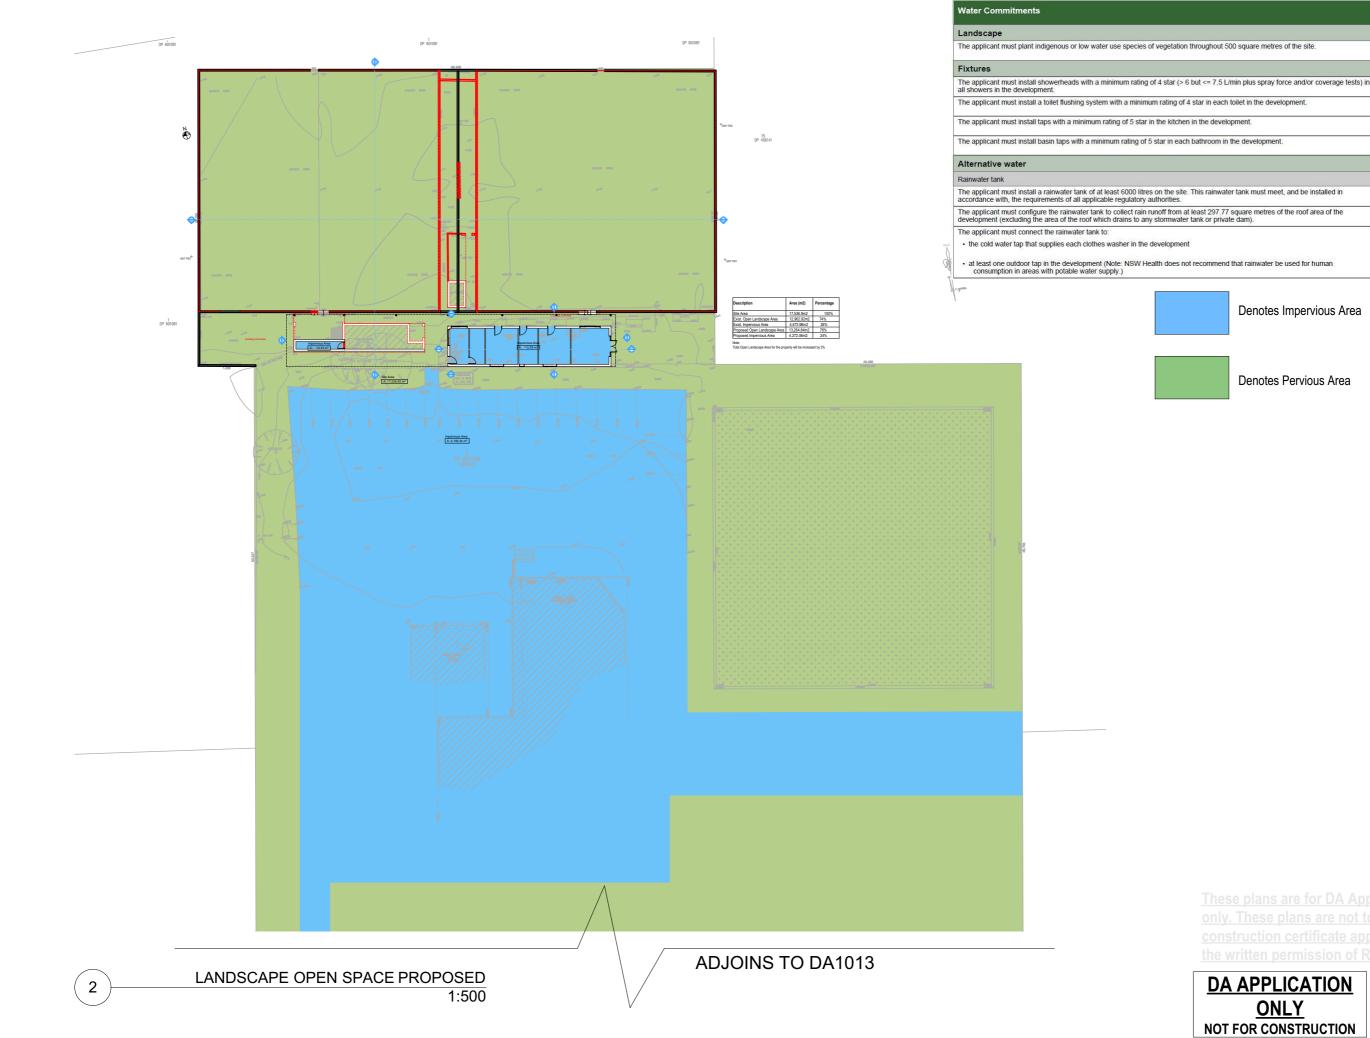

Denotes Impervious Area

Denotes Pervious Area



mmediately Report any Discrepancie to Rapid Plans



Drawn | Checked GBJ Plot Date: 7/10/2020 Project NO. RP0620HAF Project Status DA

ient Oli Bramley

Site:

Cnr Bennett Street & Stirgess Avenue, Curl Curl







Plot Date

ONLY

Sheet Size: A3

7/10/2020 D'Archijobs on Final.pin

Landscape	
The applicant must	plant indigenous or low water use species of vegetation throughout 500 square metres of the site.
Fixtures	
The applicant must all showers in the c	install showerheads with a minimum rating of 4 star (> 6 but <= 7.5 L/min plus spray force and/or coverage tests) in levelopment.
The applicant must	install a toilet flushing system with a minimum rating of 4 star in each toilet in the development.
The applicant must	install taps with a minimum rating of 5 star in the kitchen in the development.
The applicant must	install basin taps with a minimum rating of 5 star in each bathroom in the development.
Alternative wa	ter
Rainwater tank	
	install a rainwater tank of at least 6000 litres on the site. This rainwater tank must meet, and be installed in e requirements of all applicable regulatory authorities.
	configure the rainwater tank to collect rain runoff from at least 297.77 square metres of the roof area of the uding the area of the roof which drains to any stormwater tank or private dam).
The applicant must	connect the rainwater tank to:
the cold water t	ap that supplies each clothes washer in the development
	door tap in the development (Note: NSW Health does not recommend that rainwater be used for human

ADJOINS TO DA1012


STREET

TED



BENNETT


2

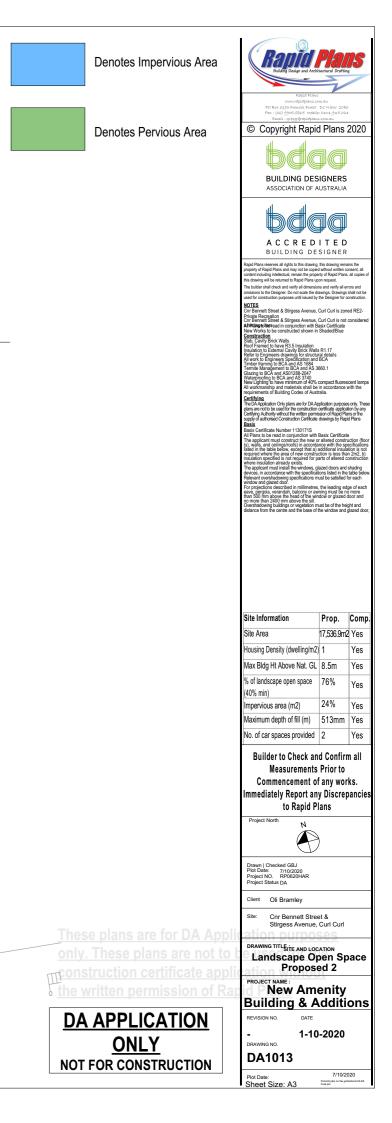




DA APPLICATION

ONLY

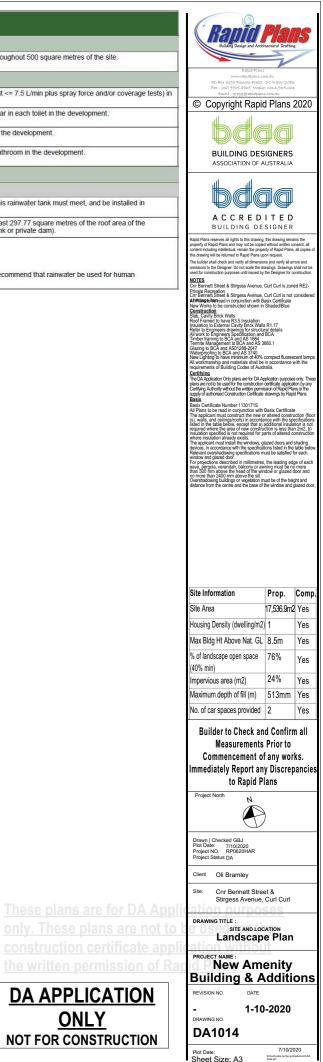

Sheet Size: A3

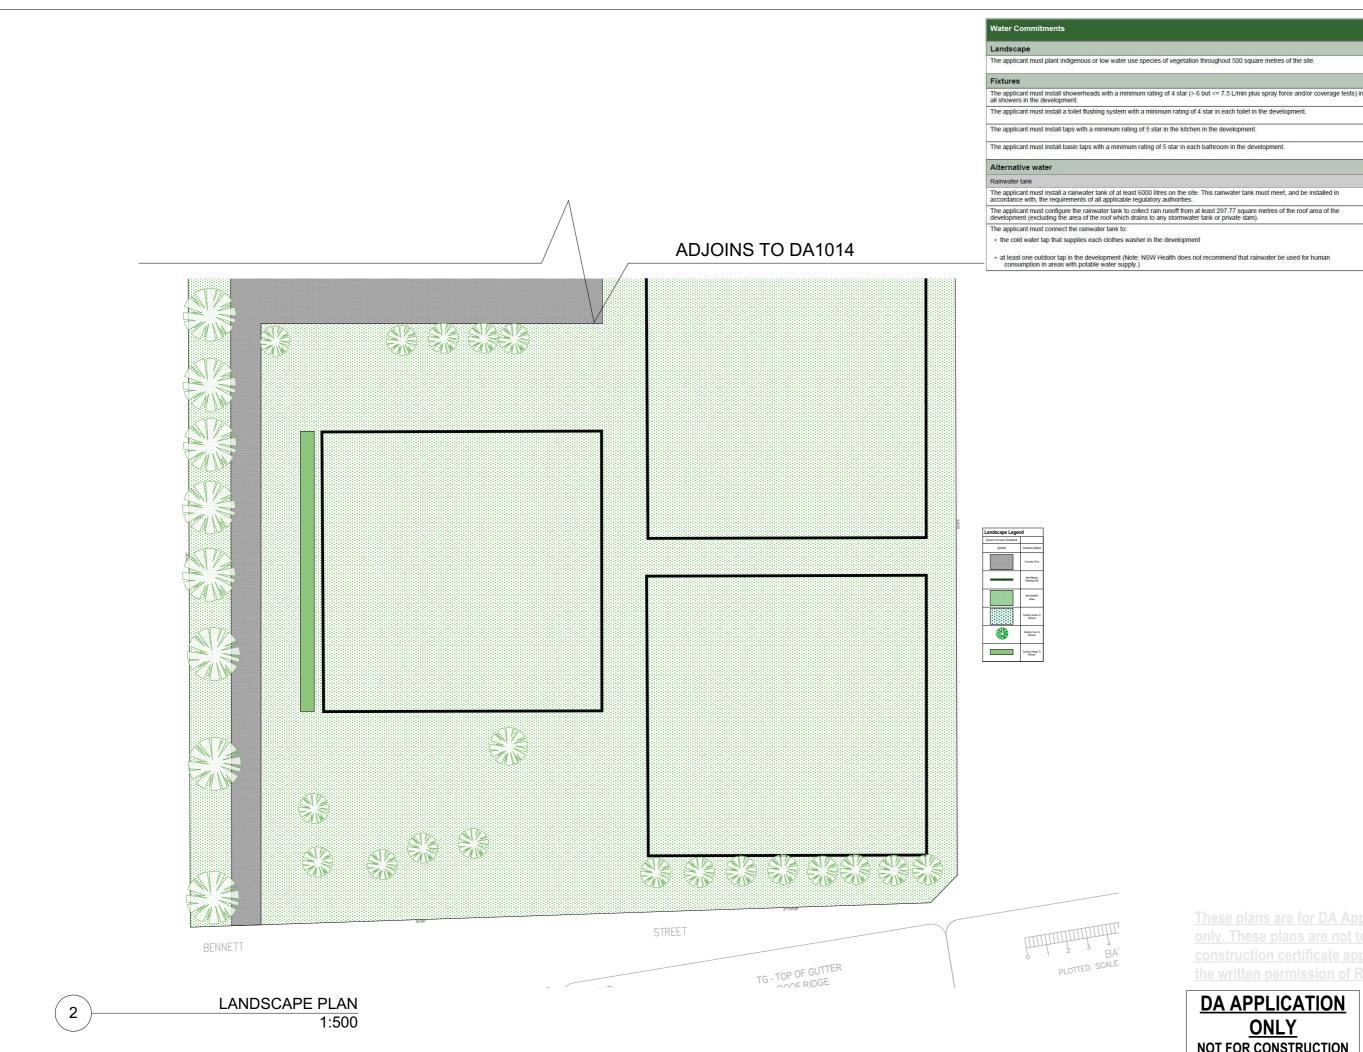

nous or low water use species of vegetation throughout 500 square metres of the site

The applicant must install a rainwater tank of at least 6000 litres on the site. This rainwater tank must meet, and be insi accordance with, the requirements of all applicable regulatory authorities.


DA APPLICATION

ONLY

NOT FOR CONSTRUCTION



D:Archijobs or Final.pin

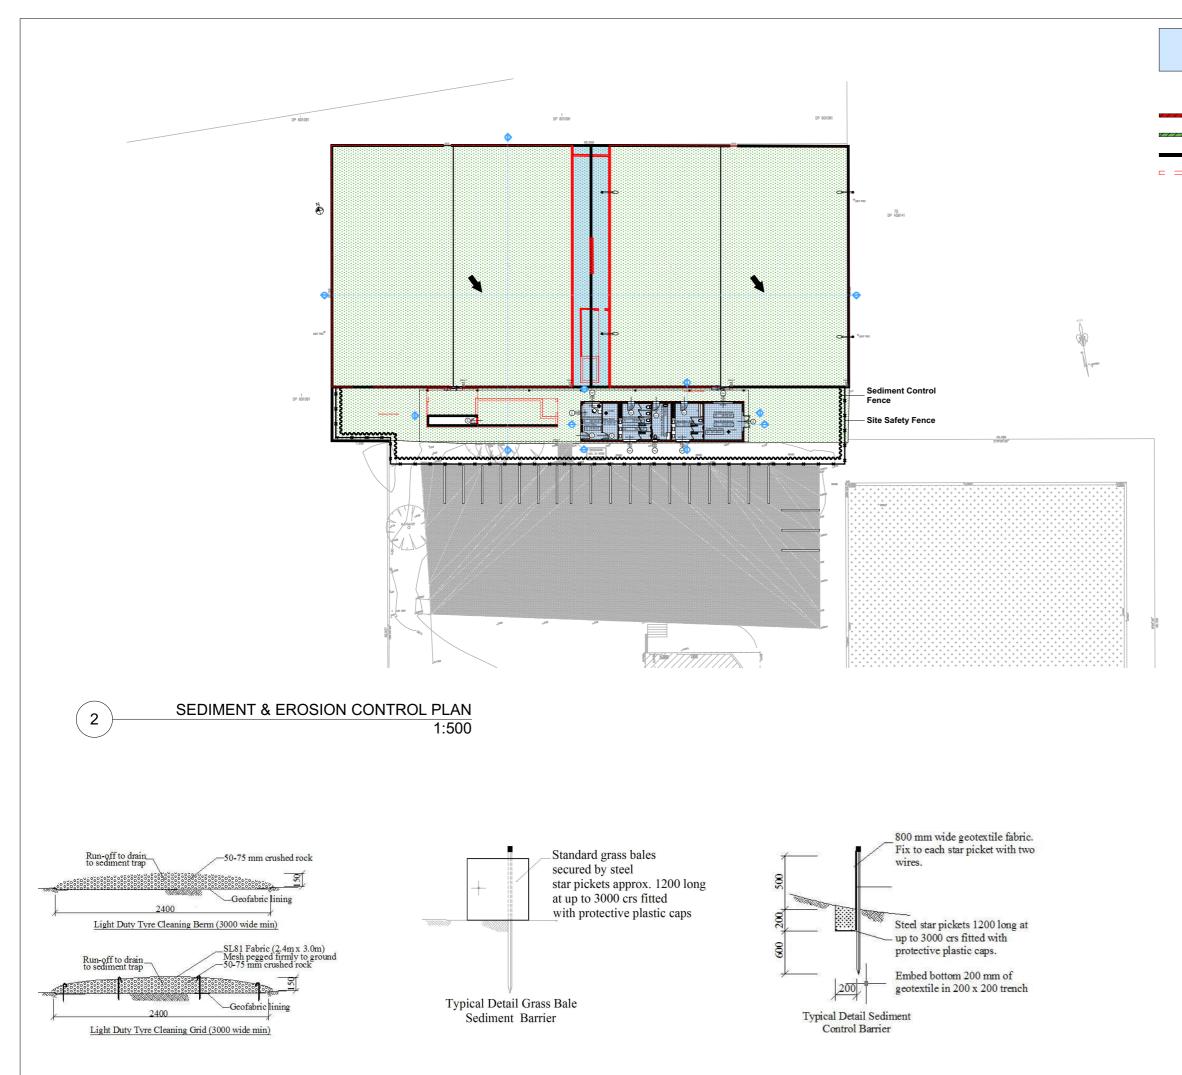

= = =


Wall Legend Denotes New Masonry Wall

Denotes New Concrete Block Wall Denotes Existing Wall Denotes Demolished Item



Sheet Size: A3



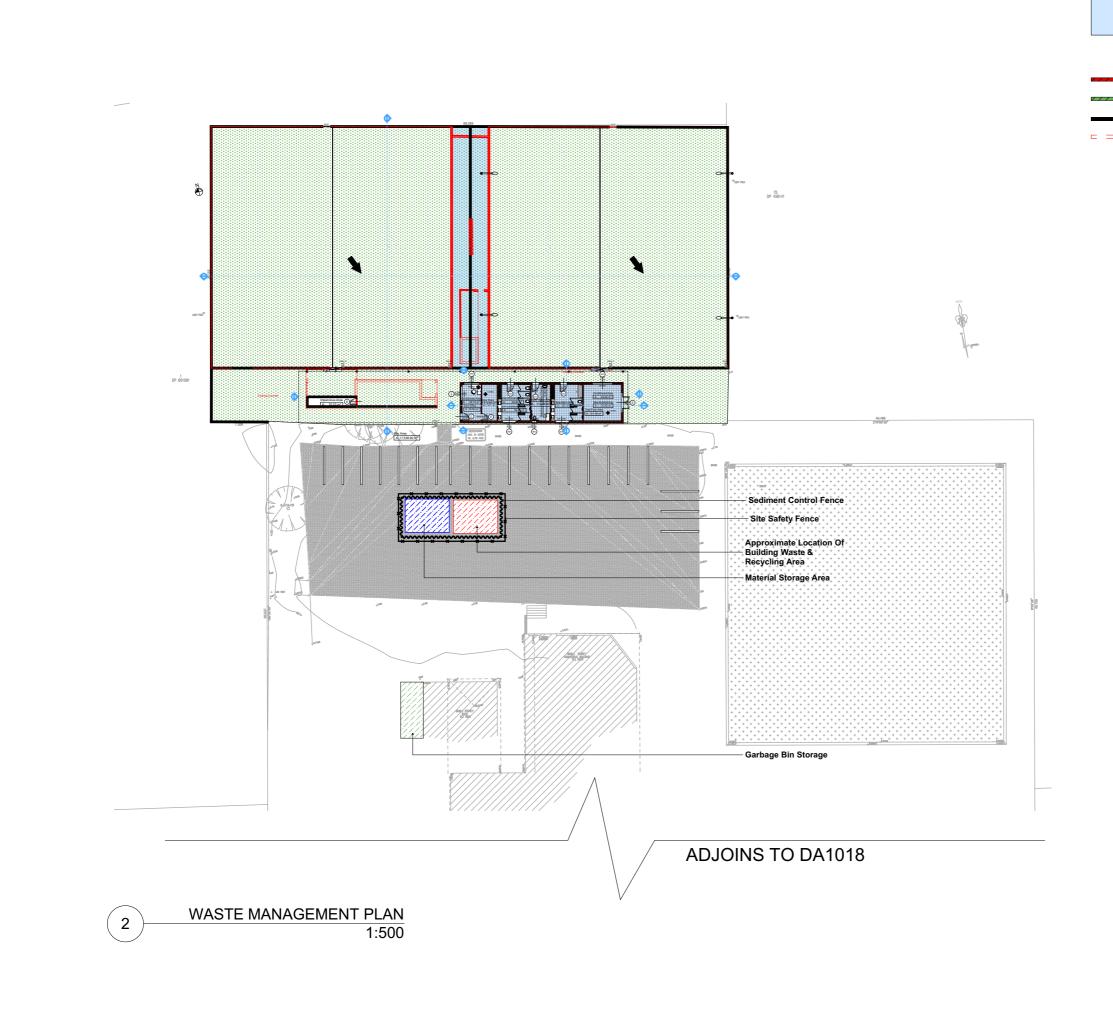

Wall Legend


Denotes New Masonry Wall Denotes New Concrete Block Wall Denotes Existing Wall Denotes Demolished Item

DA APPLICATION

ONLY

NOT FOR CONSTRUCTION



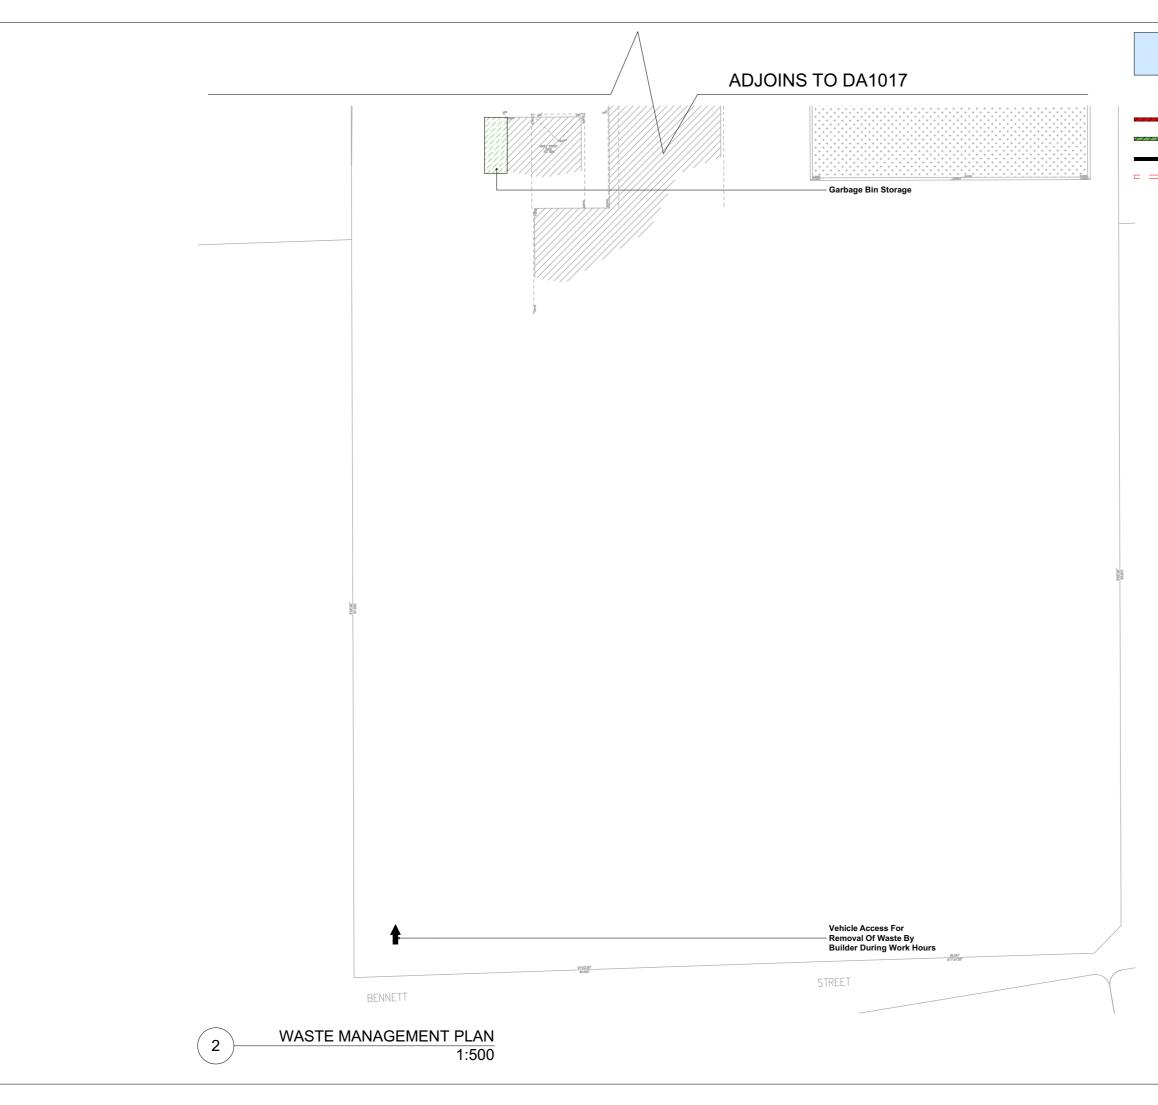

= = =

Wall Legend Denotes New Masonry Wall


DA APPLICATION

ONLY

NOT FOR CONSTRUCTION

Denotes New Concrete Block Wall Denotes Existing Wall Denotes Demolished Item



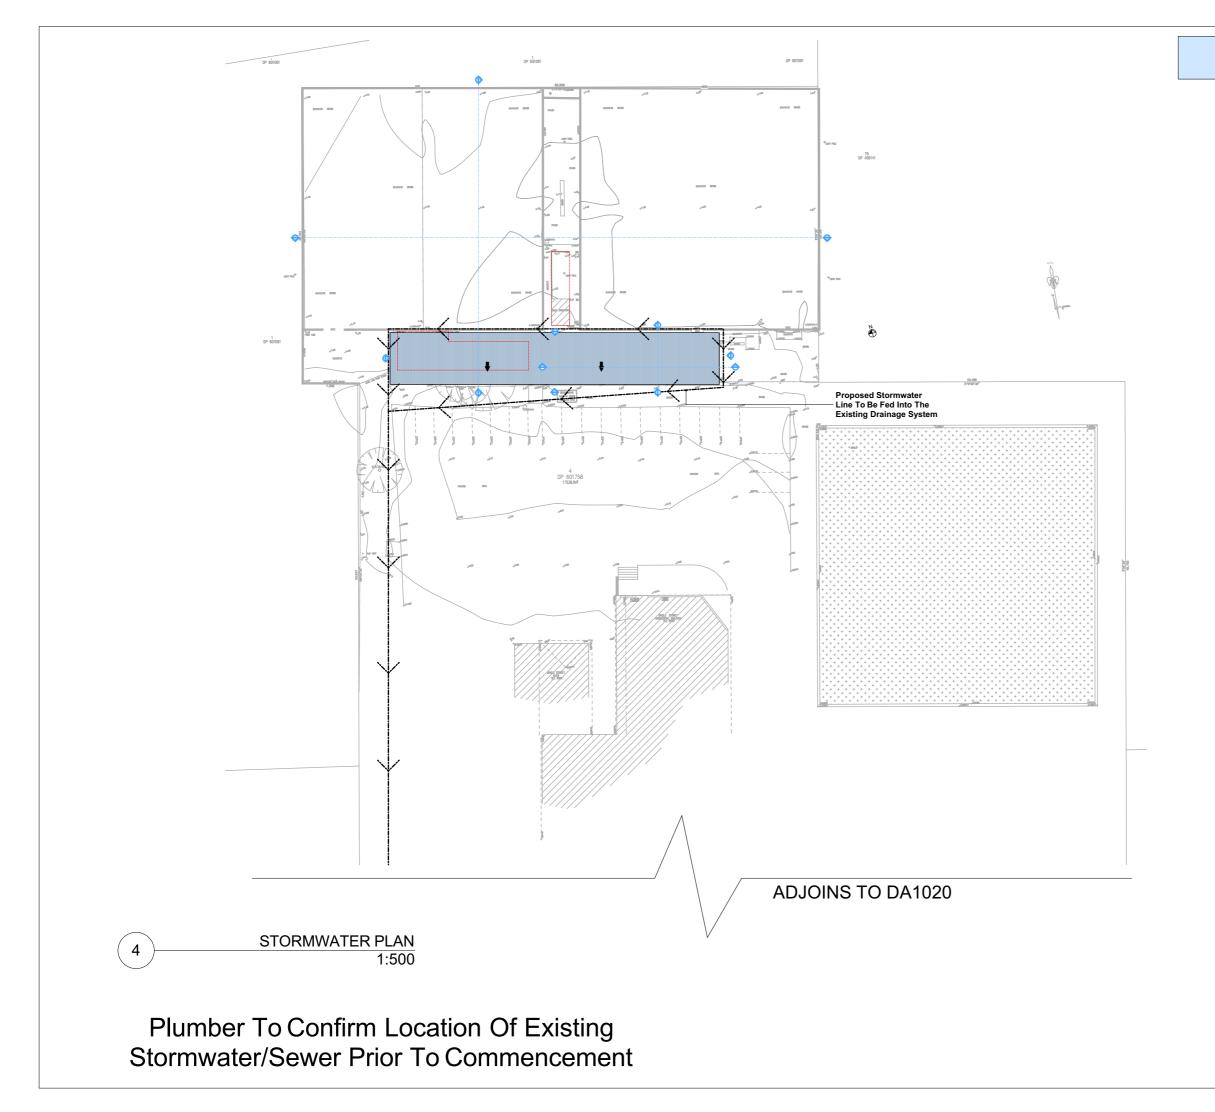




Plot Date:	
Sheet Size:	A3


D:Archijobe Final.pin


DA APPLICATION


ONLY

NOT FOR CONSTRUCTION

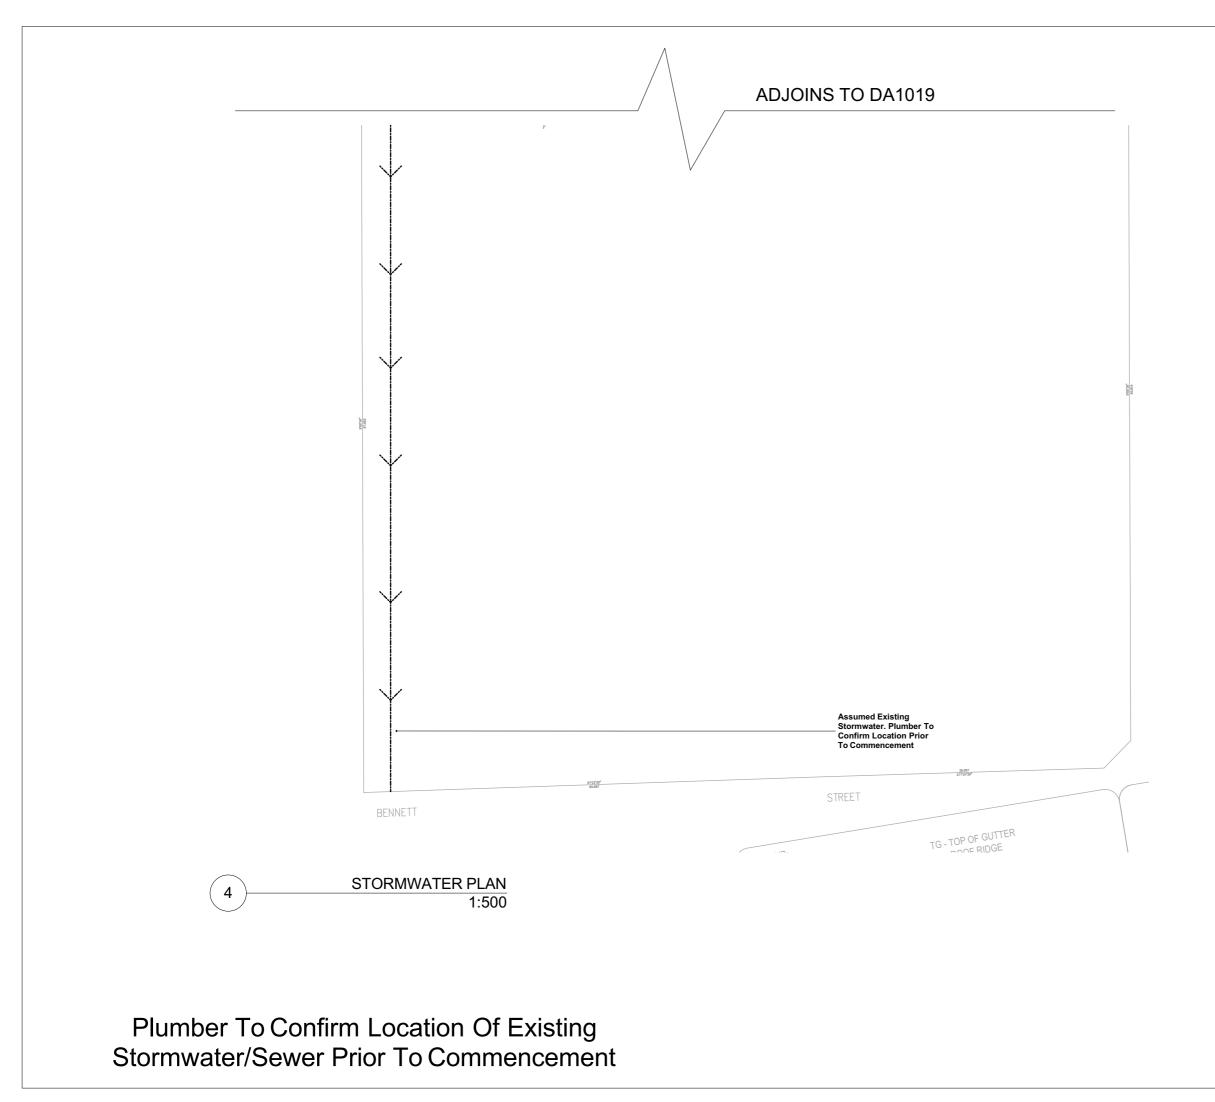

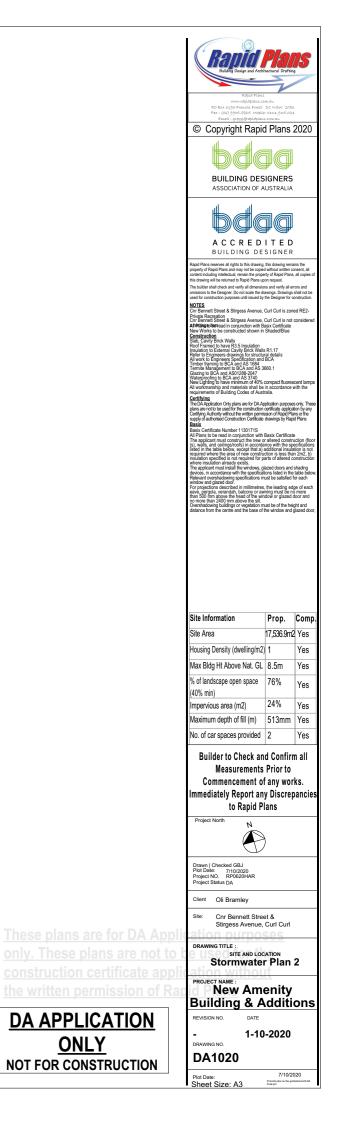

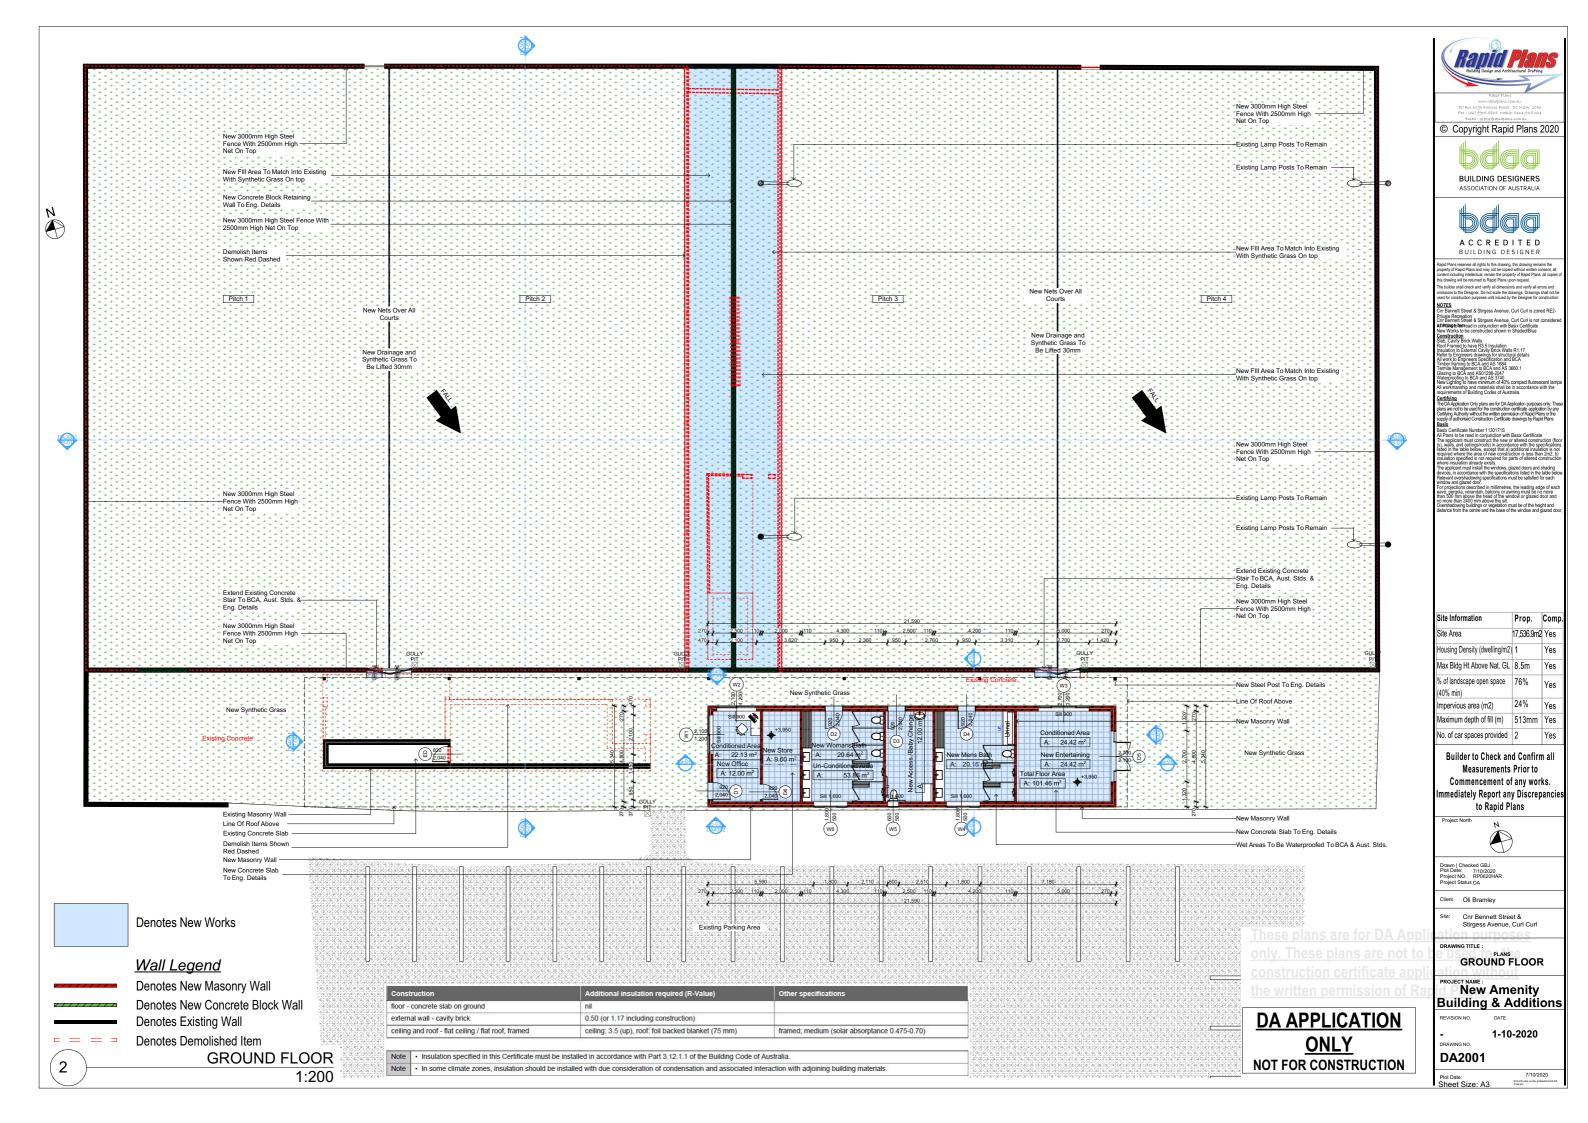

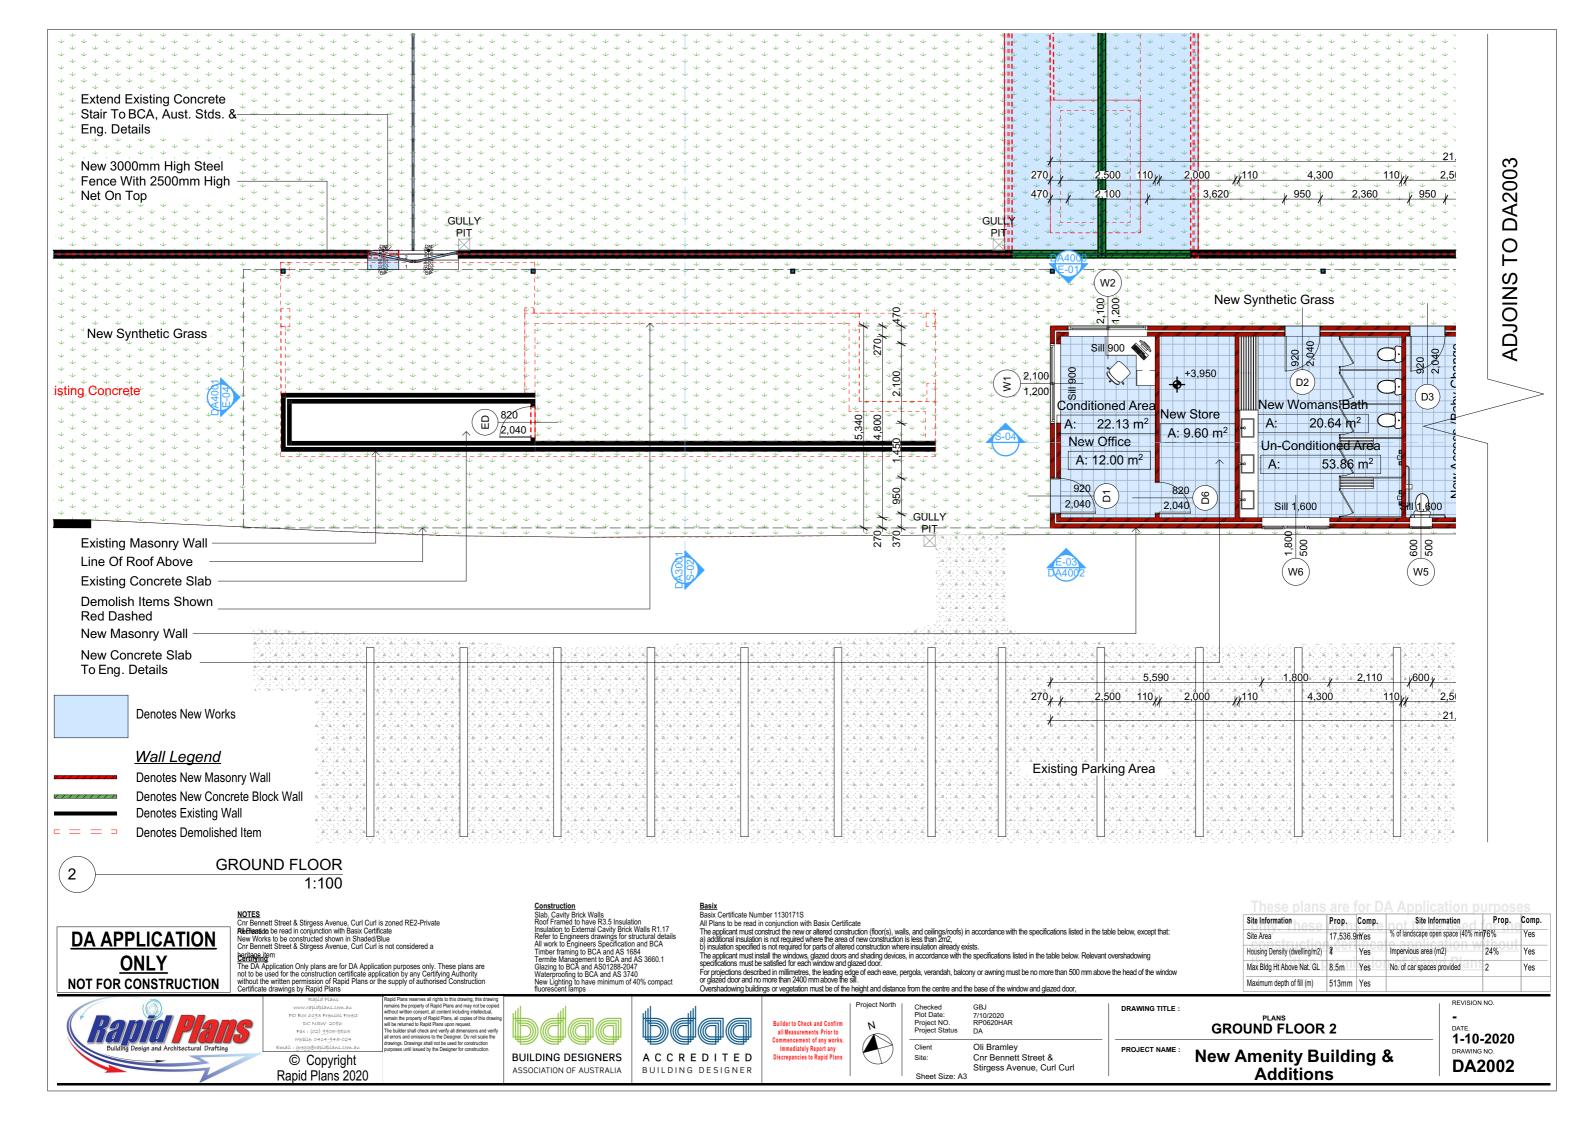

Hot water	
	t install the following hot water system in the development, or a system with a higher energy rating: solar (electric rformance of 15 to 20 STCs or better.
Cooling syste	m
The living areas m	ust not incorporate any cooling system, or any ducting which is designed to accommodate a cooling system.
The bedrooms mu	st not incorporate any cooling system, or any ducting which is designed to accommodate a cooling system.
Heating syste	m
The living areas m	ust not incorporate any heating system, or any ducting which is designed to accommodate a heating system.
The bedrooms mu	st not incorporate any heating system, or any ducting which is designed to accommodate a heating system.
Ventilation	
The applicant mus	t install the following exhaust systems in the development:
At least 1 Bathro	om: no mechanical ventilation (ie. natural); Operation control: n/a
Kitchen: no mec	nanical ventilation (ie. natural); Operation control: n/a
Laundry: natural	ventilation only, or no laundry; Operation control: n/a
Artificial light	ng
	t ensure that the "primary type of artificial lighting" is fluorescent or light emitting diode (LED) lighting in each of the nd where the word "dedicated" appears, the fittings for those lights must only be capable of accepting fluorescent or (LED) lamps:
• at least 1 of th	e bedrooms / study; dedicated
• at least 1 of th	living / dining rooms; dedicated
	oilets: dedicated

ADJOINS TO DA2002

$\begin{array}{c} \begin{array}{c} \begin{array}{c} \begin{array}{c} \begin{array}{c} \end{array} \\ \end{array} \\ \end{array} \\ \end{array} \\ \end{array} \\ \begin{array}{c} \end{array} \\ \end{array} \\ \end{array} \\ \begin{array}{c} \end{array} \\ \end{array} \\ \end{array} \\ \end{array} \\ \begin{array}{c} \end{array} \\ \end{array} \\ \end{array} \\ \end{array} \\ \begin{array}{c} \end{array} \\ \end{array} \\ \end{array} \\ \end{array} \\ \begin{array}{c} \end{array} \\ \end{array} \\ \end{array} \\ \end{array} \\ \begin{array}{c} \end{array} \\ \end{array} \\ \begin{array}{c} \end{array} \\ \end{array} \\ \end{array} \\ \end{array} \\ \begin{array}{c} \end{array} \\ \end{array} \\ \end{array} \\ \end{array} \\ \begin{array}{c} \end{array} \\ \end{array} \\ \end{array} \\ \begin{array}{c} \end{array} \\ \end{array} \\ \end{array} \\ \end{array} \\ \begin{array}{c} \end{array} \\ \end{array} \\ \end{array} \\ \end{array} \\ \begin{array}{c} \end{array} \\ \end{array} \\ \end{array} \\ \end{array} \\ \end{array} \\ \end{array} \\ \begin{array}{c} \end{array} \\ \end{array} $	<pre></pre>	Stair To BCA, Aust. Stds. & Stair To BCA, Aust. St
+ + + + + + + + + + + + + + + + + + +		New Steel Post To Eng. Details
000 000 000 000 000 000 000 000 000 00		New Masonry Wall New Concrete Slab To Eng. Details Wet Areas To Be Waterproofed To BCA & Aust. Stds


Natural lighting	
The applicant must install a window a	and/or skylight in 3 bathroom(s)/toilet(s) in the development for natural lighting.
Other	
The applicant must construct each re definitions.	frigerator space in the development so that it is "well ventilated", as defined in the BASIX
The applicant must install a fixed out	door clothes drying line as part of the development.
The applicant must install a fixed inde	oor or sheltered clothes drying line as part of the development.



Wall Legend

Denotes New Masonry Wall



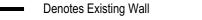

Denotes Demolished Item

		ана ана ана Тобрата	······································			ali da una siada a cita si activa. Note i de la constructiva de la constructiva.	The Bolt Article States and th
10 600	0, 2,510	1 ,800	A . A . A . A . A .	7.180	A. A. A. A. A. A	A. A. A. A. A. A.	
	2,500 110	A A A A A A A A A		5,000	270 /	ά Δ. ά Δ. <u>δ</u> . Δ. Δ.	
110	2,300 110	4,200	D 110	5,000	210//		
Δ. Δ. Δ	21,590						
	à à 4 à 4			4 4 A A A A	a a a a a		The Transformation and the Article and Articles Teaching the Teaching Strength and the Teaching Transformation and the Article and the Arti
	Α.Α.Α.Α.Α.Α.Α.Α.Α.Α.Α.Α.Α.Α.Α.Α.Α.Α.Α.	4 . 4 . 4 . A . A . A	A . A . A . A . A . A . A	Α΄ Α΄ Α΄ Α΄ Α΄ Α΄ Α΄	4 4 A A	Α, Α, Α, Α, Α, Α	
۵. ۵ à ۵.		Δ · · Δ · · Δ · · Δ · · Δ					
A	ά··· ά··· ά·· ά··	ά. δ. ά. ά. ά ά	Δ·Δ·:Δ·.Δ·.Δ·.Δ·.Δ		Δ · Δ · Δ · Δ · Δ · Δ · Δ · Δ	- A - A - A - A - A - A	
۵. ۵. ۵.	Δ.Α.Α.Α.Α.Α.	Δ. Δ. Δ. Δ. Δ. Δ.	Α. Α. Α. Α. Α.	۵. ۵. ۵. ۵. ۵. ۵. ۵. ۵.	A. A. A. A. A. A	ΔΔΔΔΔΔΔ	A A A A A A A A A A A A A A A
<u>م</u> <u>م</u>	5 A A A	۵. ۵. ۵. ۵. ۵. ۵. ۵	δ · Σ · δ · Σ · Δ · Δ · Δ	6 A A A A	A A A A A A	Δ	
ΔΔ	Δ Δ Δ Δ	6	ΔΔΔΔΔΔ	Δ.Δ.Δ.Δ.Δ.Δ.Δ.Δ		Δ	
	, , , , , , , , , , , , , , , , , , ,						Langan ang ang ang ang ang ang ang ang an




Site Information	Prop.	Comp.	Site Information	Prop.	Comp
Site Area	17,536.9	mYes	% of landscape open space (40% mir	176%	Yes
Housing Density (dwelling/m2)	2	Yes	Impervious area (m2)	24%	Yes
Max Bldg Ht Above Nat. GL	8.5m	Yes	No. of car spaces provided	2	Yes
Maximum depth of fill (m)	513mm	Yes		-	-

New Amenity Building & Additions


GROUND FLOOR 3


REVISION NO.


-DATE. 1-10-2020 DRAWING NO. DA2003

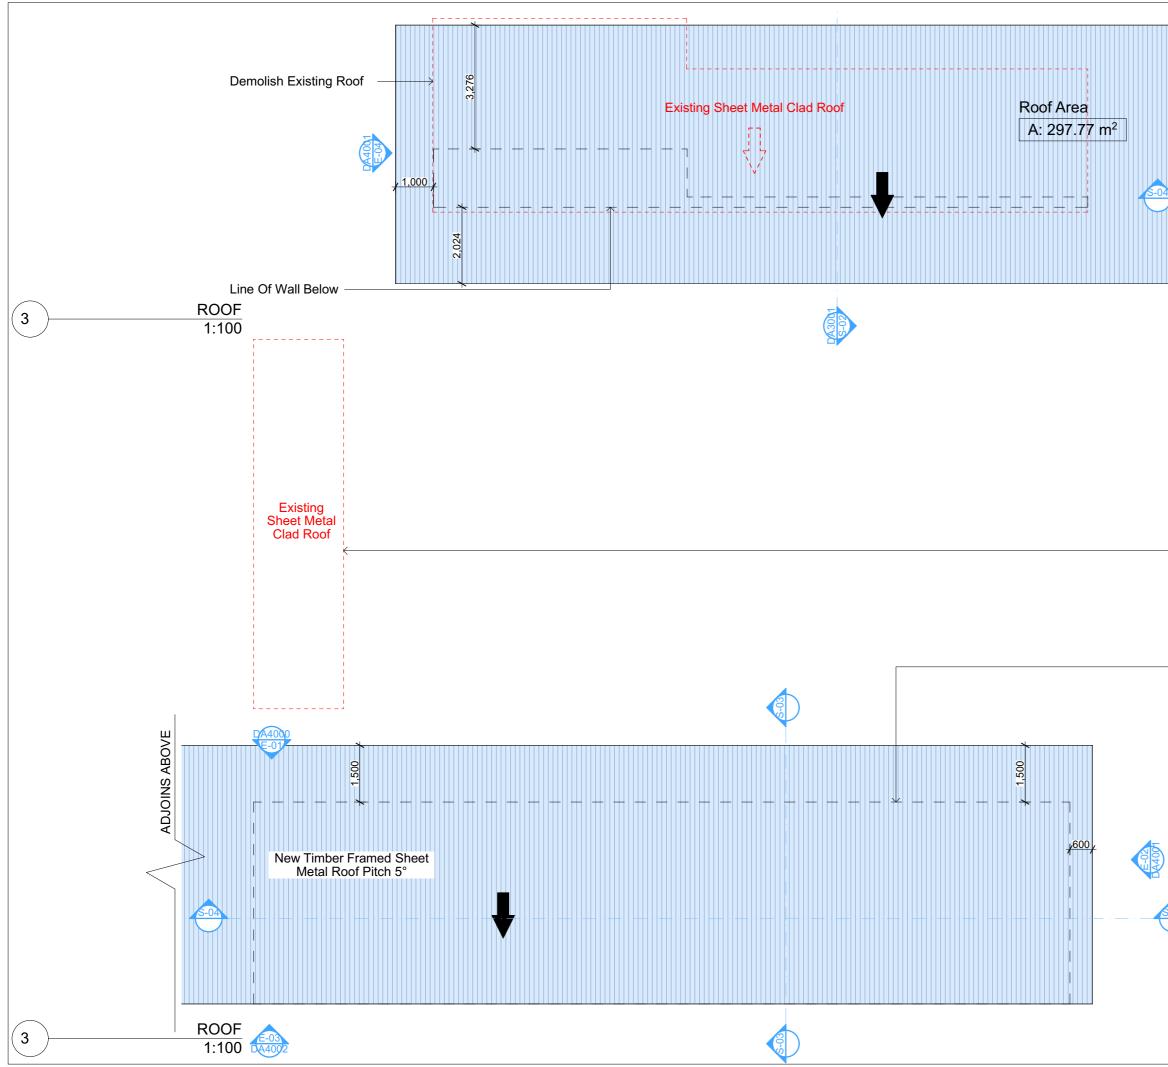


ADJOINS BELOW	Copyright Rapid C	Anala De Nada Construction	in the analysis of the second
	Sinc. Carly Brick Wells Fouriation of Example and Carly Brick Wells Read the Carl And AS 198 (There the sample BR CAR and AS 198 (Wells Dipfing) In base minimum of 40%, New Lighting In base minimum of 40%, All workmanites and the Carl And AS 198 (Second Carl) (Second Carl) (Second Carl) New Lighting In base minimum of 40%, All workmanites and the Carl And AS 198 (Second Carl) (Second Carl) (Second Carl) (Second Carl) (Second Carl) (Second Carl) (Second Carl) (Second Carl) (Second Carl) (S	plication purpose certificate applical sist of Rapid Pla drawings by Rapi Basix Certificatt raitered constri attered constri- attered constri- attered constri- dition is less that arts of altered c lazed doors and ions listed in the ust be satisfied f	s only. These tion by any ns or the d Plans a uction (floor ecifications n 2m2, b) onstruction shading table below. or each
–Demolish Existing Roof			
–Line Of Wall Below	Site Information Site Area Housing Density (dwelling/m2) Max Bldg Ht Above Nat. GL % of landscape open space (40% min) Impervious area (m2)		Comp. Yes Yes Yes Yes Yes
	Maximum depth of fill (m) No. of car spaces provided Builder to Check an Measurements Commencement of Immediately Report an to Rapid Pl Project North	Prior to f any wor y Discrep	ks.
)	N Drawn Checked GBJ Pict Date: 7/10/2020 Project NO. RP0620HAR Project Status DA)	
These plans are for DA Appli	Client Oli Bramley Site: Cnr Bennett Stree Stirgess Avenue,		
only. These plans are not to construction certificate appli the written permission of Ra	DRAWING TITLE : PLANS ROOF P	LAN enity	ons
	REVISION NO. DATE		
DA APPLICATION ONLY NOT FOR CONSTRUCTION		-2020	

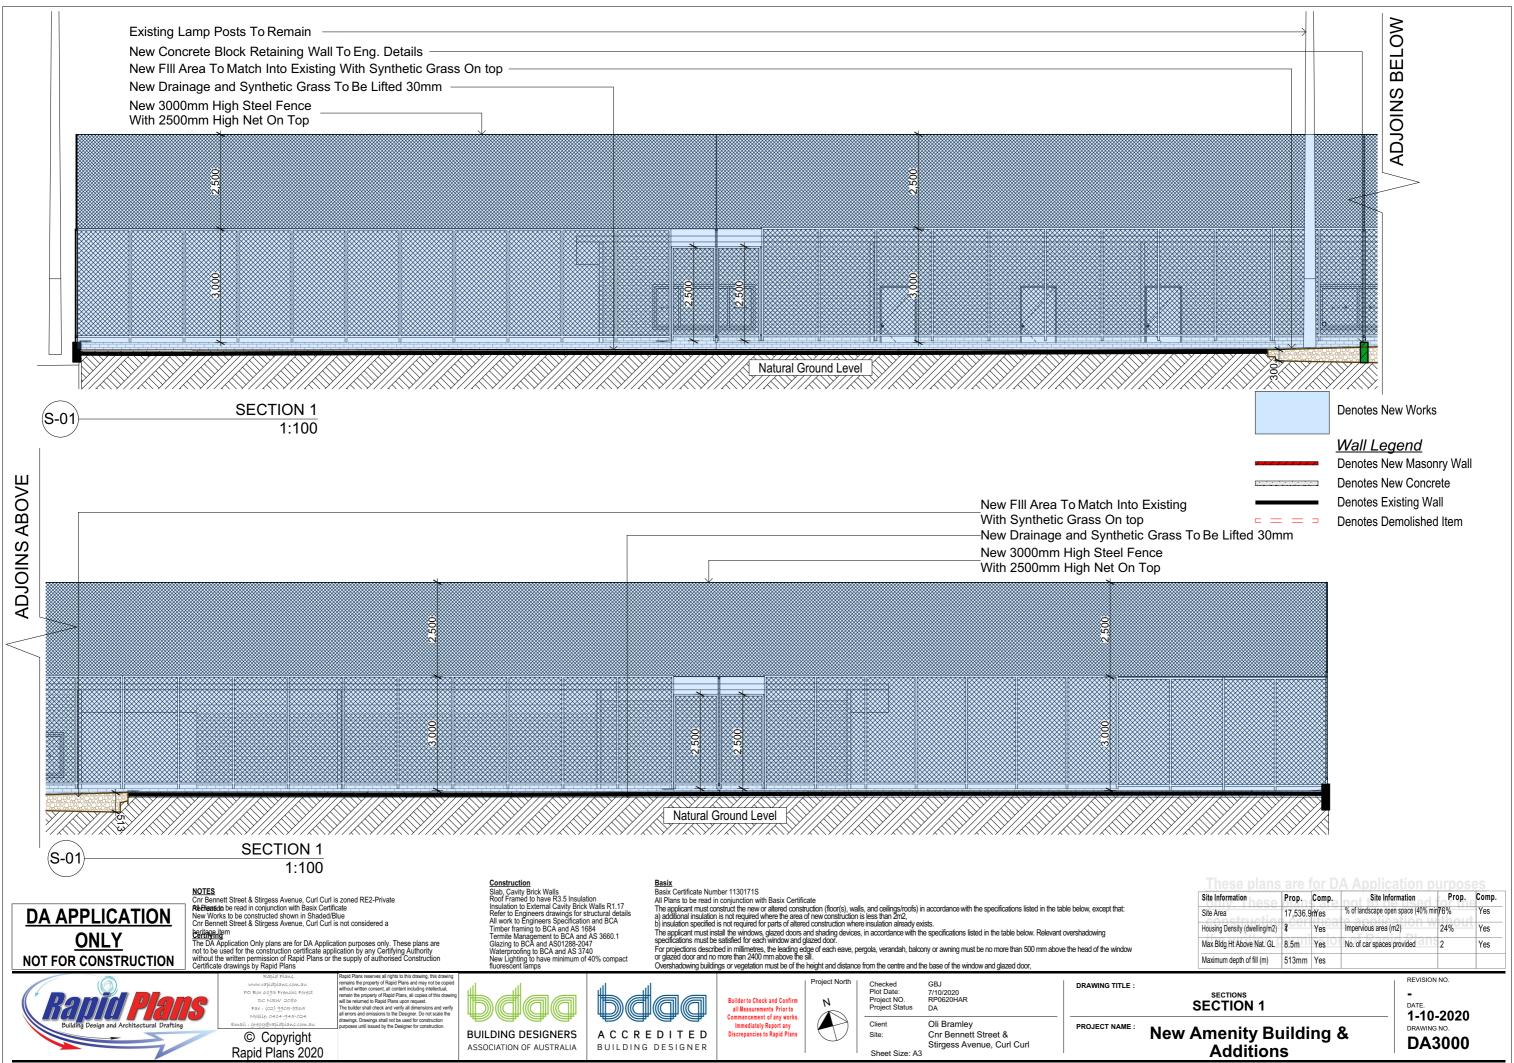


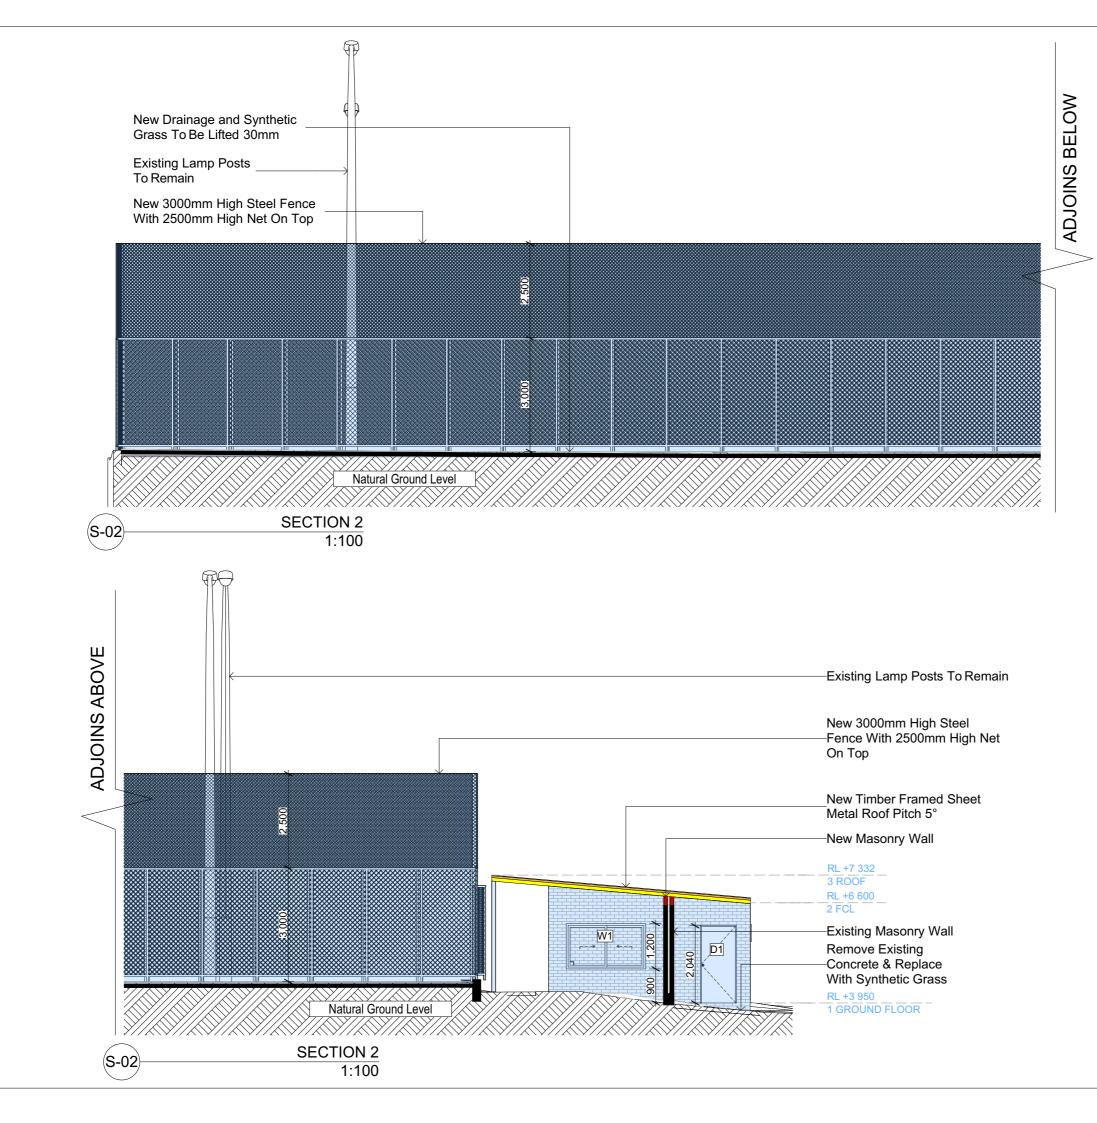


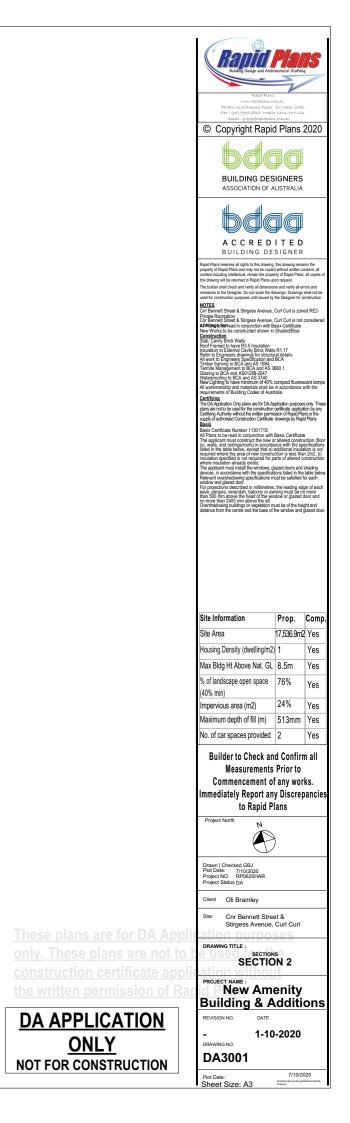

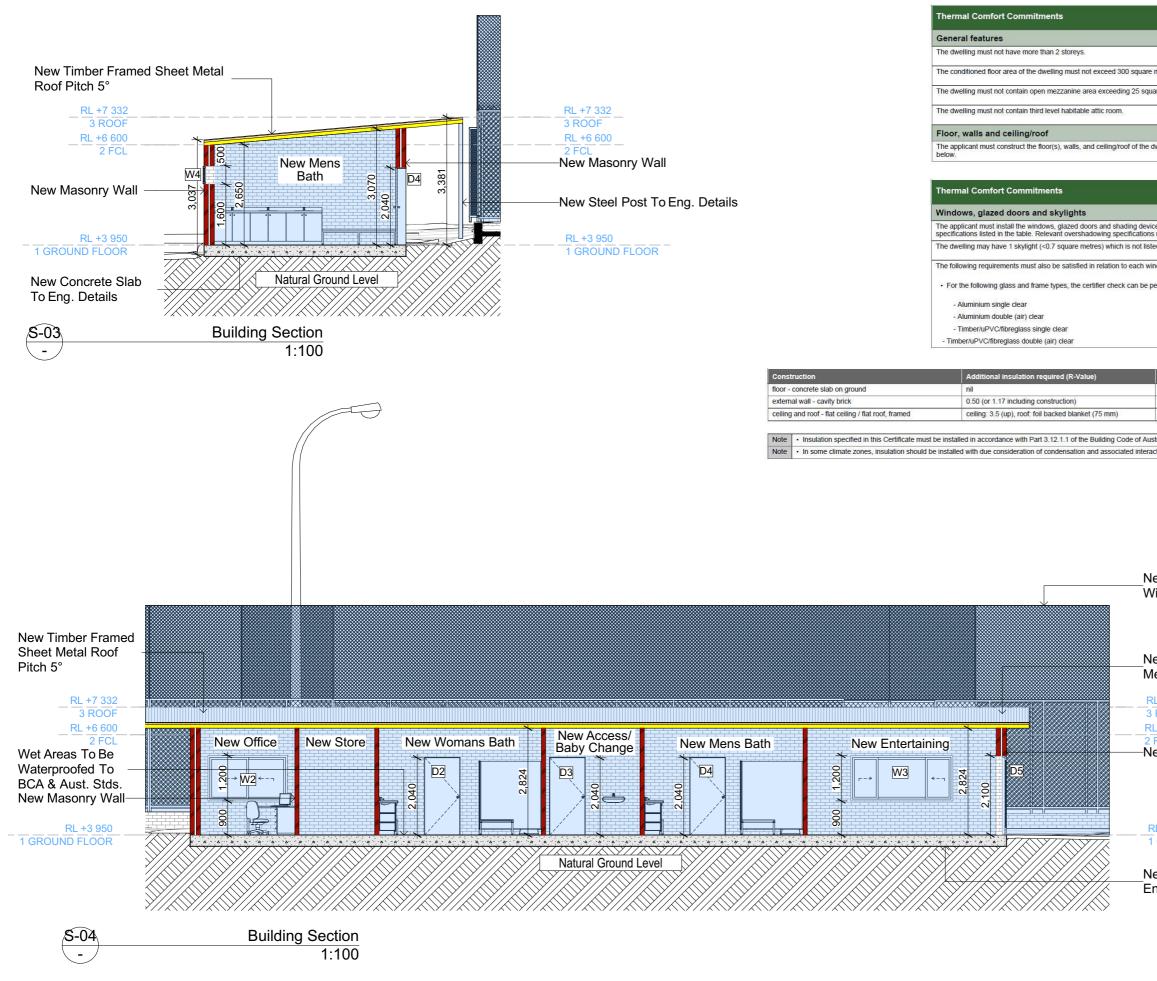

	Rando Building Design and Archit		15
		V	
	Rapid Plans www.rapidplans.co PO Box 6293 Frenchs Forest		
re metres.	Fax : (02) 9905-8865 Mobile Evnail : gregg@vapidplans	0414-945-024	
quare metres.	© Copyright Rapid	l Plans 2	2020
	<i>bd</i>		
	BUILDING DES		
e dwelling in accordance with the specifications listed in the table	ASSOCIATION OF A		
	bđe	10	
	ACCRED BUILDING DE	SIGNER	
vices described in the table below, in accordance with the	Rapid Plans reserves all rights to this drawing, property of Rapid Plans and may not be copied content including intellectual, remain the prope	t without written co rty of Rapid Plans,	onsent, all
ns must be satisfied for each window and glazed door. sted in the table.	this drawing will be returned to Rapid Plans up The builder shall check and verify all dimension	on request. ns and verify all err	rors and
sted in the table.	omissions to the Designer. Do not scale the dra used for construction purposes until issued by	awings, Drawings s	shall not be
window and glazed door:	NOTES Cnr Bennett Street & Stirgess Avenue, (Private Recreation	Curl Curl is zone	ed RE2-
performed by visual inspection.	Private Recreation Cnr Bennett Street & Stirgess Avenue, (AltPtilageoiteeread in conjunction with Ba New Works to be constructed shown in	asix Certificate	
perioritica by field inspection.	Construction Slab, Cavity Brick Walls	Oligoeorpide	
	Insulation to External Cavity Brick Walls Refer to Engineers drawings for structur	R1.17 al details	
	Timber framing to BCA and AS 1684 Termite Management to BCA and AS 38	60.1	
	Waterproofing to BCA and ASU1288-2047 Waterproofing to BCA and AS 3740 New Lighting to have minimum of 40% of	compact fluores	cent lamps
	New Works to be constructed shown in <u>Construction</u> Stab, Carvy birck Wells Stab, Carvy birck Wells Refer to Engineers drawings for skruuber lay work, to Engineers Specification and all work, to Engineers Specification and all work, to Engineers Specification and all work, and the Stab and AS 31740, With Waterpropring to BCA and AS 31740, With Waterpropring to BCA and AS 31740, With Waterpropring to BCA and AS 31740, With all workmarks and materials shall be requirements of Building Codes of Aust Certifying	m accordance v alia.	with the
	Certifying The DA Application Only plans are for DA Ap plans are not to be used for the construction Certifying Authority without the written permis	plication purposes certificate applicat sion of Ranki Plin	s only. These tion by any ns or the
Other specifications	Basix	drawings by Rapi	d Plans
	Basix Certificate Number 1130171S All Plans to be read in conjunction with I	Basix Certificate	e uction (floor
	(s) walls, and ceilings/roofs) in accorda listed in the table below, except that a) a required where the area of new constru- insulation specified is not required for pa- where insulation already exists. The applicant must install the windows, git durings, in accordingought bits properties.	nce with the spe additional insula	ecifications ition is not n 2m2 b)
framed; medium (solar absorptance 0.475-0.70)	insulation specified is not required for pa where insulation already exists. The applicant must install the windows of	arts of altered co	onstruction
	Relevant overshadowing specifications m	ust be satisfied fi	or each
ustralia. raction with adjoining building materials.	Window and glazed door. For projections described in millimetres, eave, pergola, verandah, balcony or aw than 500 mm above the head of the win no more than 2400 mm above the sill. Overshadowing buildings or vegetation m distance from the centre and the base of t	the leading edg	ge of each o more
raction with aujoining building materials.	no more than 2400 mm above the read of the win no more than 2400 mm above the sill. Overshadowing buildings or vegetation m	oow or glazed o ust be of the heig	ght and
New 3000mm High Steel Fence	Site Information	Prop.	Comp.
•		Prop. 17,536.9m2	· ·
New 3000mm High Steel Fence With 2500mm High Net On Top	Site Area	17,536.9m2	Yes
	Site Area Housing Density (dwelling/m2)	17,536.9m2 1	Yes Yes
•	Site Area Housing Density (dwelling/m2) Max Bldg Ht Above Nat. GL	17,536.9m2 1 8.5m	Yes
	Site Area Housing Density (dwelling/m2) Max Bldg Ht Above Nat. GL % of landscape open space	17,536.9m2 1	Yes Yes
	Site Area Housing Density (dwelling/m2) Max Bldg Ht Above Nat. GL % of landscape open space (40% min)	17,536.9m2 1 8.5m	Yes Yes Yes Yes
With 2500mm High Net On Top	Site Area Housing Density (dwelling/m2) Max Bldg Ht Above Nat. GL % of landscape open space	17,536.9m2 1 8.5m 76%	Yes Yes Yes
With 2500mm High Net On Top New Timber Framed Sheet	Site Area Housing Density (dwelling/m2) Max Bldg Ht Above Nat. GL % of landscape open space (40% min) Impervious area (m2) Maximum depth of fill (m)	17,536.9m2 1 8.5m 76% 24% 513mm	Yes Yes Yes Yes Yes Yes
With 2500mm High Net On Top New Timber Framed Sheet	Site Area Housing Density (dwelling/m2) Max Bldg Ht Above Nat. GL % of landscape open space (40% min) Impervious area (m2) Maximum depth of fill (m) No. of car spaces provided	17,536.9m2 1 8.5m 76% 24% 513mm 2	Yes Yes Yes Yes Yes Yes Yes
With 2500mm High Net On Top New Timber Framed Sheet Metal Roof Pitch 5°	Site Area Housing Density (dwelling/m2) Max Bldg Ht Above Nat. GL % of landscape open space (40% min) Impervious area (m2) Maximum depth of fill (m) No. of car spaces provided Builder to Check an	17,536.9m2 1 8.5m 76% 24% 513mm 2 d Confirm	Yes Yes Yes Yes Yes Yes Yes
With 2500mm High Net On Top New Timber Framed Sheet Metal Roof Pitch 5° RL +7 332 3 ROOF RL +6 600	Site Area Housing Density (dwelling/m2) Max Bldg Ht Above Nat. GL % of landscape open space (40% min) Impervious area (m2) Maximum depth of fill (m) No. of car spaces provided Builder to Check an Measurements	17,536.9m2 1 8.5m 76% 24% 513mm 2 d Confirm Prior to	2 Yes Yes Yes Yes Yes Yes Yes n all
With 2500mm High Net On Top New Timber Framed Sheet Metal Roof Pitch 5° RL +7 332 3 ROOF RL +6 600 2 FCL	Site Area Housing Density (dwelling/m2) Max Bldg Ht Above Nat. GL % of landscape open space (40% min) Impervious area (m2) Maximum depth of fill (m) No. of car spaces provided Builder to Check an Measurements Commencement of	17,536.9m2 1 8.5m 76% 24% 513mm 2 d Confirm Prior to any wor	Yes Yes Yes Yes Yes Yes Yes n all ks.
With 2500mm High Net On Top New Timber Framed Sheet Metal Roof Pitch 5° RL +7 332 3 ROOF RL +6 600 2 FCL	Site Area Housing Density (dwelling/m2) Max Bldg Ht Above Nat. GL % of landscape open space (40% min) Impervious area (m2) Maximum depth of fill (m) No. of car spaces provided Builder to Check an Measurements Commencement of Immediately Report an	17,536.9m2 1 8.5m 76% 24% 513mm 2 d Confirm Prior to any wor y Discrep	Yes Yes Yes Yes Yes Yes Yes n all ks.
With 2500mm High Net On Top New Timber Framed Sheet Metal Roof Pitch 5° RL +7 332 3 ROOF RL +6 600 2 FCL	Site Area Housing Density (dwelling/m2) Max Bldg Ht Above Nat. GL % of landscape open space (40% min) Impervious area (m2) Maximum depth of fill (m) No. of car spaces provided Builder to Check an Measurements Commencement of Immediately Report any to Rapid PI Project North	17,536.9m2 1 8.5m 76% 24% 513mm 2 d Confirm Prior to any wor y Discrep	Yes Yes Yes Yes Yes Yes Yes n all ks.
With 2500mm High Net On Top New Timber Framed Sheet Metal Roof Pitch 5° RL +7 332 3 ROOF RL +6 600	Site Area Housing Density (dwelling/m2) Max Bldg Ht Above Nat. GL % of landscape open space (40% min) Impervious area (m2) Maximum depth of fill (m) No. of car spaces provided Builder to Check an Measurements Commencement of Immediately Report any to Rapid Pl	17,536.9m2 1 8.5m 76% 24% 513mm 2 d Confirm Prior to any wor y Discrep	Yes Yes Yes Yes Yes Yes Yes n all ks.
With 2500mm High Net On Top New Timber Framed Sheet Metal Roof Pitch 5° RL +7 332 3 ROOF RL +6 600 2 FCL	Site Area Housing Density (dwelling/m2) Max Bldg Ht Above Nat. GL % of landscape open space (40% min) Impervious area (m2) Maximum depth of fill (m) No. of car spaces provided Builder to Check an Measurements Commencement of Immediately Report any to Rapid PI Project North	17,536.9m2 1 8.5m 76% 24% 513mm 2 d Confirm Prior to any wor y Discrep	Yes Yes Yes Yes Yes Yes Yes n all ks.
With 2500mm High Net On Top New Timber Framed Sheet Metal Roof Pitch 5° RL +7 332 3 ROOF RL +6 600 2 FCL	Site Area Housing Density (dwelling/m2) Max Bldg Ht Above Nat. GL % of landscape open space (40% min) Impervious area (m2) Maximum depth of fill (m) No. of car spaces provided Builder to Check an Measurements Commencement of Immediately Report any to Rapid PI Project North	17,536.9m2 1 8.5m 76% 24% 513mm 2 d Confirm Prior to any wor y Discrep	Yes Yes Yes Yes Yes Yes Yes n all ks.
With 2500mm High Net On Top New Timber Framed Sheet Metal Roof Pitch 5° RL +7 332 3 ROOF RL +6 600 2 FCL New Masonry Wall	Site Area Housing Density (dwelling/m2) Max Bldg Ht Above Nat. GL % of landscape open space (40% min) Impervious area (m2) Maximum depth of fill (m) No. of car spaces provided Builder to Check an Measurements Commencement of Immediately Report an to Rapid Pl Project North Project North Project North	17,536.9m2 1 8.5m 76% 24% 513mm 2 d Confirm Prior to any wor y Discrep	Yes Yes Yes Yes Yes Yes Yes n all ks.
With 2500mm High Net On Top New Timber Framed Sheet Metal Roof Pitch 5° RL +7 332 3 ROOF RL +6 600 2 FCL New Masonry Wall	Site Area Housing Density (dwelling/m2) Max Bldg Ht Above Nat. GL % of landscape open space (40% min) Impervious area (m2) Maximum depth of fill (m) No. of car spaces provided Builder to Check an Measurements Commencement of Immediately Report any to Rapid Pl Project North Project North Project North Project North Project North Project North Project North	17,536.9m2 1 8.5m 76% 24% 513mm 2 d Confirm Prior to any wor y Discrep	Yes Yes Yes Yes Yes Yes Yes n all ks.
With 2500mm High Net On Top New Timber Framed Sheet Metal Roof Pitch 5° RL +7 332 3 ROOF RL +6 600 2 FCL	Site Area Housing Density (dwelling/m2) Max Bldg Ht Above Nat. GL % of landscape open space (40% min) Impervious area (m2) Maximum depth of fill (m) No. of car spaces provided Builder to Check an Measurements Commencement of Immediately Report an to Rapid PI Project North Project North Project North	17,536.9m2 1 8.5m 76% 24% 513mm 2 d Confirm Prior to any wor y Discrep	Yes Yes Yes Yes Yes Yes Yes n all ks.
With 2500mm High Net On Top New Timber Framed Sheet Metal Roof Pitch 5° RL +7 332 3 ROOF RL +6 600 2 FCL New Masonry Wall	Site Area Housing Density (dwelling/m2) Max Bldg Ht Above Nat. GL % of landscape open space (40% min) Impervious area (m2) Maximum depth of fill (m) No. of car spaces provided Builder to Check an Measurements Commencement of Immediately Report an to Rapid PI Project North Project North Project North Project Status DA Client Oli Bramley Site: Cnr Bennett Street	17,536.9m2 17,536.9m2 1 8.5m 76% 24% 513mm 2 d Confirm Prior to any wor y Discrep ans at &	Yes Yes Yes Yes Yes Yes Yes n all ks.
With 2500mm High Net On Top New Timber Framed Sheet Metal Roof Pitch 5° RL +7 332 3 ROOF RL +6 600 2 FCL New Masonry Wall RL +3 950 1 GROUND FLOOR	Site Area Housing Density (dwelling/m2) Max Bidg Ht Above Nat. GL % of landscape open space (40% min) Impervious area (m2) Maximum depth of fill (m) No. of car spaces provided Builder to Check an Measurements Commencement of Immediately Report an to Rapid PI Project North Project Not. Repo202014R Project Not. Rep0202014R Project Not. Rep0202014	17,536.9m2 17,536.9m2 1 8.5m 76% 24% 513mm 2 d Confirm Prior to any wor y Discrep ans at &	Yes Yes Yes Yes Yes Yes Yes n all ks.
With 2500mm High Net On Top New Timber Framed Sheet Metal Roof Pitch 5° RL +7 332 3 ROOF RL +6 600 2 FCL New Masonry Wall RL +3 950 1 GROUND FLOOR New Concrete Slab To Eng. Details are for DA Applie	Site Area Housing Density (dwelling/m2) Max Bldg Ht Above Nat. GL % of landscape open space (40% min) Impervious area (m2) Maximum depth of fill (m) No. of car spaces provided Builder to Check an Measurements Commencement of Immediately Report an to Rapid PI Project North Project North Project North Project Status DA Client Oli Bramley Site: Cnr Bennett Stree Stirgess Avenue, DRAWING TITLE :	17,536.9m2 17,536.9m2 1 8.5m 76% 24% 513mm 2 d Confirm Prior to any wor y Discrep ans et & Curl Curl	Yes Yes Yes Yes Yes Yes Yes n all ks.
With 2500mm High Net On Top New Timber Framed Sheet Metal Roof Pitch 5° RL +7 332 3 ROOF RL +6 600 2 FCL New Masonry Wall RL +3 950 1 GROUND FLOOR	Site Area Housing Density (dwelling/m2) Max Bidg Ht Above Nat. GL % of landscape open space (40% min) Impervious area (m2) Maximum depth of fill (m) No. of car spaces provided Builder to Check an Measurements Commencement of Immediately Report any to Rapid PI Project North Project North Project North Project No. RP662041AR Project Status DA Client Oli Bramley Site: Cnr Bennett Stree Strgess Avenue,	17,536.9m2 1 8.5m 76% 24% 513mm 2 d Confirm Prior to any worly y Discrep ans et & Curl Curl s	Yes Yes Yes Yes Yes Yes Yes n all ks.
With 2500mm High Net On Top New Timber Framed Sheet Metal Roof Pitch 5° RL +7 332 3 ROOF RL +6 600 2 FCL New Masonry Wall RL +3 950 1 GROUND FLOOR New Concrete Slab To Eng. Details are for DA Applie	Site Area Housing Density (dwelling/m2) Max Bldg Ht Above Nat. GL % of landscape open space (40% min) Impervious area (m2) Maximum depth of fill (m) No. of car spaces provided Builder to Check an Measurements Commencement of Immediately Report am to Rapid PI Project North Project North Project North Project North Project Status DA Client Oli Bramley Site: Cnr Bennett Stree Strigess Avenue, DRAWING TITLE :: SECTIO	17,536.9m2 1 8.5m 76% 24% 513mm 2 d Confirm Prior to any worly y Discrep ans et & Curl Curl s	Yes Yes Yes Yes Yes Yes Yes n all ks.
With 2500mm High Net On Top New Timber Framed Sheet Metal Roof Pitch 5° RL +7 332 3 ROOF RL +6 600 2 FCL New Masonry Wall RL +3 950 1 GROUND FLOOR New Concrete Slab To Eng. Details are plans are for DA Applic Only. These plans are not to b construction certificate applic	Site Area Housing Density (dwelling/m2) Max Bidg Ht Above Nat. GL % of landscape open space (40% min) Imperious area (m2) Maximum depth of fill (m) No. of car spaces provided Builder to Check an Measurements Commencement of Immediately Report an to Rapid PI Project North Project North Project North Client Oli Bramley Bate: Cnr Bennett Stree Streps Avenue, DRAWING TITLE : SECTION SECTION PROJECT NAME :	17,536.9m2 1 8.5m 76% 24% 513mm 2 d Confirm Prior to any worly Discrep ans et & Curl Curl N 3	Yes Yes Yes Yes Yes Yes Yes n all ks.
With 2500mm High Net On Top New Timber Framed Sheet Metal Roof Pitch 5° RL +7 332 3 ROOF RL +6 600 2 FCL New Masonry Wall RL +3 950 1 GROUND FLOOR New Concrete Slab To Eng. Details are for DA Applic Only. These plans are not to b	Site Area Housing Density (dwelling/m2) Max Bldg Ht Above Nat. GL % of landscape open space (40% min) Impervious area (m2) Maximum depth of fill (m) No. of car spaces provided Builder to Check an Measurements Commencement of Immediately Report am to Rapid PI Project North Project North Project North Project North Project Status DA Client Oli Bramley Site: Cnr Bennett Stree Strigess Avenue, DRAWING TITLE :: SECTIO	17,536.9m2 17,536.9m2 1 8.5m 76% 24% 513mm 2 d Confirm Prior to any worl y Discrep ans t & Curl Curl Curl Curl S N 3 Entity	Yes Yes Yes Yes Yes Yes n all ks. pancies
With 2500mm High Net On Top New Timber Framed Sheet Metal Roof Pitch 5° RL +7 332 3 ROOF RL +6 600 2 FCL New Masonry Wall RL +3 950 1 GROUND FLOOR New Concrete Slab To Eng. Details are plans are for DA Applic Only. These plans are not to b construction certificate applic the written permission of Rap	Site Area Housing Density (dwelling/m2) Max Bidg Ht Above Nat. GL % of landscape open space (40% min) Impervious area (m2) Maximum depth of fill (m) No. of car spaces provided Builder to Check an Measurements Commencement of Immediately Report an to Rapid PI Project North Project North Project North Client Oli Bramley Site: Cnr Bennett Stree Strgess Avenue, Strges	17,536.9m2 17,536.9m2 1 8.5m 76% 24% 513mm 2 d Confirm Prior to any worl y Discrep ans t & Curl Curl Curl Curl S N 3 Entity	Yes Yes Yes Yes Yes Yes n all ks. pancies
With 2500mm High Net On Top New Timber Framed Sheet Metal Roof Pitch 5° RL +7 332 3 ROOF RL +6 600 2 FCL New Masonry Wall RL +3 950 1 GROUND FLOOR New Concrete Slab To Eng. Details are plans are for DA Applic Only. These plans are not to b construction certificate applic the written permission of Rap	Site Area Housing Density (dwelling/m2) Max Bldg Ht Above Nat. GL % of landscape open space (40% min) Impervious area (m2) Maximum depth of fill (m) No. of car spaces provided Builder to Check an Measurements Commencement of Immediately Report any to Rapid Pl Project North Project North Project North Project North Project North Client Oli Bramley Site: Cnr Bennett Stree Strigess Avenue, BRAWING TITLE : SECTIO PROJECT NAME : New Amo Building & A REVISION NO. DATE	17,536.9m2 17,536.9m2 1 8.5m 76% 24% 513mm 2 d Confirm Prior to any worl y Discrep ans t & Curl Curl Curl Curl S N 3 Entity	Yes Yes Yes Yes Yes Yes n all ks. pancies
With 2500mm High Net On Top New Timber Framed Sheet Metal Roof Pitch 5° RL +7 332 3 ROOF RL +6 600 2 FCL New Masonry Wall RL +3 950 1 GROUND FLOOR New Concrete Slab To Eng. Details are for DA Applic Only. These plans are not to b construction certificate applic the written permission of Rap	Site Area Housing Density (dwelling/m2) Max Bldg Ht Above Nat. GL % of landscape open space (40% min) Impervious area (m2) Maximum depth of fill (m) No. of car spaces provided Builder to Check an Measurements Commencement of Immediately Report any to Rapid PI Project North Project North Project North Project North Project North Client Oli Bramley Site: Cnr Bennett Stree Strigess Avenue, BRAWING TITLE : SECTIO PROJECT NAME : New Amo Building & A REVISION NO. DATE	17,536.9m2 17,536.9m2 1 8.5m 76% 24% 513mm 2 d Confirm 2 d Confirm 2 d Confirm y Discrep ans et & Curl Curl enity cdditio	Yes Yes Yes Yes Yes Yes n all ks. pancies
With 2500mm High Net On Top New Timber Framed Sheet Metal Roof Pitch 5° RL +7 332 3 ROOF RL +6 600 2 FCL New Masonry Wall RL +3 950 1 GROUND FLOOR New Concrete Slab To Eng. Details are for DA Applic only. These plans are not to b construction certificate applic the written permission of Rap DA APPLICATION ONLY	Site Area Housing Density (dwelling/m2) Max Bidg Ht Above Nat. GL % of landscape open space (40% min) Impervious area (m2) Maximum depth of fill (m) No. of car spaces provided Builder to Check an Measurements Commencement of Immediately Report an to Rapid PI Project North Project North Project North Client Oli Bramley Site: Cnr Bennley Site: Strages Avenue, DRAWING TITLE : Section PROJECT NAME : New Amod Building & A Revision No. DATE - 1-10	17,536.9m2 17,536.9m2 1 8.5m 76% 24% 513mm 2 d Confirm 2 d Confirm 2 d Confirm y Discrep ans et & Curl Curl enity cdditio	Yes Yes Yes Yes Yes Yes n all ks. pancies
With 2500mm High Net On Top New Timber Framed Sheet Metal Roof Pitch 5° RL +7 332 3 ROOF RL +6 600 2 FCL New Masonry Wall RL +3 950 1 GROUND FLOOR New Concrete Slab To Eng. Details are plans are for DA Applic Only. These plans are not to b construction certificate applic the written permission of Rap	Site Area Housing Density (dwelling/m2) Max Bidg Ht Above Nat. GL % of landscape open space (40% min) Impervious area (m2) Maximum depth of fill (m) No. of car spaces provided Builder to Check an Measurements Commencement of Immediately Report an to Rapid PI Project North Project North Project North Project Status DA Client Oli Bramley Site: Cnr Bennett Stree Strgess Avenue, DRAWING TITLE :: Section Revision No. Date - 1-10 DRAWING NO.	17,536.9m2 17,536.9m2 1 8.5m 76% 24% 513mm 2 d Confirm 2 d Confirm 2 d Confirm y Discrep ans et & Curl Curl enity cdditio	Yes Yes Yes Yes Yes Yes Yes n all ks. bancies

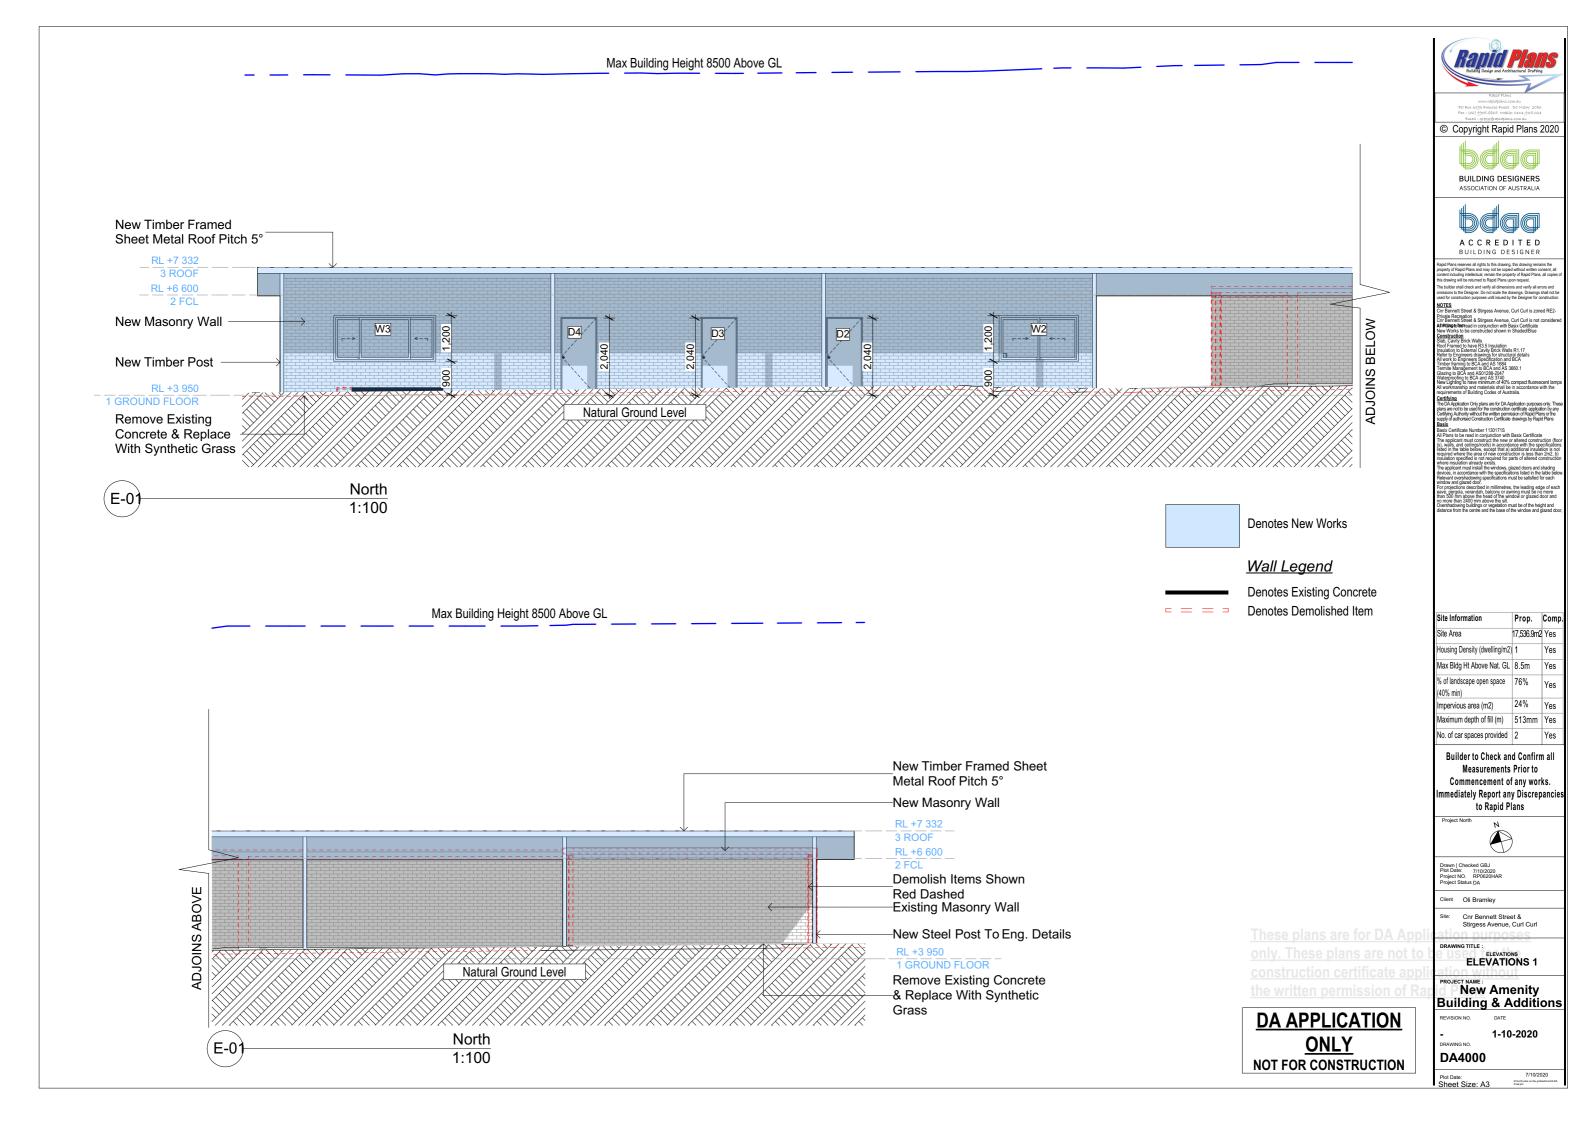

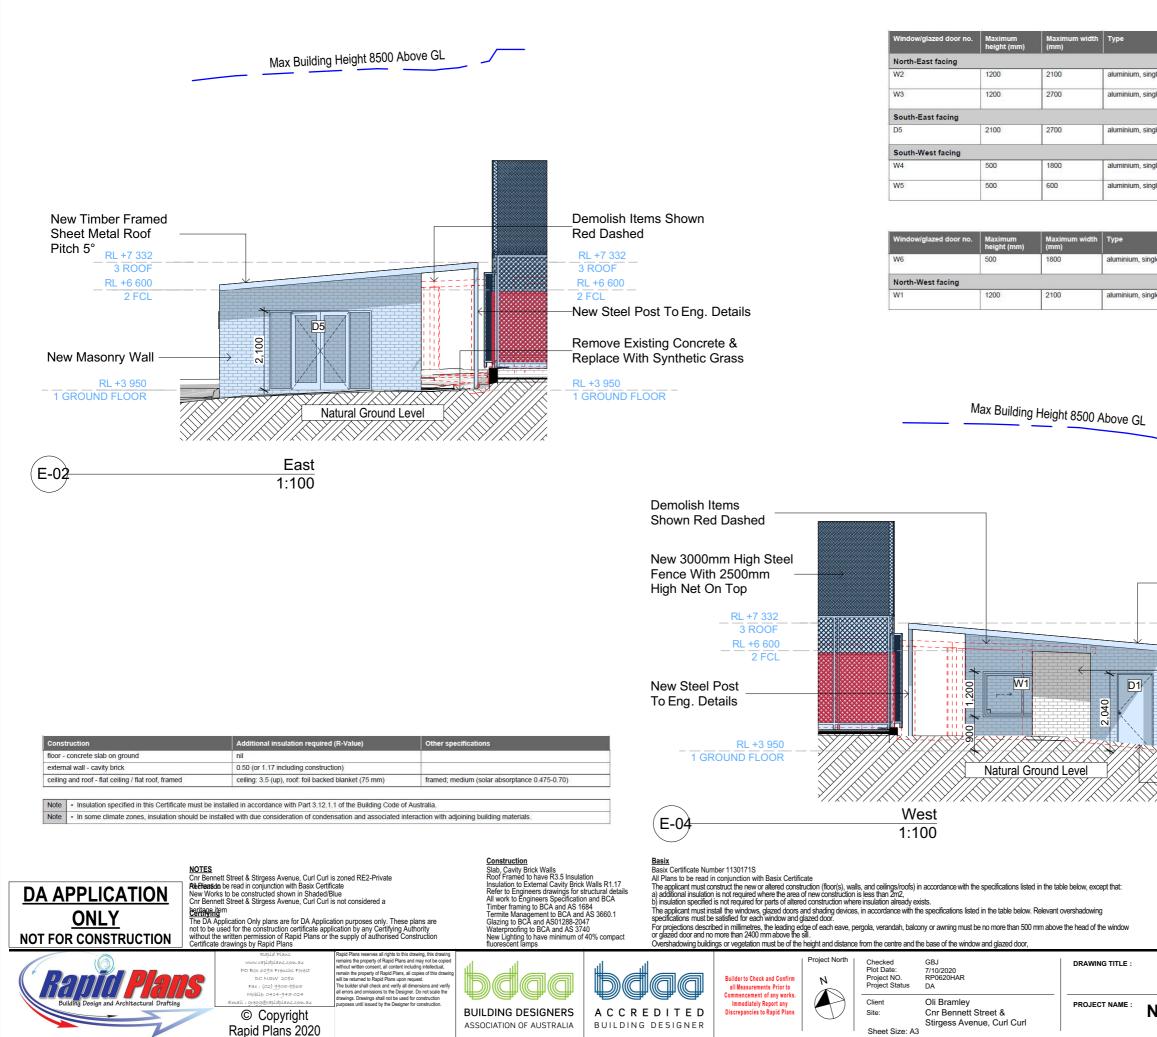

	Shading Device (Dimension within 10%)	Overshadowing	
igle, clear	eave 1500 mm, 1125 mm above head of window or glazed door	not overshadowed	
igle, clear	eave 1500 mm, 1125 mm above head of window or glazed door	not overshadowed	
igle, clear	eave 750 mm, 878 mm above head of window or glazed door	not overshadowed	
gle, clear	eave 150 mm, 550 mm above head of window or glazed door	not overshadowed	

	Shading Device (Dimension within 10%)	Overshadowing
ngle, clear	eave 150 mm, 550 mm above head of window or glazed door	not overshadowed
ngle, clear	eave 3050 mm, 952 mm above head of window or glazed door	not overshadowed

New Timber Framed	
Sheet Metal Roof Pitch	5°

	RL +7 332
	3 ROOF
	RL +6 600
	2 FCL
7	—Existing Masonry Wall
<	—New Masonry Wall
	RL +3 950
77/2017/2017/	1 GROUND FLOOR
	Remove Existing Concrete &
\//<\///	Replace With Synthetic Grass
/// <<< />	

Site Information	Prop.	Comp.	Site Information	Prop.	Comp	
Site Area	17,536.9nYes		% of landscape open space (40% min	76%	Yes	
Housing Density (dwelling/m2)	2	Yes	Impervious area (m2)	24%	Yes	
Max Bldg Ht Above Nat. GL	8.5m	Yes	No. of car spaces provided	2	Yes	
Maximum depth of fill (m)	513mm	Yes				


New Amenity Building & Additions


ELEVATIONS


ELEVATIONS 2


REVISION NO.

-DATE. 1-10-2020 DRAWING NO. DA4001

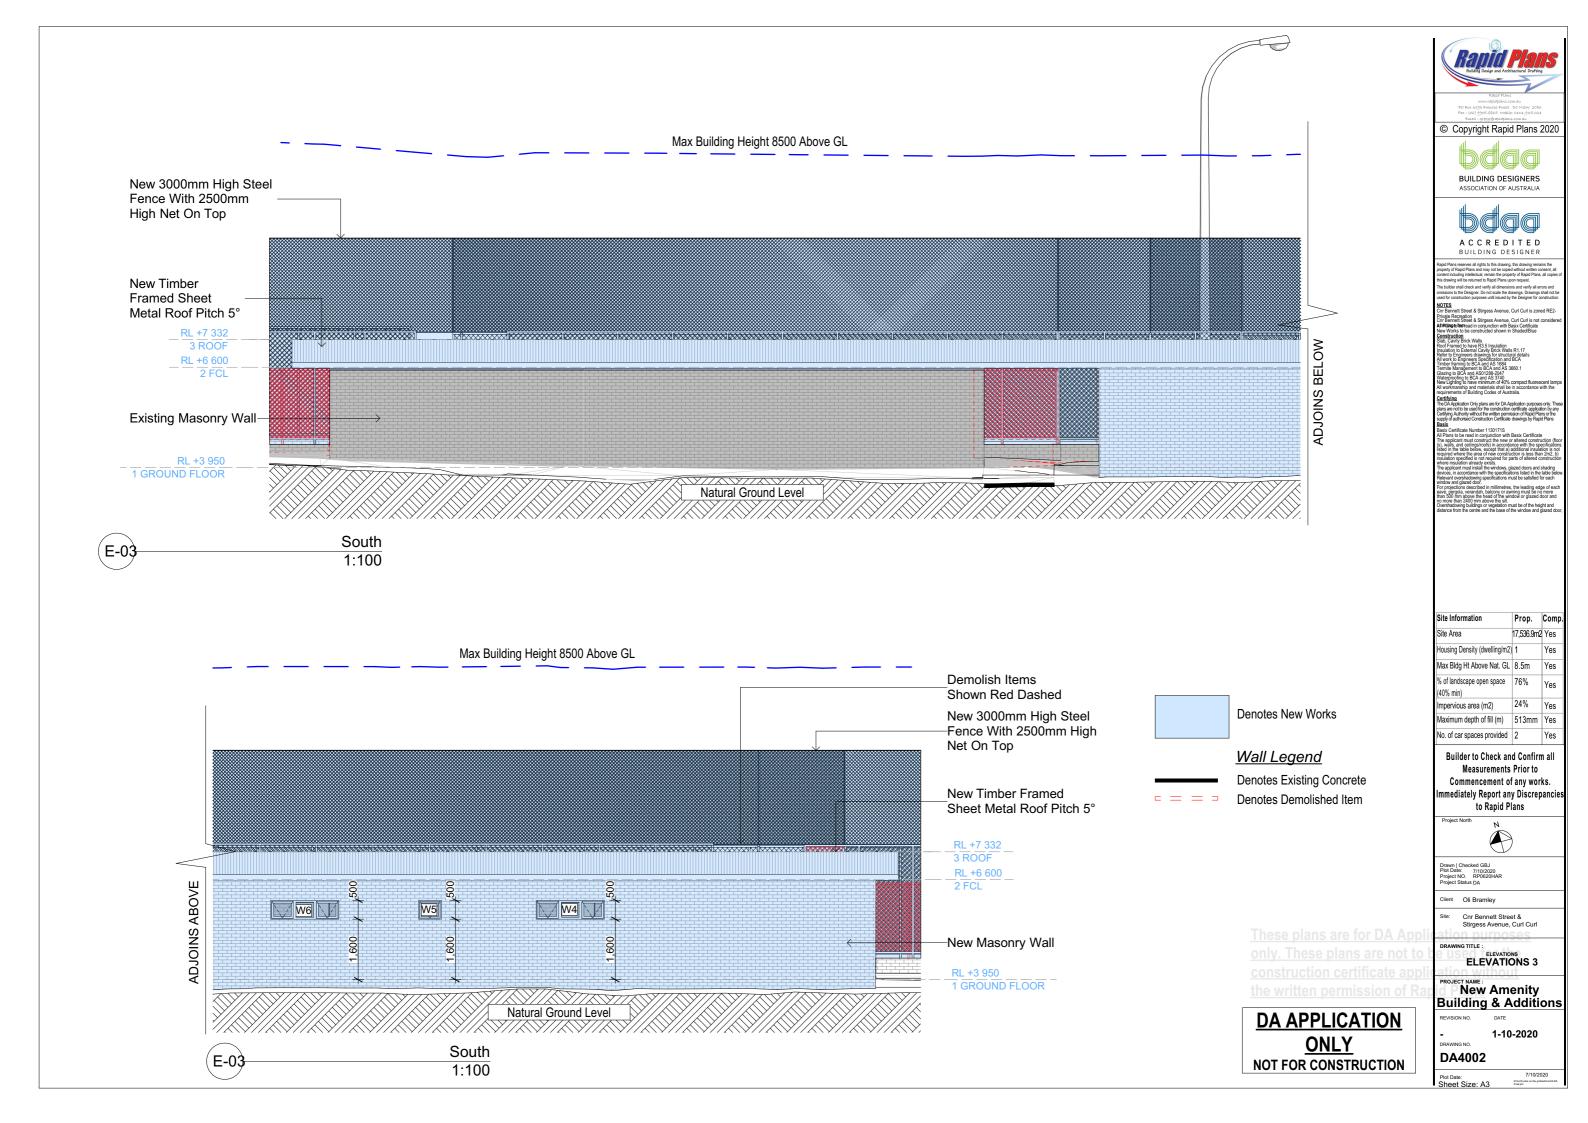

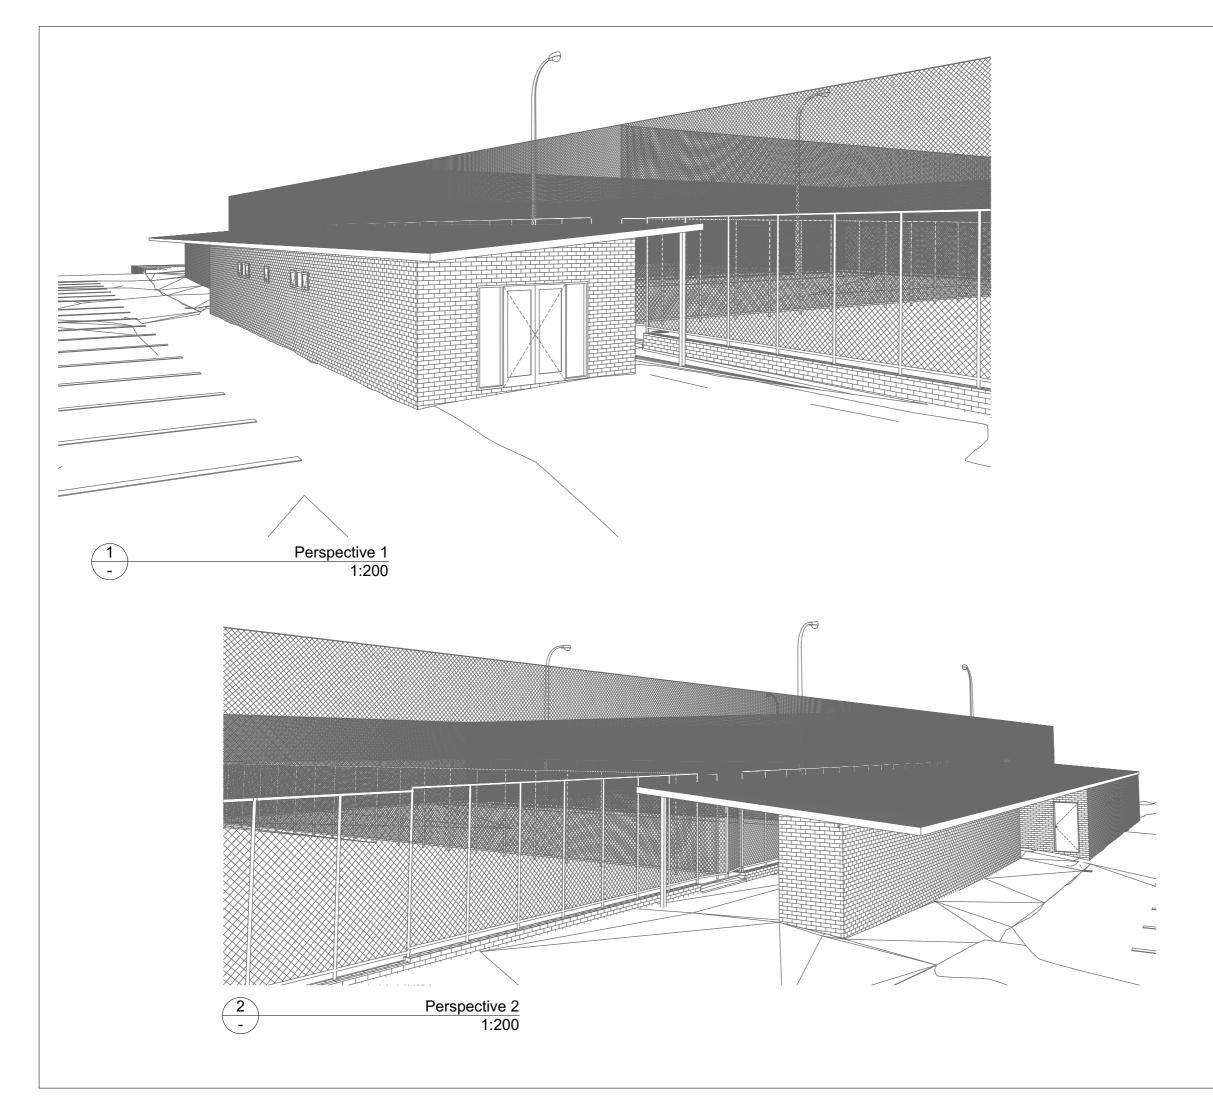

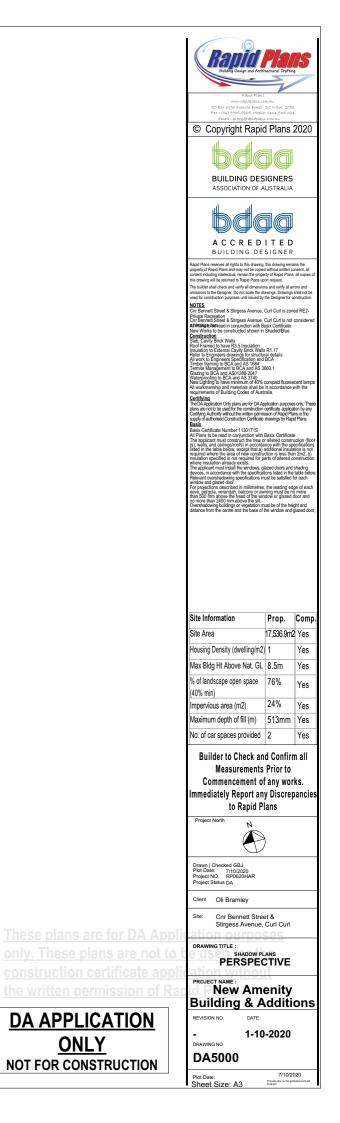

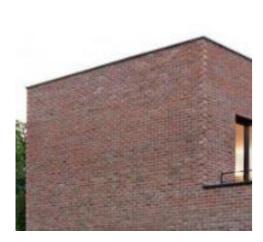

Denotes Masonry Wall (Typical). Owner To Confirm Type & Colour




Denotes Fencing With Net Ontop (Typical). Owner To Confirm Type & Colour



Denotes Sheet Metal Roof (Typical). Owner To Confirm Type & Colour



Denotes Tiling (Typical). Owner To Confirm Type & Colour

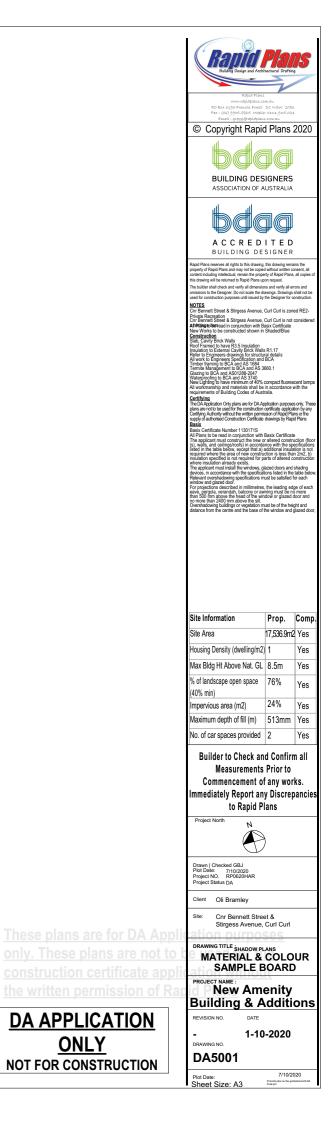

ONLY