

NUMBER OF STOREYS

SIDE BOUNDARY ENVELOPE

SIDE BOUNDARY SETBACKS

REAR BOUNDARY SETBACK

LANDSCAPE OPEN SPACE

PRIVATE OPEN SPACE

FRONT BOUNDARY SETBACK

2

5m

0.9m

6.5m

6.0m

60m²

40% (168.8m²)

ACTION PLANS

73 FULLER STREET, COLLAROY PLATEAU 2097

m: 0426 957 518 e: operations@actionplans.com.au w: www.actionplans.com.au

DEVELOPMENT APPLICATION

SHEET NUMBER	SHEET NAME				DATE PUBLISHED							
DA00	COVER				30/10/2020							
DA01	SITE ANALYSIS				30/10/2020							
DA02	SITE / ROOF / S	EDIMENT EROSION / STORMWATER CO	NCEPT / WASTE MA	NAGEMENT PLAN	30/10/2020							
DA03	EXISTING GRO	UND FLOOR PLAN			30/10/2020							
DA04	EXISTING FIRS	T FLOOR PLAN			30/10/2020							
DA05		OUND FLOOR PLAN			30/10/2020							
DA06		RST FLOOR PLAN			30/10/2020							
DA00		IORTH / EAST ELEVATION										
DA08		SOUTH / WEST ELEVATION										
DA09	LONG / CROSS	SECTION			30/10/2020							
DA10	DRIVEWAY PLA	N / LONG SECTION			30/10/2020							
DA11	AREA CALCULA	TIONS / SAMPLE BOARD			30/10/2020							
DA12	WINTER SOLST	TICE 9 AM			30/10/2020							
DA13	WINTER SOLST	TICE 12 PM			30/10/2020							
DA14	WINTER SOLST	30/10/2020										
DA15	BASIX COMMIT	ASIX COMMITMENTS										
ADDRESS		DEVELOPMENT APPLICATION 73 FULLER STEET COLLAROY PLATE	ALL NSW 2007									
LOT & DP/SP		LOT 9 DP 33000	AU 11311 2031									
COUNCIL		NORTHERN BEACHS COUNCIL (WAR	RINGAH)									
SITE AREA		422m ²										
FRONTAGE		10.67m										
CONTROLS		PERMISSIBLE / REQUIRED	EXISTING	PROPOSED	COMPLIANCE							
		m / m² / %	m / m² / %	m / m² / %								
			Do	Do	YES							
LAND ZONING MINIMUM LOT S	175	R2 – LOW DENSITY RESIDENTIAL 600m ²	R2 422m ²	R2 UNCHANGED	YES							
FLOOR SPACE		NOT IDENTIFEID	422111- N/A	N/A	N/A							
MAXIMUM BUILI	-	8.5m	7.35m	7.5m	YES							
HAZARDS		0.511	7.5511	7.50	123							
ACID SULFATE		NOT IDENTIFEID	N/A	N/A	N/A							
FLOOD PLANNI		NOT IDENTIFEID	N/A	N/A	N/A							
DEVELOPMENT	-											
LAND		AREA - A	N/A	N/A	N/A							
COASTAL HAZA	RDS	NOT IDENTIFEID	N/A	N/A	N/A							
HIGH/MED/LOW PRECINCT	FLOOD RISK	NOT IDENTIFEID	N/A									
NATIVE VEGET	ATION	NOT IDENTIFEID	N/A	N/A	N/A							
WILDLIFRE COF	RIDORS	NOT IDENTIFEID	N/A	N/A	N/A							
WATERWAYS A	ND RIPARIAN	NOT IDENTIFEID	N/A	N/A	N/A							
DCP			6.8m	UNCHANGED								
WALL HEIGHT		7.2m	YES									

2

N/A

N: 2.5m

S: 0.9m

7.96m

6.89m

60m²

107.61m²

YES

NO

YES

NO

YES

NO

YES

UNCHANGED

UNCHANGED

UNCHANGED

UNCHANGED

N/A


0.15m

127.06m²



- EARTHWORKS - PART 3.1.1 OF NCC - EARTH RETAINING STRUCTURES - PART 3.1.2 OF NCC - DRAINAGE - PART 3.1.3 OF NCC - TERMITE-RISK MANAGEMENT - PART 3.1.4 OF NCC - FOOTINGS & SLAB - PART 3.2 OF NCC INCLUDING AS 2870-2011 - MASONRY - PART 3.3 OF NCC INCLUDING AS 3700:2018 - FRAMING - PART 3.4 OF NCC - SUB FLOOR VENTILATION - PART 3.4.1 OF NCC - ROOF CLADDING AND WALL-CLADDING - PART 3.5 OF NCC - GLAZING - PART 3.6 OF NCC INCLUDING AS 1288 - FIRE SAFETY - PART 3.7 OF NCC - FIRE SEPARATION OF EXTERNAL WALLS - PART 3.7.2 OF NCC - FIRE PROTECTION OF SEPARATING WALLS AND FLOORS- PART 3.7.3 OF NCC - SMOKE ALARMS - PART 3.7.5 OF NCC - WET AREAS AND EXTERNAL WATERPROOFING - PART 3.8.1 OF NCC - ROOM HEIGHTS - PART 3.8.2 OF NCC - FACILITIES - PART 3.8.3 OF NCC - LIGHT - PART 3.8.4 OF NCC - VENTILATION - PART 3.8.5 OF NCC - SOUND INSULATION - PART 3.8.6 OF NCC - STAIRWAYAND RAMP CONSTRUCTION - PART 3.9.1 OF NCC - BARRIERS AND HANDRAILS - PART 3.9.2 OF NCC - SWIMMING POOLS - PART 3.10.1 OF NCC - CONSTRUCTION IN BUSHFIRE PRONE AREAS - PART 3.10.5 OF NCC - FENCING & OTHER PROVISIONS - REGS & AS1926.1 2012 - DEMOLITION WORKS - AS2601-2001 THE DEMOLITION OF STRUCTURES. - WATERPROOFING OF WET AREAS TO COMPLY WITH AS 3740-2010 - ALL PLUMBING & DRAINAGE WORK TO COMPLY WITH AS 3500:2018 - ALL PLASTERBOARD WORK TO COMPLY WITH AS 2588:2018 - ALL STRUCTURAL STEEL WORK TO COMPLY WITH AS 4100-1992 & AS 1554 - ALL CONCRETE WORK TO COMPLY WITH AS 3600:2018 - ALL ROOF SHEETING WORK TO COMPLY WITH AS 1562.1-2018 - ALL SKYLIGHTS TO COMPLY WITH AS 4285-2019 - ALL CERAMIC TILING TO COMPLY WITH AS 3958.1-2007 & 3958.2-1992 - ALL GLAZING ASSEMBLIES TO COMPLY WITH AS 2047-2014 & 1288 - ALL TIMBER RETAINING WALLS ARE TO COMPLY WITH AS 1720.1-2010, AS 1720.2-2006. AS 1720.4-2006. AS 1170.1-2002 & AS 1170.4-2007 - ALL RETAINING WALLS ARE TO COMPLY WITH 3700:2018 & AS 3600:2018 - ALL CONSTRUCTION TO COMPLY WITH AS 3959:2018

NCC & AS COMPLIANCES SPECIFICATIONS

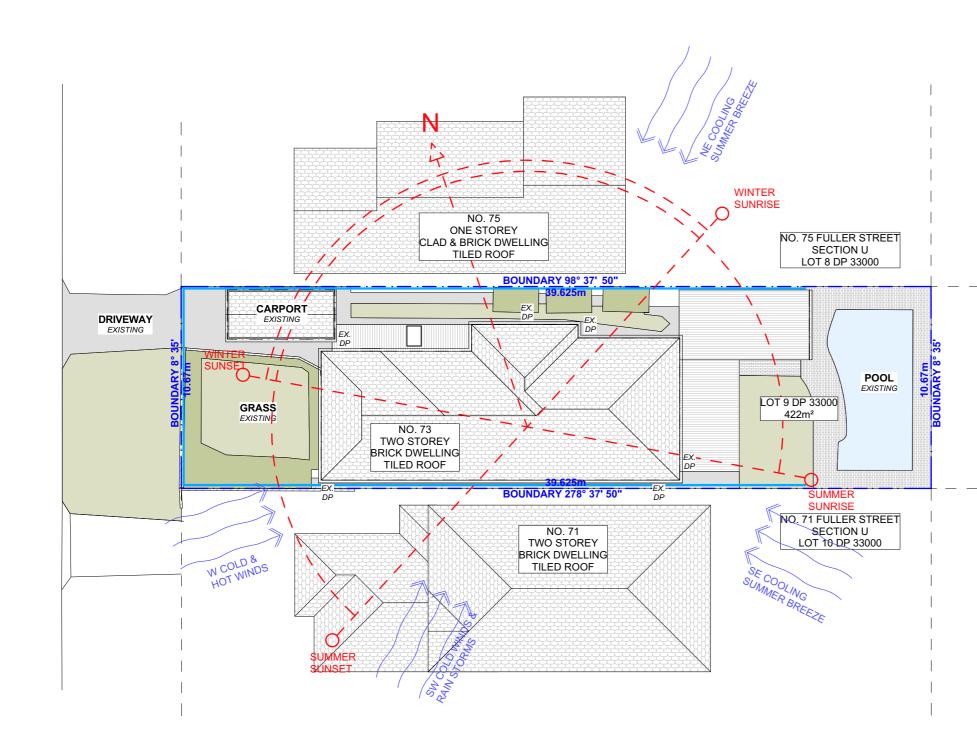



NOTE: ALL DEMOLISHED ELEMENTS TO ENG. SPECIFICATIONS AND AS. 2601 - 2001



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l					dimensions on site prior to commencement of any work, creation of shop drawings, or fabrication of components. All errors and omissions are to be verified by the	
					Builder/Contractor and referred to the designer prior to the commencement of works.	

EGEND

EXISTING PROPOSED - - DEMOLISHED

CLIENT
KAREN & ANTHONY PELLICANO

2097

DA01 PROJECT ADDRESS DATE 73 FULLER STREET, COLLAROY PLATEAU



8 CBA ATM










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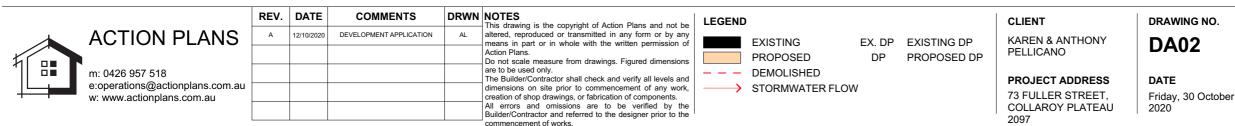
DRAWING NAME SITE ANALYSIS



Friday, 30 October 2020

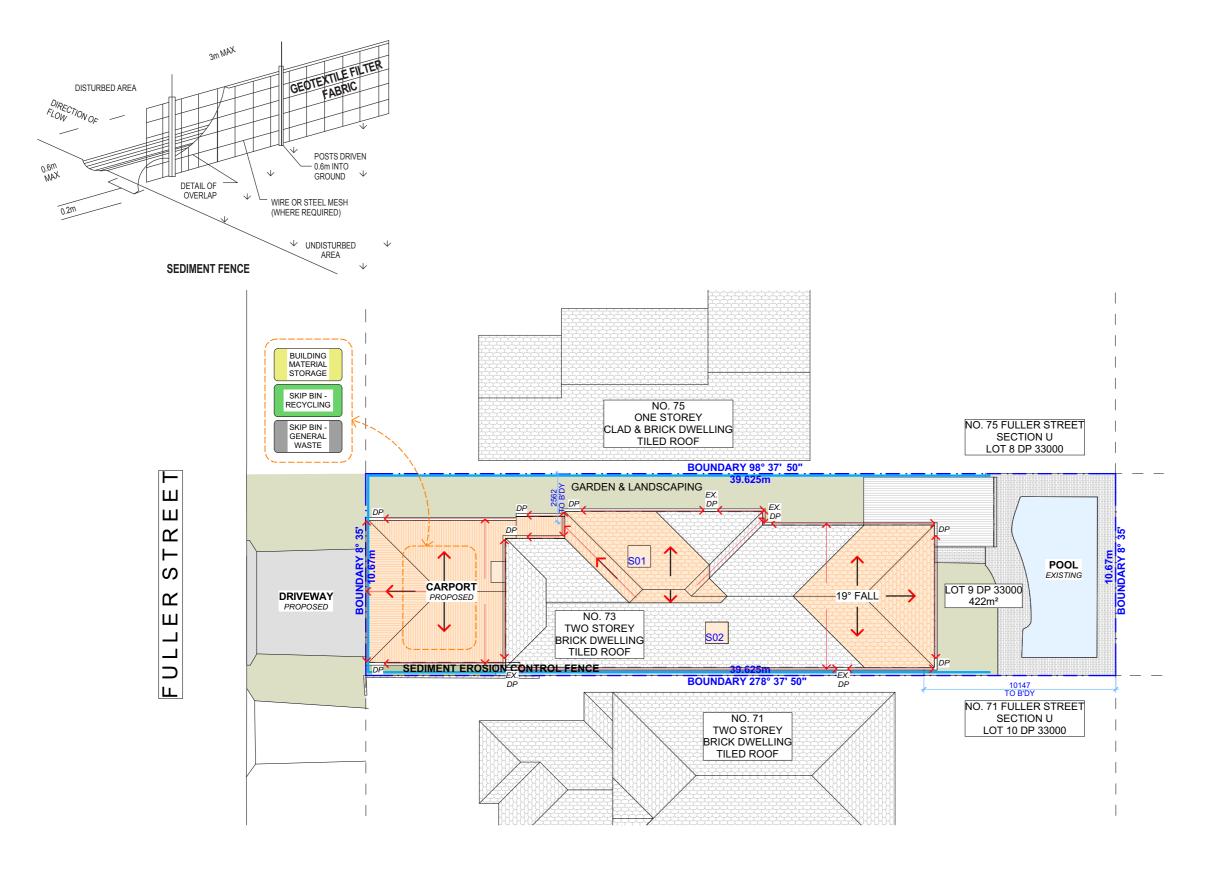

SITE / ROOF / SEDIMENT EROSION / STORMWATER CONCEPT / WASTE MANAGEMENT PLAN 1:200@A3



NOTES REGARDING BOUNDARY

THE INFORMATION SHOWN ON THIS PLAN IS FOR DESIGN PURPOSES ONLY. THE POSITION OF BOUNDARY LINES HAVE BEEN ESTABLISHED BY A SURVEY TO MEET THE IDENTIFICATION REQUIREMENTS FOR COUNCIL AND NOT FOR REGISTRATION WITH THE LAND REGISTRATION SERVICES NSW NOR MAY THIS PLAN BE USED FOR ANY OTHER PURPOSE. SUBSEQUENT REGISTERED OR OTHER SURVEYS MAY AFFECT THE DEFINED BOUNDARY POSITIONS IN THIS AREA. ANY DIFFERENCES OF THIS NATURE ARE BEYOND THE PURPOSES OF THIS PLAN. THIS PLAN IS FOR THE ABOVE STATED PURPOSES ONLY. RESTRICTIONS ON THE TITLE HAVE NOT BEEN INVESTIGATED. IF FURTHER DEVELOPMENT IS CONTEMPLATED OR CONSTRUCTION INTENDED THEN IT IS IMPORTANT THAT A SURVEY SET OUT IS CARRIED OUT.

DUST CONTROL :

TO REDUCE DUST GENERATED BY WIND ACTION, THE REMOVAL OF THE TOP SOIL IS TO BE MINIMISED. TO PREVENT DUST GENERATION, WATERING DOWN OF THE SITE, ESPECIALLY DURING THE MOVEMENT OF MACHINERY IS REQUIRED. WHERE EXCAVATING INTO ROCK, KEEP THE SURFACE MOIST TO MINIMISE DUST. CONSTRUCT A GRAVEL ENTRY/EXIT POINT USING BLUE METAL AND RESTRICT ALL VEHICLE MOVEMENTS WITHIN THE SITE TO A MINIMUM. ENSURE WIND BREAKS, SUCH AS EXISTING FENCES ARE MAINTAINED DURING THE CONSTRUCTION PHASE UNTIL NEW LANDSCAPING IS PROVIDED OR REINSTATED. PREVENT DUST BY COVERING STOCKPILES

SEDIMENT NOTE :

1. ALL EROSION AND SEDIMENT CONTROL MEASURES TO BE INSPECTED AND MAINTAINED DAILY BY THE SITE MANAGER.

2. MINIMISE DISTURBED AREAS, REMOVE EXCESS SOIL FROM EXCAVATEDAREA AS SOON AS POSSIBLE. 3. ALL MATERIAL STOCKPILE TO BE CLEAR FROM DRAINS, GUTTERS AND FOOTPATHS, OR WITHIN SEDIMENT FENCE AREA.

4. DRAINAGE TO BE CONNECTED TO STORMWATER AS SOON AS POSSIBLE. IF STORED ON SITE, IT MUST BE FILTERED BEFORE RELEASING INTO STORMWATER SYSTEM OR WATERWAYS

5. ROADS AND FOOTPATHS TO BE SWEPT DAILY.

STOCKPILES :

ALL STOCKPILES ARE TO BE KEPT ON-SITE WHERE POSSIBLE. ANY MATERIALS PLACED ON THE FOOTPATHS OR NATURE STRIPS REQUIRE COUNCIL'S PERMISSION

ALL STOCKPILES ARE TO BE PLACED AWAY FROM THE DRAINAGE LINES AND STREET GUTTERS. IT IS BEST TO LOCATE THESE ON THE HIGHEST PART OF THE SITE IF POSSIBLE. PLACE WATERPROOF COVERING OVER STOCKPILES

IF REQUIRED PROVIDE DIVERSION DRAIN & BANK AROUND STOCKPILES.

GUTTER PROTECTION : PROVIDE PROTECTION TO DOWNHILL GRATE IN GUTTER BY MEANS OF SAND BAGS OR BLUE METAL WRAPPED IN GEOTEXTILE FABRIC. WHEN SOIL OR SAND BUILDS UP AROUND THIS SEDIMENT BARRIER, THE MATERIAL SHOULD BE RELOCATED BACK TO THE SITE FOR DISPOSAL.


NOTE: ALL PROPOSED STORMWATER TO CONNECT WITH EXISTING

DRAWING NAME

SITE / ROOF / SEDIMENT EROSION / STORMWATER CONCEPT / WASTE MANAGEMENT PLAN SCALE



1:1, 1:200 @A3

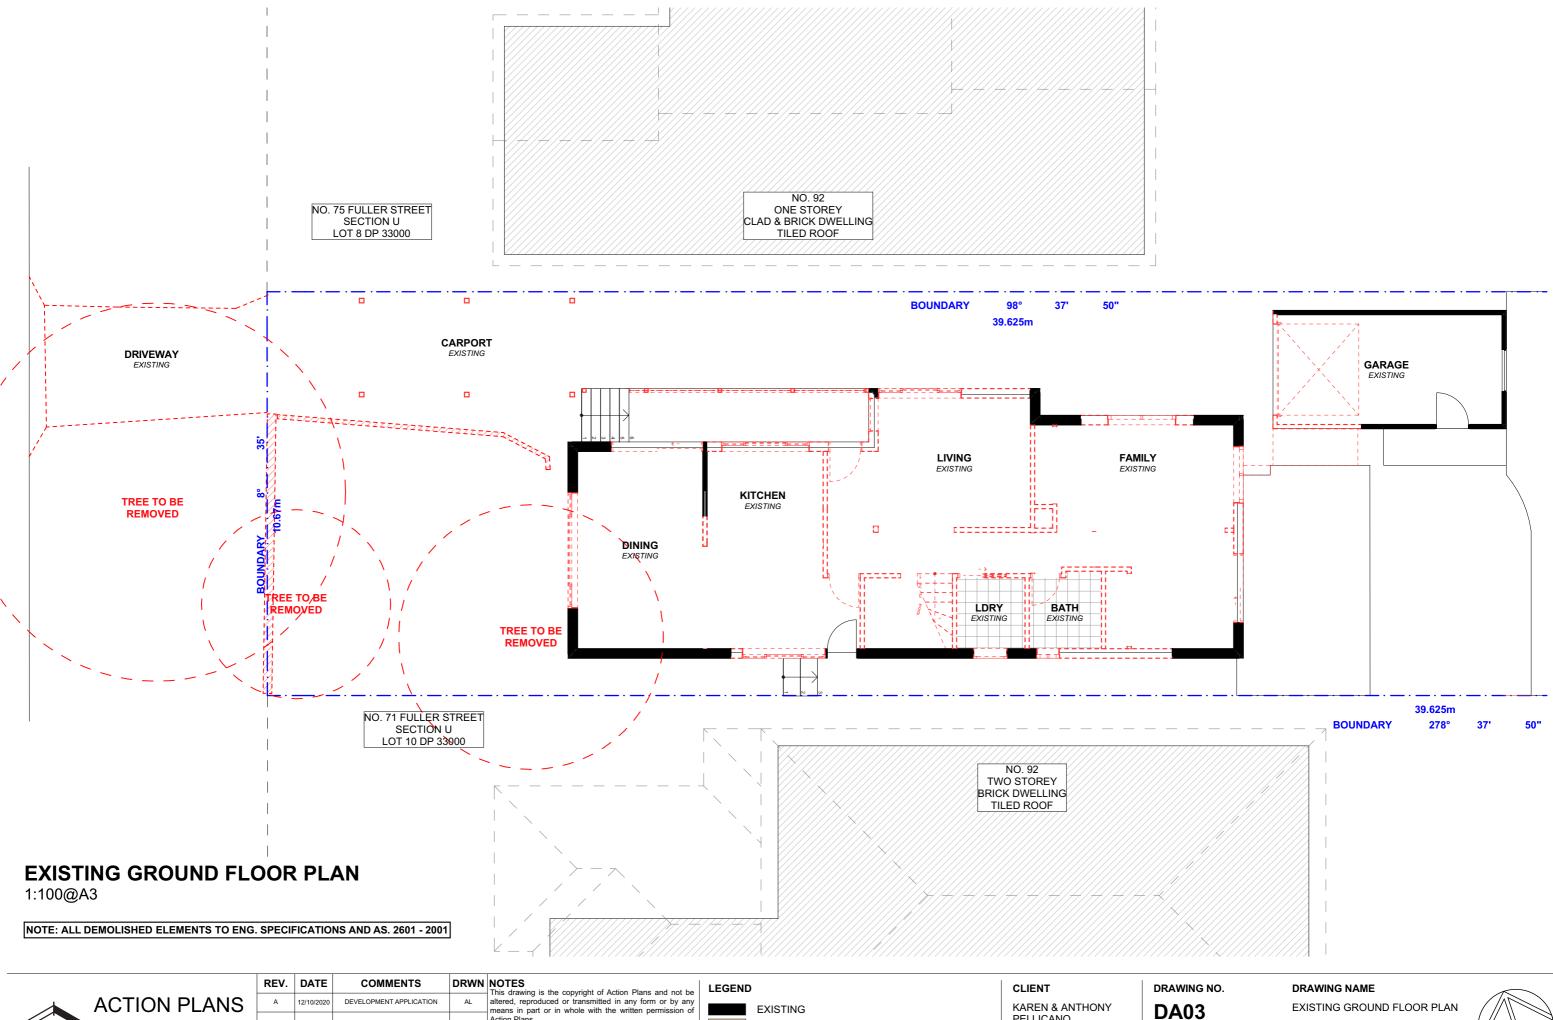


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57 518 ns@actionplans.com.au tionplans.com.au					Do not scale measure from drawings. Figured dimensions are to be used only. The Builder/Contractor shall check and verify all levels and dimensions on site prior to commencement of any work, creation of shop drawings, or fabrication of components.		PROPOSED DEMOLISHED	PROJECT ADDRESS 73 FULLER STREET,	DATE Friday, 3
					All errors and omissions are to be verified by the Builder/Contractor and referred to the designer prior to the commencement of works.			COLLAROY PLATEAU 2097	2020


EXISTING GROUND FLOOR PLAN



y, 30 October

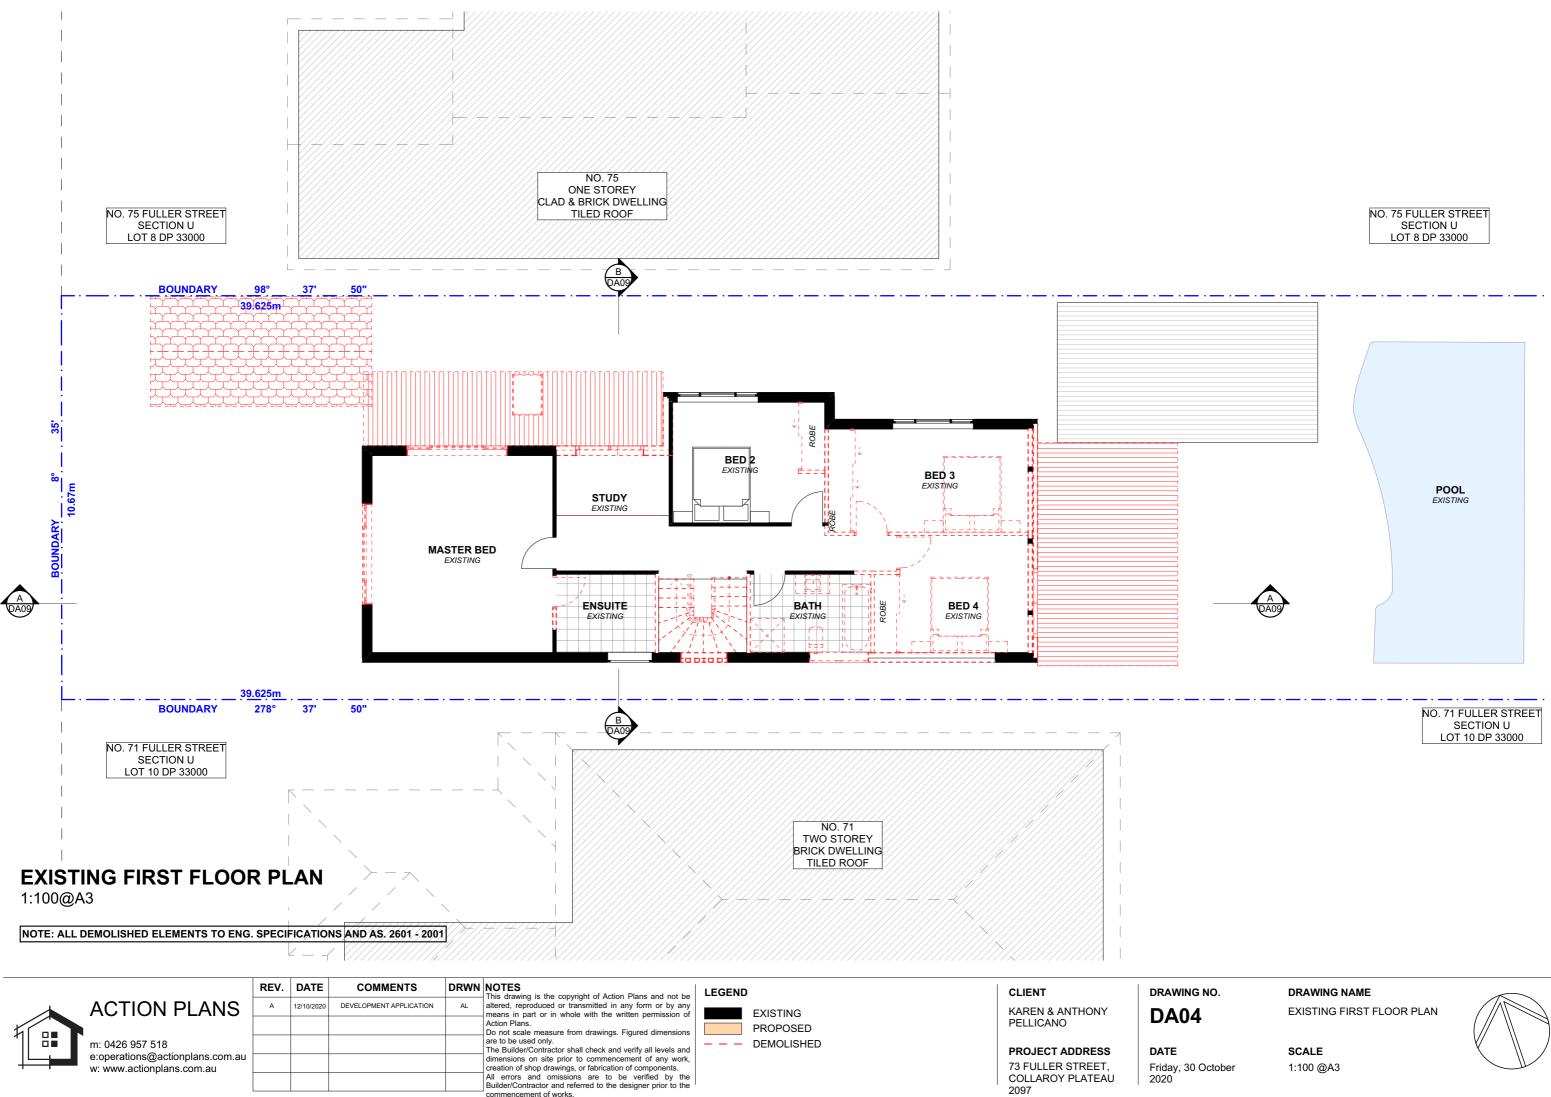

commencement of works.

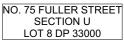


2020

COLLAROY PLATEAU

2097

1:100 @A3

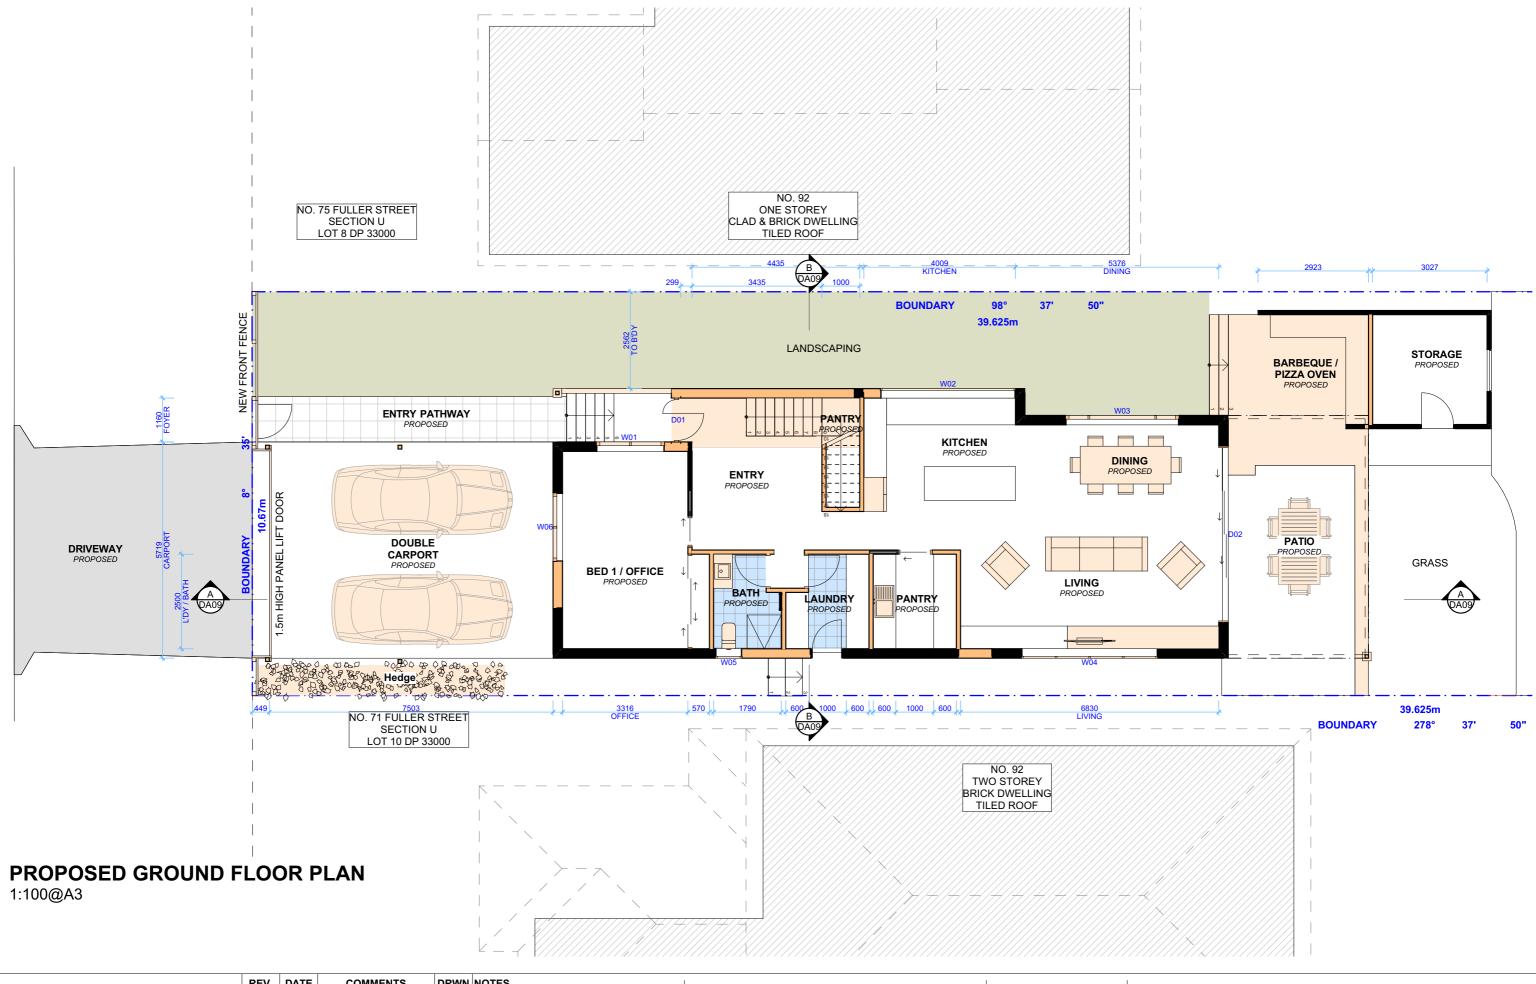

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					All errors and omissions are to be verified by the Builder/Contractor and referred to the designer prior to the commencement of works.			COLLAROY PLATEAU 2097	2020


IG NO.

DRAWING NAME

PROPOSED GROUND FLOOR PLAN



30 October

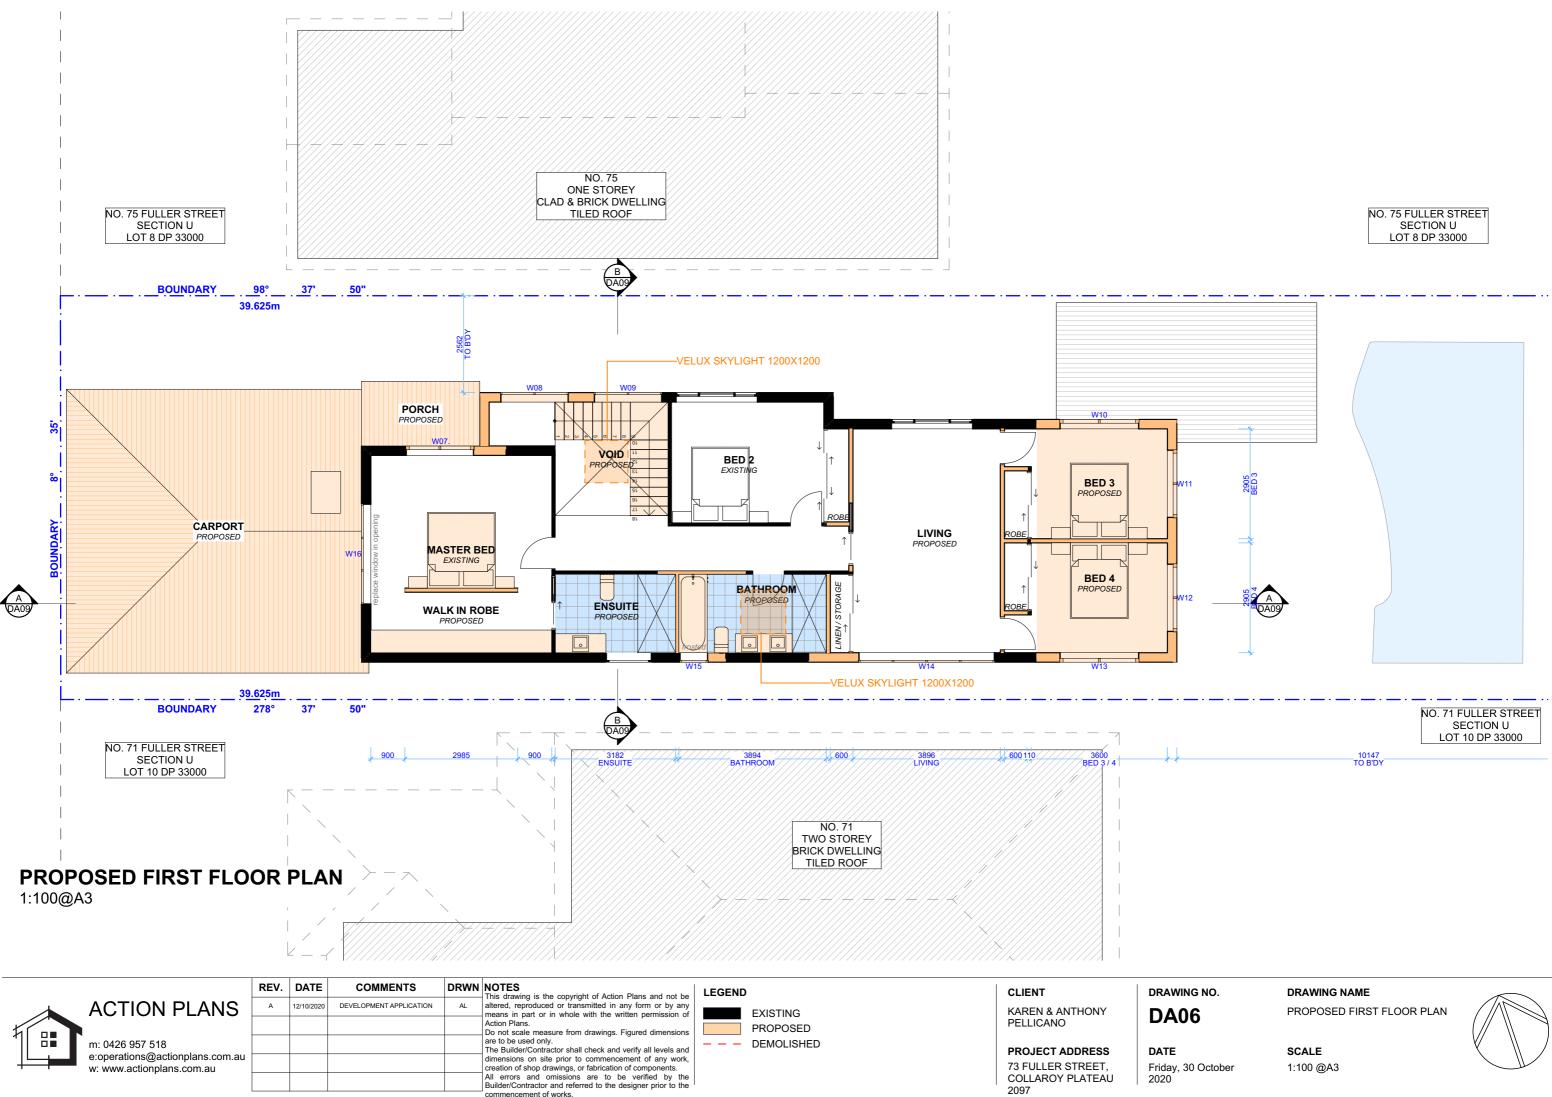


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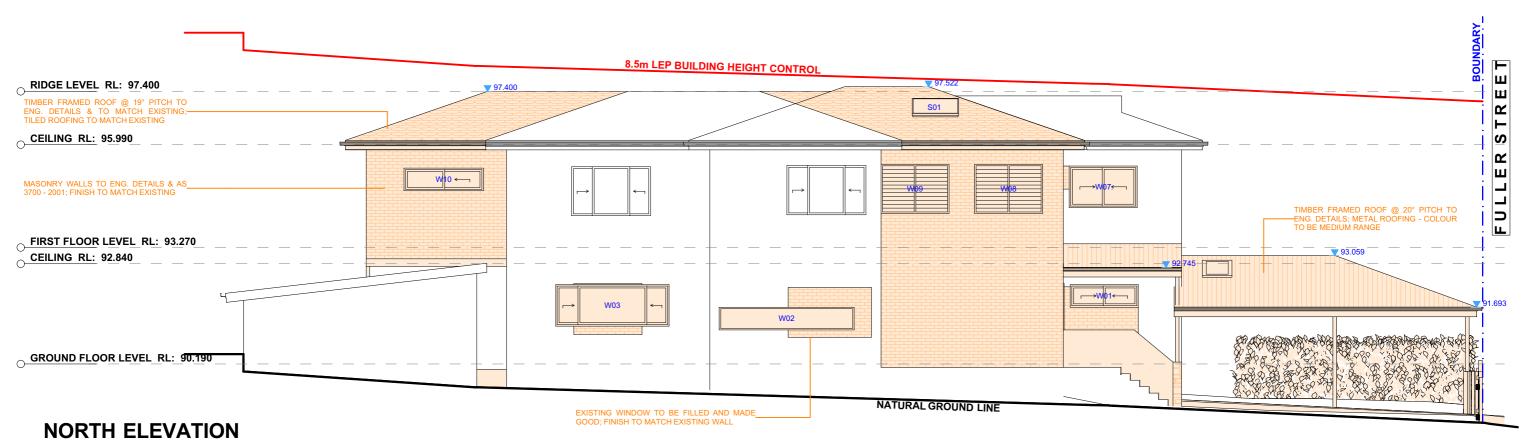
PROJECT ADDRESS 73 FULLER STREET, COLLAROY PLATEAU 2097

2020




Friday, 30 October

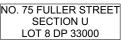1:100 @A3




1:100@A3

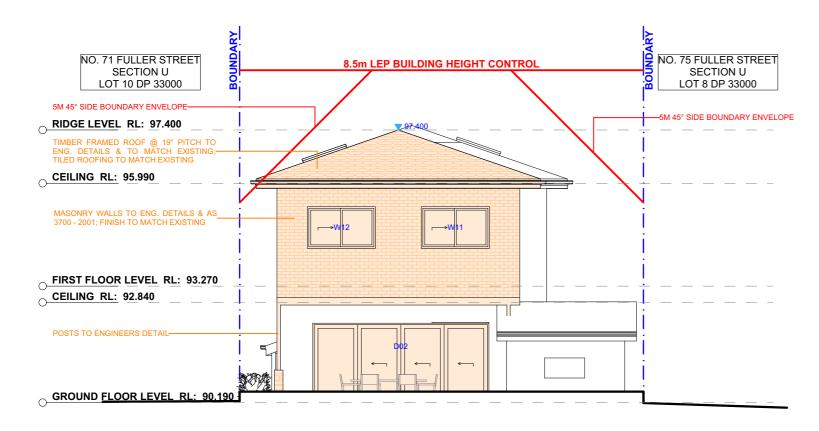

EAST ELEVATION


1:100@A3

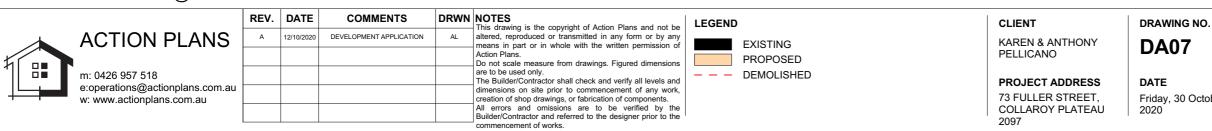

DRAWING NAME NORTH / EAST ELEVATION

SCALE 1:100 @A3

Friday, 30 October

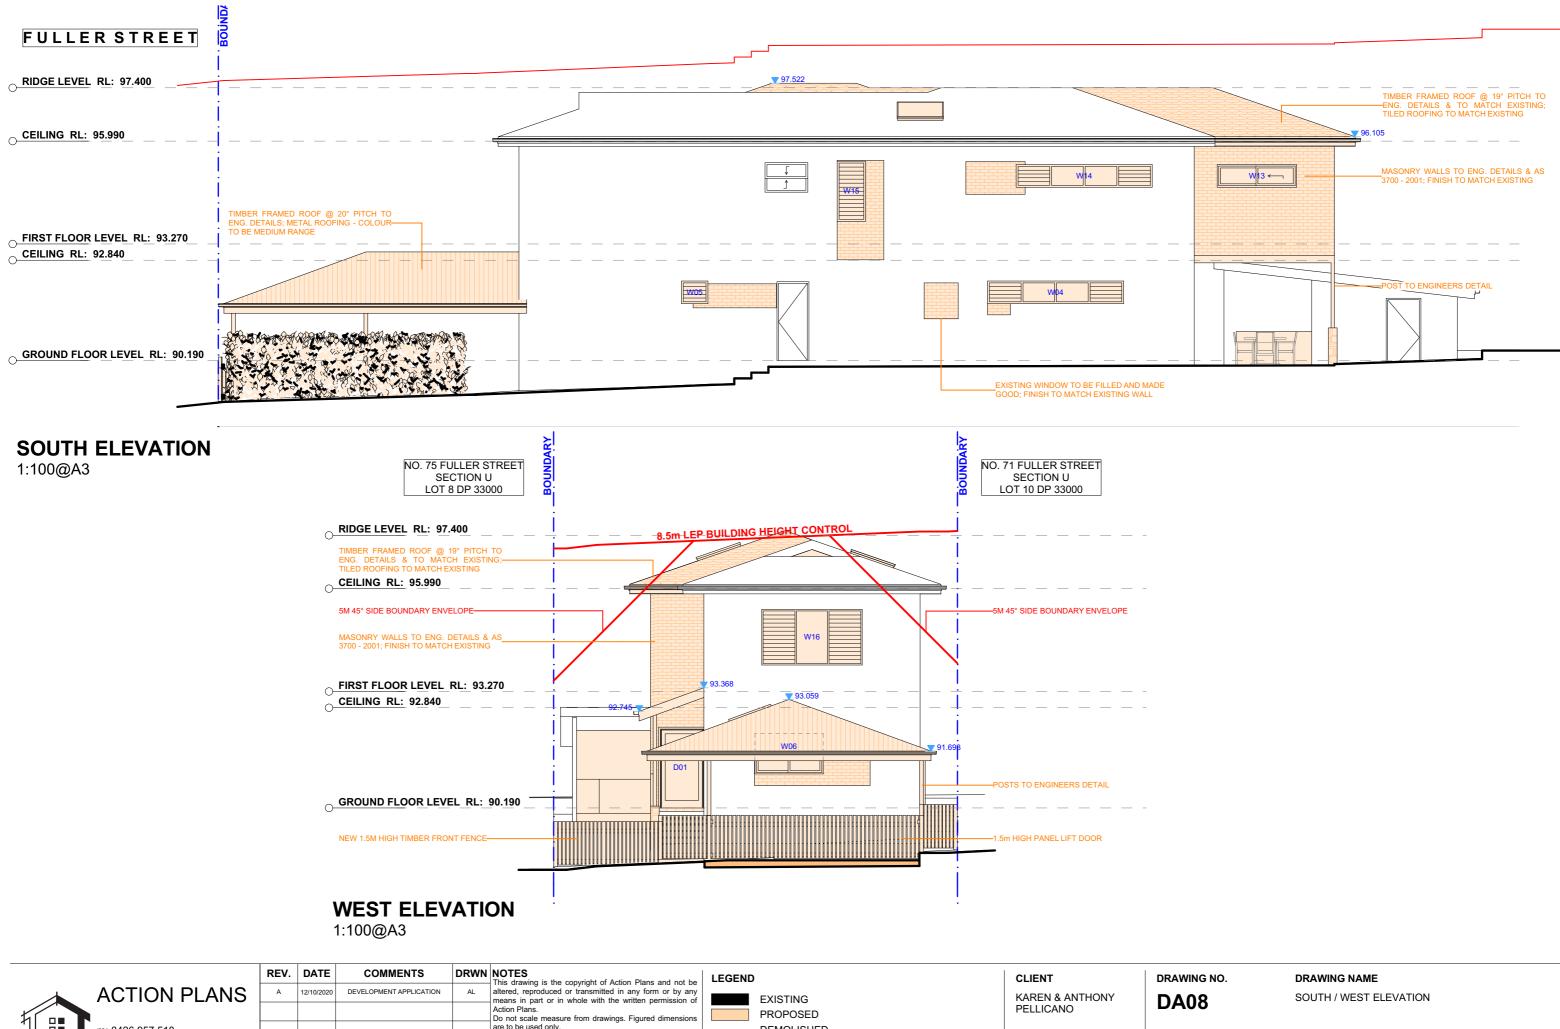


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					All errors and omissions are to be verified by the Builder/Contractor and referred to the designer prior to the commencement of works.			COLLAROY PLATEAU 2097	2020


SCALE 1:100 @A3


, 30 October

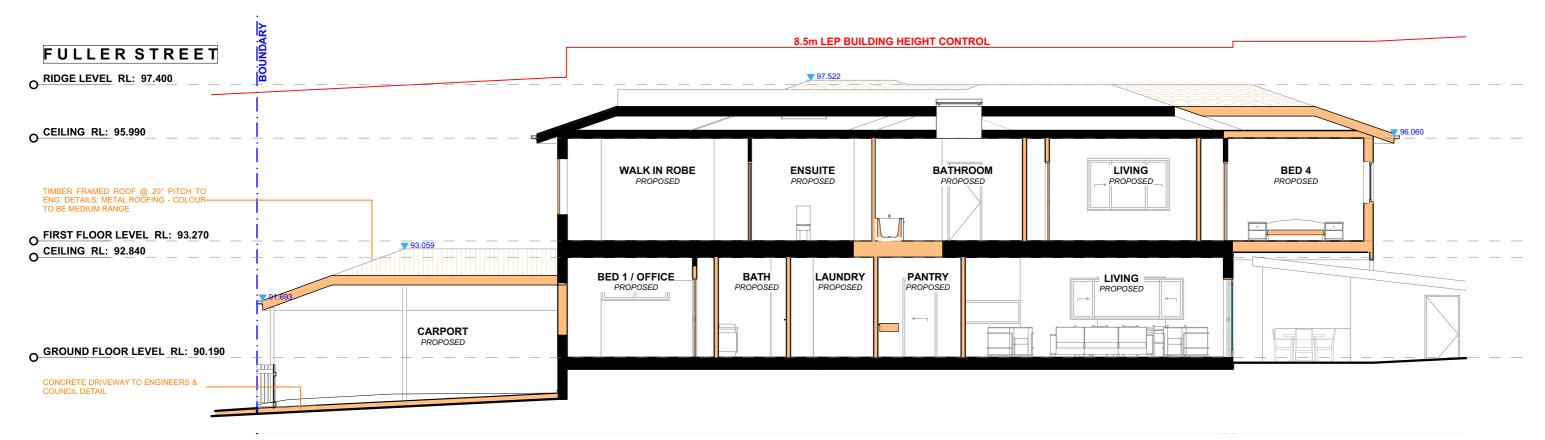

LONG SECTION AA


1:100@A3

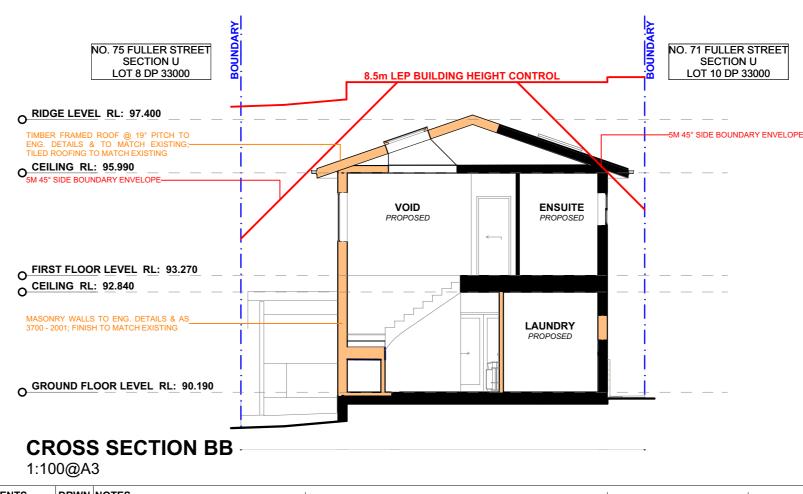

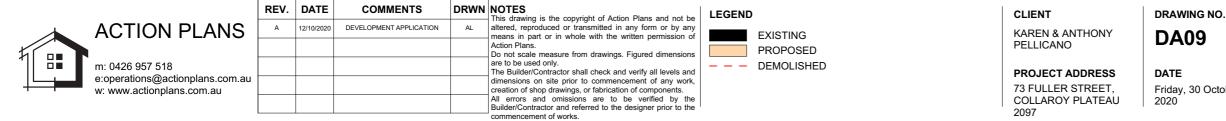

DRAWING NAME LONG / CROSS SECTION

Friday, 30 October

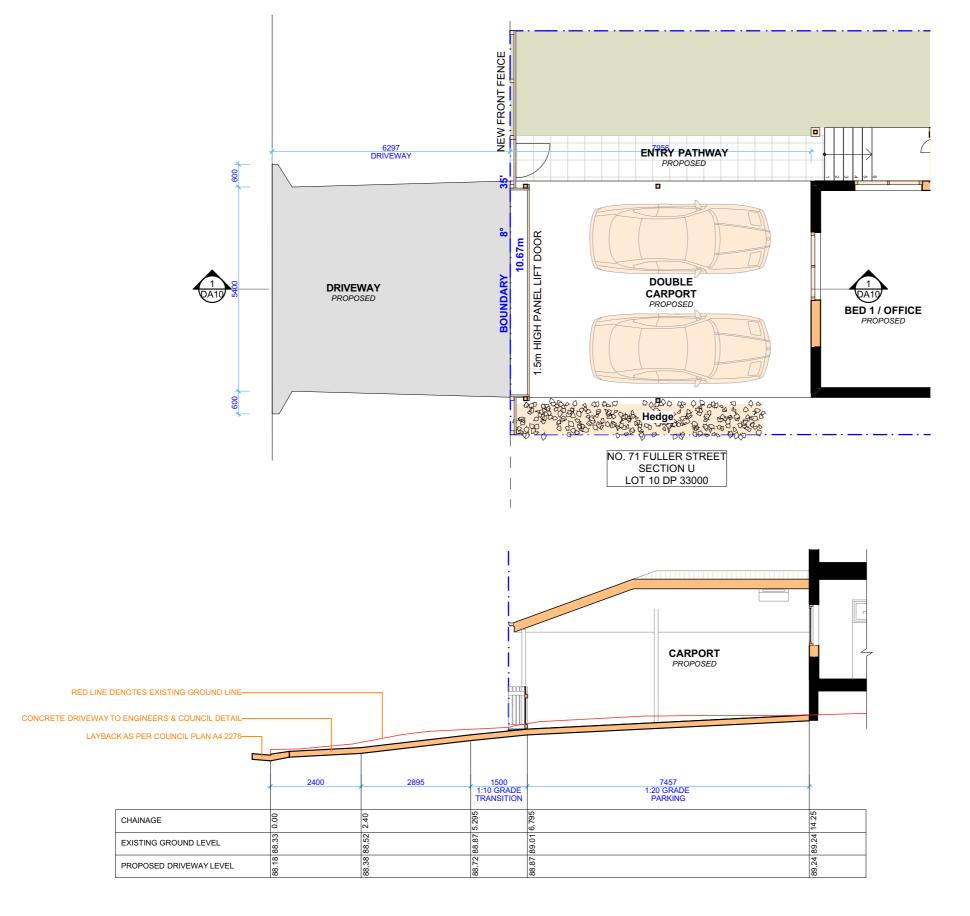

DRIVEWAY LONG SECTION

1:100@A3




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nplans.com.au					dimensions on site prior to commencement of any work, reation of shop drawings, or fabrication of components. All errors and omissions are to be verified by the Juilder/Contractor and referred to the designer prior to the		73 FULLER STREET, COLLAROY PLATEAU	Friday, 30 2020
					commencement of works.		2097	

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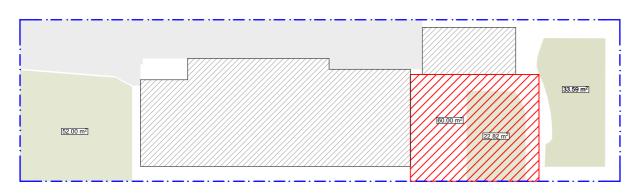
DRAWING NAME

DRIVEWAY PLAN / LONG SECTION


Friday, 30 October 2020



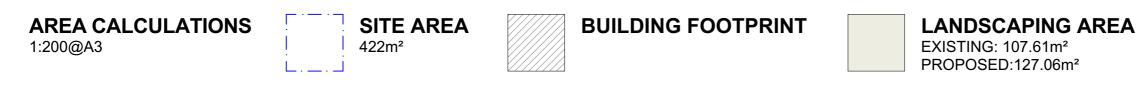




EXISTING AREA CALCULATIONS 1:250@A3

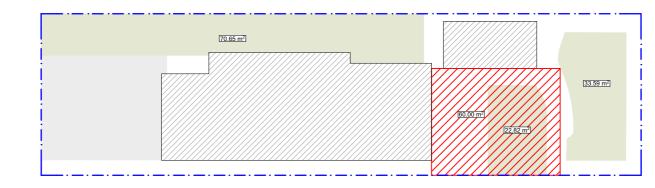

PROPOSED AREA CALCULATIONS 1:250@A3





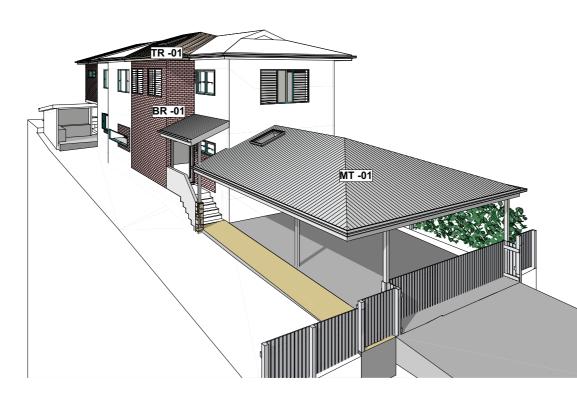

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MT-01 PAINTED COLOURBOND METAL ROOF SHEETING. 'IRONSTONE' OR SIMILAR

TR-01 TILED ROOF

TO MATCH EXISTING

BR-01 FACE BRICKWORK

TO MATCH EXISTING

WING NO.


DRAWING NAME

AREA CALCULATIONS / SAMPLE BOARD



y, 30 October

SCALE 1:250 @A3

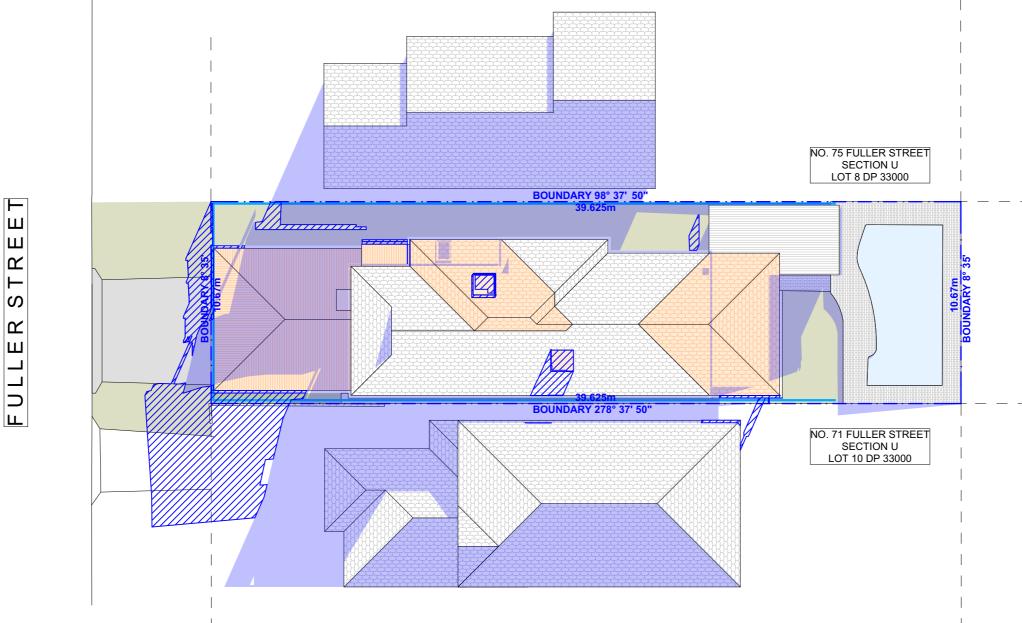

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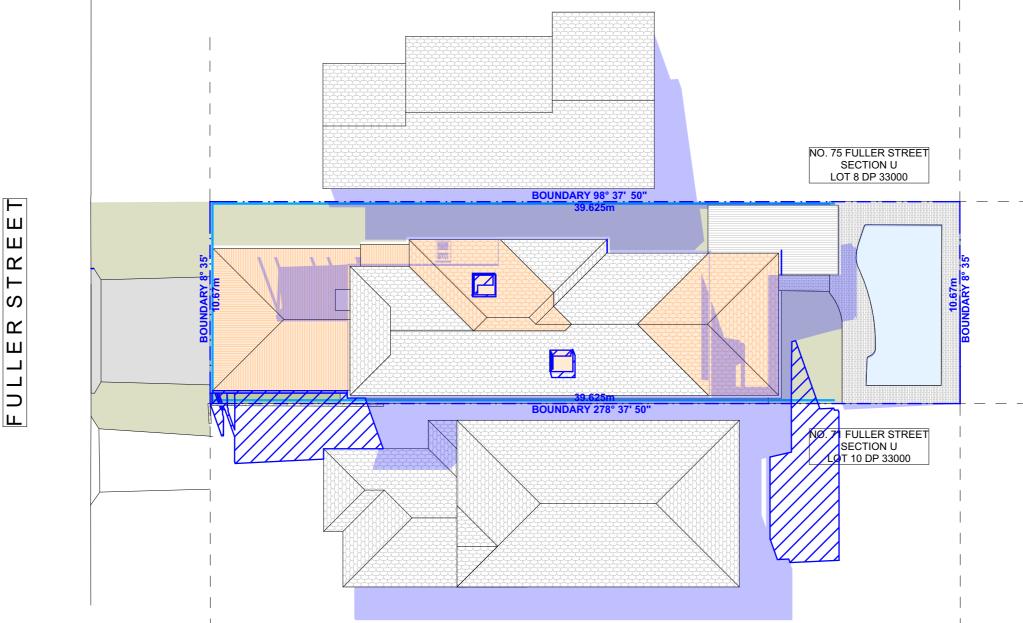
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WING NO.

DRAWING NAME WINTER SOLSTICE 9 AM



y, 30 October



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e:operations@actionpla	lans.com.au				The Builder/Contractor shall check and verify all levels and dimensions on site prior to commencement of any work,			PROJECT ADDRESS	DATE
w: www.actionplans.com.au	om.au				creation of shop drawings, or fabrication of components. All errors and omissions are to be verified by the Builder/Contractor and referred to the designer prior to the commencement of works.		73 FULLER STREET, COLLAROY PLATEAU 2097	Friday, 30 Oct 2020	

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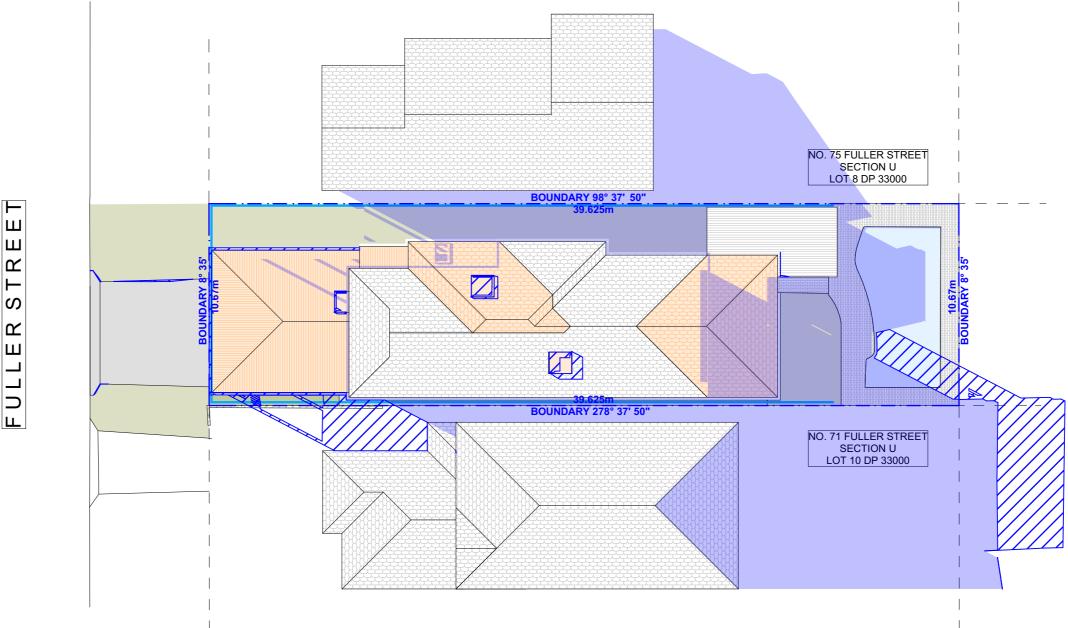
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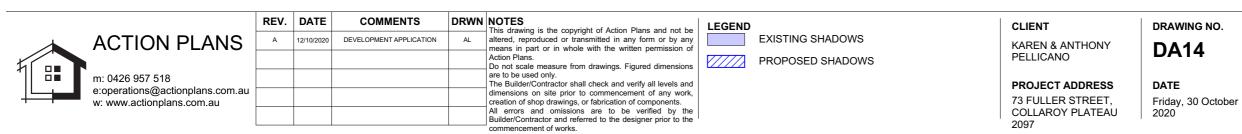
DRAWING NAME WINTER SOLSTICE 12 PM



SCALE 1:200 @A3

, 30 October





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DRAWING NAME

WINTER SOLSTICE 3 PM



page 1 / 7 BASIX Certificate number: A392305

BASIX Certificate Building Sustainability Index www.basix.nsw.gov.au

Alterations and Additions

Certificate number: A392305

NSW Planning, Industry & Environment

This certificate confirms that the proposed development will meet the NSW government's requirements for sustainability, if it is built in accordance with the have the meaning given by the document entitled. TASIX Alternions and Additions Definitions' dated 06/10/2017 published by the Department. This document is available at www.basix.nsw.gov.au

Secretary Date of issue: Friday, 09, October 2020 To be valid, this certificate must be lodged within 3 months of the date of issue.

Certificate Prepare	${f d}$ ${f by}$ (please complete before submitting to Council or PCA)
Name / Company Name	Action Plans
ABN (if applicable): 1711	8297587

Separate dwelling house

73 FULLER STREET 73 FULLER Street COLLAROY PLATEAU 2097

My renovation work is valued at \$50,000 or more and does not include a pool (and/or spa).

Building Sustainability Index www.basix.nsw.gov.au Planning, Industry & Environmen

how on C/CDC lans & Certifie

BASIX Certificate number: A392305

Glazing re	equirements						Show on DA Plans	Show on CC/CDC Plans & specs	Certifie Check
Windows	and glazed o	doors							
					hading devices, in accordance with r each window and glazed door.	the specifications listed in the table below.	\checkmark	\checkmark	~
The following	ng requirement	ts must also	be satisfi	ed in relation	to each window and glazed door:			\checkmark	~
have a U-va	alue and a Sola	ar Heat Gair	n Coefficie	ent (SHGC)		ed glass may either match the description, or, le below. Total system U-values and SHGCs s.		~	~
have a U-va must be cal	alue and a Sola Iculated in acco	ar Heat Gair ordance with	n Coefficie n National	ent (SHGC) Fenestratio	to greater than that listed in the tab	ar glazing, or toned/air gap/clear glazing must le below. Total system U-values and SHGCs s. The description is provided for information		~	~
					f each eave, pergola, verandah, ba han 2400 mm above the sill.	lcony or awning must be no more than 500 mm	n 🗸	~	~
Pergolas w	ith polycarbona	ate roof or s	imilar tran	slucent mate	erial must have a shading coefficier	t of less than 0.35.		~	~
External lou	uvres and blind	is must fully	shade the	e window or	glazed door beside which they are	situated when fully drawn or closed.		\checkmark	~
					e window or glazed door above wh ens must not be more than 50 mm.	ich they are situated, unless the pergola also		~	~
Windows	s and glazed	d doors g	lazing r	equireme	nts				
Window / c no.	door Orientatio	on Area of glass inc. frame (m2)	Oversha Height (m)	dowing Distance (m)	Shading device	Frame and glass type			
W01	N	1.08	0	0	eave/verandah/pergola/balcony >=900 mm	standard aluminium, single clear, (or U-value: 7.63, SHGC: 0.75)	1		
W02	N	2.14	0	0	external louvre/blind (adjustable)	standard aluminium, single clear, (or U-value: 7.63, SHGC: 0.75)	1		
W03	N	3.3	0	0	external louvre/blind (adjustable)	standard aluminium, single clear, (or	11		

Window / door	Orientation	Area of	of Overshadowing		Shading device	Frame and class type	
		glass inc. frame (m2)	Height (m)	Distance (m)			
						U-value: 7.63, SHGC: 0.75)	
W04	s	2.16	0	0	none	standard aluminium, single clear, (or U-value: 7.63, SHGC: 0.75)	
W05	s	0.42	0	0	none	standard aluminium, single clear, (or U-value: 7.63, SHGC: 0.75)	
W06	w	1.94	0	0	eave/verandah/pergola/balcony >=900 mm	standard aluminium, single clear, (or U-value: 7.63, SHGC: 0.75)	
W07	N	1.98	0	0	eave/verandah/pergola/balcony >=600 mm	standard aluminium, single pyrolytic low-e, (U-value: 5.7, SHGC: 0.47)	
W08	N	2.34	0	0	eave/verandah/pergola/balcony >=600 mm	standard aluminium, single pyrolytic low-e, (U-value: 5.7, SHGC: 0.47)	
W09	N	2.34	0	0	eave/verandah/pergola/balcony >=600 mm	standard aluminium, single pyrolytic low-e, (U-value: 5.7, SHGC: 0.47)	
W10	N	1.26	0	0	eave/verandah/pergola/balcony >=600 mm	standard aluminium, single pyrolytic low-e, (U-value: 5.7, SHGC: 0.47)	
W11	E	1.98	0	0	eave/verandah/pergola/balcony >=600 mm	standard aluminium, single pyrolytic low-e, (U-value: 5.7, SHGC: 0.47)	
W12	E	1.98	0	0	eave/verandah/pergola/balcony >=600 mm	standard aluminium, single pyrolytic low-e, (U-value: 5.7, SHGC: 0.47)	
W13	s	1.26	0	0	eave/verandah/pergola/balcony >=600 mm	standard aluminium, single clear, (or U-value: 7.63, SHGC: 0.75)	
W14	s	2.16	0	0	eave/verandah/pergola/balcony >=600 mm	standard aluminium, single clear, (or U-value: 7.63, SHGC: 0.75)	
W15	s	1.19	0	0	eave/verandah/pergola/balcony >=600 mm	standard aluminium, single clear, (or U-value: 7.63, SHGC: 0.75)	
W16	W	3.5	0	0	external louvre/blind (adjustable)	standard aluminium, single clear, (or	

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Glazing re	quirements							Show on DA Plans	Show on CC/CDC Plans & specs	Certifi Checł
Window / do no.	oor Orientation	Area of glass inc. frame (m2)	Oversha Height (m)	dowing Distance (m)	Shading device		Frame and glass type			
D01	w	2.44	0	0	eave/verandah/pergo	la/balcony	U-value: 7.63, SHGC: 0.75) standard aluminium, single clear, (or U-value: 7.63, SHGC: 0.75)			
D02	E	9.79	0	0	eave/verandah/pergo >=900 mm	la/balcony	standard aluminium, single clear, (or U-value: 7.63, SHGC: 0.75)			
					ne specifications listed i	n the table b	elow.	~	 	
	nt may either ma				to each skylight: I-value and a Solar Hea	t Gain Coeff	icient (SHGC) no greater than that listed in		~	~
External aw	•			the skylight a	bove which they are si	tuated when	fully drawn or closed.		\checkmark	~
	glazing regu	uiremen		4		Frame and	nlass type			
Skylights		nlazinn								
Skylight nur			Shading	device						
	mber Area of			fixed awning	or blind		moulded plastic single clear, (or U-value:			

Glazing requ	irements						Show on DA Plans	Show on CC/CDC Plans & specs	Certifier Check
Window / door no.	Orientation	Area of glass inc. frame (m2)	Oversha Height (m)	dowing Distance (m)	Shading device	Frame and glass type			
D01	w	2.44	0	0	eave/verandah/pergola/balcony >=900 mm	U-value: 7.63, SHGC: 0.75) standard aluminium, single clear, (or U-value: 7.63, SHGC: 0.75)			
D02	E	9.79	0	0	eave/verandah/pergola/balcony >=900 mm	standard aluminium, single clear, (or U-value: 7.63, SHGC: 0.75)			
Skylights							-		1
The applicant m	nust install the	e skylight:	s in accor	dance with th	ne specifications listed in the table	below.	~	\checkmark	~
The following re	quirements r	nust also	be satisfi	ed in relation	to each skylight:			\checkmark	\checkmark
Each skylight m the table below.		tch the de	scription,	or, have a U	I-value and a Solar Heat Gain Coe	fficient (SHGC) no greater than that listed in		~	\checkmark
External awning	s and louvre	s must fu	lly shade	the skylight a	above which they are situated whe	n fully drawn or closed.		\checkmark	\checkmark
Skylights gl	azing requ	iremen	ts						
Skylight numbe	r Area of g inc. fram		Shading	device	Frame an	d glass type			
S1	1.44		external	fixed awning	or blind aluminium 6.21, SHO	, moulded plastic single clear, (or U-value: GC: 0.808)			
S2	1.44		external	fixed awning	or blind aluminium	, moulded plastic single clear, (or U-value:	11		

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es and sv Lighting The applicant must ensure a minimum of 40% of new or altered light fixtures are fitted with light-emitting-diode (LED) lamps. Fixtures The applicant must ensure new or altered showerheads have a flow rate no greater than 9 litres per minute or a 3 The applicant must ensure new or altered toilets have a flow rate no greater than 4 litres per average flush or a min The applicant must ensure new or altered taps have a flow rate no greater than 9 litres per minute or minimum 3 s

			page 2 / 7	BASIX Certificate number: A392305
	Show on DA Plans	Show on CC/CDC Plans & specs	Certifier Check	Construction
				Insulation requirements
fluorescent, or		~	\checkmark	The applicant must constru- the table below, except that is not required for parts of a
3 star water rating.	1	<i>✓</i>	√	Construction
ninimum 3 star water rating.		V	×	suspended floor with open (R0.7).
star water rating.		\checkmark		external wall: brick veneer

Construction	Show on DA Plans	Show on CC/CDC Plans & specs	Certifier Check		
nsulation requirements					
	d construction (floor(s), walls, and ceilings/roofs) i tion is not required where the area of new constru- where insulation already exists.		~	\checkmark	~
			-		
	Additional insulation required (R-value)	Other specifications	-		
Construction suspended floor with open subfloor: framed (R0.7).		Other specifications	_		
Construction suspended floor with open subfloor: framed	Additional insulation required (R-value)	Other specifications			

Window / door	Orientation		Oversha	adowing	Shading device	Frame and glass type
		glass inc. frame (m2)	Height (m)	Distance (m)		
						U-value: 7.63, SHGC: 0.75)
W04	s	2.16	0	0	none	standard aluminium, single clear, (o U-value: 7.63, SHGC: 0.75)
W05	s	0.42	0	0	none	standard aluminium, single clear, (o U-value: 7.63, SHGC: 0.75)
W06	w	1.94	0	0	eave/verandah/pergola/balcony >=900 mm	standard aluminium, single clear, (o U-value: 7.63, SHGC: 0.75)
W07	N	1.98	0	0	eave/verandah/pergola/balcony >=600 mm	standard aluminium, single pyrolytic (U-value: 5.7, SHGC: 0.47)
W08	N	2.34	0	0	eave/verandah/pergola/balcony >=600 mm	standard aluminium, single pyrolytic (U-value: 5.7, SHGC: 0.47)
W09	N	2.34	0	0	eave/verandah/pergola/balcony >=600 mm	standard aluminium, single pyrolytic (U-value: 5.7, SHGC: 0.47)
W10	N	1.26	0	0	eave/verandah/pergola/balcony >=600 mm	standard aluminium, single pyrolytic (U-value: 5.7, SHGC: 0.47)
W11	E	1.98	0	0	eave/verandah/pergola/balcony >=600 mm	standard aluminium, single pyrolytic (U-value: 5.7, SHGC: 0.47)
W12	E	1.98	0	0	eave/verandah/pergola/balcony >=600 mm	standard aluminium, single pyrolytic (U-value: 5.7, SHGC: 0.47)
W13	s	1.26	0	0	eave/verandah/pergola/balcony >=600 mm	standard aluminium, single clear, (o U-value: 7.63, SHGC: 0.75)
W14	s	2.16	0	0	eave/verandah/pergola/balcony >=600 mm	standard aluminium, single clear, (o U-value: 7.63, SHGC: 0.75)
W15	S	1.19	0	0	eave/verandah/pergola/balcony >=600 mm	standard aluminium, single clear, (o U-value: 7.63, SHGC: 0.75)
W16	W	3.5	0	0	external louvre/blind (adjustable)	standard aluminium, single clear, (c

REV. DATE COMMENTS DRWN NOTES

 INOTES

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 Do not scale measure from drawings. Figured dimensions are to be used only.

 The Builder/Contractor shall check and verify all levels and dimensions on site prior to commencement of any work, creation of shop drawings, or fabrication of components.

 All errors and omissions are to be verified by the Builder/Contractor and referred to the designer prior to the commencement of works.

 All window & door dimensions, orientation, glazing materials, opening types, frame types are to be confirmed by a suitably qualified person prior to the ordering of any such materials are to take place.

 U value takes precedence over glazing type/colour in all cases.

 all new glazing must meet the BASIX specified frame and glass type, <u>OR</u> meet the ecified U value and SHGC value.

 CLIENT **ACTION PLANS** А DEVELOPMENT APPLICATION AL 12/10/2020 KAREN & ANTHONY **DA15** PELLICANO m: 0426 957 518 PROJECT ADDRESS DATE e:operations@actionplans.com.au 73 FULLER STREET, w: www.actionplans.com.au COLLAROY PLATEAU 2020 2097

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BASIX Certificate number: A392305

Project name Street address

Lot number Section numb

Project type

Dwelling type

Type of alteration and addition

Local Government Area Northern Beaches Council Plan type and number Deposited Plan 33000

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