GELATO MESSINA MANLY

1-3 Sydney Road, Manly NSW 2095

DRAWING LIST						
DRAWING NO.	DRAWING TITLE	REV				
A-301	COVER PAGE	A				
A-302	SITE PLAN	A				
A-303	SIGNAGE PLAN	А				
A-304	SHOPFRONT ELEVATION	A				
A-305	SHOPFRONT ELEVATION	A				
A-301	SIGNAGE DETAILS	A				

HEALTH NOTES

- 1. All food fit out must comply with the Design, Construction & Fitout for Food Premises AS4674-2004.
- 2. All service pipes, condensate pipes and electrical conduits must be sealed into the walls, floors or plinths.
- 3. The doors of the airlock and sanitary compartments must be close-fitting and self closing.
- 4. All joints formed by the butting together of fittings must be sealed in such a manner as to eliminate any cavity or crevice; alternatively, a clear space of at least 75mm is to be provided.
- 5. All walls in the food preparation and kitchen area must be tiled to a height of 2m min. with glazed ceramic tiles, stainless steel, laminated plastics or similar approved impervious material adhered directly to the wall.
- 6. All intersections of floor and walls and plinths in the food preparation and kitchen area must be coved with an approved material to a minimum radius of 25mm.
- 7. Concrete plinths are to be 75mm in height and must be recessed not more than 50mm to provide a toe space.
- 8. Sinks, tubs and benches work must be finished flush to the wall.
- 9. All refrigerator and freezer cabinets not sealed flush to the wall are to be kept to a minimum of 200mm from walls.
- 10. All shelving is to be locate at least 25mm off the wall or the intersection of the shelf and wall must be completely sealed.
- 11. Handbasin supplied with hot and cold water through an approved hands free mixing device must be provided and located in close proximity to the food preparation area.
- 12. A liquid soap dispenser and paper towel dispenser must be provided above or adjacent to the handbasin.
- 13. Washing facilities must be provided and comply with food premises code.
- 14. Not less than 300 lux of light will be available on all surfaces where food is prepared, utensils are washed and sterilsed in accordance with AS 1680
- 15. Ceilings are to be constructed of rigid, smooth faced, non-absorbent material.
- 16. Temperature gauge is to be provided externally to each coolroom, chiller, freezer room or low temperature room
- 17. Waterproof membrane to be applied to all floor surface and return membrane to be minimum 300mm up wall surfaces. Membrane to be certified by relevant certifying authorities.
- 18. All equipment to be elevated from the floor 150mm in height with equipment legs or 75mm in height for concrete plinth

CODES & AUTHORITIES

The proposed works are designed and constructed in accordance with the following BCA design specification. The contractor is to fabricate and install all proposed items as per drawings to comply with the requirements of all relevant codes and authorities as follows:

- Development Application, Construction Certificate & Complying Development Approvals by Council and/or Private Certifier conditions
- Building Code of Australia (BCA)
- Sydney Water
- NSW Health Act
- All floor, wall and ceiling materials and linings will have fire hazard properties complying with BCA Specification C1.10
- -All door handles, locks and fail safe devices will comply with Clause D2.21 of the BCA
 -All automatic (power operated) doors will comply with D2.19 of the BCA
- All exits and paths of travel to an exit from any point on the floor, including the minimum unobstructed width of any path of travel to exits,
- will comply with D1.6 of the BCA
 Balustrades and handrails will comply with BCA Clause D2.16 to D2.18, and AS 1170

- Fire Hose Reels (FHR) & Fire Hydrant (FH) coverage to comply with relevant BCA requirements.

 All glazing including decals will comply with AS 1288-2006, AS 2047-1999 and AS 1170.1-2002 and AS1428.1-2009.

 Disable access, facilities and circulation space will comply with Part D3 of the BCA, Disability (Access to Premises-Buildings) Standards 2010 and AS1428 1-2009 and AS 1428 4-2009
- Artificial lightning not to exceed the maximum illumination power density specified under Clause J6.2(b) & Table J6.2a as Applicable - Artificial lighting for all rooms or space on a floor must be individually operated by a switch or other control device in accordance with
- All glazing to proposed new shopfronts will comply with Part J2 of the BCA.
- All windows and doors to proposed new shopfronts will comply with the energy efficiency sealing requirements under.
 All required essential fire safety measures will be provided and /or adjusted (where appropriate) to comply with the base building fire safety schedule and alternative solution requirements, unless otherwise altered in the fire safety schedule issued with the CC/CDC approval for the proposed works. Refer to Fire Safety Schedule (or Annual Fire Safety Statements) issued for the base building and the CC/CDC issued for the proposed works.

FOOD PREMISES CODES & AUTHORITIES

The Contractor to ensure all food premises construction to comply with the requirements of:

- The relevant provisions of the Building Code of Australia relating to:
 - > lightweight construction; > emergency lighting and exit signs;

 - > access and egress;
 - fire-fighting equipment;energy efficiency;
 - >mechanical ventilation system
 - > toilet and other sanityh facilities for patrons and staff;
- AS 4674-2004 Design, Construction and Fitout of Food Premises;
- FSANZ Food Standards Code;
- The Food Act 2003:
- The Food (General) Regulation 2004;
- The minimisation of likely contamination of food and the provision of temperature control as required by the Food Regulations;
- Council's Code for Waste Handling in Buildings

MATERIALS & FINISHES SPECIFICATION

- 1. No substitution of specified materials is to be made without the approval of Vie Studio.
- 2. Where required the contractor shall submit identified samples of any materials or items to be used on the project. All samples to be approved by Vie Studio prior to construction, any work not conforming to the approved sampled will be rejected or replaced at the

DIMENSIONS

The contractor shall verify all dimensions on site prior to construction. Any discrepancy with the dimensions on plan must be reported

RESPONSIBILITY

The Contractor shall be responsible for all works under the contract and agrees to carry out and complete all works by the practical

The Contractor shall:

- Obtain all relevant documents and a copy of Development and Construction Certificate approvals and conditions prior to construction:
- Obtain all Authority approvals (excluding council DA and CC) necessary for the conduct of the works, and pay any fees in respect to those approvals prior to commencement of any works:
- Obtain all relevant consultant drawings prior and ensure all works according to approved drawings are carried out.

 Obtain all relevant information on the location and depth of any existing services, and check all requirements which exist on the site.
- including those not shown on the drawings;
- Comply with all laws that are relevant to the conduct of the works, including any laws relating to the environment, and pay any fees in respect of complying with all laws:
- Obtain landlord, body corporate or management's approvals for any work affecting other tenancies as a result of the works;
- Comply with all relevant Australian Standards, environmental standards and industry codes, including any construction or operating standards advised by FHC, the OHS act and Work Cover requirement;

COMPLETION

- Prior to the issue of the Certificate of Practical Completion, the Contractor shall arrange to:
 Thoroughly clean all areas prior to hand over of site, including any ease/oil locks, stains and droppings of paint and mortar and other similar works:
- Test all services, fixtures and equipment;
 Leave the project clean, tidy and fit for use or occupancy by the Client;
- Provide information for warranties and guarantees of all services, equipments and fittings;
 Obtain or Issue all relevant certificates of compliance for the issuance of Occupation Certificate



GENERAL NOTES

- 1. DO NOT SCALE DRAWNAS, FIGURED DIMENSIONS ARE TO BE FOLLOWED.
 2. COPPRISH OF THESE DRAWNAS AND REAL RED DOCUMENTS ARE RESERVED BY VIE STUDIO.
 2. COPPRISH OF THESE DRAWNES AND REAL RED DOCUMENTS ARE RESERVED BY VIE STUDIO.
 2. COPPRISH OF THE DEPLOYED FOR THE PRICE TO CONSTRUCTION. IN THE EVENT OF ANY DISCREPANCIES ON THESE DRAWNAS, THE CONTRACTOR SHALL.
 3. CHIEF CONTRACTOR'S RESPONSIBILITY TO GETAN APPROVALS FROM APPROPRIATE AUTHORITIES INCLUDING LOCAL COUNCIL AND WATER BOARD PRIOR TO CONSTRUCTION.
- CONSTRUCTION

 S. MEASUR-BIEST FOR THE FARRICATION OF SECONDARY COMPONENTS ARE TO BE TAKEN ON SITE TO SLIFT

 6. CONTRACTOR TO LIASE WITH THICH PARTY SUPPLERS TO CONFRIM EACH REQUIREMENTS, NOLLDING ELECTRICAL, DATA, COMMS, HYDRAULICS AND ANY OTHER
 RELATED REQUIREMENTS.

 7. CONTRACTOR TO ENSURE STRUCTURAL INTEGRITY, STABILITY AND FEASIBILITY OF ALL UNITS/COMPONENTS PRIDE TO FARRICATION. ALL STRUCTURAL COMPONENTS

 SHALL BE READ NO ACCORDANCE TO DETALS AND SPECIFICATIONS PREPABED BY A STRUCTURAL ENONEMER

 8. ALL ARCHITECTURAL DOLDMENTATION ARE TO BE READ IN CONJUNCTION WITH OTHER CONSIST.

 8. ALL ARCHITECTURAL OUT OF THE STRUCTURAL STR

OUTDOOR SEATING PLAN

REVISED DRAWING SET

DATE:

PROJECT NUME
22535-S

DRAWING TITLE: **COVER PAGE**

DRAWN BY: KL CHECKED BY: SI DRAWING No: REVISION: A-301 Ε

SCALE:

1:1

PAPER SIZE: A3



SITE PLAN

SUITE 1, 11 BOWDEN ST ALEXANDRIA NSW 2015 T: 02 95505268 E: DESIGN@VIESTUDIO.COM.AU W: WWW.VIESTUDIO.COM.AU

GENERAL NOTES

LID NOT SCALE DRAWINDS, FIGURED DIMENSIONS ARE TO BE FOLLOWED

2. COPYRIGHT OF THESE DRAWINGS AND RELATED DOCUMENTS ARE RESERVED BY VIE STUDIO.

3. ALL DIMENSIONS ARE TO BE CONFEMED ON SITE PRIOR TO CONSTRUCTION. IN THE EVENT OF ANY DISCREPANCIES ON THESE DRAWINGS, THE CE CONTACT THE DESIGNER BEFORE PROCEEDING WITH ANY WORK.

4. IT IS THE CONTRACTOR'S RESPONSIBILITY TO OBTAIN APPROVALS FROM APPROPRIATE AUTHORITIES INCLUDING LOCAL COUNCIL AND WATER BO

CONSTRUCTION

5. MEASUREMENTS FOR THE FABRICATION OF SECONDARY COMPONENTS ARE TO BE TAKEN ON SITE TO SUIT.

6. CONTRACTOR TO LIABSE WITH THRID PARTY SUPPLERS TO CONFRIM DEACT REQUIREMENTS, INCLUDING ELECTRICAL, DATA, COMMS, HYDRAULICS AND ANY OTHER RELATED REQUIREMENTS.

7. CONTRACTOR TO ENSURE STRUCTURAL INTEGRITY. STABILITY AND FEASBILITY OF ALL MITS/COMPONENTS PRIOR TO FABRICATION ALL STRUCTURAL COMPONENTS.

8. PAUL ER FIELD M ACCORDANCE TO DETALS AND SPECPICATIONS PREPARED BY A STRUCTURAL ENGINEER.

8. PAUL BY A COUNTRACTOR TO COUNTRACTOR AND CONDANCETOR WITH OTHER CONDAILATED BRAWNESS/PEOFICATION AND ALL OTHER REATED DOCUMENTS.

9. ALL WORKS TO BE INACCORDANCE WITH THE BULLDING CODE OF ALSTRALIA, ALSTRALIAM STANDARDS, STATUTORY REGULATIONS AND LOCAL AUTHORITY.

REV: NOTES: SIGNAGE DETAILS


DATE: 10.11.2022

22535-S

GELATO MESSINA MANLY PROJECT NUMBER

DRAWING TITLE: SITE PLAN

PAPER SIZE: A3 SCALE: 1:100 DRAWN BY: KL CHECKED BY: SL DRAWING No: REVISION: A-302 Α

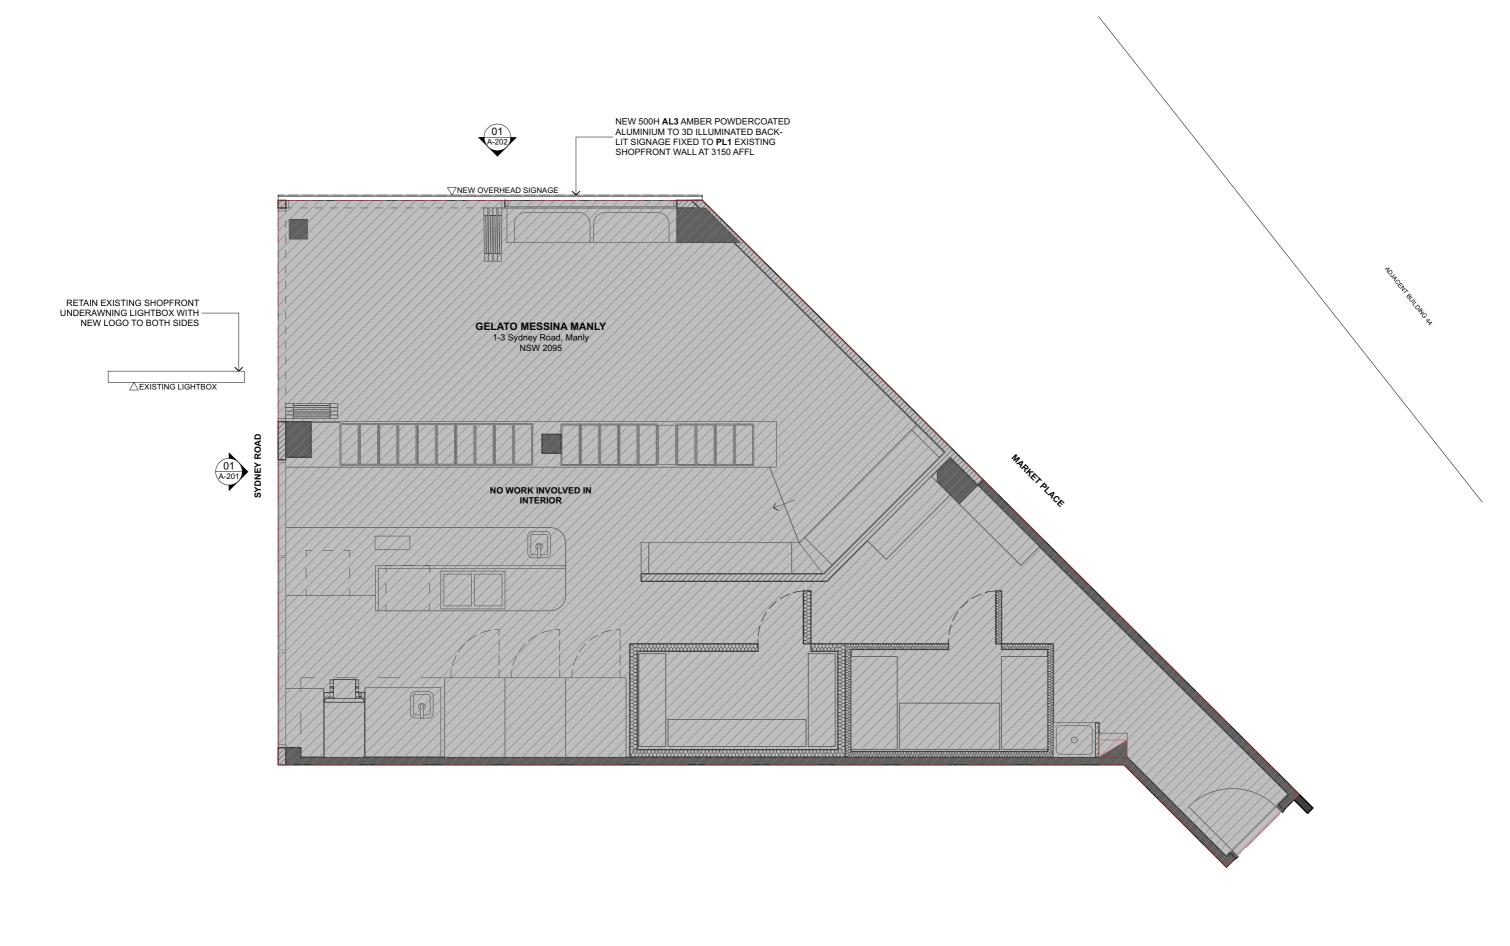

SIGNAGE PLAN 1:50

SUITE 1, 11 BOWDEN ST ALEXANDRIA NSW 2015 T: 02 95505268 E: DESIGN@VIESTUDIO.COM.AU W: WWW.VIESTUDIO.COM.AU

GENERAL NOTES

1. DO NOT SCALE DRAWINGS, FIGURED DIMENSIONS ARE TO BE FOLLOWED
 2. COPPRIENT OF THESE BRAWINGS AND RELATED DOCUMENTS ARE RESERVED BY VIE STUDIO.
 3.4LD IMMENSIONS ARE TO BE CONFIRMED ON SITE PRICE TO CONSTRUCTION IN THE EVENT OF ANY DISCREPANCIES ON THESE DRAWINGS, THE CONTRACTOR SHALL
 4.1T S.THE CONTRACTOR'S RESPONSIBILITY TO OBTAIN APPROVALS FROM APPROPRIATE AUTHORITIES INCLUDING LOCAL COUNCIL AND WATER BOARD PRIOR TO

THE PROPERTY OF THE PROPERTY O

REV: NOTES:

A SIGNAGE DETAILS


DATE: 10.11.2022 PROJECT GELATO MESSINA MANLY 1-3 Sydney Road, Manly NSW 2095

PROJECT NUMBER 22535-S

DRAWING TITLE: SIGNAGE PLAN PAPER SIZE: A3 SCALE: 1:50 DRAWN BY: KL CHECKED BY: SL DRAWING No: REVISION:


Α

A-303

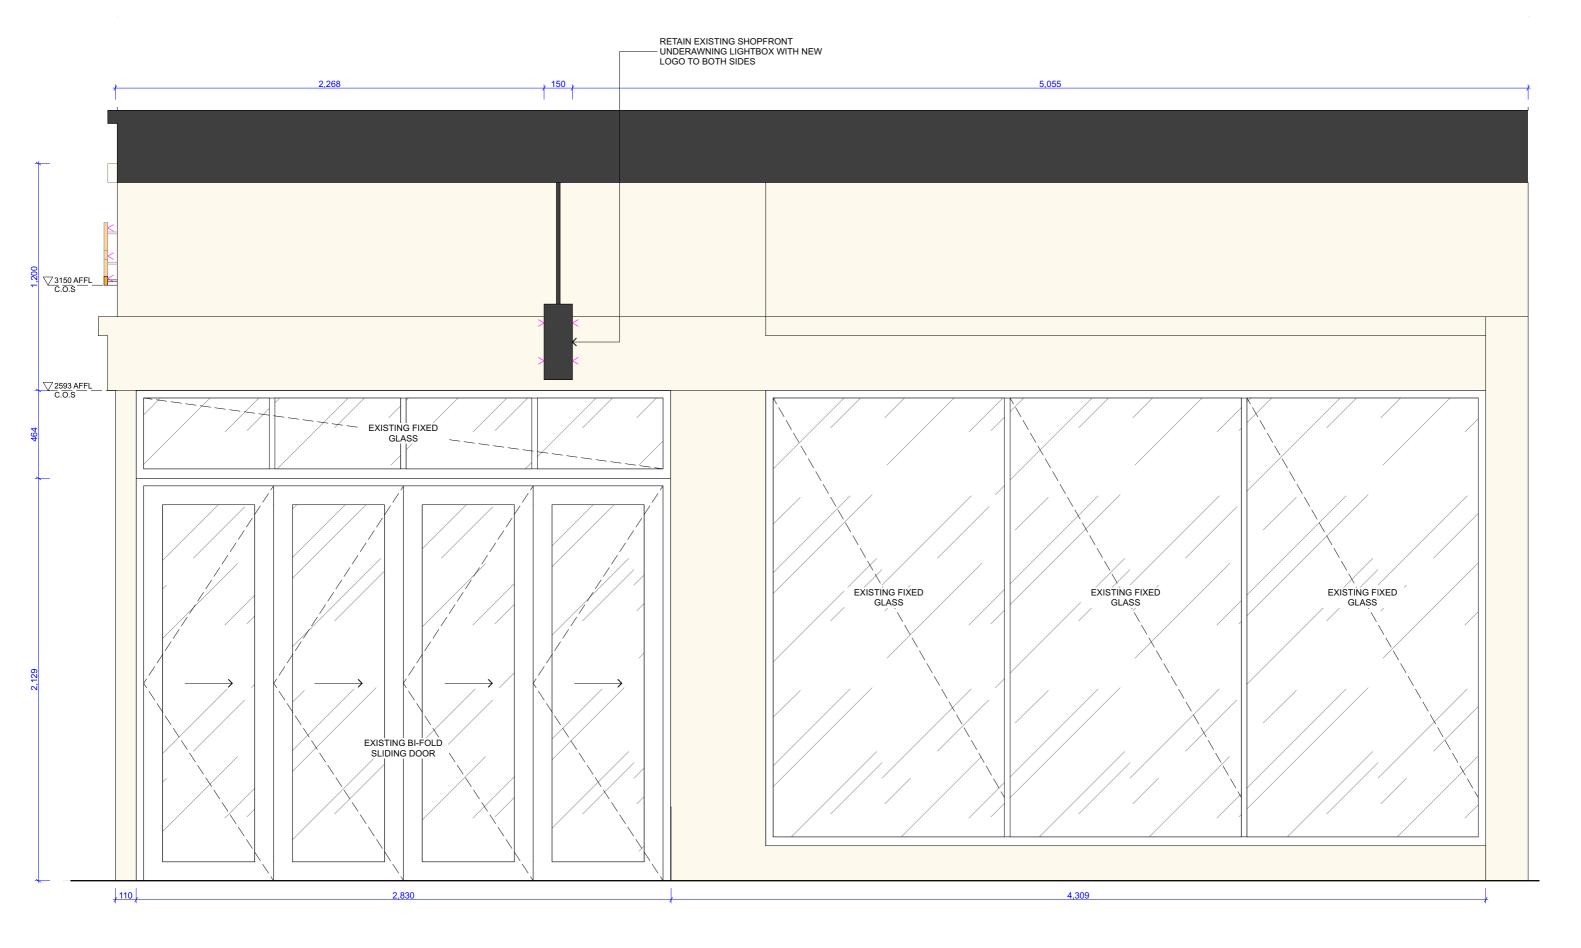

O1 SHOPFRONT ELEVATION 1:20

Vìe	GENERAL NOTES 1. DO NOT SCALE DRAWNAS, FIGURED DIMENSIONS ARE TO BE FOLLOWED.	REV: NOTES:	DATE:	PROJECT GELATO MESSINA MANLY	DRAWING TITLE:	PAPER SIZE: A3	SCALE:	1:20
VIG	2. COPPRIGHT OF THESE DRAWINGS AND RELATED DOCUMENTS ARE RESERVED BY VE STUDIO. 3. ALL DIMENSIONS ARET DIE CONFERMED ON SIEP FIROR TO CONSTRUCTION. IN THE EVENT OF ANY DISCREPANCIES ON THESE DRAWINGS, THE CONTRACTOR SHALL CONTRACT THE DESIGNER BEFORE PROCEEDING WITH ANY WORK. 4. IT IS THE CONTRACTOR'S REPORMSRILL TY CORTAIN APPROVADIA'S FROM APPROPRIATE ALTH-DORTORS IN ALL HOUSE AND WATER BOARD PRIOR TO	A SIGNAGE DETAILS	10.11.2022	1-3 Sydney Road, Manly NSW 2095	SHOPFRONT ELEVATION	DRAWN BY: KL	CHECKED B	3Y: SL
studio	CONSTRUCTION 5. MEASUREMENTS FOR THE FABRICATION OF SECONDARY COMPONENTS ARE TO BE TAKEN ON SITE TO SUIT. 6. CONTRACTIOR TO LAISE WITH TH'RID PARTY SUPPLIERS TO CONFRIM EXACT REQUIREMENTS, INCLUDING ELECTRICAL DATA, COMMIS, HYDRAULICS AND ANY OTHER RELATED RECOUREMENTS.			PROJECT NUMBER 22535-S		DRAWING No:	REVISION:	
SUITE 1, 11 BOWDEN ST ALEXANDRIA NSW 2015 T: 02 95505268 E: DESIGN@VIESTUDIO.COM.AU W: WWW.VIESTUDIO.COM.AU	7. CONTRACTIOR TO ENSURE STRUCTURAL NITEGRITY, STREAUTY AND FEASBULTY OF ALL INITISCOMPONENTS PRIOR TO FABRICATION. ALL STRUCTURAL COMPONENTS SHALL BE REDUD NA COCKROMME TO DETRIALS AND SPECRATIONS PERPARED BY A STRUCTURAL ENGINEER WINDIGSSPECPLAND AND ALL UTHER REALTED DOCUMENTS SHALL WORKS TO BE IN ACCORDANCE WITH THE BUILDING COCK OF AUSTRALIA, AUSTRALIAN STANDARDS, STATUTORY REGULATIONS AND LOCAL AUTHORITY REQUIREMENTS.					A-304	Α	

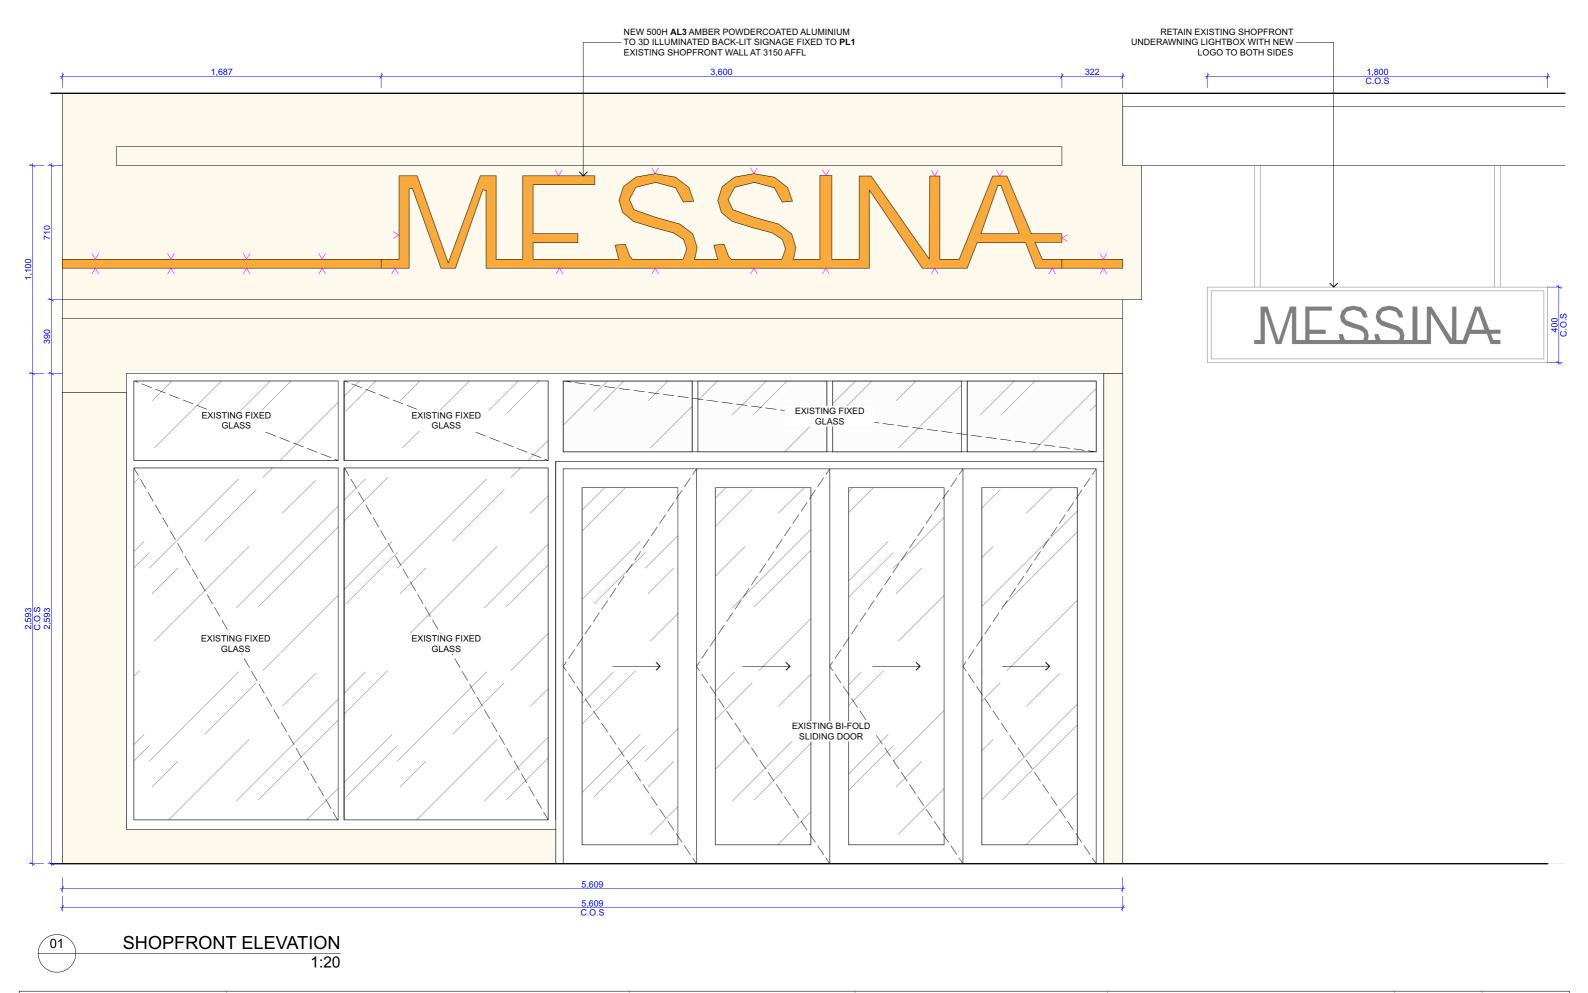

SUITE 1, 11 BOWDEN ST ALEXANDRIA NSW 2015 T: 02 95505268 E: DESIGN@VIESTUDIO.COM.AU W: WWW.VIESTUDIO.COM.AU

GENERAL NOTES

1. DO NOT SCALE DRAWINGS, FIGURED DIMENSIONS ARE TO BE FOLLOWED
 2. COPYRIGHT OF THESE DRAWINGS AND RELATED DOCUMENTS ARE RESERVED BY VIE STUDIO.
 3. ALD IMMENSION ARE TO BE CONFINED ON SITE PRICE TO CONSTRUCTION. IN THE EVENT OF ANY DISCREPANCES ON THESE DRAWINGS, THE CONTRACTOR SHALL CONTRACT THE DESIGNER BEFORE PROCEEDING WITH ANY WORK.
 1. ST. 11. CONTRACTOR'S RESPONSIBILITY TO GETAIN APPROVALS FROM APPROPRIATE AUTHORITIES INCLIDING LOCAL COUNCIL AND WATER BOARD PRIOR TO

CONSTRUCTION.

MEASUREMENTS FOR THE FARRICATION OF SECONDARY COMPONENTS ARE TO BE TAKEN ON STET TO SITE.

E CONTRACTOR TO LIASE WITH THEO PARTY SUPPLIERS TO COMPRIME PACK TEXT THEN ON STET TO SITE.

E CONTRACTOR TO LIASE WITH THEO PARTY SUPPLIERS TO COMPRIME PACK TEXTUREMENTS. INCLUDING ELECTRICAL, DATA, COMMS, HOPBALLES AND ANY OTHER RELATED REQUIREMENTS.

7. CONTRACTOR TO ENSURE STRUCTURAL INTEGRITY, STABILITY AND FEASBELITY OF ALL INITISCOMPONENTS PRIOR TO FABRICATION. ALL STRUCTURAL COMPONENTS SHALL BEFORE TO A MACCORDANCE TO DETALS AND SPECIFICATIONS PREPARED BY A STRUCTURAL ENGINEER.

SHALL BE REDO IN ACCORDANCE TO DETALS AND SPECIFICATIONS PREPARED BY A STRUCTURAL ENGINEER.

ALL WORKS TO BE IN ACCORDANCE WITH THE BULLIONS CODE OF AUSTRALA, AUSTRALAM STANDARDS, STATUTORY RESULATIONS AND LOCAL AUTHORITY

ALL WORKS TO BE IN ACCORDANCE WITH THE BULLIONS CODE OF AUSTRALA, AUSTRALAM STANDARDS, STATUTORY RESULATIONS AND LOCAL AUTHORITY

REV: NOTES:


DATE: 10.11.2022

GELATO MESSINA MANLY 1-3 Sydney Road, Manly NSW 2095

PROJECT NUMBER

DRAWING TITLE: SHOPFRONT ELEVATION PAPER SIZE: A3 SCALE: DRAWN BY: KL CHECKED BY: SL DRAWING No: REVISION:

A-305 Α

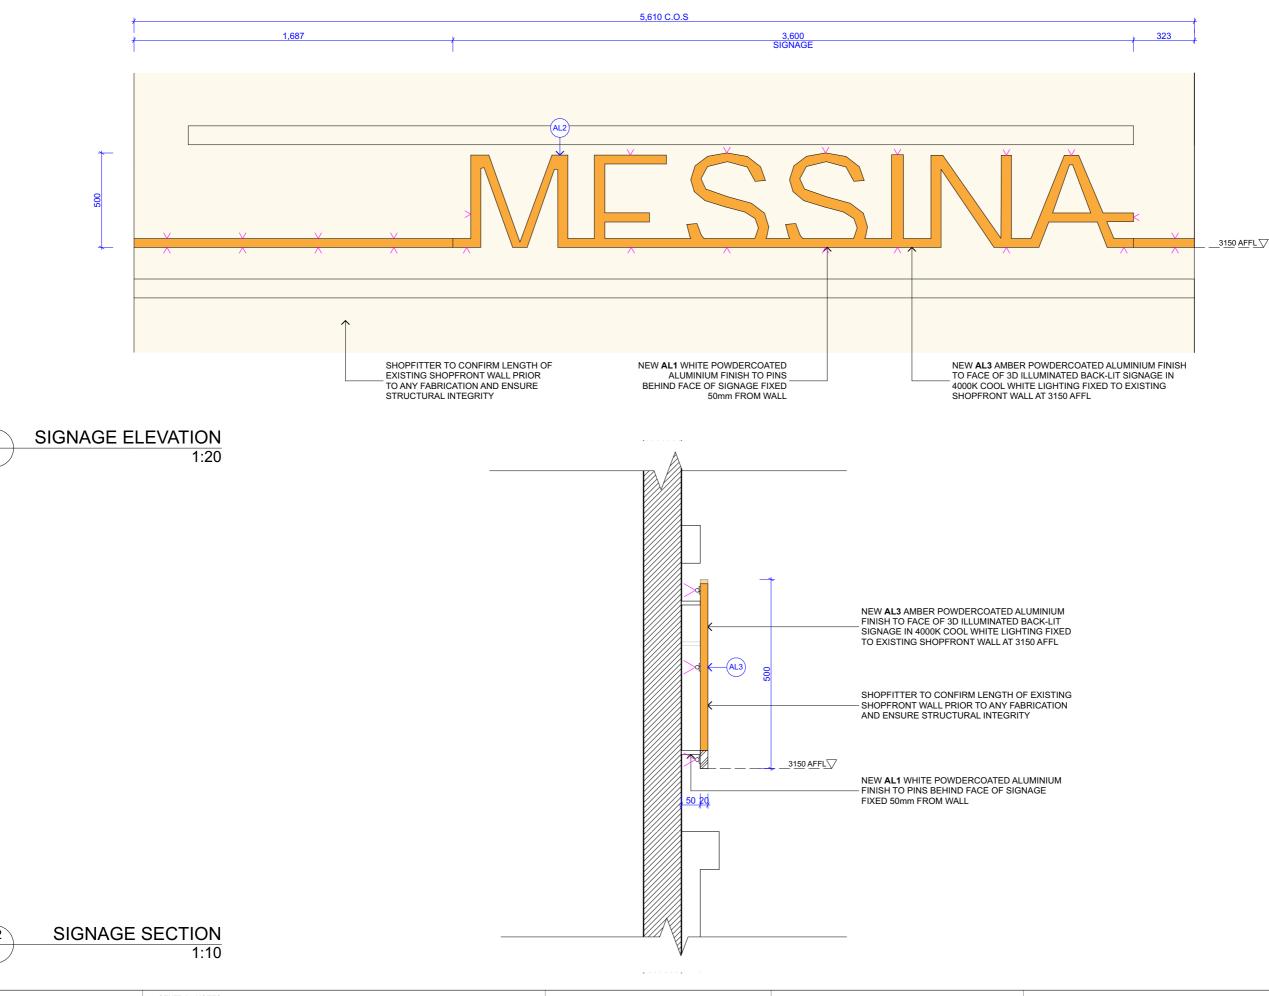

SUITE 1, 11 BOWDEN ST ALEXANDRIA NSW 2015 T: 02 95505268 E: DESIGN@VIESTUDIO.COM.AU W: WWW.VIESTUDIO.COM.AU

GENERAL NOTES

1. DO NOT SCALE DRAWNOS, FIGURED DIMENSIONS ARE TO BE FOLLOWED
 2. COPYRIGHT OF THESE DRAWNOS AND RELATED DOCUMENTS ARE RESERVED BY VIE STUDIO.
 2. COPYRIGHT OF THESE DRAWNOS AND RELATED DOCUMENTS ARE RESERVED BY VIE STUDIO.
 3. CONTACT THE DESIGNER SEPTIOR FROM CEEDING WITH ANY VIOLOGISTRUCTION. IN THE EVENT OF ANY DISCREPANCIES ON THESE DRAWNOS, THE CONTRACTOR SHALL CONTACT THE DESIGNER SEPTIOR FROM CEEDING WITH ANY VIOLOGISTRUCTION.
 4. If IS THE CONTRACTOR'S RESPONSIBILITY TO OBTAIN APPROVALS FROM APPROPRIATE AUTHORITIES INCLUDING LOCAL COUNCIL AND WATER BOARD PRIOR TO CONSTRUCTION.

CONSTRUCTION

MEASUREMENTS FOR THE FARRICATION OF SECONDARY COMPONENTS ARE TO BE TAKEN ON SITE TO SUIT.

6. CONTRACTOR TO LIASE WITH THEIR PARTY SUPPLERS TO CONFRIME PACET REQUIREMENTS, INCLIDING ELECTRICAL, DATA, COMMS, HYDRAULICS AND ANY OTHER RELATED REQUIREMENTS.

7. CONTRACTOR TO ENSURE STRUCTURAL INTEGRITY, STABILITY AND FEASBILITY OF ALL UNITS COMPONENTS PRIOR TO FARIATION ALL STRUCTURAL COMPONENTS SHALL BE REDO AN ACCORDANCE TO DETALS AND SPECIFICATIONS PREPARED BY A STRUCTURAL ENGINEER.

8. ALL AND RECONSTRUCTURE OF THE PACED ON CONTRACTION INTERPREPARED BY A STRUCTURAL ENGINEER.

8. ALL AND RECONSTRUCTURE WITH THE BULDING CODE OF AUSTRALIA, AUSTRALIAN STRUCTURES, STRUCTUREY REGULATIONS AND LOCAL AUTHORITY.

REV: NOTES:

DATE: 10.11.2022

GELATO MESSINA MANLY 1-3 Sydney Road, Manly NSW 2095

PROJECT NUMBER 22535-S

DRAWING TITLE: SIGNAGE DETAILS

PAPER SIZE: A3 SCALE: 1:20, 1:10 DRAWN BY: KL CHECKED BY: SL

DRAWING No: REVISION: A-301 Α