# G.J. Gardner. HOMES

PROJECT: NEW DWELLING

**ADDRESS: 15 MONASH PARADE** 

**DEE WHY NSW** 

LOT #: 73

DP #: 6167

DRAWING LIST					
DRAWING No	DRAWING NAME	REVISION	DATE		
GJG-A01	COVER SHEET	G	02/07/2019		
GJG-A02	EXISTING SURVEY PLAN	G	02/07/2019		
GJG-A03	SITE PLAN	G	02/07/2019		
GJG-A04	LANDSCAPE PLAN	G	02/07/2019		
GJG-A05	GROUND FLOOR PLAN	G	02/07/2019		
GJG-A06	FIRST FLOOR PLAN	G	02/07/2019		
GJG-A07	ELEVATIONS	G	02/07/2019		
GJG-A08	ELEVATIONS	G	02/07/2019		
GJG-A09	SECTIONS	G	02/07/2019		
GJG-A10	DEMOLITION PLAN	G	02/07/2019		
GJG-A11	SHADOW DIAGRAM	G	02/07/2019		
GJG-A12	EROSION & SEDIMENT PLAN	G	02/07/2019		
GJG-A13	SITE ANALYSIS	G	02/07/2019		
GJG-A14	WASTE MANAGEMENT	G	02/07/2019		
GJG-A15	BASIX COMMITMENT	G	02/07/2019		
GJG-A16	DRIVEWAY DETAIL	G	02/07/2019		



15 MONASH PARADE DEE WHY NSW

# SPECIFICATION:

The specification overrides drawings

#### STRUCTURAL DESIGN:

This design may be subject to change due to structural engineers requirements and / or LGA / PCA conditions.

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	DRAWING REVISION SCHEDI	JLE
No.	AMENDMENTS	DATE
Α	FIRST ISSUE	25/10/2018
В	ADJUST SETBACK; MAKE HOUSE WIDE; ADJUST FRIDGE SPACE; ADD LANDING TO LAUNDRY STAIRS; ADD AC UNIT; CHANGES TO BUTTLERS WINDOW; MAKE ALFRESCO WIDER; ADJUST DINING WINDOWS; MOVE WATER TANK; AJUST BALCONY DOOR; ADD DOOR TO BED 3; ADD SHELVES TO WIR; REDESIGN ENSUITE.	07/11/2018
С	ROOF CHANGED TO SKILLION ROOF WITH WITH LOW PITCH ROOF ABOVE STAIRS AND ENSUITE	27/11/2018
D	ADJUST ALFRESCO; COURTYARD WINDOW HEAD HEIGHT AT 1800; REMOVE DOORS TO ENSUITE AND ADD OPENING; HALF HEIGHT WALL TO STUDY.	29/11/2018
Е	CHANGE FF CEILING HEIGHT; ADJUST WINDOWS; ADJUST ROOF PITCH.	06/12/2018
F	UPDATE TO FULL SET DA ISSUE	18/12/2018
G	LOWER HOUSE 300mm; DELETE MASTER WIR CANTILEVERED	02/07/2019

# (Sydney North). Owner(s) signature Builders signature Date

General notes

specifications.

FINAL SIGNED COPY

any preliminary plan and

Use figured dimensions only. Do not scale from drawings. All ground lines are approximate.

Window and door sizes shown are nominal. All work to be carried out in accordance with local Council codes, BCA, Australian Standards and any relevant authorities. Wind rating, refer to framing manufacturers

I / We accept that these plans are the final working drawings. They supercede

I / We have checked that all alterations and additions are shown. I / We are aware these plans form part of our

contract between GJ Gardner Homes

# G.J. Gardner. HOMES

# **SYDNEY NORTH**

Unit 2, 28 - 30 Orchard Rd, Brookvale Sydney, NSW, 2100 Phone 9939 3339 Fax 9939 4442 www.gjgardner.com.au



SUITE 302 5 CELEBRATION DRIVE BELLA VISTA NSW 2153 PHONE: (02) 8883 4344 EMAIL: kjrdrafting@kjr.net.au

Project

DOUBLE STOREY DWELLING

Project address

15 MONASH PARADE DEE WHY NSW

Client

MARTIN

Stage

Drawing title
COVER SHEET

True North

Date	02/07	7/2019	Drawn	LV - KJR
Sheet S	Size	А3	Scale	1 : 100

Job No 230238 - GJGN077

Drawing No

GJG-A01

NO SOUNDARY SURVEY HAS BEEN UNDERTAKEN, BEARINGS, DIVENSIONS AND AREAS ARE FROM TITLE ONLY AND ARE SUBJECT TO COMPRISATION BY BOUNDARY SURVEY.

DIMENSIONS SHALL NOT BE OBTAINED BY SCALING THE DETAIL FROM THE DRAWING, SURVEYOR MUST BE CONTACTED IF THERE ARE ANY DISCREPANCIES

SERVICES SHOWN ARE INDICATIVE ONLY POSITIONS ARE BASED ON SURFACE INDICATORISI LOCATED DURING OTHER SERVICES MAY EXIST WHICH ARE NOT SHOWN

LEVELS ARE BASED ON AUSTRALIAN HEIGHT DATUM (A.H.D.) USING SSM 19736, R.L. 30,04m.

RIDGE & GUTTERS HEIGHTS HAVE BEEN OBTAINED BY INDIRECT METHOD AND ARE ACCURATE TO ±0.05m

CONTOURS ARE AN INDICATION OF LANDFORM AND SHOULD NOT BE TAKEN IN PREFERENCE TO SPOT LEVELS

ADJOINING DWELLINGS, BUILDINGS HAVE BEEN PLOTTED FOR DIAGRAMMATIC PURPOSES ONLY

CONTOUR INTERVALS 0.5m.

#### LEGEND

88 - BOTTOM OF BANK BM - BENCHMARK BRW - BOTTOM OF RETAINING WALL CHIM - CHIMNEY CL - CENTRELINE OF ROAD

CO - EDGE OF CONCRETE COG - CHANGE OF GRACE CONC - CONCRETE SURFACE LEVEL DISH - DISH DRAIN EB - EDGE OF BITUMEN EBOX - BLECTRICITY BOX ET - EDGE OF TRACK

EC - EDGE OF CONCRETE PL - FLOOR LEVEL PNC · FENCE GON - EDGE OF GARDEN GGP - GRATEO GULLY PIT GMT - GAS WETER/SERVICE

GUT - TOP OF EAVE & GUTTER HYD - HYDRANT BW - INVERT OF PIT KO - KERB OUTLET LCF - LAPPED & CAPPED PALING FENCE LP - LIGHT POLE MH - MANHOLE MPF - METAL PANEL FENCE MS - MEDIAN STRIP NS - NATURAL SURFACE PAL - PALING FENCE PAV - EDGE OF PAVERS PC - PRAM CROSSING PINV - INVERT OF PIPE PP - POWER POLE PRF - POST & RAIL FENCE PWF - POST & WIRE FENCE

RHYD - RECYCLED HYDRANT

RSV - RECYCLED STOP VALVE RIDGE - RIDGE RTK - ROLL-TOP KERB SIC - SEWER INSPECTION COVER SIP - SURFACE INLET PIT SL - SURFACE LEVEL SUH - SEWER LAWPHOUS SMH - SEWER MANHOLE SP - STOCK PILE SV - STOP VALVE SVP - SEWER VENTILATION PIPE TB - TOP OF BANK
TEL - TELECOVIMUNICATIONS PIT TK - TOP OF KERB TRW - TOP OF RETAINING WALL VC - VEHICULAR CROSSING MM - WATER METERSERVICE

WMF - WIRE WESH FENCE

DRAWING REVISION SCHEDULE **AMENDMENTS** A FIRST ISSUE 25/10/2018 B ADJUST SETBACK; MAKE HOUSE WIDE; ADJUST FRIDGE SPACE; ADD LANDING TO LAUNDRY STAIRS; ADD AC UNIT; CHANGES TO BUTTLERS WINDOW; MAKE ALFRESCO WIDER; ADJUST DINING WINDOWS; MOVE WATER TANK; AJUST BALCONY DOOR; ADD DOOR TO BED 3; ADD SHELVES TO WIR; REDESIGN ENSUITE C ROOF CHANGED TO SKILLION 27/11/2018 ROOF WITH WITH LOW PITCH ROOF ABOVE STAIRS AND ENSUITE D ADJUST ALFRESCO; 29/11/2018 COURTYARD WINDOW HEAD HEIGHT AT 1800; REMOVE DOORS TO ENSUITE AND ADD OPENING: HALF HEIGHT WALL TO STUDY. E CHANGE FF CEILING HEIGHT: 06/12/2018

Owner(s) signature Builders signature Date

General notes

specifications.

(Sydney North).

18/12/2018

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All work to be carried out in accordance with

G.J. Gardner. HOMES

# **SYDNEY NORTH**

Unit 2, 28 - 30 Orchard Rd, Brookvale Sydney, NSW, 2100 Phone 9939 3339 Fax 9939 4442 www.gjgardner.com.au

Drafted By

SUITE 302 5 CELEBRATION DRIVE BELLA VISTA NSW 2153 PHONE: (02) 8883 4344 EMAIL: kjrdrafting@kjr.net.au

DOUBLE STOREY DWELLING

Project address

15 MONASH PARADE DEE WHY NSW

Client

MARTIN

Stage DA

Drawing title

**EXISTING SURVEY PLAN** 

02/07/2019 Drawn LV - KJR Date Sheet Size A3 Scale 1:200

230238 - GJGN077 Job No


True North

Rev

G

Drawing No

GJG-A02

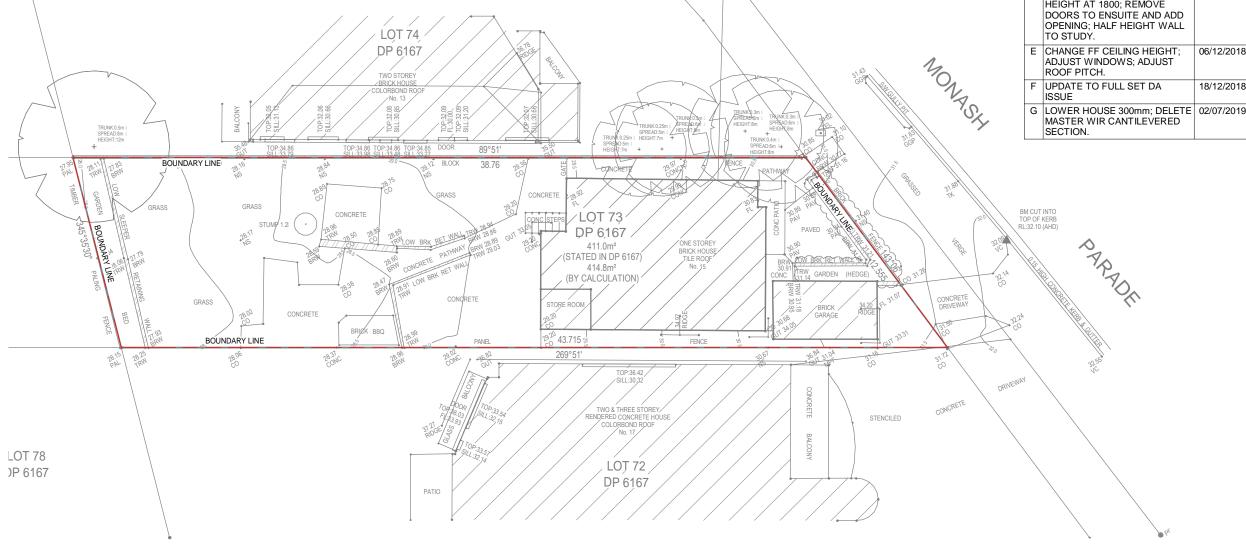

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× CAUTION ×

**EXISTING SURVEY** 

THE INFORMATION SHOWN ON THIS PLAN MAY BE INSUFFICIENT FOR SOME TYPES OF DETAILED DESIGN. OSUM SURVEYING P/L SHOULD BE CONSULTED AS TO THE SUITABILITY OF THE INFORMATION SHOWN HEREIN PRIOR TO THE COMMENCEMENT OF ANY DESIGN WORKS



OSUM SURVEYING PTY LTD ABN 34 606 994 138

> P.O. BOX 126 **OATLEY NSW 2223**

email: info@osumcorporation.com mo: 0400 512 715 ph: (02) 8283 7016

0 1m 3m 5m

SCALE BAR 1:200

# SPECIFICATION:


The specification overrides drawings


#### STRUCTURAL DESIGN:


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0 1m 2m 3m 4m 5m

SCALE BAR 1:100

DRAWING REVISION SCHEDULE			
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Α	FIRST ISSUE	25/10/2018	
В	ADJUST SETBACK; MAKE HOUSE WIDE; ADJUST FRIDGE SPACE; ADD LANDING TO LAUNDRY STAIRS; ADD AC UNIT; CHANGES TO BUTTLERS WINDOW; MAKE ALFRESCO WIDER; ADJUST DINING WINDOWS; MOVE WATER TANK; AJUST BALCONY DOOR; ADD DOOR TO BED 3; ADD SHELVES TO WIR; REDESIGN ENSUITE.	07/11/2018	
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G	LOWER HOUSE 300mm; DELETE MASTER WIR CANTILEVERED SECTION.	02/07/2019	
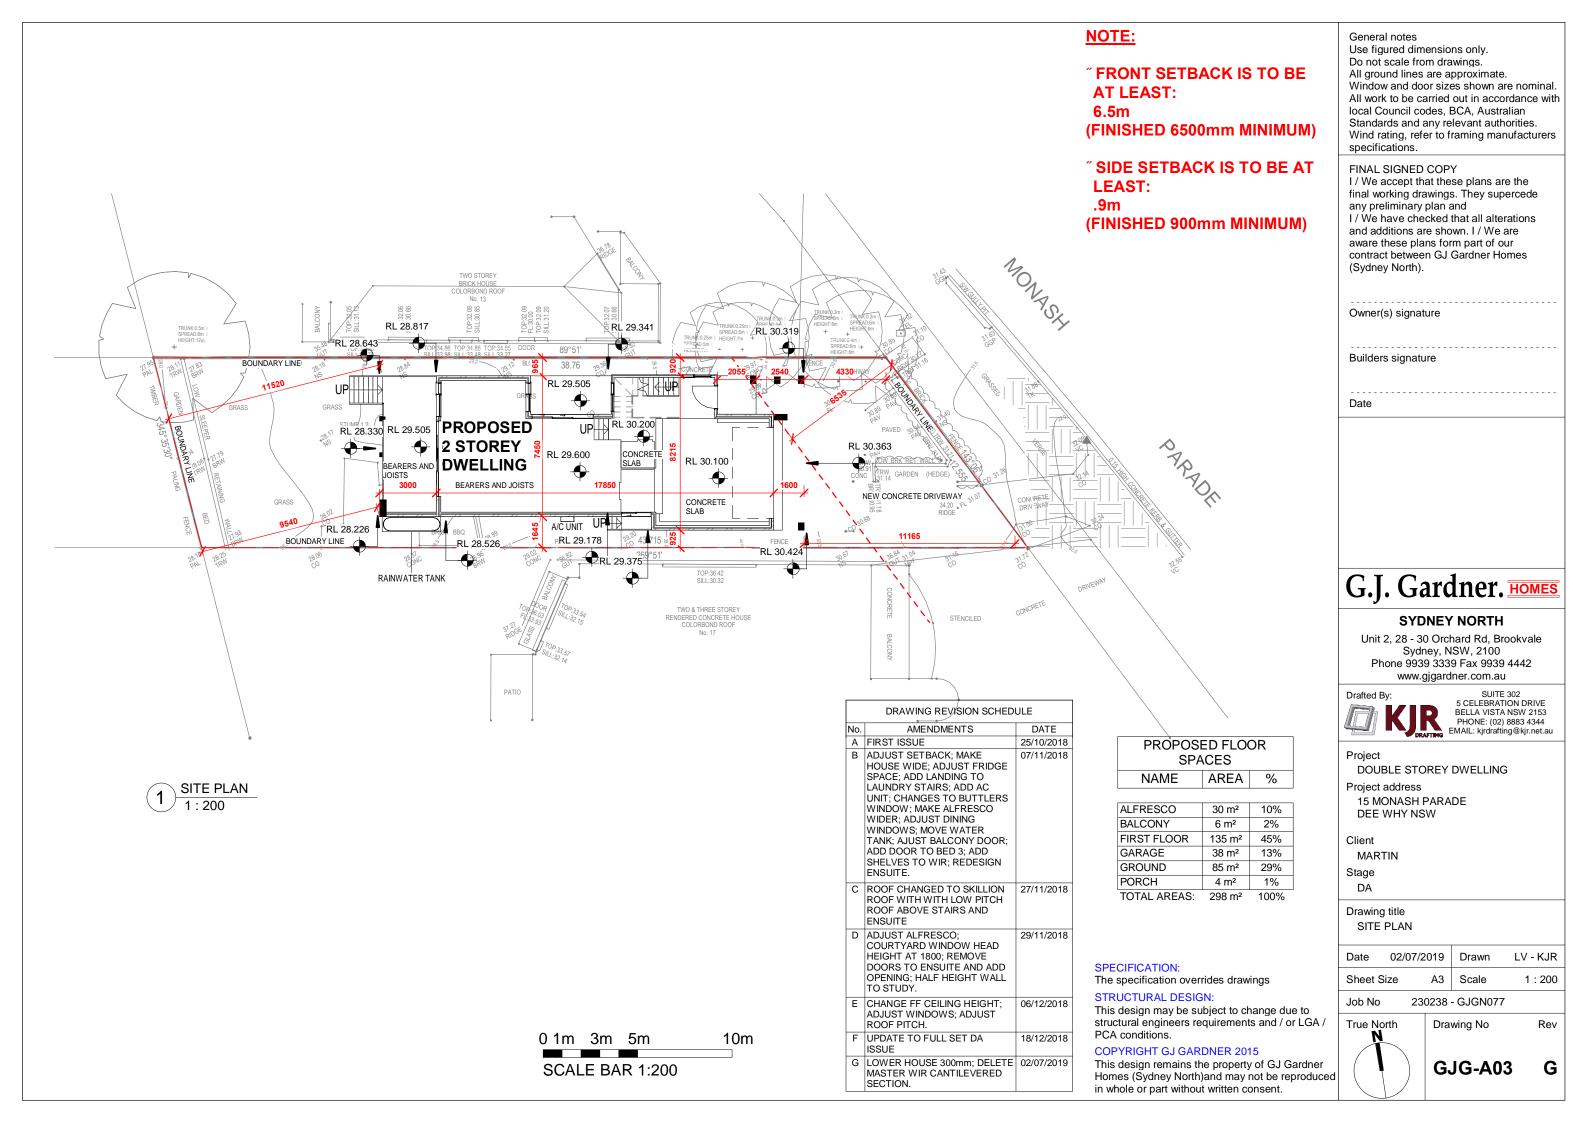
# WINDOW SCHEDULE

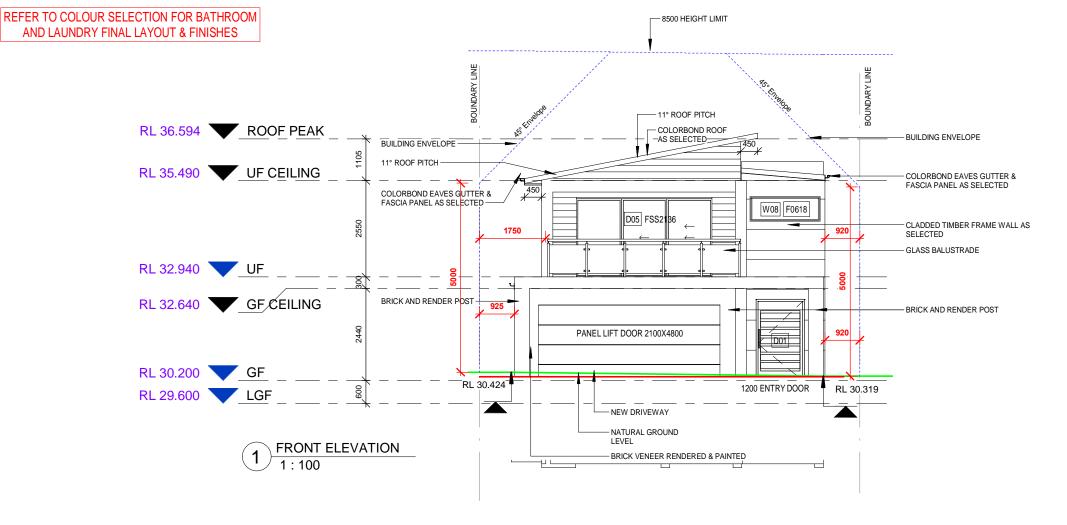Code	Width	Height
	1500	•
W01	1500	2100
W02	1500	1800
W03	1500	2400
W04	1180	2400
W05	2400	700
W06	1200	700
W07	1810	600
W08	1800	600
W09	1810	600
W10	1852	600
W11	1822	600
W12	3610	860
W13	610	860
W14	600	2100
W15	2400	2100
W16	1827	1800
W17	2410	860
W18	1570	860
W19	2410	860
W20	2410	860
<b>~</b> 1		

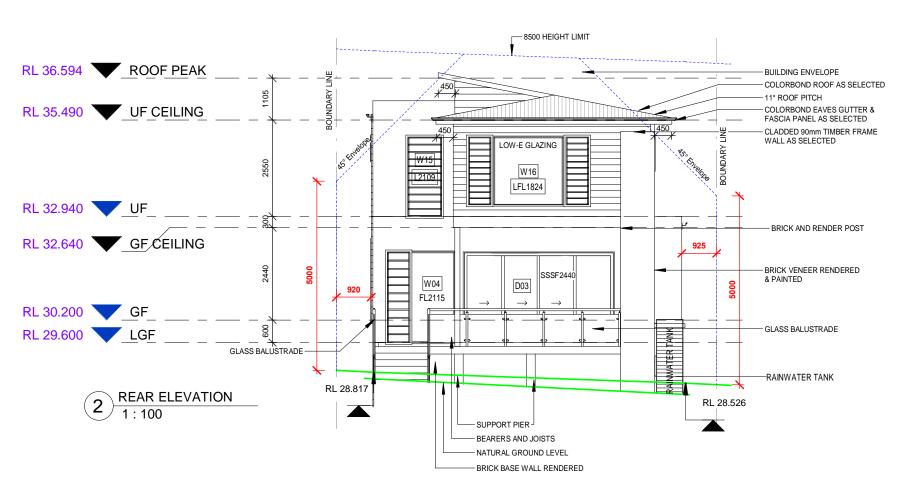Grand total: 20

#### DOOR SCHEDULE Code Width Height D01 1200 2100 D02 3228 2400 D03 4000 2400 D04 1570 2100 D05 3588 2100

# Grand total: 5 SPECIFICATION:

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STRUCTURAL DESIGN:

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Owner(s) signature

Builders signature

Date

G.J. Gardner. HOMES

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SUITE 302 5 CELEBRATION DRIVE BELLA VISTA NSW 2153 PHONE: (02) 8883 4344 EMAIL: kjrdrafting@kjr.net.au

roject

DOUBLE STOREY DWELLING

Project address

15 MONASH PARADE DEE WHY NSW

Client

MARTIN

Stage DA

Drawing title ELEVATIONS

 Date
 02/07/2019
 Drawn
 LV - KJR


 Sheet Size
 A3
 Scale
 1 : 100


Job No 230238 - GJGN077

True North Drawing No

Ü

GJG-A07

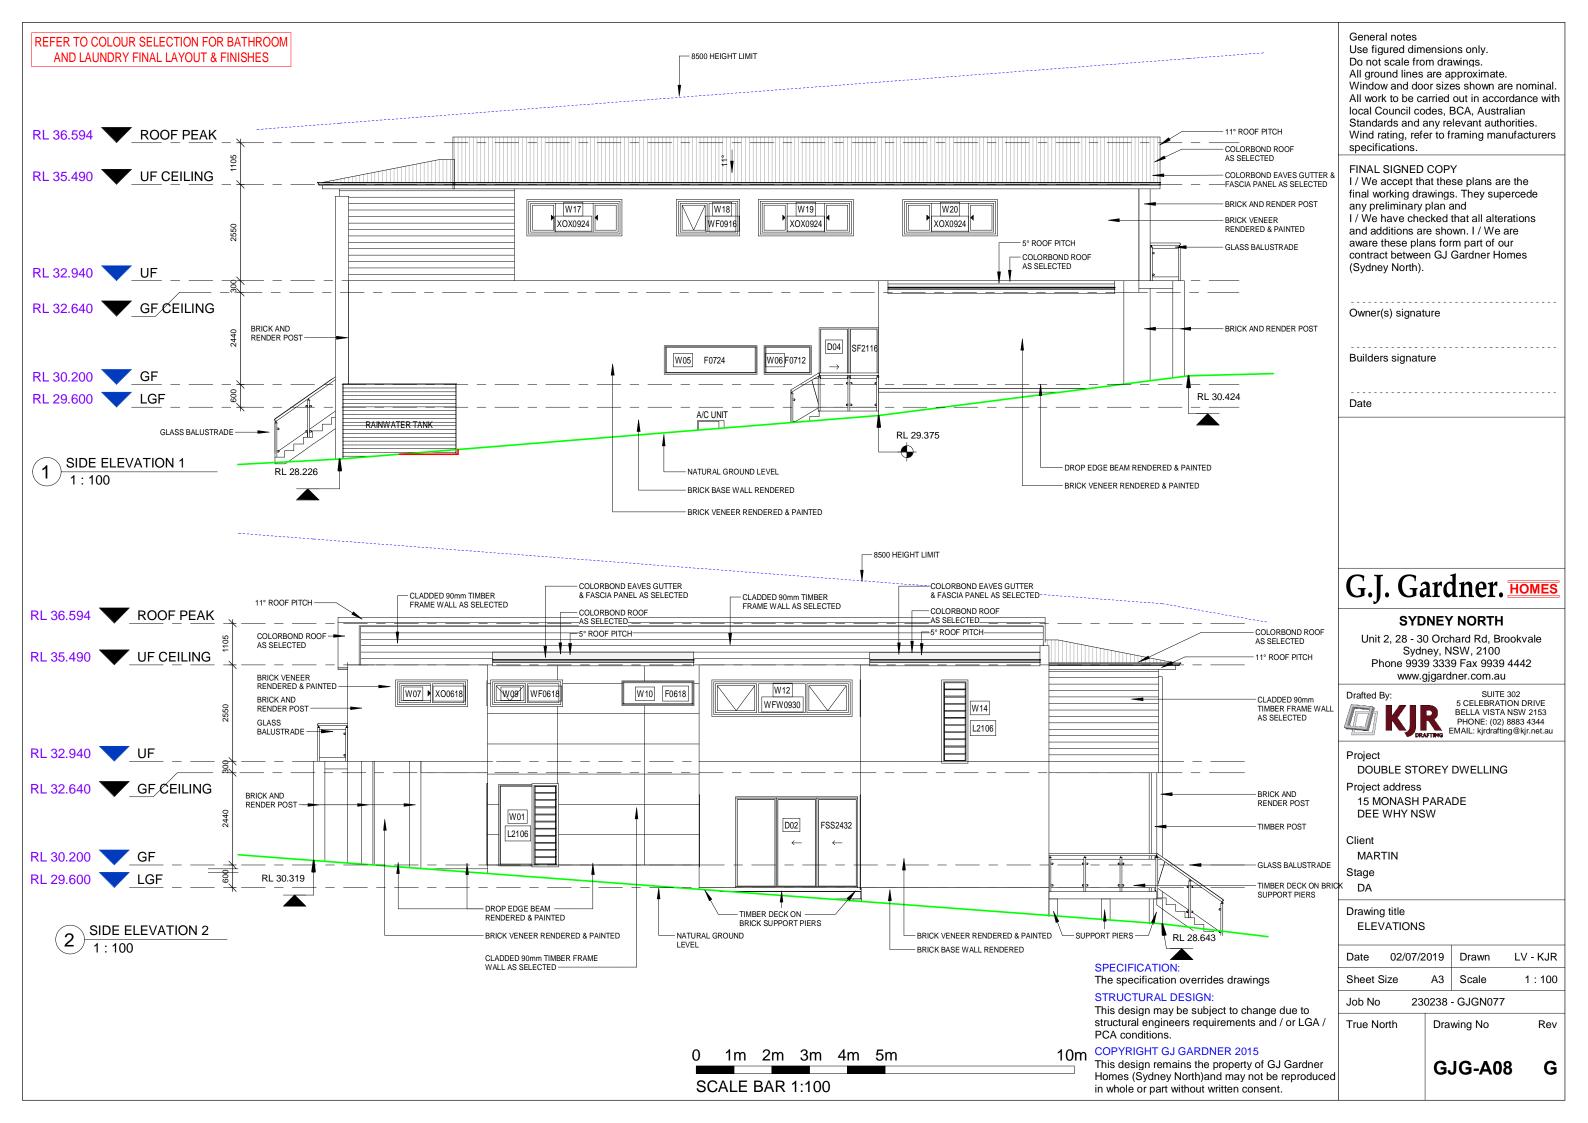

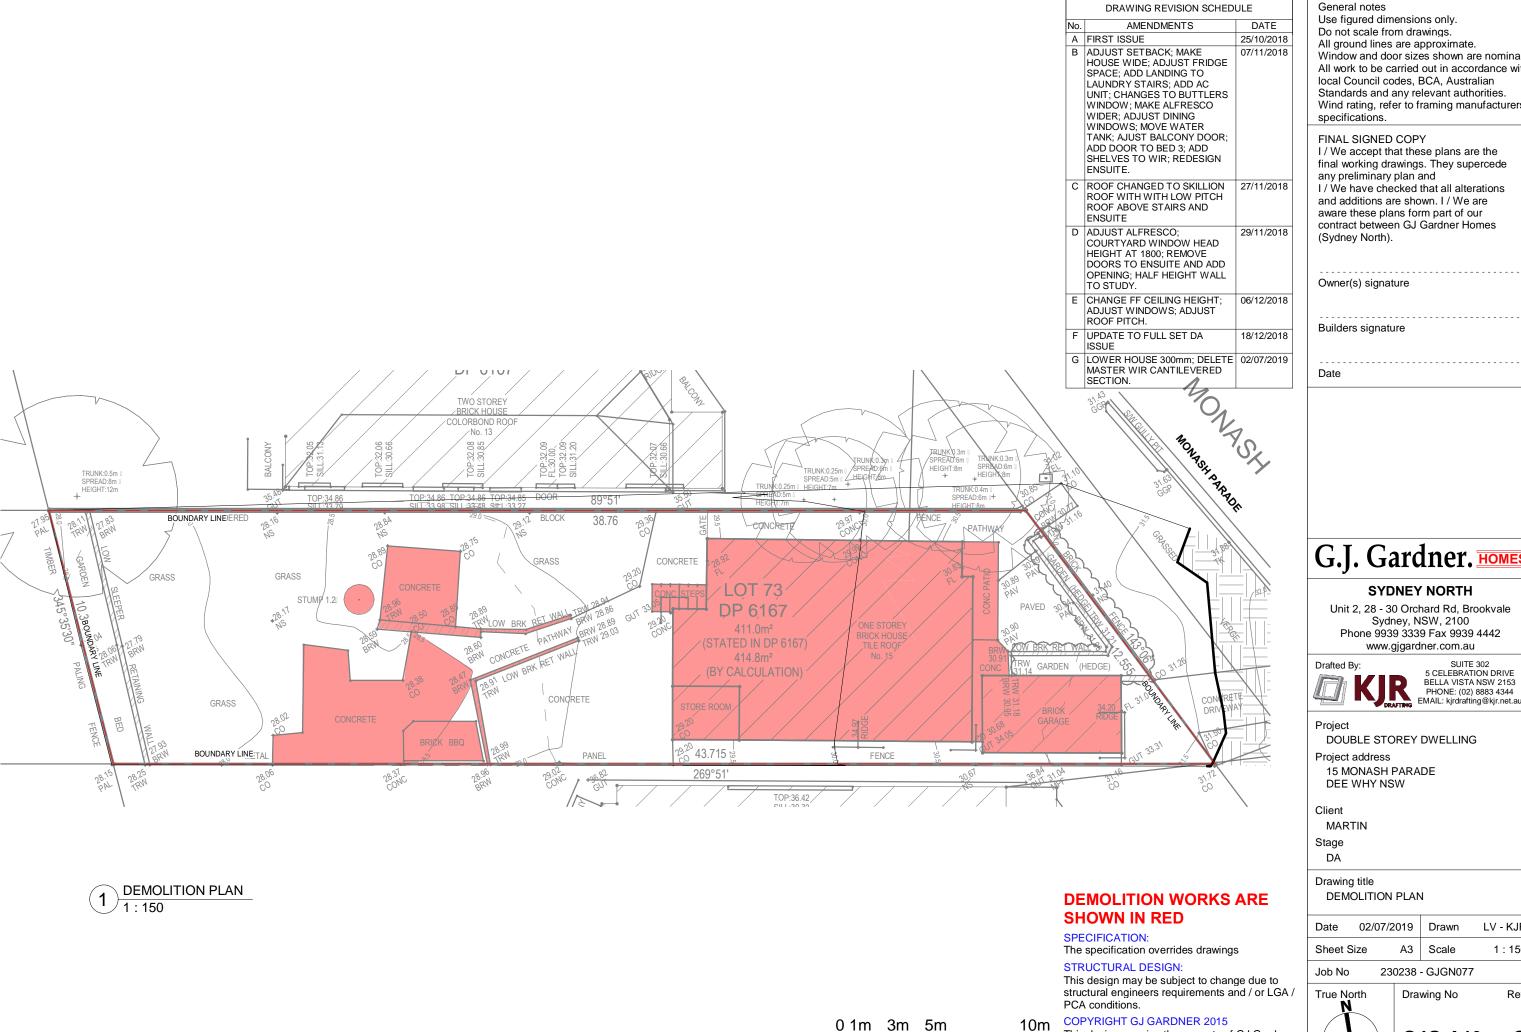

SCALE BAR 1:200

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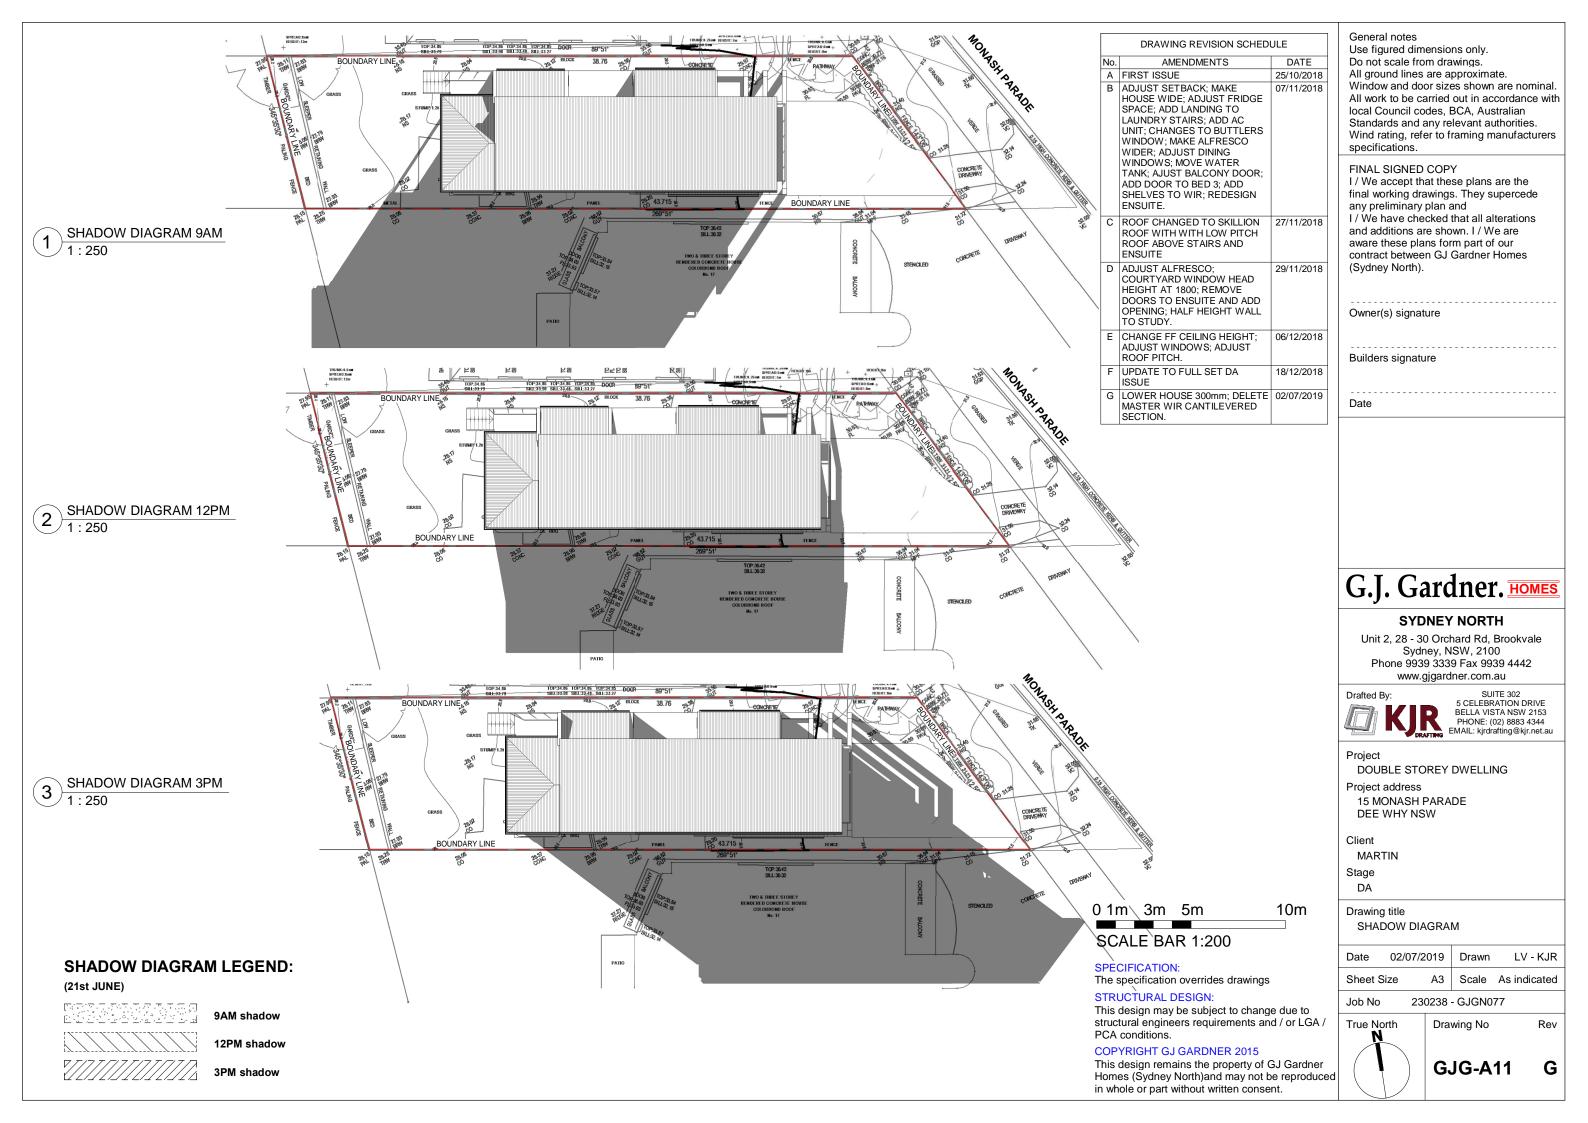
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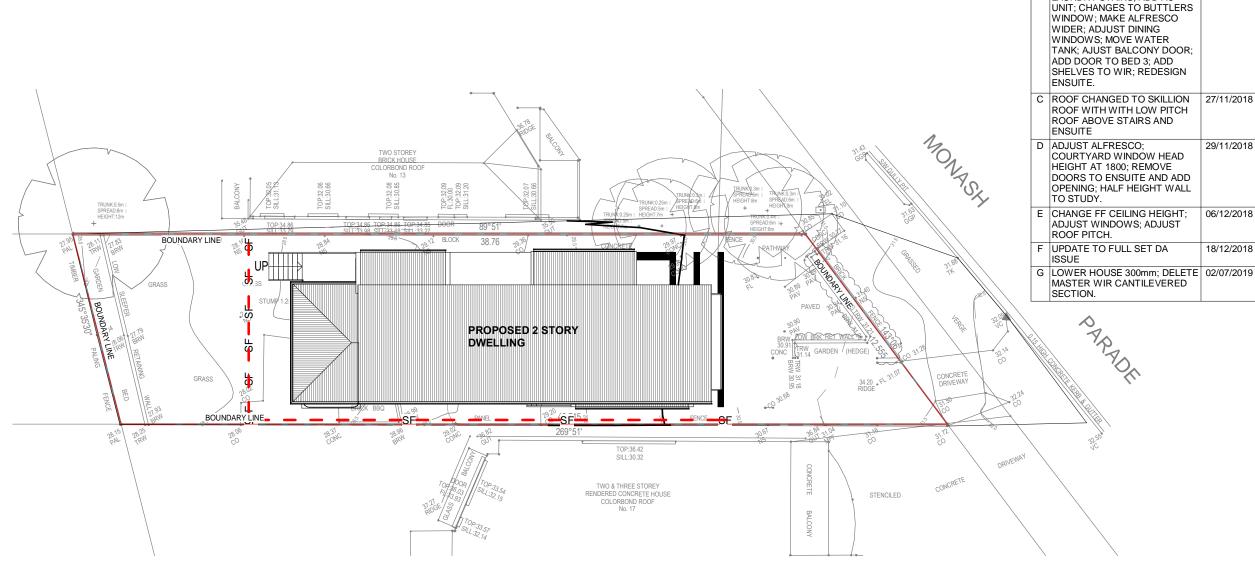
Date	02/0	7/2019	Drawn	LV - KJR
Sheet	Size	А3	Scale	1 : 150

GJG-A10 G

Rev

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WIRE OR STEEL MESH DISTURBED AREA

**EROISION & SEDMIENT** 

1:200

GEOTEXTILE FILTER TIMBER POSTS DRIVEN DETAIL OF OVERLAR 0.3m INTO GROUND

UNDISTURBED AREA

**SEDIMENT FENCE DETAILS** 

# **SEDIMENT CONTROL NOTES:**

- ALL EROSION AND SEDIMENTATION CONTROL MEASURES, INCLUDING REVEGETATION AND STORAGE OF SOIL & TOP SOIL SHALL BE IMPLEMENTED TO THE STANDARDS OF THE SOIL CONSERVATION OF NSW.
- ALL THE DRAINAGE WORKS SHALL BE CONSTRUCTED AND STABILISED AS EARLY AS POSSIBLE DURING DEVELOPMENT.
- SEDIMENT TRAPS SHALL BE CONSTRUCTED AROUND ALL INLET PITS, CONSISTING OF 300mm WIDE x 300mm
- ALL SEDIMENT BASINS AND TRAPS SHALL BE CLEANED WHEN THE STRUCTURES ARE A 60% FULL OF SOIL MATERIALS. INCLUDING THE MAINTENANCE PERIOD.
- TOPSOIL FROM ALL AREAS THAT WILL BE DISTURBED TO STRIPPED AND STOCKPILED.
- SOIL AND TOPSOIL STOCKPILES SHALL BE LOCATED AWAY FROM DRAINAGE LINES AREA AREAS WHERE WATER MAY CONCENTRATE.
- STOCKPILE TOPSOIL SEPARATELY FROM SUBSOIL
- STRIPPING OF GRASS AND VEGETATION ETC. FROM SITE SHALL BE KEPT TO A MINIMUM.
- FILTER SHALL BE CONSTRUCTED BY STRECTCHING A FILTER FABRIC (PROPEX OR APPROVED EQUIVALENT BETWEEN POST AT 3m CENTRES. FABRIC SHALL BE BURIED 150mm ALONG ITS LOWER EDGE.
- ALL DISTURBED AREAS SHALL BE REVEGETATED AS SOON AS THE RELEVANT WORKS ARE COMPLETED.

ALL SEDIMENT CONTROL STRUCTURES TO BE INSPECTED AFTER EACH RAINFALL EVENT FOR STRUCTURAL DAMAGE AND ALL TRAPPED SEDIMENT TO BE REMOVED TO A NOMINATED SOIL STOCKPILE SITE.

0 1m 3m 5m 10m

SCALE BAR 1:200

# **BOUNDARY NOTES:**

- BOUNDARY INFORMATION SUPPLIED BY **OWNER**
- CONFIRM ALL BOUNDARY INFORMATION PRIOR TO COMMENCEMENT OF WORK.

#### **SETOUT NOTES:**

- BOUNDARY DIMENSIONS AND LOCATION OF DWELLING TO BE CONFIRMED AND SETOUT BY SURVEYOR PRIOR TO COMMENCEMENT OF WORK. - BUILDER TO BE PRESENT TO CONFIRM PREFERENCE TO LOCATION.

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General notes

DATE

25/10/2018

07/11/2018

DRAWING REVISION SCHEDULE

AMENDMENTS

HOUSE WIDE; ADJUST FRIDGE

SPACE; ADD LANDING TO

LAUNDRY STAIRS; ADD AC

B ADJUST SETBACK; MAKE

A FIRST ISSUE

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DOUBLE STOREY DWELLING

Project address

15 MONASH PARADE DEE WHY NSW

Client

MARTIN

Stage DA

Drawing title

**EROSION & SEDIMENT PLAN** 


02/07/2019 LV - KJR Date Drawn Sheet Size Scale A3 1:200

230238 - GJGN077 Job No



Drawing No

GJG-A12

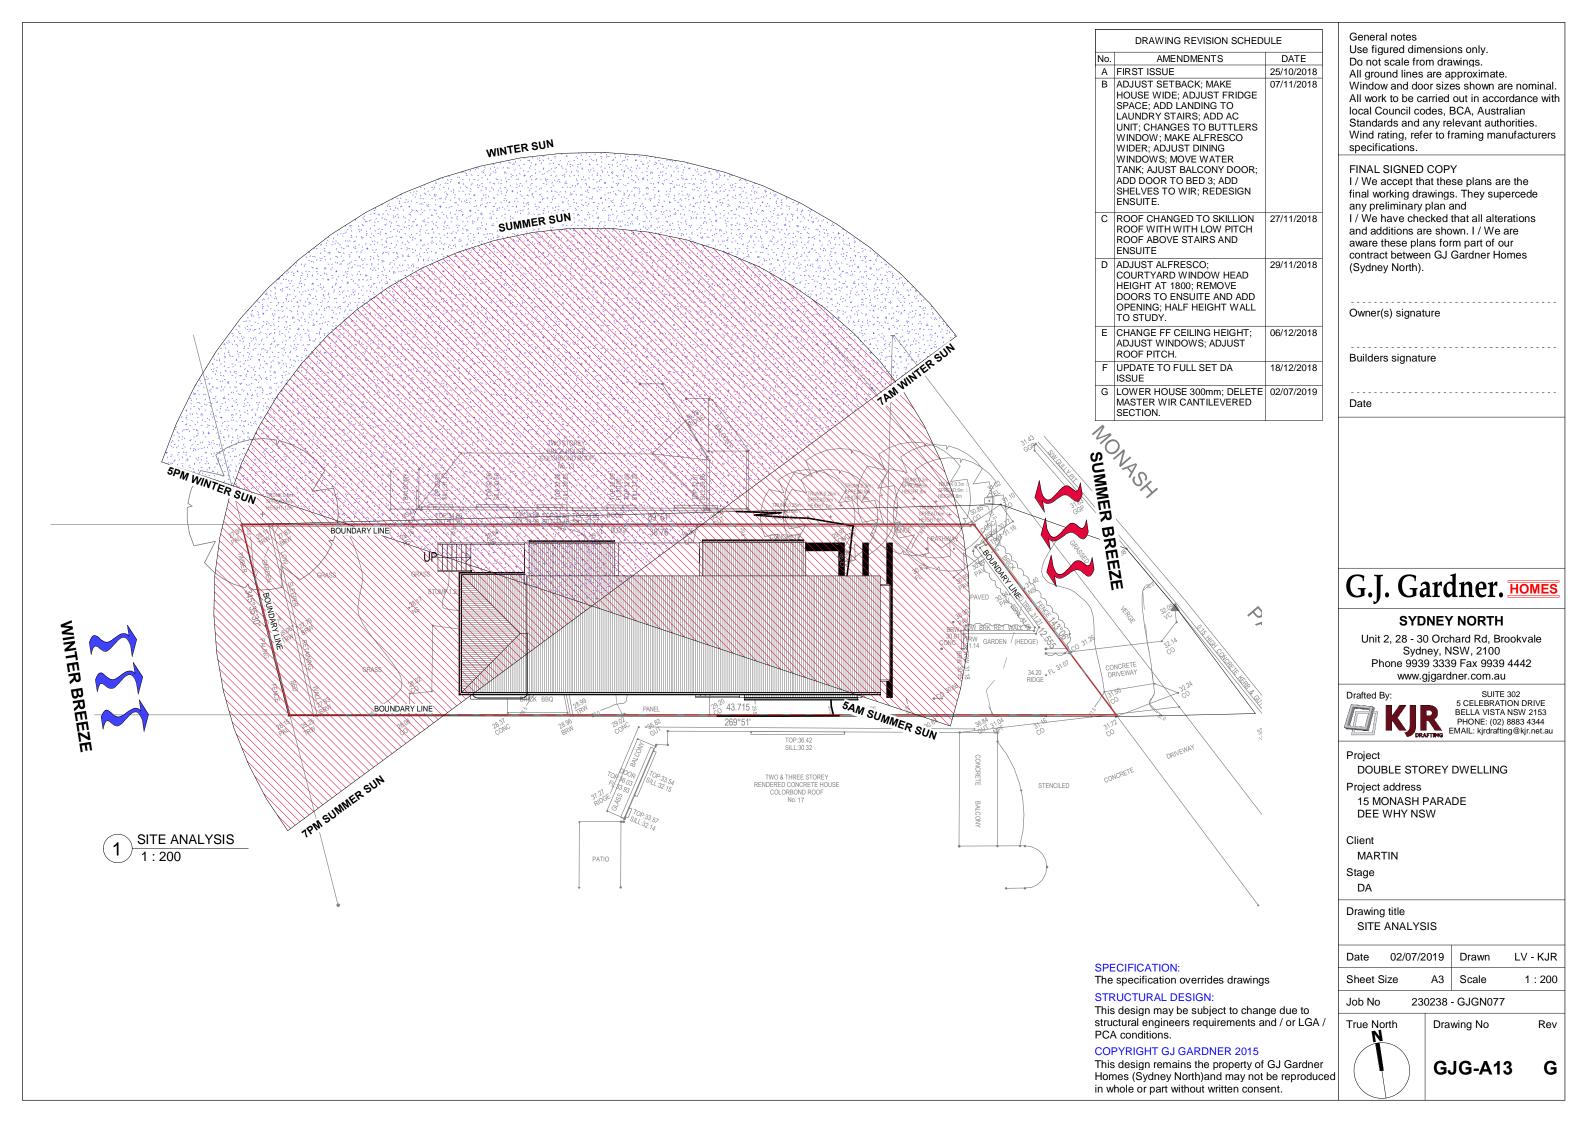

# WASTE MANAGEMENT PLAN FOR PROPOSED 2 STOREY DWELLING AT: 15 MONASH PARADE, DEE WHY

		DESTINATION	•	
		Reuse & Recycl	Reuse & Recycling	
Type of materials	Estimated volume (m3)	On-Site Specify proposed reuse or on-site recycling method	Offsite Specify contractor and recycling outlet	Specify contractor or landfill site
Green waste	2	Chip and compost for landscaping and new gardens	-	Nil to landfill
Bricks	Nil			Nil to landfill
Concrete	20		Waste Management centre for recycling	Nil to landfill
Timber	10	Used for formwork and studwork, site shed or temporary fence	Long lengths of good quality timber to Timber Recycling Company. Lengths less than 1 meter to Waste Management centre for recycling	Nil to landfill
Plasterboard	10		Waste Management centre	Taken to landfi
Roof tiles	8		Good tiles to Waste Management centre for recycling; sell to second hand building supplies	Nil to landfill
Metals	2		Waste Management centre for recycling	Nil to landfill
Asbestos	5		Cart to licensed asbestos tip	Taken to landfi
DRAW	ING REVISION S	CHEDULE		
	MENDMENTS	DATE	1	1
A FIRST ISSU	JE ETBACK; MAKE	25/10/2018 07/11/2018		

HOUSE WIDE; ADJUST FRIDGE SPACE; ADD LANDING TO

UNIT; CHANGES TO BUTTLERS WINDOW; MAKE ALFRESCO

TANK; AJUST BALCONY DOOR;

C ROOF CHANGED TO SKILLION 27/11/2018

G LOWER HOUSE 300mm; DELETE 02/07/2019

29/11/2018

06/12/2018

18/12/2018

ADD DOOR TO BED 3; ADD SHELVES TO WIR; REDESIGN

ROOF WITH WITH LOW PITCH

COURTYARD WINDOW HEAD

DOORS TO ENSUITE AND ADD

OPENING; HALF HEIGHT WALL TO STUDY.

MASTER WIR CANTILEVERED

HEIGHT AT 1800; REMOVE

E CHANGE FF CEILING HEIGHT; ADJUST WINDOWS; ADJUST

F UPDATE TO FULL SET DA

ROOF ABOVE STAIRS AND

ENSUITE.

ENSUITE

D ADJUST ALFRESCO:

ROOF PITCH.

ISSUE

LAUNDRY STAIRS; ADD AC

WIDER; ADJUST DINING WINDOWS; MOVE WATER

MATERIAL	S ON-SITE	DESTINATION		
			Reuse & Recycling	
Type of materials	Estimated volume (m3)	On-Site Specify proposed reuse or on-site recycling method	Offsite Specify contractor and recycling outlet	Specify contractor or landfill site
Excavation Material	5	Re-use for backfill under slab. Remove top soil and stockpile for use in landscaping	-	
Green waste	Nil			
Bricks	Nil			
Concrete	2		Excess concrete returned to supplier	Nil to landfill
Timber	2		Excess timber returned to supplier	Nil to landfill
Plasterboard	0.5		Excess plasterboard returned to supplier	Nil to landfill
Roof colorbond	0.5		Excess colorbond roof returned to supplier	Nil to landfill
Metals	0.1		Waste Management centre for recycling	Nil to landfill

USE OF PREMISES				
Type of Waste to be Generated	Expected volume per week (m3)	On-Site Specify proposed reuse or on-site recycling method	Destination	
Food, general domestic waste	0.4	Bins located on site	Disposal via council rubbish removal	
Paper, Cardboard	0.1	Bins located on site	Disposal via council recycling collection	
Glass, Bottles	0.1	Bins located on site	Disposal via council recycling collection	

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MARTIN

True North

Stage DA

Drawing title
WASTE MANAGEMENT

 Date
 02/07/2019
 Drawn
 LV - KJR

 Sheet Size
 A3
 Scale
 1 : 1

Job No 230238 - GJGN077

200200 - 00010

G

GJG-A14

Drawing No

# **BASIX** Certificate

Building Sustainability Index www.basix.nsw.gov.au

# Single Dwelling

Certificate number: 985999S

This certificate confirms that the proposed development will meet the NSW government's requirements for sustainability, if it is built in accordance with the commitments set out below. Terms used in this certificate, or in the commitments, have the meaning given by the document entitled "BASIX Definitions" dated 08/10/2017 published by the Department. This document is available at www.basix.nsw.gov.au

Secretary
Date of issue: Monday, 17 December 2018
To be valid, this certificate must be lodged within 3 months of the date of issue.

Project name	n.GJGN077_15 Mc	nash pde Dee Why	
Street address	15 Monash Parade	15 Monash Parade Dee Why 2099	
Local Government Area	Northern Beaches	Council	
Plan type and plan number	deposited 6167		
Lot no.	73		
Section no.	ie.		
Project type	separate dwelling house		
No. of bedrooms	4		
Project score			
Water	<b>✓</b> 43	Target 40	
Thermal Comfort	✓ Pass	Target Pass	
Energy	<b>✓</b> 52	Target 50	

Project summary		
Project name	n.GJGN077_15 Monash pde Dee Why	
Street address	15 Monash Parade Dee Why 2099	
Local Government Area	Northern Beaches Council	
Plan type and plan number	deposited 6167	
Lot no.	73	
Section no.		
Project type	separate dwelling house	
No. of bedrooms	4	
Project score		
Water	<b>✓</b> 43	Target 40
Thermal Comfort	✓ Pass	Target Pass

Project address		Assessor details and thermal	loads	
Project name	n.GJGN077_15 Monash pde Dee Why	Assessor number	n/a	
Street address	15 Monash Parade Dee Why 2099	Certificate number	n/a	
Local Government Area	Northern Beaches Council	Climate zone	n/a	
Plan type and plan number	Deposited Plan 6167	Area adjusted cooling load (MJ/m².year)	n/a	
Lot no.	73	Area adjusted heating load (MJ/m².year)	n/a	
Section no.	-	Project score		
Project type		Water	<b>✓</b> 43	Target 40
Project type	separate dwelling house		V 10	Targot 40
No. of bedrooms	4	Thermal Comfort	✓ Pass	Target Pass
Site details		Energy	<b>✓</b> 52	Target 50
Site area (m²)	411		W 102	rangoroo
Roof area (m²)	155			
Conditioned floor area (m2)	177.0	1		
Unconditioned floor area (m2)	18.0			

Water Commitments	Show on DA plans	Show on CC/CDC plans & specs	Certifier check
Fixtures			
The applicant must install showerheads with a minimum rating of 3 star (> 4.5 but <= 6 L/min) in all showers in the development.		•	~
The applicant must install a tollet flushing system with a minimum rating of 3 star in each tollet in the development.		~	V
The applicant must install taps with a minimum rating of 3 star in the kitchen in the development.		~	
The applicant must install basin taps with a minimum rating of 3 star in each bathroom in the development.		~	
Alternative water			
Rainwater tank			
The applicant must install a rainwater tank of at least 1500 litres on the site. This rainwater tank must meet, and be installed in accordance with, the requirements of all applicable regulatory authorities.	~	~	~
The applicant must configure the rainwater tank to collect rain runoff from at least 155 square metres of the roof area of the development (excluding the area of the roof which drains to any stormwater tank or private dam).		~	V
The applicant must connect the rainwater tank to:			
all toilets in the development		<b>✓</b>	V
the cold water tap that supplies each clothes washer in the development.		~	~

Thermal Comfort Commitments	Show on DA plans	Show on CC/CDC plans & specs	Certifie check
General features			
The dwelling must not have more than 2 storeys.	~	~	~
The conditioned floor area of the dwelling must not exceed 300 square metres.	~	~	~
The dwelling must not contain open mezzanine area exceeding 25 square metres.	~	~	~
The dwelling must not contain third level habitable attic room.	V	V	V
Floor, walls and ceiling/roof			
The applicant must construct the floor(s), walls, and ceiling/roof of the dwelling in accordance with the specifications listed in the table below.	V	-	-

Construction	Additional insulation required (R-Value)	Other specifications
floor - concrete slab on ground, 76 square metres	nil	
floor - above habitable rooms or mezzanine, 65 square metres, framed	nil	
floor - suspended floor above garage, framed	nil	
external wall - brick veneer	2.86 (or 3.40 including construction)	
external wall - framed (weatherboard, fibre cement, metal clad)	3.00 (or 3.40 including construction)	
internal wall shared with garage - plasterboard	nil	
ceiling and roof - flat ceiling / pitched roof	ceiling: 4.5 (up), roof: foil/sarking	unventilated; medium (solar absorptance 0.475-0.70)

Note | • Insulation specified in this Certificate must be installed in accordance with Part 3.12.1.1 of the Building Code of Australia.

Note • In some climate zones, insulation should be installed with due consideration of condensation and associated interaction with adjoining building materials.

Thermal Comfort Commitments	Show on DA plans	Show on CC/CDC plans & specs	Certifie check
Windows, glazed doors and skylights		*	
The applicant must install the windows, glazed doors and shading devices described in the table below, in accordance with the specifications listed in the table. Relevant overshadowing specifications must be satisfied for each window and glazed door.	-	~	-
The dwelling may have 1 skylight (<0.7 square metres) which is not listed in the table.	~	~	V
The following requirements must also be satisfied in relation to each window and glazed door:	~	V	V
For the following glass and frame types, the certifier check can be performed by visual inspection.			J
- Aluminium single clear			
- Aluminium double (air) clear			
- Timber/uPVC/fibreglass single clear			
- Timber/uPVC/fibreglass double (air) clear			
<ul> <li>For other glass or frame types, each window and glazed door must be accompanied with certification showing a U value no greater than that listed and a Solar Heat Gain Coefficient (SHGC) within the range of those listed. Total system U values and SHGC must be calculated in accordance with National Fenestration Rating Council (NFRC) conditions. Frame and glass types shown in the table below are for reference only.</li> </ul>			~
Overshadowing buildings/vegetation must be of the height and distance from the centre and the base of the window and glazed door, as specified in the 'overshadowing' column.			

Window/glazed door no.	Maximum height (mm)	Maximum width (mm)	Туре	Shading Device (Dimension within 10%)	Overshadowing
North facing					
W01	2100	1500	U-value: 6.6, SHGC: 0.441 - 0.539 (aluminium, single, tint)	awning (adjustable) 500 mm, 1000 mm above base of window or glazed door	1-2 m high, <1.5 m away
D02	2400	3200	U-value: 5.2, SHGC: 0.351 - 0.429 (aluminium, double (air), tint)	awning (adjustable) 1500 mm, 1500 mm above base of window or glazed door	not overshadowed
W07	600	1800	U-value: 6.6, SHGC: 0.441 - 0.539 (aluminium, single, tint)	eave 550 mm, 800 mm above head of window or glazed door	not overshadowed

Energy Commitments	Show on DA plans	Show on CC/CDC plans & specs	Certifier
Hot water			
The applicant must install the following hot water system in the development, or a system with a higher energy rating: gas instantaneous with a performance of 4 stars.	~	~	V
Cooling system			
The applicant must install the following cooling system, or a system with a higher energy rating, in at least 1 living area: 3-phase airconditioning; Energy rating: EER 3.0 - 3.5		~	~
The applicant must install the following cooling system, or a system with a higher energy rating, in at least 1 bedroom: 3-phase airconditioning; Energy rating: EER 3.0 - 3.5		~	~
The cooling system must provide for day/night zoning between living areas and bedrooms.		~	~
Heating system			
The applicant must install the following heating system, or a system with a higher energy rating, in at least 1 living area: 3-phase airconditioning; Energy rating: EER 3.0 - 3.5		~	~
The applicant must install the following heating system, or a system with a higher energy rating, in at least 1 bedroom: 3-phase airconditioning; Energy rating: EER 3.0 - 3.5		~	~
The heating system must provide for day/night zoning between living areas and bedrooms.		~	~
Ventilation			
The applicant must install the following exhaust systems in the development:			
At least 1 Bathroom: no mechanical ventilation (ie. natural); Operation control: n/a		~	~
Kitchen: individual fan, not ducted, Operation control: manual switch on/off		~	~
Laundry: natural ventilation only, or no laundry; Operation control: n/a		~	V
Artificial lighting			
The applicant must ensure that the "primary type of artificial lighting" is fluorescent or light emitting diode (LED) lighting in each of the following rooms, and where the word "dedicated" appears, the fittings for those lights must only be capable of accepting fluorescent or light emitting diode (LED) land to the capable of accepting fluorescent or light emitting diode (LED) and the capable of accepting fluorescent or light emitting fluorescent or light emitti			
<ul> <li>at least 4 of the bedrooms / study;</li> </ul>			

**Description of project** 

Total area of garden and lawn (m2)

final) for the development may be issued.

Energy Commitments	Show on DA plans	Show on CC/CDC plans & specs	Certifie check
at least 2 of the living / dining rooms;		~	V
• the kitchen;		-	
all bathrooms/toilets;		V	-
• the laundry;		~	
• all hallways;		V	-
Natural lighting			
The applicant must install a window and/or skylight in the kitchen of the dwelling for natural lighting.	~	~	-
The applicant must install a window and/or skylight in 3 bathroom(s)/toilet(s) in the development for natural lighting.	V	~	-
Other			
The applicant must install a gas cooktop & electric oven in the kitchen of the dwelling.		~	
The applicant must construct each refrigerator space in the development so that it is "well ventilated", as defined in the BASIX definitions.		~	
The applicant must install a fixed outdoor clothes drying line as part of the development.		V	

e applicant must install a fixed outdoor clothes drying line as part of the development.	-		
Legend			
In these commitments, "applicant" means the person carrying out the development.			
Commitments identified with a $\checkmark$ in the "Show on DA plans" column must be shown on the plans accompandevelopment application is to be lodged for the proposed development).	anying the developm	ent application fo	or the proposed development (if a
Commitments identified with a $\checkmark$ in the "Show on CC/CDC plans and specs" column must be shown in the certificate / complying development certificate for the proposed development.	e plans and specifica	tions accompan	ying the application for a construction
Commitments identified with a In the "Cartifier check" column must be cartified by a cartifying authority.	as having been fulfill	ed hefore a fina	occupation certificate/either interim or

# SPECIFICATION:

The specification overrides drawings

#### STRUCTURAL DESIGN:

This design may be subject to change due to structural engineers requirements and / or LGA / PCA conditions.

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	DRAWING REVISION SCHED	ULE	
No.	AMENDMENTS	DATE	
Α	FIRST ISSUE	25/10/2018	
В	ADJUST SETBACK; MAKE HOUSE WIDE; ADJUST FRIDGE SPACE; ADD LANDING TO LAUNDRY STAIRS; ADD AC UNIT; CHANGES TO BUTTLERS WINDOW; MAKE ALFRESCO WIDER; ADJUST DINING WINDOWS; MOVE WATER TANK; AJUST BALCONY DOOR; ADD DOOR TO BED 3; ADD SHELVES TO WIR; REDESIGN ENSUITE.	07/11/2018	
С	ROOF CHANGED TO SKILLION ROOF WITH WITH LOW PITCH ROOF ABOVE STAIRS AND ENSUITE	27/11/2018	
D	ADJUST ALFRESCO; COURTYARD WINDOW HEAD HEIGHT AT 1800; REMOVE DOORS TO ENSUITE AND ADD OPENING; HALF HEIGHT WALL TO STUDY.	29/11/2018	
E	CHANGE FF CEILING HEIGHT; ADJUST WINDOWS; ADJUST ROOF PITCH.	06/12/2018	
F	UPDATE TO FULL SET DA ISSUE	18/12/2018	
G	LOWER HOUSE 300mm; DELETE MASTER WIR CANTILEVERED SECTION.	02/07/2019	

### General notes Use figured dimensions only. Do not scale from drawings. All ground lines are approximate. Window and door sizes shown are nominal. All work to be carried out in accordance with local Council codes, BCA, Australian Standards and any relevant authorities. Wind rating, refer to framing manufacturers specifications. FINAL SIGNED COPY I / We accept that these plans are the final working drawings. They supercede any preliminary plan and I / We have checked that all alterations

aware these plans form part of our contract between GJ Gardner Homes (Sydney North).
Ourpor(a) signature
Owner(s) signature
Builders signature
D-4-
Date

and additions are shown. I / We are

# G.J. Gardner. HOMES

# **SYDNEY NORTH**

Unit 2, 28 - 30 Orchard Rd, Brookvale Sydney, NSW, 2100 Phone 9939 3339 Fax 9939 4442 www.gjgardner.com.au



SUITE 302 5 CELEBRATION DRIVE BELLA VISTA NSW 2153 PHONE: (02) 8883 4344 EMAIL: kjrdrafting@kjr.net.au

DOUBLE STOREY DWELLING

Project address

15 MONASH PARADE DEE WHY NSW

Client

MARTIN

Stage DA

Drawing title

True North

BASIX COMMITMENT

Drawn 02/07/2019 LV - KJR Date Sheet Size A3 Scale


230238 - GJGN077 Job No


Drawing No


Rev

G

GJG-A15

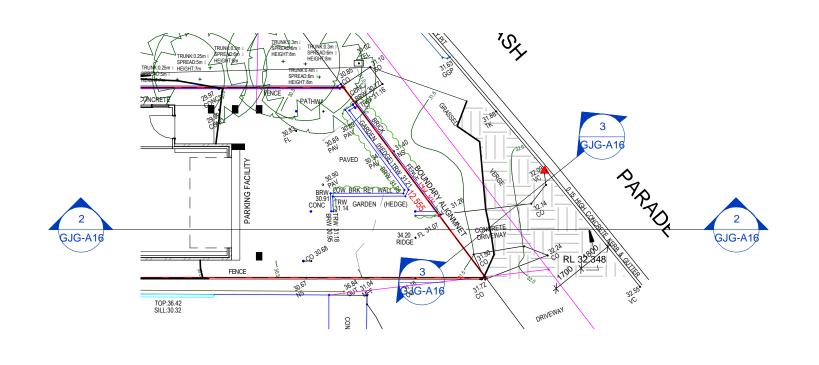

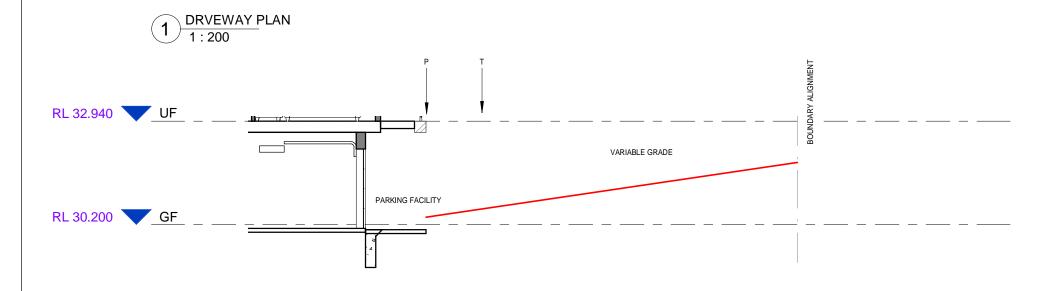

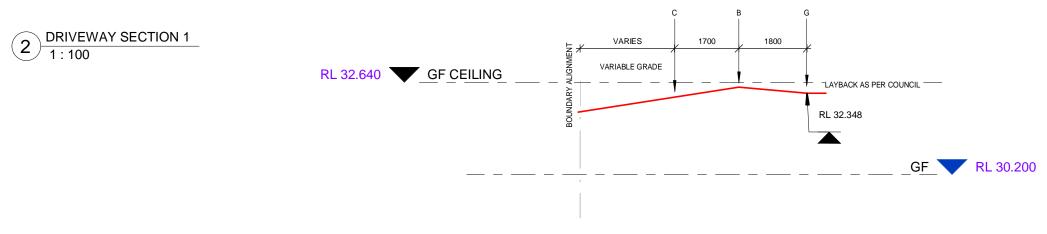

**DRIVEWAY SECTION 2** 1:100

# SPECIFICATION:

The specification overrides drawings

# STRUCTURAL DESIGN:

This design may be subject to change due to structural engineers requirements and / or LGA / PCA conditions.

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# FINAL SIGNED COPY

I / We accept that these plans are the final working drawings. They supercede any preliminary plan and I / We have checked that all alterations and additions are shown. I / We are aware these plans form part of our contract between GJ Gardner Homes (Sydney North).

Owner(s) signature
Builders signature

Date

# G.J. Gardner. HOMES

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DOUBLE STOREY DWELLING

Project address

15 MONASH PARADE DEE WHY NSW

Client

MARTIN

Stage DA

Drawing title

DRIVEWAY DETAIL

Date	02/0	07/2019	Drawn	LV - KJR
Sheet Size		АЗ	Scale	As indicated

230238 - GJGN077 Job No

True North

Drawing No

GJG-A16

Rev