## ALTERATIONS & ADDITIONS @ 4/235 PITTWATER ROAD, MANLY

JANUARY 2025

Drawing List				
Sheet No.	Sheet No. Sheet Name		Rev.	Revision Description (edit)
DA - 000	Cover Page	28/01/2025	С	
EX - 01	Existing Unit 4 Plan	28/01/2025	С	
DA - 101	Site Analysis Plan	28/01/2025	С	
DA - 102	Proposed Site/Roof Plan	28/01/2025	С	
DA - 103	Proposed Site Calculations	28/01/2025	С	
DA - 201	Proposed Unit 4 Plan	28/01/2025	С	
DA - 202	Proposed Unit 4 Loft Plan	28/01/2025	С	
DA - 301	Proposed Long Section	28/01/2025	С	
DA - 302	Proposed Cross Section	28/01/2025	С	
DA - 401	Proposed Eastern Elevation	28/01/2025	С	
DA - 402	Proposed Western Elevation	28/01/2025	С	
DA - 403	Proposed Northern & Southern Elevations	28/01/2025	С	
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Existing Street Elevation



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# BASIX Certificate Building Sustainability Index www.basix.nsw.gov.au

### Alterations and Additions

Certificate number: A1781186

This certificate confirms that the proposed development will meet the NSW government's requirements for sustainability, if it is built in accordance with the commitments set out below. Terms used in this certificate, or in the commitments, have the meaning given by the document entitled "BASIX Definitions" dated 10/09/2020 published by the Department. This document is available at www.basix.nsw.gov.au





	Show or DA Plan
Lighting	
The applicant must ensure a minimum of 40% of new or altered light fixtures are fitted with fluorescent, compact fluorescent, or light- emitting-diode (LED) lamps.	

Construction	Show on DA Plans	Show on CC/CDC Plans & specs	Certifier Check		
Insulation requirements					
The applicant must construct the new or alter listed in the table below, except that a) addit insulation specified is not required for parts of	ional insulation is not required where the ar		~	~	~
Construction	Additional insulation required (R- value)	Other specifications			
floor above existing dwelling or building.					
raked ceiling, pitched/skillion roof: framed	ceiling: R0.74 (up), roof: foil backed blanket (100 mm)	medium (solar absorptance 0.475 - 0.70)			

rramed	blanket (100 mm)		0.70)	
Glazing requirements	5			Show or DA Plan
Skylights				
The applicant must install th	ne skylights in accordance with the spe	cifications listed in the table	e below.	~
The following requirements	must also be satisfied in relation to each	ch skylight:		
Each skylight may either ma listed in the table below.	atch the description, or, have a U-value	and a Solar Heat Gain Co	pefficient (SHGC) no greater than that	
Skylights glazing requiren	nents			
Skylight number	Area of glazing inc. frame (m2)	Shading device	Frame and glass type	
SK1	1	no shading	timber, low-E internal/argon fill/clear external, (or U-value: 2.9, SHGC: 0.456)	
SK2	1	no shading	timber, low-E internal/argon fill/clear external, (or U-value: 2.9, SHGC: 0.456)	
SK3	1	no shading	timber, low-E internal/argon fill/clear external, (or U-value: 2.9, SHGC: 0.456)	

Legend	
In these commitmer	nts, "applicant" means the person carrying out the development.
	ified with a 🎺 in the "Show on DA plans" column must be shown on the plans accompanying the development application for the p cation is to be lodged for the proposed development).
	ified with a 💙 in the *Show on CC/CDC plans & specs* column must be shown in the plans and specifications accompanying the a ing development certificate for the proposed development.
Commitments ident may be issued.	ified with a 💙 in the *Certifier check* column must be certified by a certifying authority as having been fulfilled, before a final occup

	Loft Alterations and Additions	DATE	28/01/2025
	Cover Page	SCALE	AS NOTED
г	Phillipa Hayes	DRAWN	JGW/AC #2406
	4/235 Pittwater Road, Manly	JOB NO.	#2406

	page 1/5			
Project address				
Project name	Cardigan Alterations & Additions			
Street address	235 PITTWATER Road MANLY 2095			
Local Government Area	Northern Beaches Council			
Plan type and number	Strata Plan SP45983			
Lot number	4			
Section number	-			
Project type				
Dwelling type	Dwelling above existing building			
Type of alteration and addition	The estimated development cost for my renovation work is \$50,000 or more.			
N/A	N/A			
Certificate Prepared by (ple	ease complete before submitting to Council or PCA)			
Name / Company Name: Wray and Cutcliffe Architects				
ABN (if applicable):				

5	Show on CC/CDC Plans & specs	Certifier Check
	>	<



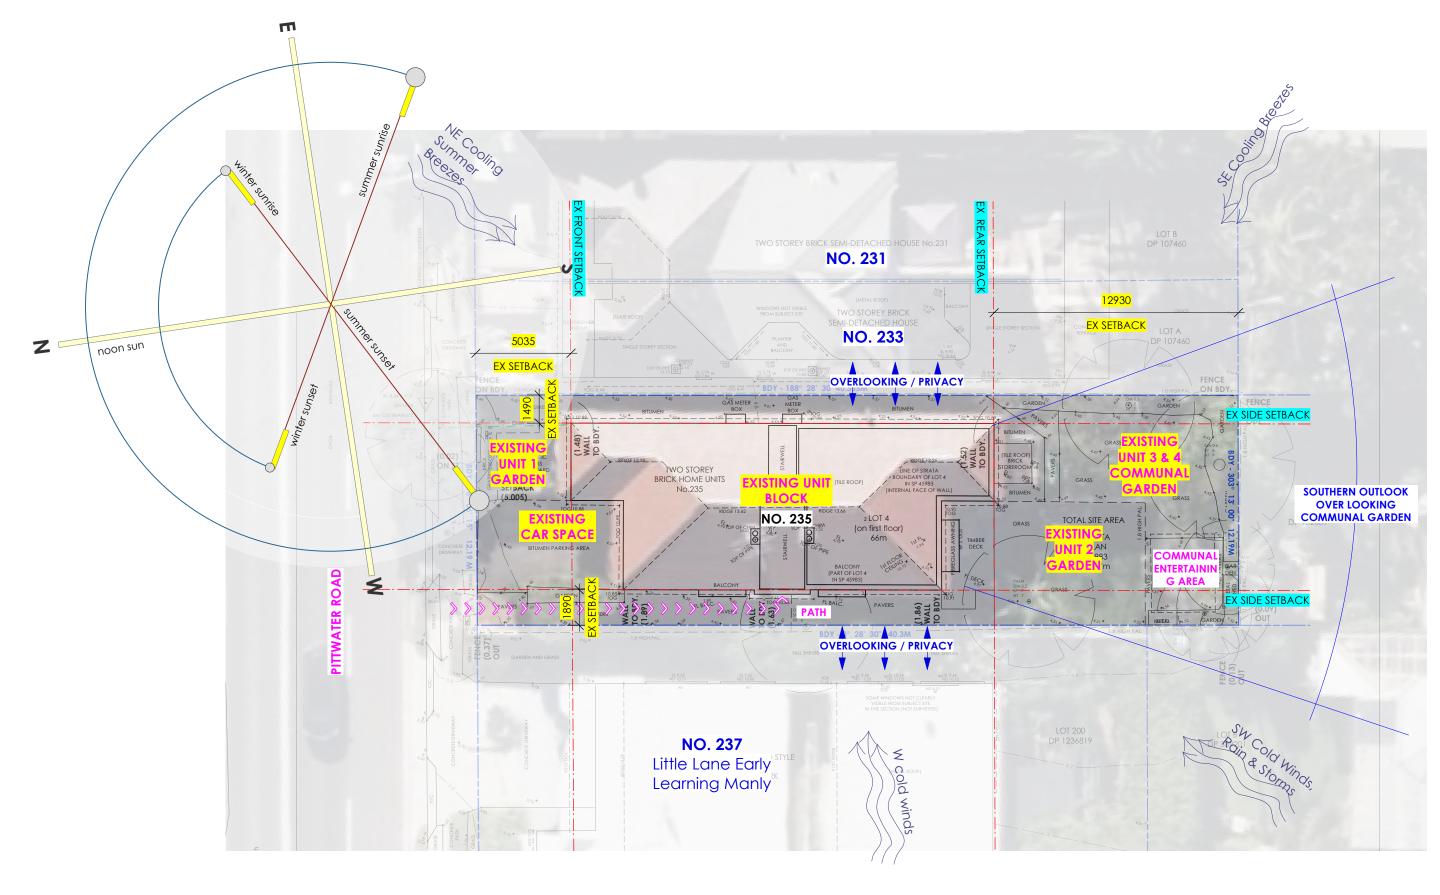


application for a construction

pation certificate for the development



С	Development Application Draft	28/01/2025
В	Design Development	08/11/2024
A	Schematic Initials	07/08/2024
Issue	Description	Date





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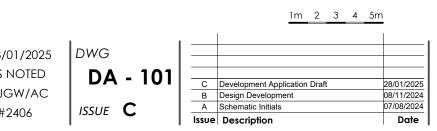
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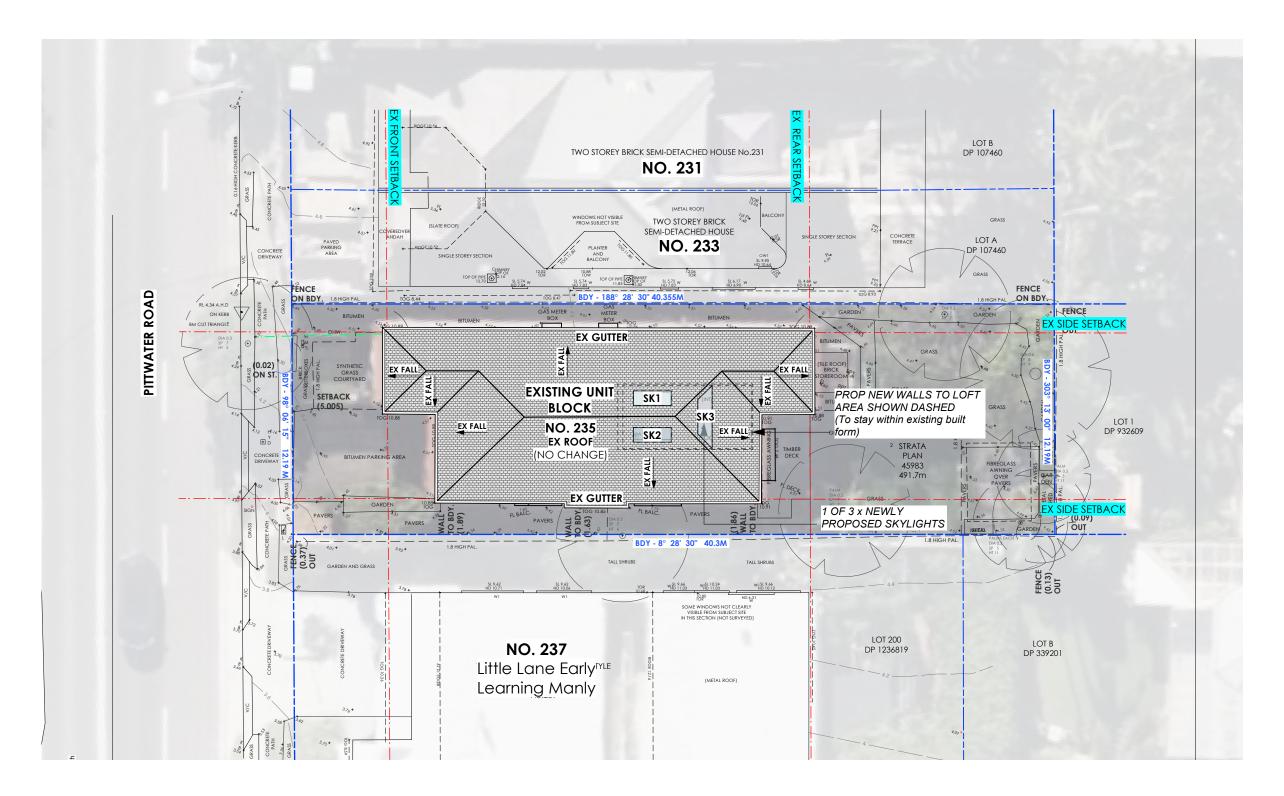
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Loft Alterations and Additions		28/
Site Analysis Plan	SCALE	AS
Phillipa Hayes	DRAWN	JC
4/235 Pittwater Road, Manly	JOB NO.	#2

e: jessica@wacarchitects.com.au • e: alice@wacarchitects.com.au \* Waterproof/ Weatherproofing standards as well as Australian St standards as well as Australian St









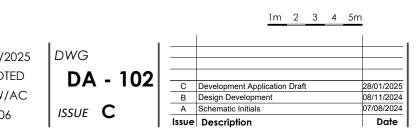
WRAY AND CUTCLIFFE ARCHITECTS e: jessica@wacarchitects.com.au • e: alice@wacarchitects.com.au m: 0421 755 086 m: 0424 561 309 m: 0424 561 309

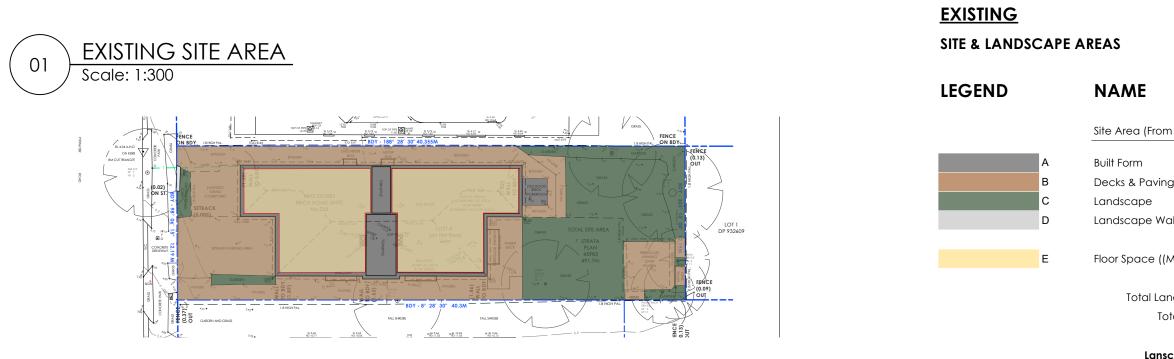
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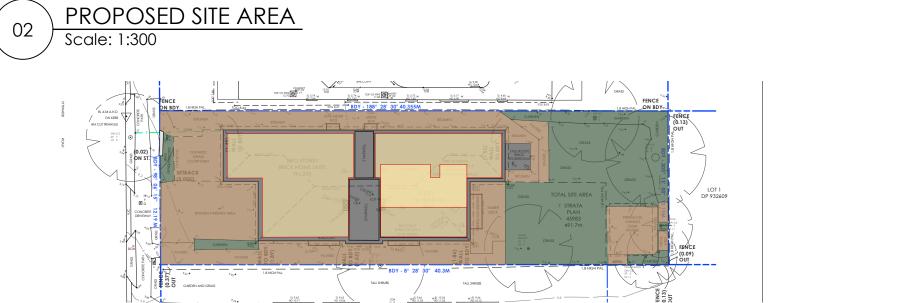
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Loft Alterations and Additions	DATE	28/01/2
Proposed Site/Roof Plan	SCALE	AS NOT
Phillipa Hayes	DRAWN	JGW/
4/235 Pittwater Road, Manly	JOB NO.	#2406







PROPOSED		<u>(no change)</u> E AREAS		
LEGEND		NAME	ļ	AREA (m2):
		Site Area (From Survey)	-	491.70
	А	Built Form	_	176.02
	в	Decks & Paving	-	185.52
	С	Landscape	-	129.79
	D	Landscape Walls	-	0.50
	Е	Floor Space ((Max 0.6:1)/295sqm)	-	292.19
		Total Landscape Area	-	129.79
		Total Area	-	491.82
		Lanscape Area		26.40%

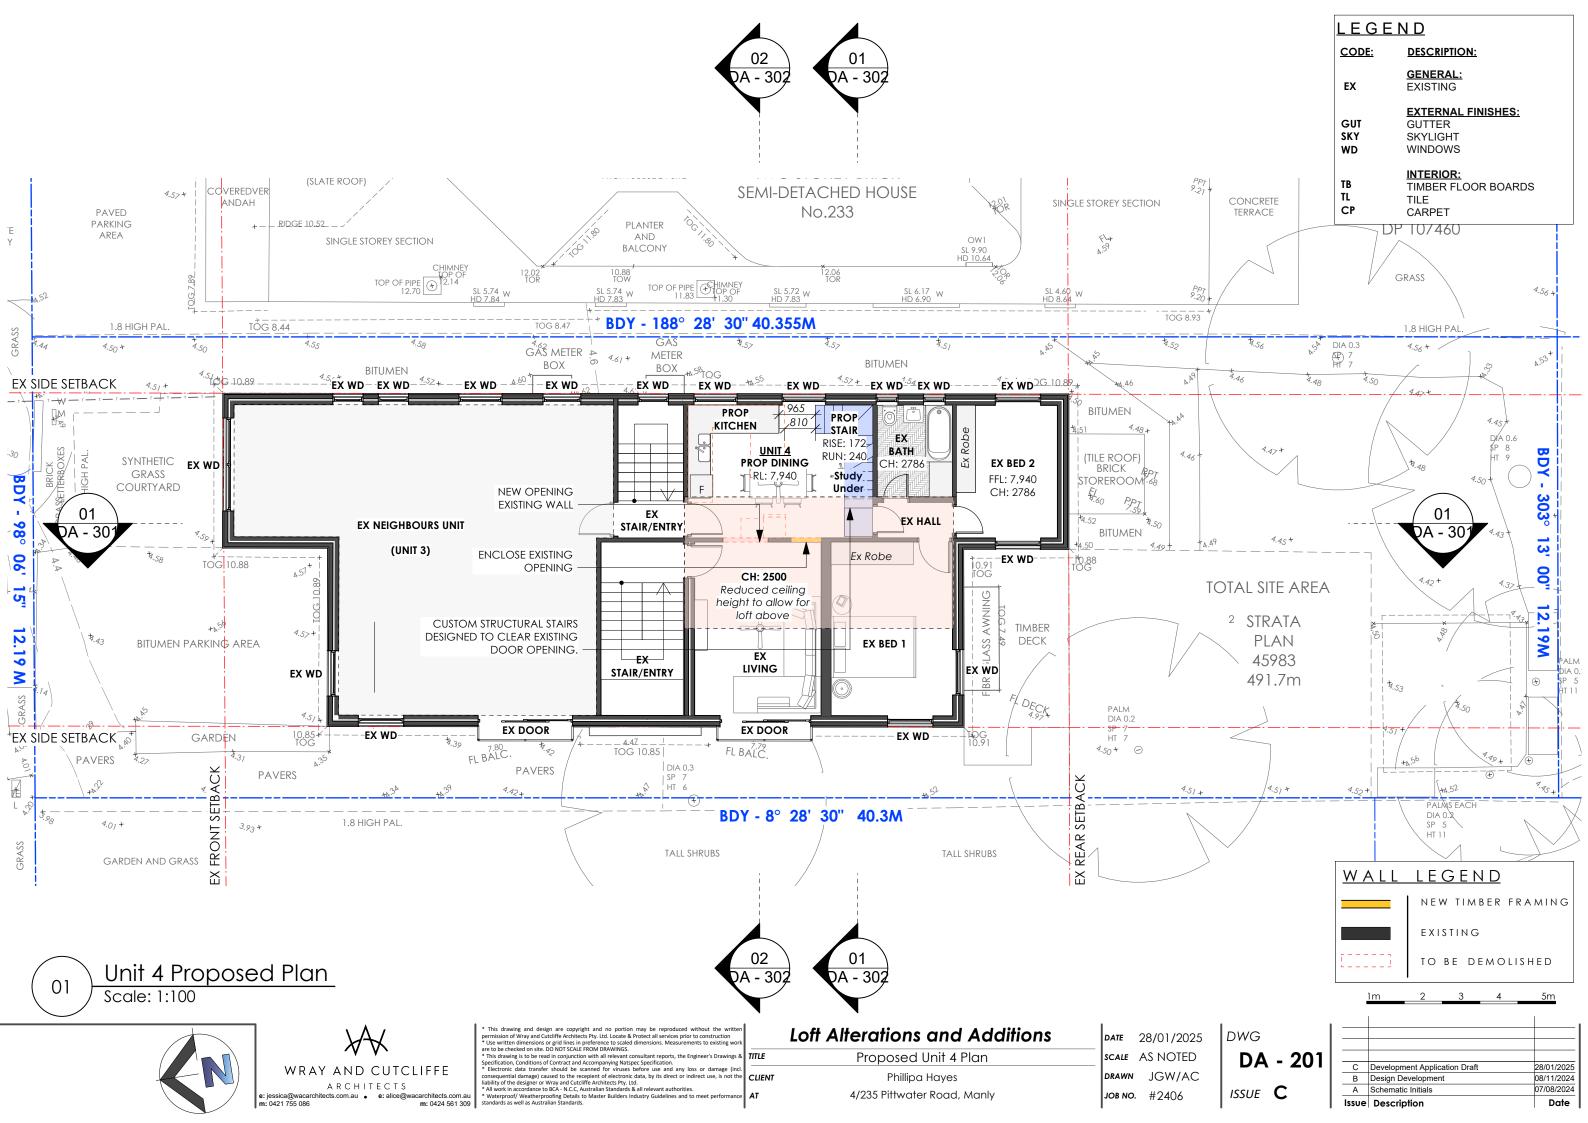
 $\lambda \nabla$ WRAY AND CUTCLIFFE ARCHITECTS e: jessica@wacarchitects.com.au • e: alice@wacarchitects.com.au m: 0421 755 086 m: 0424 561 309 m: 0424 561 309

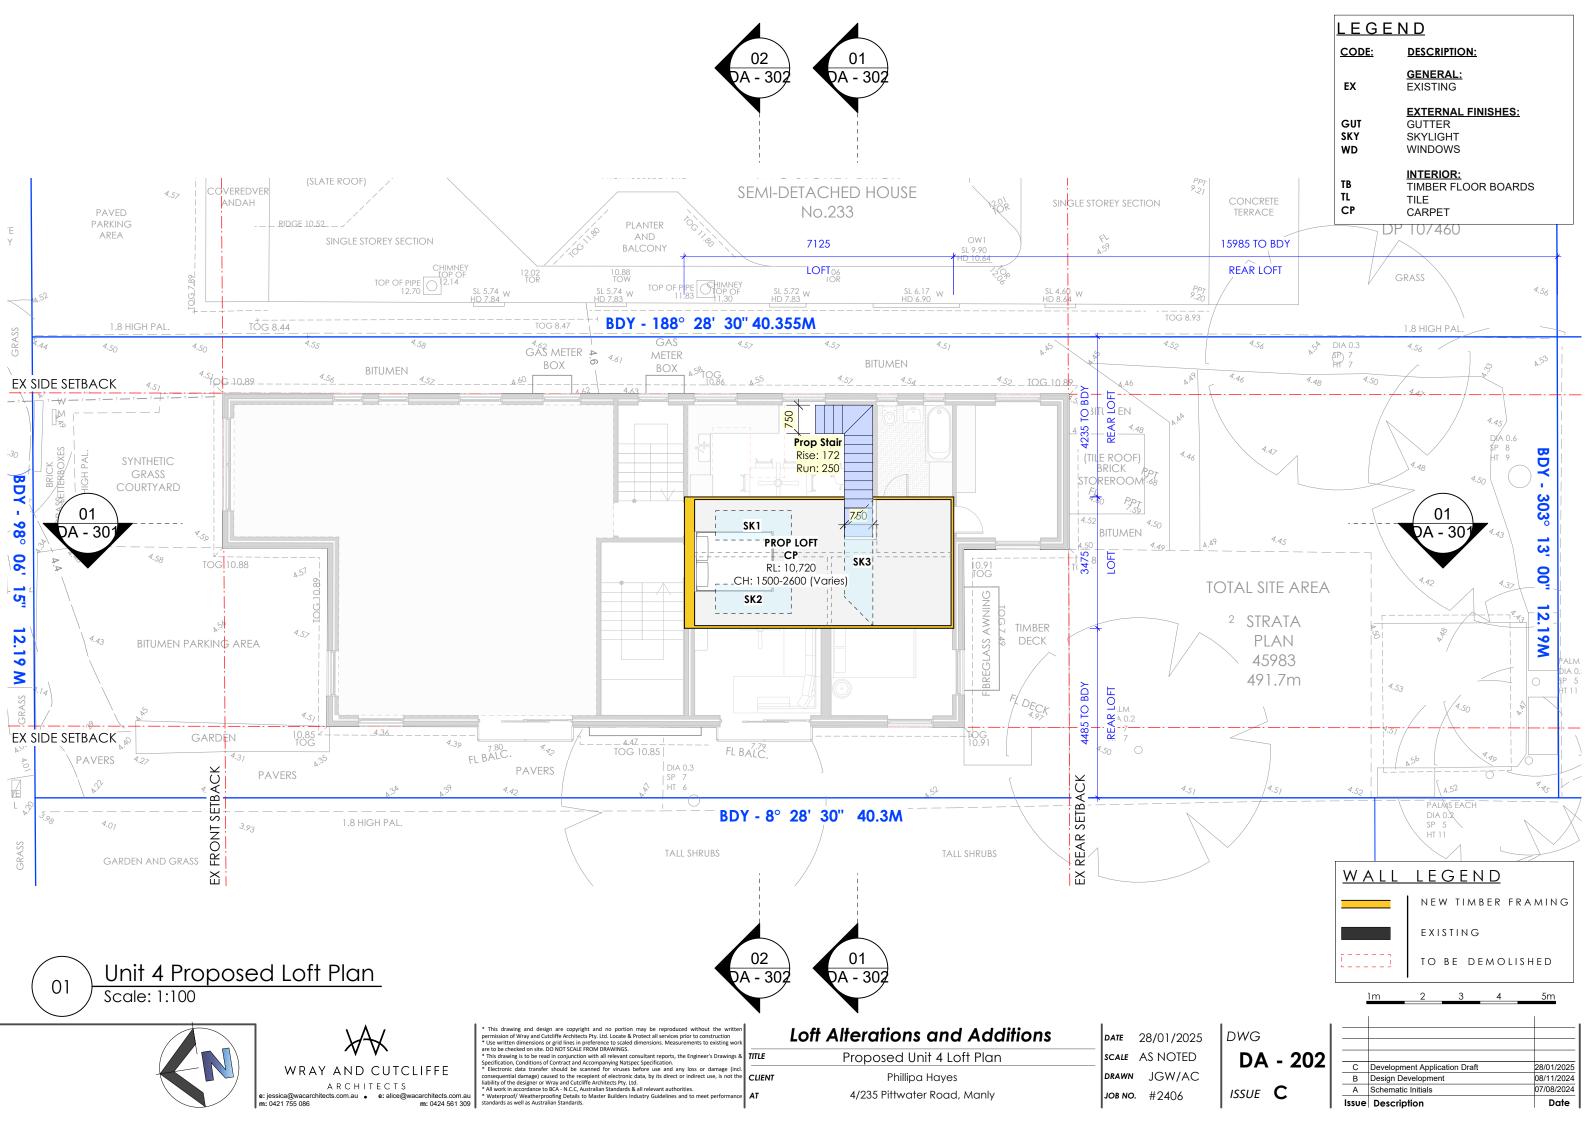
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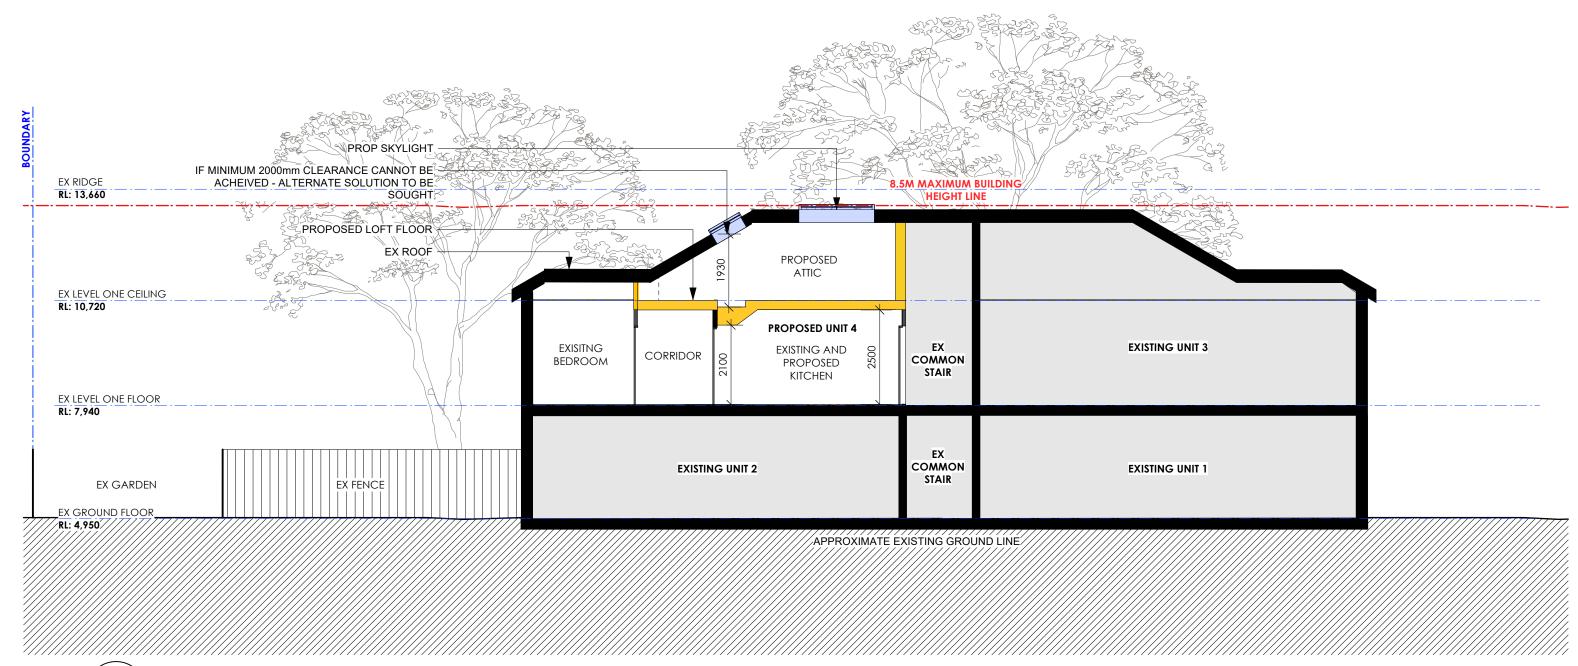
Loft Alterations and Additions	DATE 28/01/2025	DWG			<u>+</u>
Proposed Site Calculations	scale AS NOTED	DA - 103			
Phillipa Hayes	DRAWN JGW/AC		<u> </u>	Development Application Draft Design Development	28/01/2025 08/11/2024
	, .		A	Schematic Initials	07/08/2024
4/235 Pittwater Road, Manly	JOB NO. #2406	ISSUE C	Issue		Date

## AREA (m2):

a (From Survey)	-	491.70
n	-	176.02
Paving	-	185.52
pe	-	129.79
pe Walls	-	0.50
ace ((Max 0.6:1)/295sqm)	-	269.63
tal Landscape Area	-	129.79
Total Area	-	491.82
Lanscape Area		26.40%





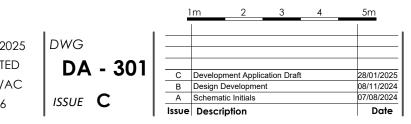


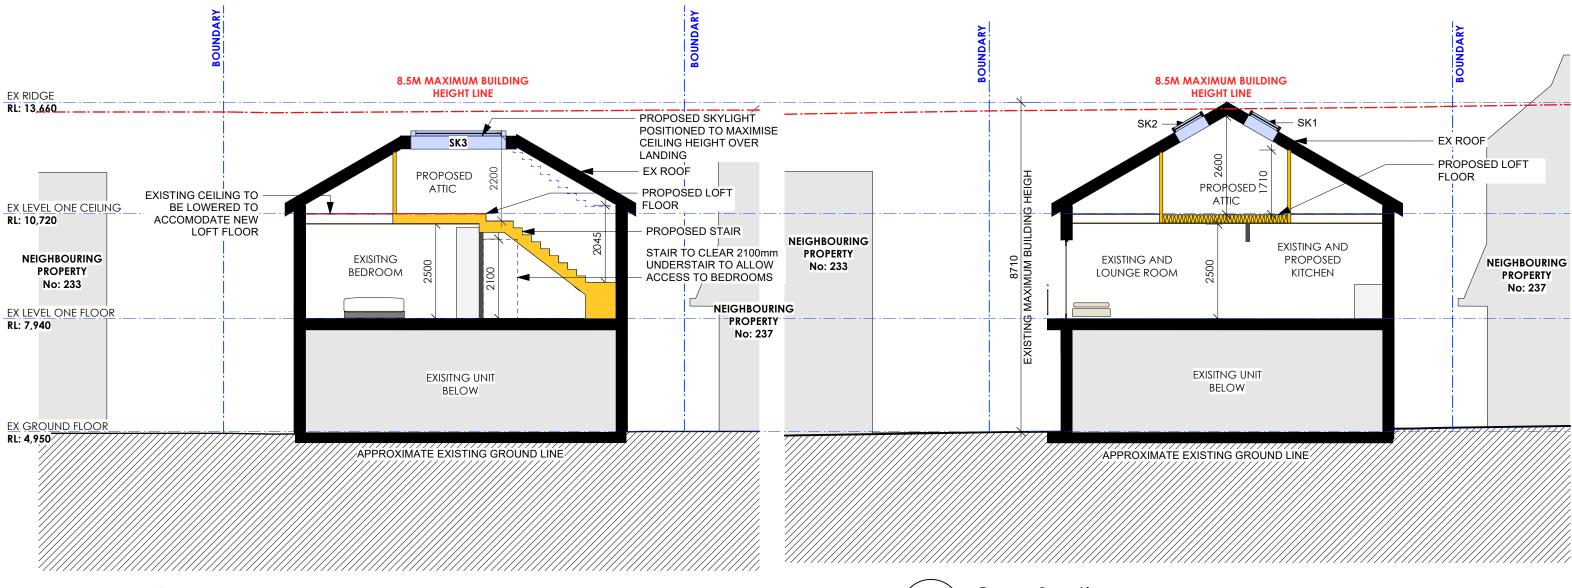
01 Long Section Scale: 1:100



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 Autority Back and Standards.

Loft Alterations and Additions	DATE	28/01/20
Proposed Long Section	SCALE	AS NOTE
Phillipa Hayes	DRAWN	JGW/A
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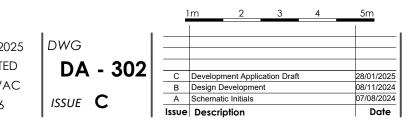


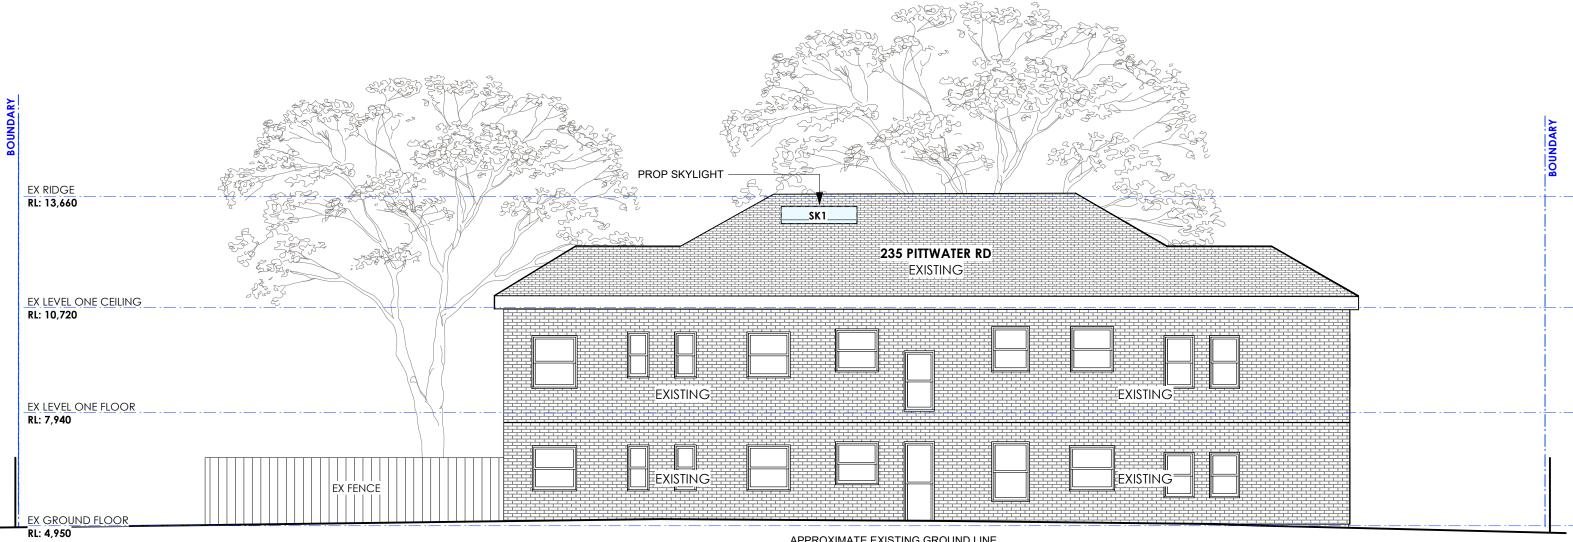
01 Cross Section Scale: 1:100 02 Cross Section Scale: 1:100



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Loft Alterations and Additions	DATE	28/01/20
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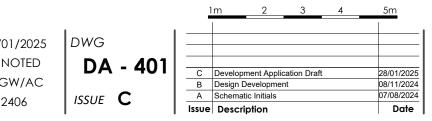
APPROXIMATE EXISTING GROUND LINE

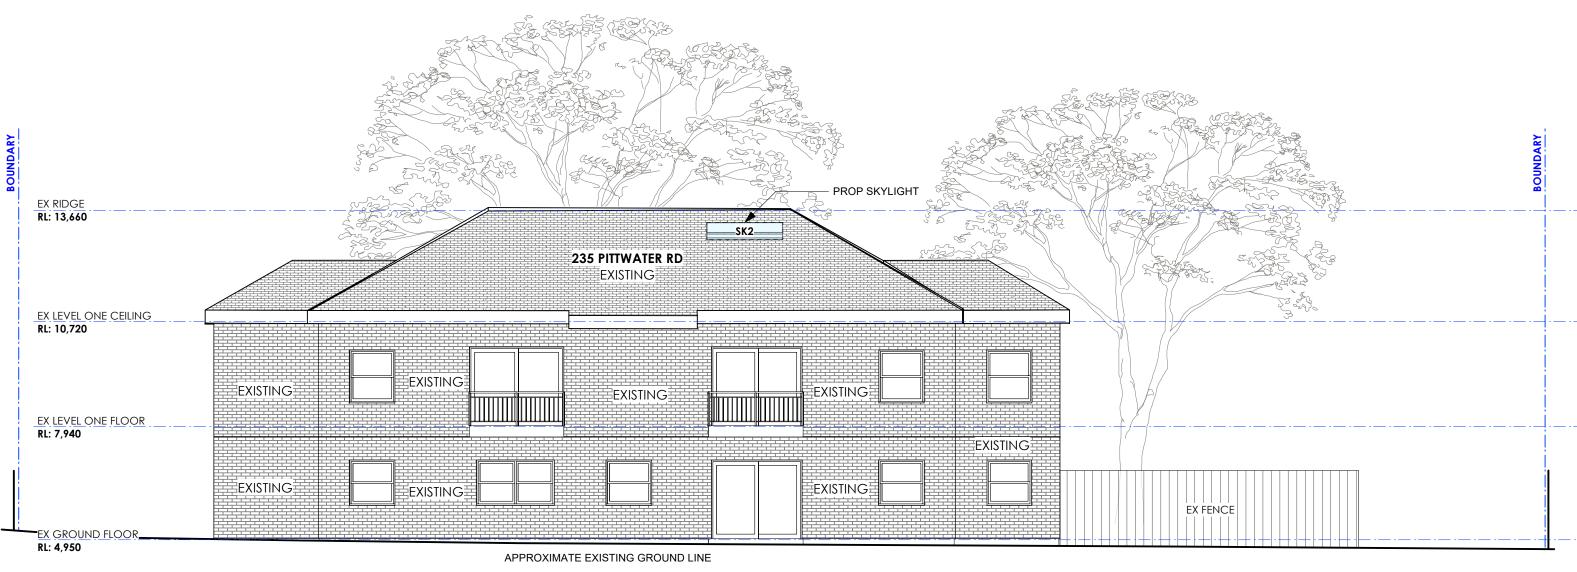
Eastern Elevation Scale: 1:100 01



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JOB NO	#2406
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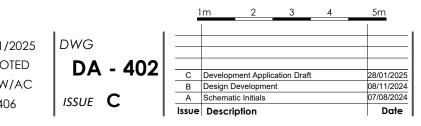


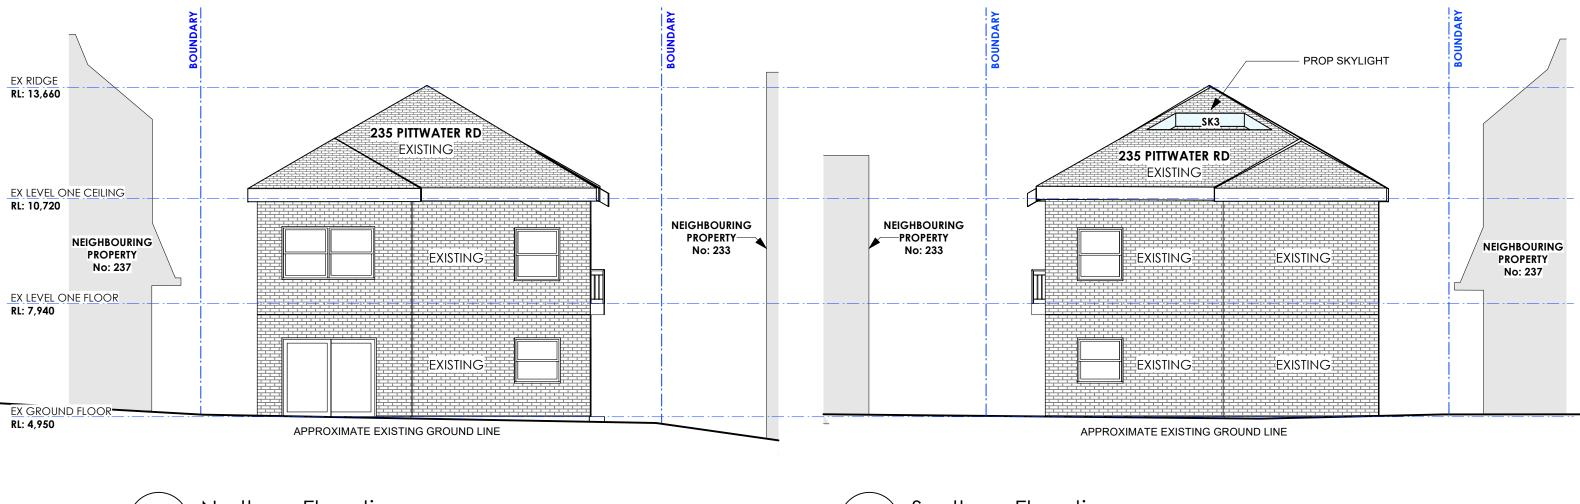


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Northern Elevation Scale: 1:100 01

Southern Elevation Scale: 1:100 02



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Loft Alterations and Additions	DA
Proposed Northern & Southern Elevations	sc
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