

ACTION PLANS

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DEVELOPMENT APPLICATION

These plans are for Development Approval only.

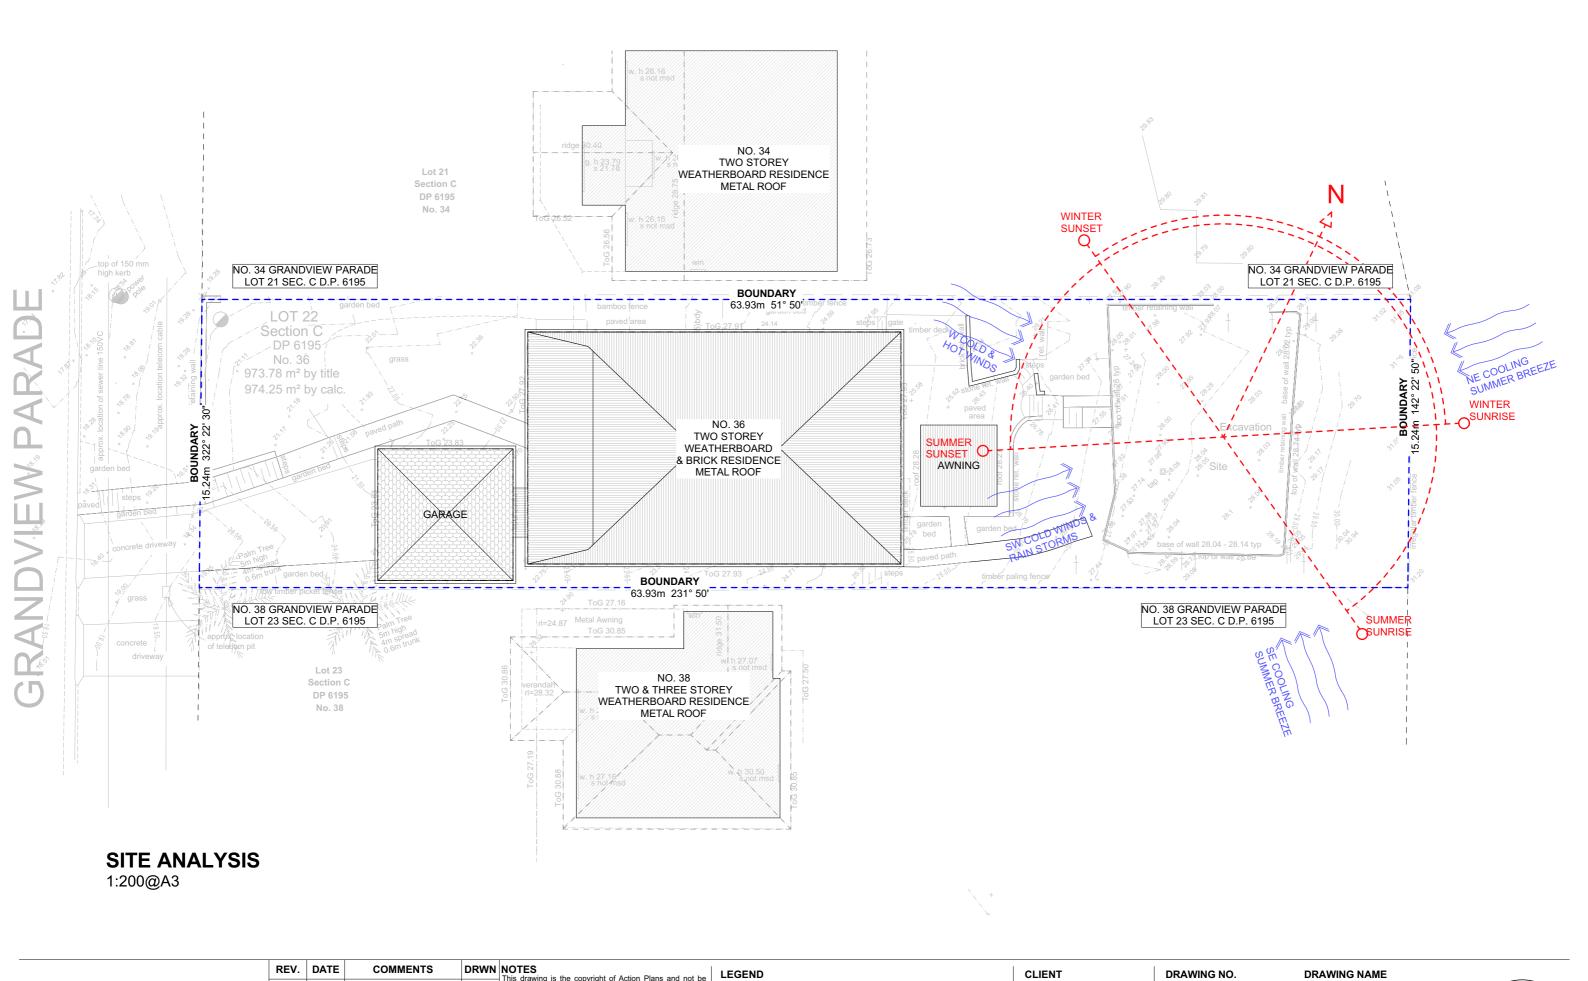
SHEET NUMBER	SHEET NAME	DATE PUBLISHED
DA00	COVER	2/09/2020
DA01	SITE ANALYSIS	2/09/2020
DA02	SITE / ROOF / SEDIMENT EROSION / WASTE MANAGEMENT PLAN	2/09/2020
DA03	SECONDARY DWELLING FLOOR PLAN	2/09/2020
DA04	NORTH / EAST ELEVATION	2/09/2020
DA05	SOUTH / WEST ELEVATION	2/09/2020
DA06	LONG / CROSS SECTION	2/09/2020
DA07	AREA CALCULATIONS	2/09/2020
DA08	WINTER SOLSTICE 9 AM	2/09/2020
DA09	WINTER SOLSTICE 12 PM	2/09/2020
DA10	WINTER SOLSTICE 3 PM	2/09/2020
DA11	BASIX COMMITMENTS	2/09/2020

ITEM DETAILS	DEVELOPMENT APPLICAT	TION		
ADDRESS	36 GRANDVIEW PARADE MONA	VALE NSW 2103		
LOT & DP/SP	LOT 22 DP 6195			
COUNCIL	NORTHERN BEACHS COUNCIL	(PITTWATER)		
SITE AREA	973.78m²			
FRONTAGE	15.24m			
CONTROLS	PERMISSIBLE / REQUIRED	EXISTING	PROPOSED	COMPLIANCE
CONTROLS	m / m² / %	m / m² / %	m / m² / %	
LEP				
LAND ZONING	E4 – ENVIRONMENTAL LIVING	E4	E4	YES
MINIMUM LOT SIZE	700m²	973.78m²	UNCHANGED	YES
FLOOR SPACE RATIO	NOT IDENTIFIED	N/A	N/A	N/A
MAXIMUM BUILDING HEIGHT	8.5m	6.4m	UNCHANGED	YES
HAZARDS				
GEOTECHNICAL HAZARD H1/H2	WITHIN H2 HAZARD	N/A	N/A	N/A
DCP				
SIDE BOUNDARY ENVELOPE	3.5m	N/A	N/A	N/A
SIDE BOUNDARY SETBACKS	N: 2.5m S: 1m	N/A	N: 2.9m S: 2m	YES
FRONT BOUNDARY SETBACK	6.5m	9.9m	UNCHANGED	YES
REAR BOUNDARY SETBACK	6.5m	27.1m	6.7m	YES
LANDSCAPE AREA	60% (584.26m²)	51% (498.54m ²)	48% (463.74m ²)	NO
PRIVATE OPEN SPACE	80m²	110m²	110m ²	YES

36 GRANDVIEW PARADE, MONA VALE, NSW 2103

NCC & AS COMPLIANCES SPECIFICATIONS

- EARTHWORKS PART 3.1.1 OF NCC
- EARTH RETAINING STRUCTURES PART 3.1.2 OF NCC
- DRAINAGE PART 3.1.3 OF NCC
- TERMITE-RISK MANAGEMENT PART 3.1.4 OF NCC
- FOOTINGS & SLAB PART 3.2 OF NCC INCLUDING AS2870
- MASONRY PART 3.3 OF NCC INCLUDING AS3700
- FRAMING PART 3.4 OF NCC
- SUB FLOOR VENTILATION PART 3.4.1 OF NCC
- ROOF CLADDING AND WALL-CLADDING PART 3.5 OF NCC
- GLAZING PART 3.6 OF NCC INCLUDING AS1288
- FIRE SAFETY PART 3.7 OF NCC
- FIRE SEPERATION PART 3.7.2 OF NCC
- FIRE PROTECTION OF SEPERATING WALLS AND FLOORS- PART 3.7.3 OF NCC
- SMOKE ALARMS PART 3.7.5 OF NCC
- WET AREAS AND EXTERNAL WATERPROOFING PART 3.8.1 OF NCC
- ROOM HEIGHTS PART 3.8.2 OF NCC
- FACILITIES PART 3.8.3 OF NCC
- LIGHT PART 3.8.4 OF NCC
- VENTILATION PART 3.8.5 OF NCC
- SOUND INSULATION PART 3.8.6 OF NCC
- STAIRWAYAND RAMP CONSTRUCTION PART 3.9.1 OF NCC
- BARRIERS AND HANDRAILS PART 3.9.2 OF NCC
- SWIMMING POOLS PART 3.10.1 OF NCC
- CONSTRUCTION IN BUSHFIRE PRONE AREAS PART 3.10.5 OF NCC
- FENCING & OTHER PROVISIONS REGS & AS1926
- DEMOLITION WORKS AS2601-1991 THE DEMOLITION OF STRUCTURES.
- ALL WATERPROOF MEMBRANES TO COMPLY WITH WITH AS 3740-2010
- ALL PLUMBING & DRAINAGE WORK TO COMPLY WITH AS 3500
- SITE CLASSIFICATION AS TO AS 2870
- ALL PLASTERBOARD WORK TO COMPLY WITH AS 2588-1998
- ALL STRUCTURAL STEEL WORK TO COMPLY WITH AS 4100 & AS 1554
- ALL CONCRETE WORK TO COMPLY WITH AS 3600
- ALL ROOF SHEETING WORK TO COMPLY WITH AS 1562-1992
- ALL SKYLIGHTS TO COMPLY WITH WITH AS 4285-2007
- ALL CERAMIC TILING TO COMPLY WITH AS 3958.1-2007 & 3958.2-1992
- ALL GLAZING ASSEMBLIES TO COMPLY WITH AS2047 & 1288
- ALL TIMBER RETAINING WALLS ARE TO COMPLY WITH AS 1720.1-2010, AS 1720.2-2006, AS 1720.4-2006, AS 1170.1-1989 & AS 1170.4-2007
- ALL RETAINING WALLS ARE TO COMPLY WITH 3700 2011 & AS 3600 -2009
- ALL CONSTRUCTION TO COMPLY TO AS3959- 2009





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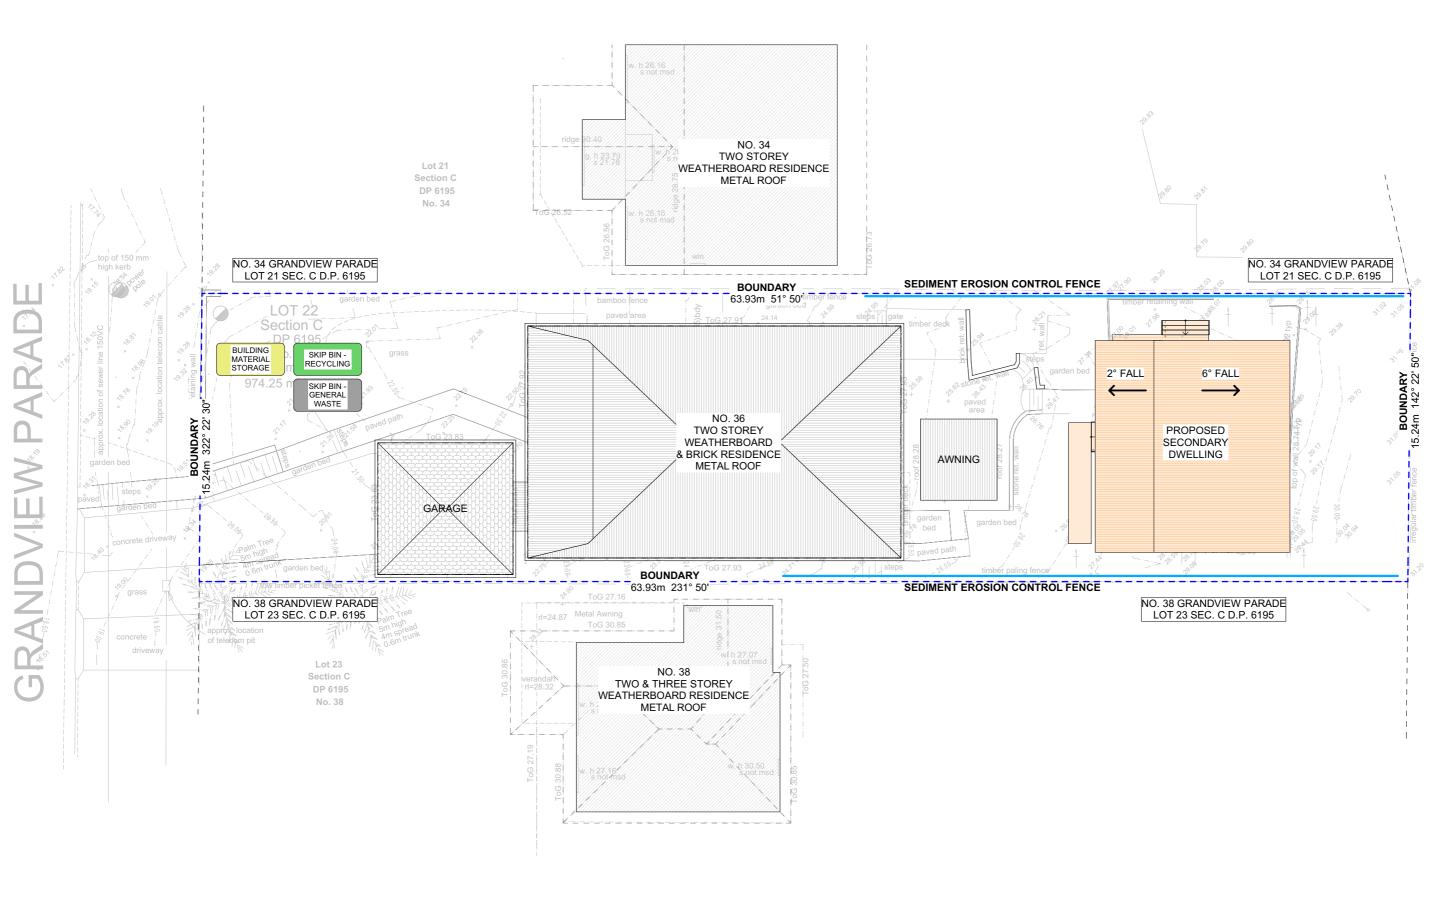
PROJECT ADDRESS 36 GRANDVIEW PARADE, MONA VALE, NSW 2103

DA01

SITE ANALYSIS DATE

Wednesday, 2 SCALE September 2020 1:200 @A3



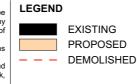


SITE / ROOF / SEDIMENT EROSION / WASTE MANAGEMENT PLAN

1:200@A3



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NSW 2103

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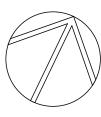
DA02

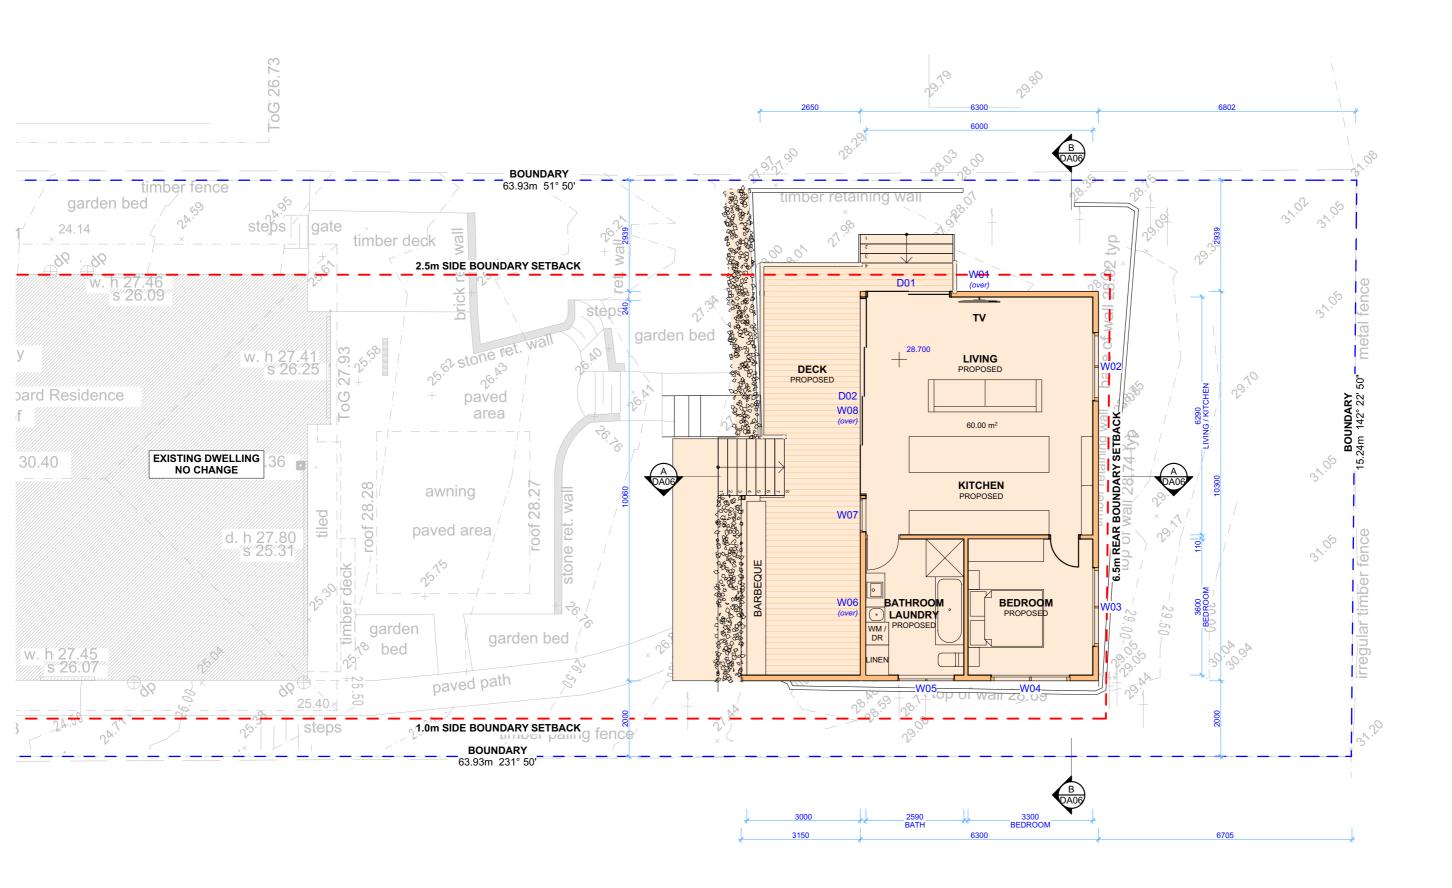
DATE
Wednesday, 2
September 2020

DRAWING NAME

SITE / ROOF / SEDIMENT EROSION / WASTE MANAGEMENT PLAN

SCALE 1:200 @A3



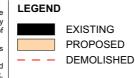


SECONDARY DWELLING FLOOR PLAN

1:100@A3



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DA03

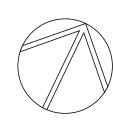
September 2020

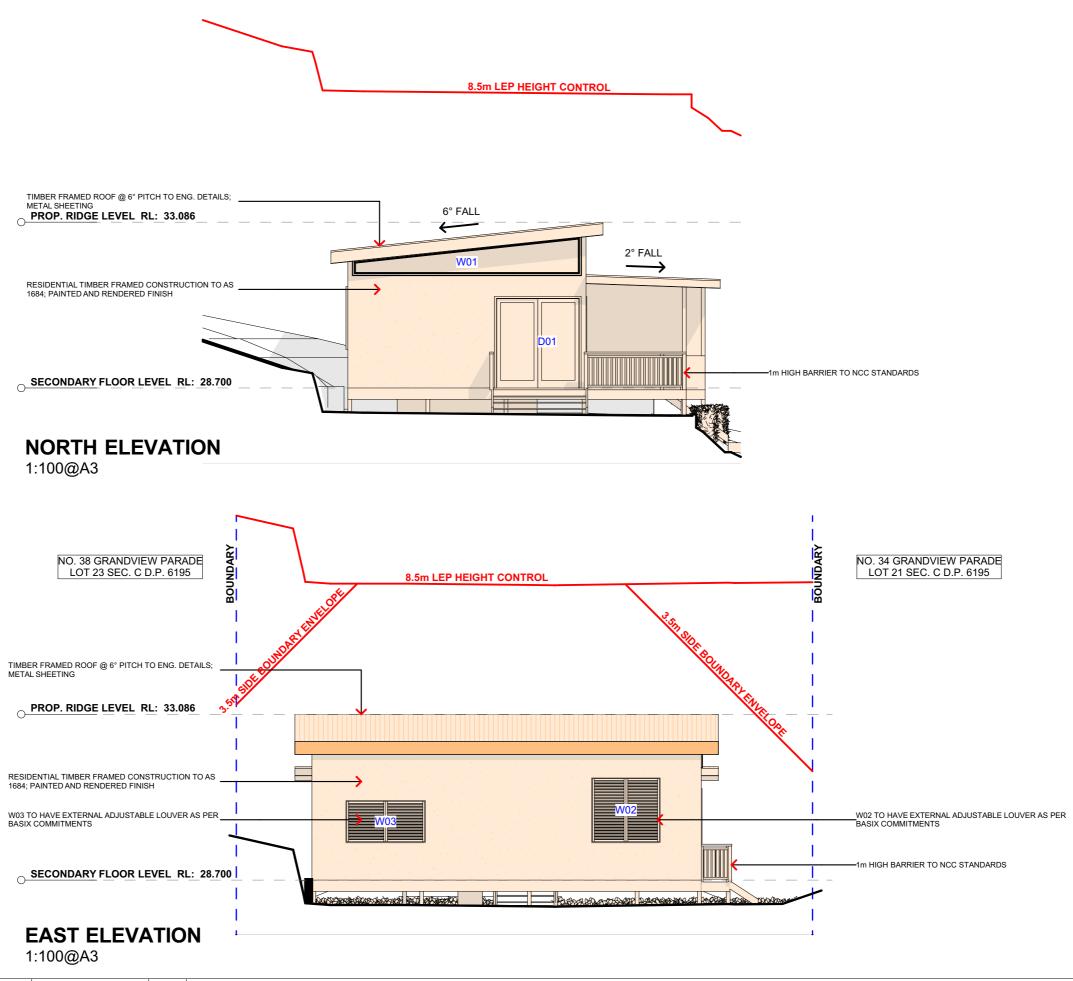
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SECONDARY DWELLING FLOOR PLAN DATE Wednesday, 2 SCALE

DRAWING NAME

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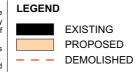
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PROJECT ADDRESS 36 GRANDVIEW

DRAWING NO. **DA04**

DATE

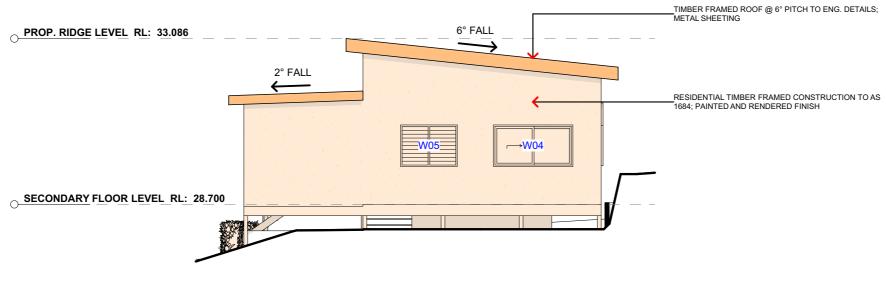
NORTH / EAST ELEVATION

DRAWING NAME

PARADE, MONA VALE, NSW 2103

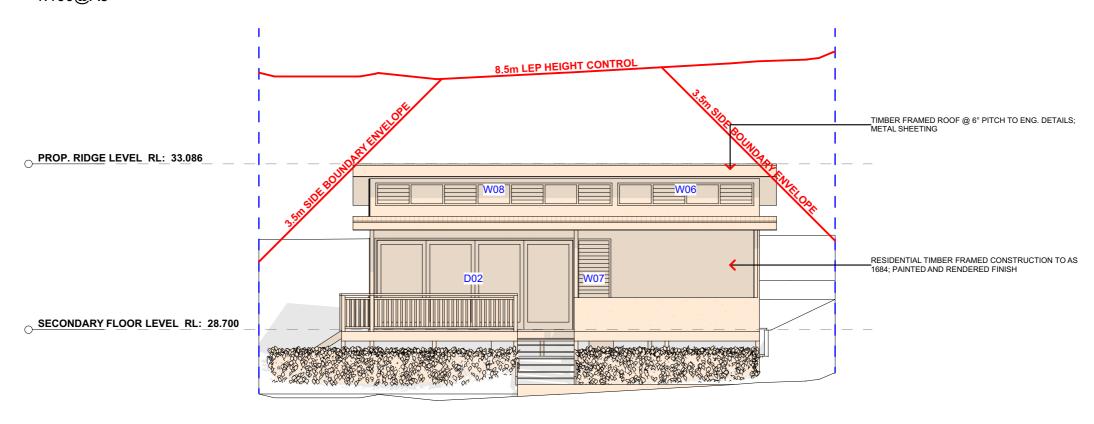
Wednesday, 2 September 2020 SCALE

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SOUTH ELEVATION

1:100@A3

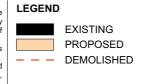


WEST ELEVATION

1:100@A3

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DA05

SOUTH / WEST ELEVATION

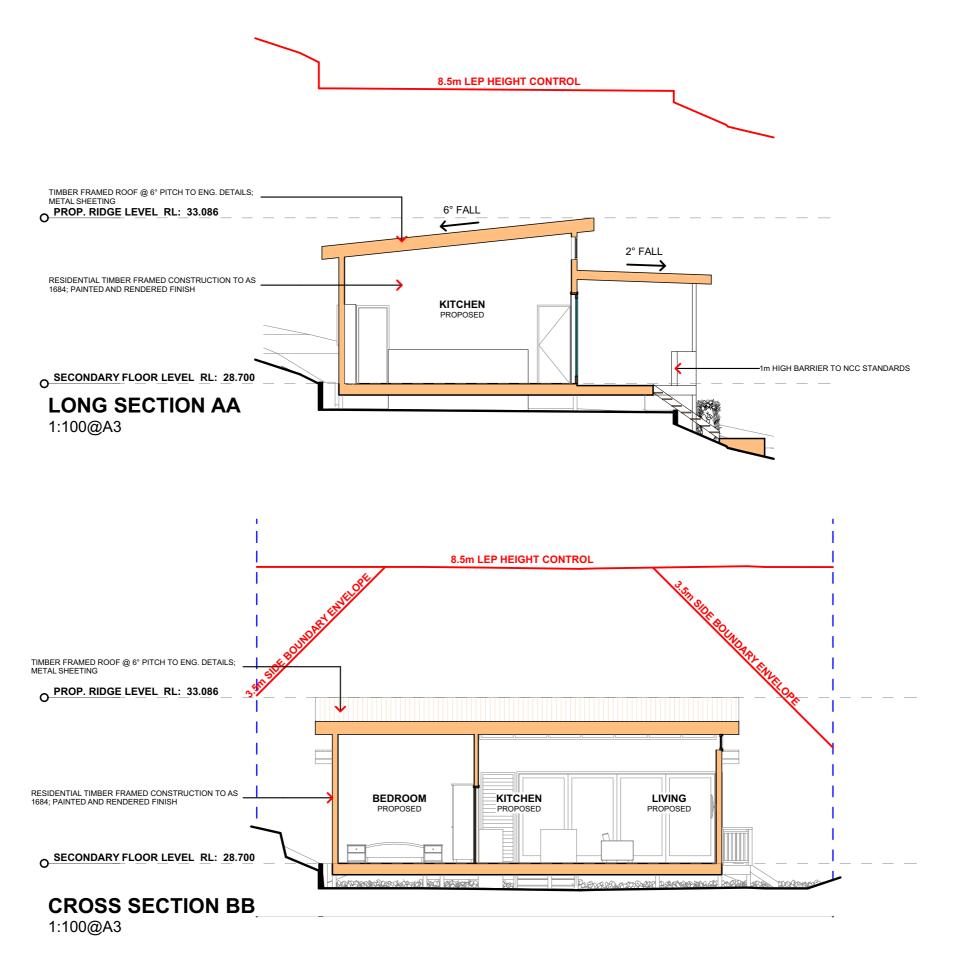
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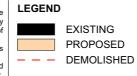
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PROJECT ADDRESS 36 GRANDVIEW PARADE, MONA VALE, NSW 2103 DA06

September 2020

DATE Wednesday, 2 DRAWING NAME LONG / CROSS SECTION

SCALE 1:100 @A3

AREA CALCULATIONS

1:200@A3

SITE AREA: 973.78m²

LANDSCAPE AREA:

Soft Landscaping: 405.32m² Impervious landscape area: 58.42m²(6%)

Total: 48% (463.74m²)

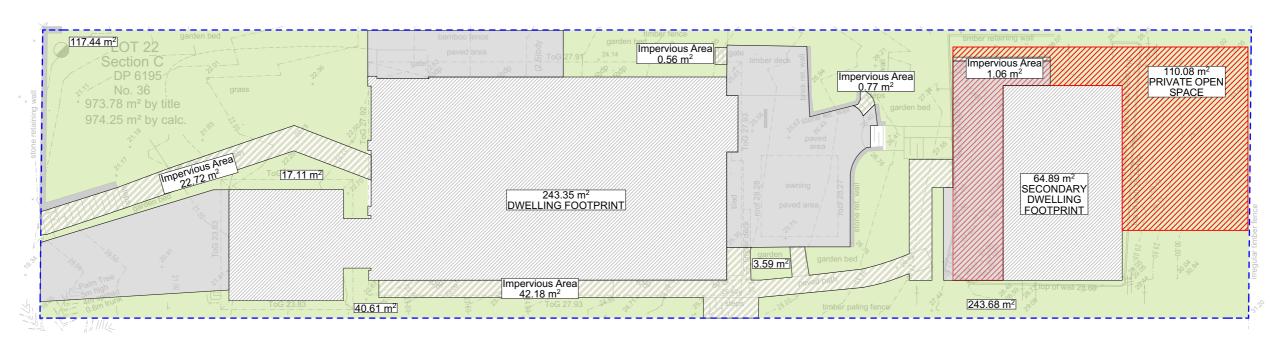


DWELLING FOOTPRINT: 308.24m²



PRIVATE OPEN SPACE

110.08m²





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LEGEND

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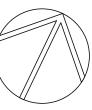
PROJECT ADDRESS 36 GRANDVIEW PARADE, MONA VALE, DA07

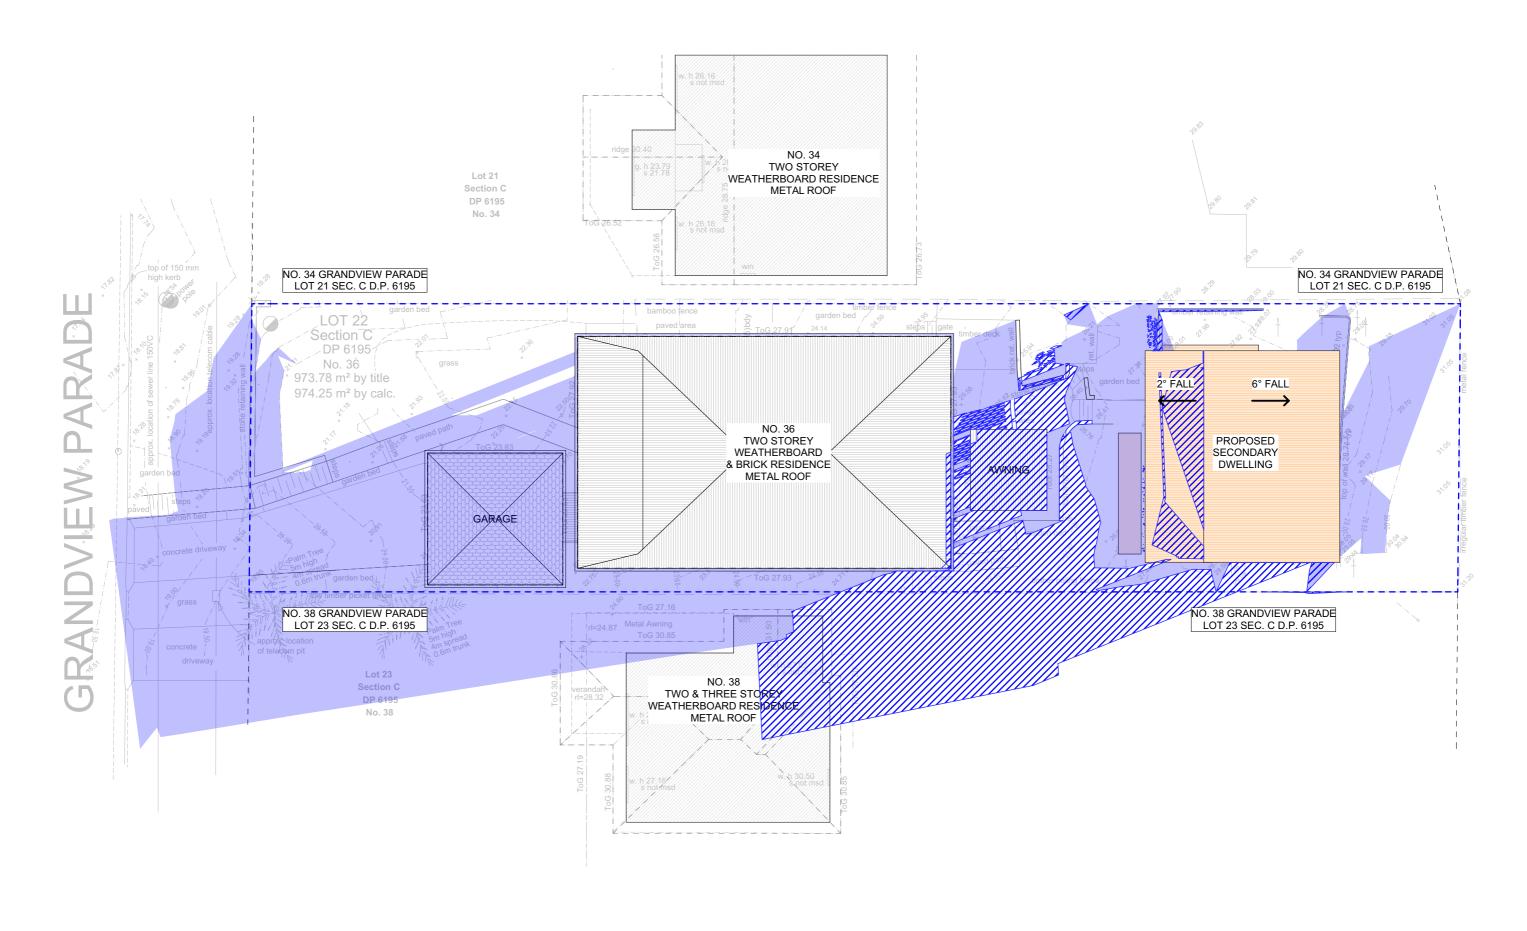
September 2020

DATE
Wednesday, 2 SCALI

DRAWING NAME
AREA CALCULATIONS

SCALE 1:200 @A3



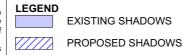


WINTER SOLSTICE 9AM

1:200@A3



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NSW 2103

DA08

DRAWING NO.

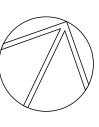
Wednesday, 2

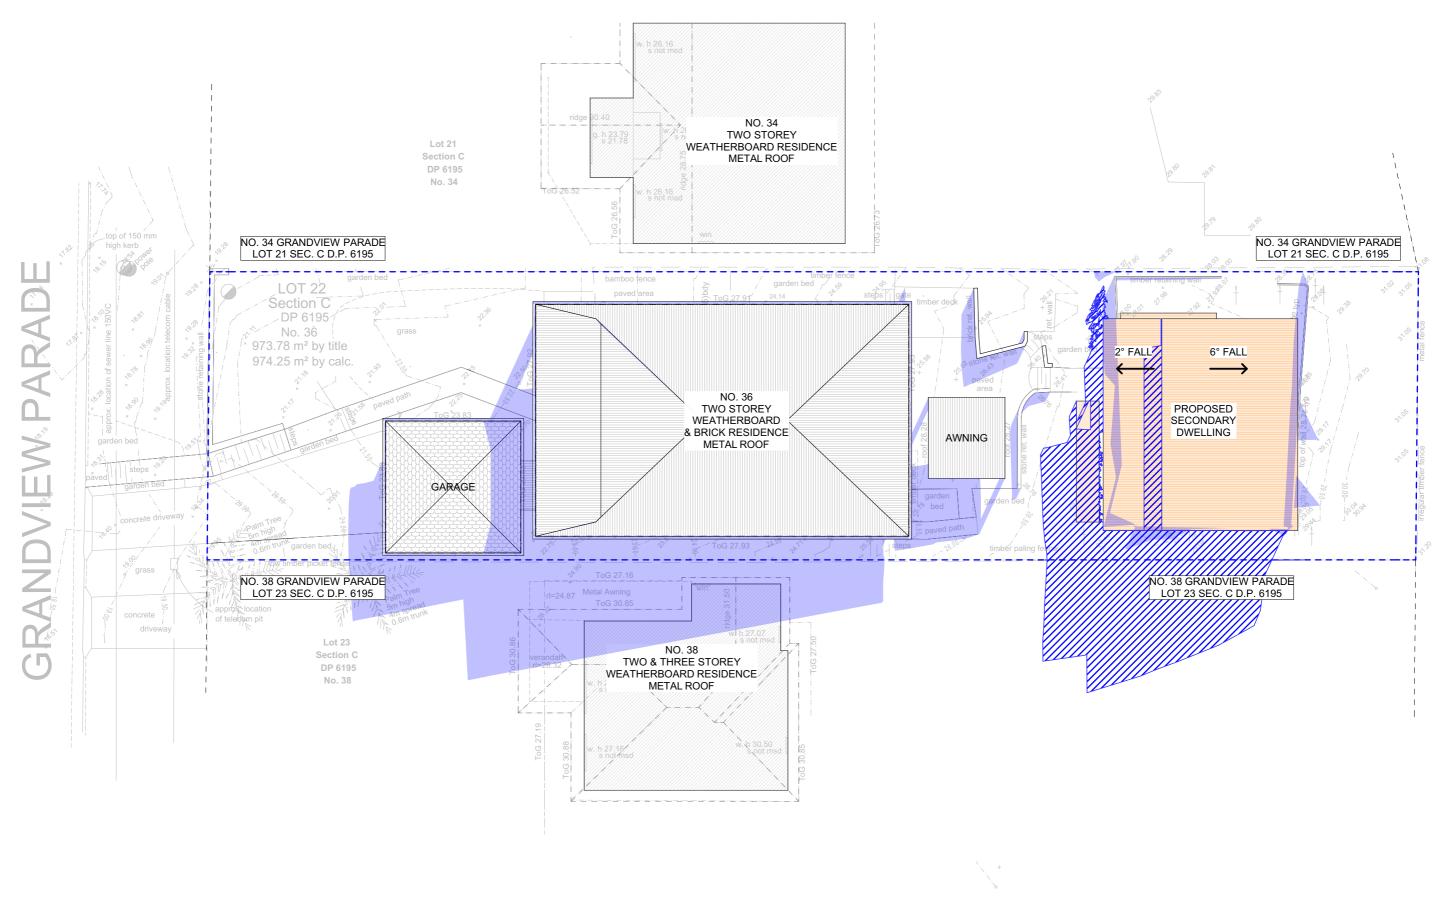
September 2020

WINTER SOLSTICE 9 AM DATE

SCALE 1:200 @A3

DRAWING NAME



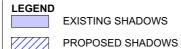


WINTER SOLSTICE 12PM

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EXISTING SHADOWS

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DRAWING NO. **DA09**

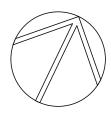
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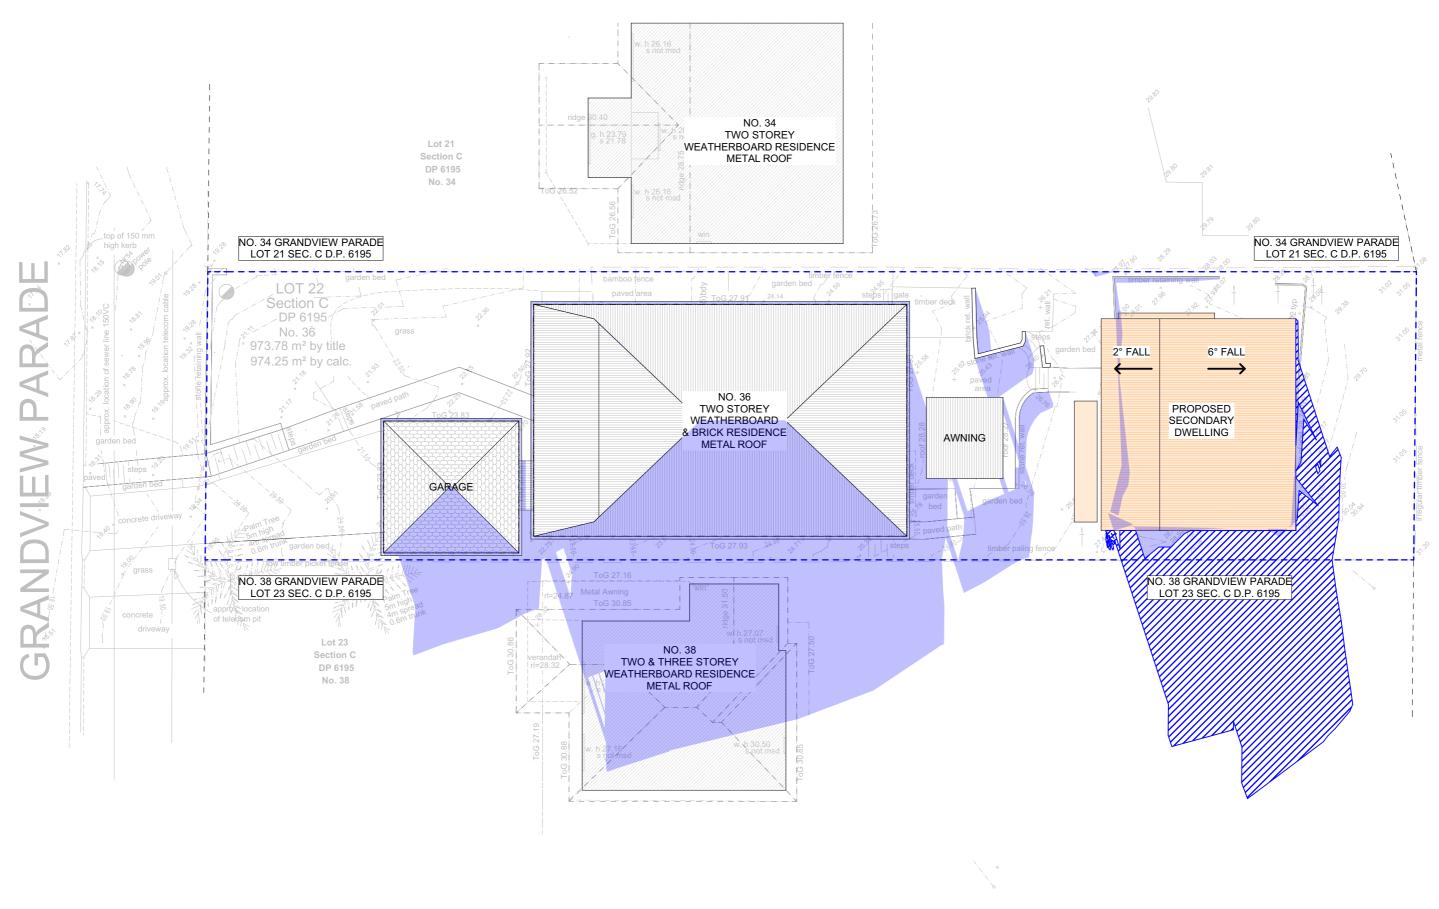
DRAWING NAME WINTER SOLSTICE 12 PM

SCALE

1:200 @A3

Wednesday, 2 September 2020



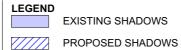


WINTER SOLSTICE 3PM

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EXISTING SHADOWS

CLIENT

NSW 2103

Robert & Julia Ellerton

PROJECT ADDRESS 36 GRANDVIEW PARADE, MONA VALE,

DA10

DATE Wednesday, 2

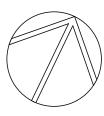
September 2020

DRAWING NO.

DRAWING NAME

WINTER SOLSTICE 3 PM

SCALE 1:200 @A3



BASIX Thermal comfort inclusions

Floors

Suspended timber with R2.0 insulation (insulation only value) to open and enclosed suspended areas

External Walls

Lightweight cladding on framed walls with R2.5 insulation (insulation only value) and Thermoseal Wall Wrap or equivalent minimum R-total R_t 3.56

External Colour: Medium (0.475 < SA < 0.7)

Walls within dwellings

Plasterboard on studs, no insulation required

Glazing Doors/Windows

Single low-e glazing with aluminium frame to louvered windows:

Group B – louvred windows

U-value: 4.80 (equal to or lower than) SHGC: 0.51 (±10%)

High performance glazing and frame system to all remaining windows:

Group B – sliding doors/windows + fixed glazing

U-value: 2.9 (equal to or lower than) SHGC: 0.42 (±10%)

Given values are AFRC total window system values (glass and frame)

Skylights

None

Ceilings

Plasterboard ceiling with R4.0 insulation (insulation only value) where roof above or balcony above

Ceiling Penetrations

Downlights as per NatHERS assessment

Assumed sealed LED downlights, one every 2.5m²

Roof

Metal roof with foil backed blanket (R_u1.3 and R_d1.3) (ie. Bradfords Anticon 60)

External Colour

Medium (0.475 < SA < 0.7)

Floor coverings

Carpet to bedrooms, timber to living and tiles to bathroom

External Shading

Shading as per stamped drawings

Windows W02 & W03 require external adjustable louvers or blinds

Ventilation

All external doors have weather seals, all exhaust fans and chimneys have dampers, and down lights proposed will have capped fittings

BASIX water inclusions

Rainwater tank

3,500L rainwater tank collecting from $114m^2$ of roof area

Connected to garden

BASIX Energy inclusions

Hot water

Gas instantaneous – 6 star

Alternative energy

Photovoltaic system - minimum 2.5kW peak

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				All errors and omissions are to be verified by the Builder/Contractor and referred to the designer prior to the commencement of works. All window & door dimensions, orientation, glazing materials, opening types, frame types are to be confirmed by a suitably qualified	F
				person prior to the ordering of any such materials are to take place. U value takes precedence over glazing type/colour in all cases.	3
				all new glazing must meet the BASIX specified frame and glass type, <u>QR</u> meet the ecified U value and SHGC value.	F

CLIENT

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PROJECT ADDRESS 36 GRANDVIEW PARADE, MONA VALE, NSW 2103 DRAWING NO.

DA11 BAS

DATE Wednesday, 2 September 2020 **DRAWING NAME**BASIX COMMITMENTS