DRAWING REGISTER REVISION DATE ISSUED PAGE NO. TITLE COVER PAGE/LOCATION PLAN/COMPLIANCE DIAGRAMS PLAN: SITE ANALYSIS (Existing) 02.03.2021 PLAN: SITE (Proposed) 02.03.2021 PLAN:S BASEMENT + GROUND FLOOR 02.03.2021 PLANS: FIRST FLOOR + ROOF 02.03.2021 ELEVATIONS: NTH / STH / EST / WST 02.03.2021

NP.02 NOTIFICATION PLANS 32 Reddall Street, Manly NSW 2095

NOTIFICATION PLANS

VIEW ANALYSIS

SHADOW DIAGRAMS - EXISTING

SHADOW DIAGRAMS - PROPOSED

Lot 87, Sec DP 70416

Land Area 696.7 m² CONTROLS

LEP Floor Space Ratio Map (Sheet FSR_006)

max floor space ratio F (0.6:1)

LEP Height of Buildings Map (Sheet HOB_006)

Maximum Building Height J (9m)

LEP Land Zoning Map (Sheet LZN_006)

R1: General Residential

DCP EXCAVATION Maximum volume of excavation for the site

Max permitted excavation 350 m3

DCP 4.1.5 Open Space and Landscaping

Total open space at least 55% of site area

Total landscaped area at least 35% of open space



02.03.2021

02.03.2021

02.03.2021

02.03.2021

02.03.2021



work including rafters, privacy

BK1 - Existing brickwork to be

PB1 - Existing pebble columns to

be retained

PT2 - Existing painted timberwork
















bricks over textured render ST1 - Existing sandstone to be re-used in landscape walls

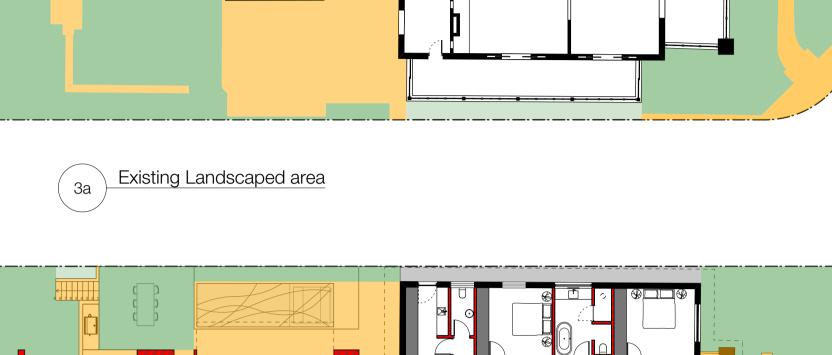

YES

YES

Compliant


Compliant

267.1 m2

Proposed

144.5 sqm

37.7% open space **YES**

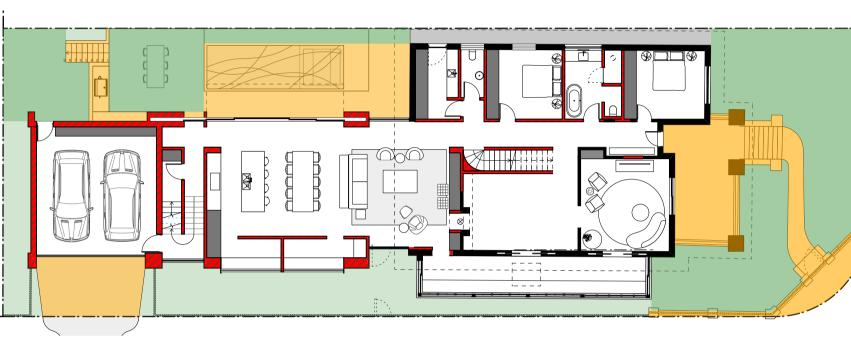



DCP 4.1.5 Open Space and Landscaping

Total Open Space | 55% of site area min. | 57.9%

Total 134.1 m2 min.

35% open space min. 69.7%

267.1 m2

Site Area 696.7 m2

Open Space Area Area OS3

Landscaped Area



with, the requirements of all applicable regulatory authorities. The applicant must configure the rainwater tank to collect rainwater runoff from at least 150 square metres of roof area.

The applicant must install a rainwater tank of at least 1290 litres on the site. This rainwater tank must meet, and be installed in accordance

The applicant must connect the rainwater tank to a tap located within 10 metres of the edge of the pool and outdoor spa. Outdoor swimming pool

The swimming pool must be outdoors.

Rainwater tank

The swimming pool must not have a capacity greater than 16 kilolitres.

The swimming pool must have a pool cover.

The applicant must install a pool pump timer for the swimming pool.

The applicant must install the following heating system for the swimming pool that is part of this development: electric heat pump.

Outdoor spa The spa must not have a capacity greater than 3 kilolitres.

The spa must have a spa cover.

The applicant must install a spa pump timer.

Hot water must install the following heating system for the outdoor spa that is part of this development: electric heat pump.

The applicant must install the following hot water system in the development: electric heat pump system that is eligible to create Renewable Energy Certificates under the (Commonwealth) Renewable Energy (Electricity) Regulations 2001 (incorporating Amendment Regulations

Lighting

The applicant must ensure a minimum of 40% of new or altered light fixtures are fitted with fluorescent, compact fluorescent, or light-emitting-diode (LED) lamps.

Fixtures The applicant must ensure new or altered showerheads have a flow rate no greater than 9 litres per minute or a 3 star water rating.

The applicant must ensure new or altered toilets have a flow rate no greater than 4 litres per average flush or a minimum 3 star water rating.

The applicant must ensure new or altered taps have a flow rate no greater than 9 litres per minute or minimum 3 star water rating.

BASIX Certificate # A346623_02

Prepared by: BASIX Certificate Centre - 23 Feb. 2021

The applicant must construct the new or altered construction (floor(s), walls, and ceilings/roofs) in accordance with the specifications listed in the table below, except that a) additional insulation is not required where the area of new construction is less than 2m2, b) insulation specified is not required for parts of altered construction where insulation already exists.

Construction	Additional insulation required (R-value)	Other specifications
concrete slab on ground floor.	nil	
floor above existing dwelling or building.	nil	
external wall: cavity brick	nil	
external wall: framed (weatherboard, fibro, metal clad)	R1.30 (or R1.70 including construction)	
external wall: other/undecided	R1.70 (including construction)	
internal wall shared with garage: single skin masonry (R0.18)	nil	
flat ceiling, pitched roof	ceiling: R2.50 (up), roof: foil/sarking	dark (solar absorptance > 0.70)
raked ceiling, pitched/skillion roof: framed	ceiling: R2.50 (up), roof: foil/sarking	dark (solar absorptance > 0.70)
flat ceiling, flat roof: framed	ceiling: R2.50 (up), roof: foil/sarking	medium (solar absorptance 0.475 - 0.70

Windows and glazed doors

The applicant must install the windows, glazed doors and shading devices, in accordance with the specifications listed in the table below. Relevant overshadowing specifications must be satisfied for each window and glazed door.

The following requirements must also be satisfied in relation to each window and glazed door:

Each window or glazed door with standard aluminium or timber frames and single clear or toned glass may either match the description, or, have a U-value and a Solar Heat Gain Coefficient (SHGC) no greater than that listed in the table below. Total system U-values and SHGCs must be calculated in accordance with National Fenestration Rating Council (NFRC) conditions.

Each window or glazed door with improved frames, or pyrolytic low-e glass, or clear/air gap/clear glazing, or toned/air gap/clear glazing must have a U-value and a Solar Heat Gain Coefficient (SHGC) no greater than that listed in the table below. Total system U-values and SHGCs must be calculated in accordance with National Fenestration Rating Council (NFRC) conditions. The description is provided for information only. Alternative systems with complying U-value and SHGC may be substituted.

For projections described in millimetres, the leading edge of each eave, pergola, verandah, balcony or awning must be no more than 500 mm above the head of the window or glazed door and no more than 2400 mm above the sill.

For projections described as a ratio, the ratio of the projection from the wall to the height above the window or glazed door sill must be at least that shown in the table below.

Pergolas with polycarbonate roof or similar translucent material must have a shading coefficient of less than 0.35.

External louvres and blinds must fully shade the window or glazed door beside which they are situated when fully drawn or closed. Pergolas with fixed battens must have battens parallel to the window or glazed door above which they are situated, unless the pergola also shades a perpendicular window. The spacing between battens must not be more than 50 mm.

Overshadowing buildings or vegetation must be of the height and distance from the centre and the base of the window and glazed door, as specified in the 'overshadowing' column in the table below.

Windows and glazed doors glazing requirements Window / door Orientation Area of Overshadowing Shading device

Williad W / addit	Cricination	Al Ca Oi	OVEISITE	adowning	Orlawing device	Traine and glass type
no.		glass inc. frame (m2)	Height (m)	Distance (m)		
GF W01	NE	4.2	0	0	eave/verandah/pergola/balcony >=900 mm	standard aluminium, single clear, (or U-value: 7.63, SHGC: 0.75)
GF W02	SE	4.05	5.85	7.5	none	standard aluminium, single clear, (or U-value: 7.63, SHGC: 0.75)
GF W03	NE	2.7	1.45	2.5	external louvre/blind (adjustable)	standard aluminium, single clear, (or U-value: 7.63, SHGC: 0.75)
GF W04	SE	14.04	0	0	external louvre/blind (adjustable)	standard aluminium, single clear, (or U-value: 7.63, SHGC: 0.75)
GF W05	SW	2.7	0	0	external louvre/blind (adjustable)	standard aluminium, single clear, (or U-value: 7.63, SHGC: 0.75)
GF W06	SE	5.13	10.35	3	awning (adjustable) >=900 mm	standard aluminium, single clear, (or U-value: 7.63, SHGC: 0.75)
GF W07	NW	5.13	9.35	5	none	standard aluminium, single pyrolytic low-e, (U-value: 5.7, SHGC: 0.47)
GF W08	NW	19.17	1.75	5	awning (adjustable) >=900 mm	standard aluminium, single clear, (or U-value: 7.63, SHGC: 0.75)
GF W09	NW	4.05	1.75	5	awning (adjustable) >=900 mm	standard aluminium, single clear, (or U-value: 7.63, SHGC: 0.75)
FF W01	NE	2.4	0	0	projection/height above sill ratio >=0.29	standard aluminium, single pyrolytic low-e, (U-value: 5.7, SHGC: 0.47)
FF W02	NE	4.8	0	0	projection/height above sill ratio >=0.29	standard aluminium, single pyrolytic low-e, (U-value: 5.7, SHGC: 0.47)
FF W03	NE	2.4	0	0	projection/height above sill ratio >=0.29	standard aluminium, single pyrolytic low-e, (U-value: 5.7, SHGC: 0.47)
FF W04	NW	5.87	0	0	external louvre/blind (adjustable)	standard aluminium, single clear, (or U-value: 7.63, SHGC: 0.75)
FF W05	NE	22.6	3.43	7.8	external louvre/blind (adjustable)	standard aluminium, single clear, (or U-value: 7.63, SHGC: 0.75)
FF W06	SE	5.87	3.15	7.5	none	standard aluminium, single clear, (or U-value: 7.63, SHGC: 0.75)
FF W07	SE	12.32	0	0	projection/height above sill ratio >=0.36	standard aluminium, single clear, (or U-value: 7.63, SHGC: 0.75)
FF W08	SE	6.9	7.65	3	none	standard aluminium, single clear, (or U-value: 7.63, SHGC: 0.75)
FF W09	SW	5.26	0	0	none	standard aluminium, single clear, (or U-value: 7.63, SHGC: 0.75)
FF W10	NW	6.9	6.65	5	none	standard aluminium, single pyrolytic low-e, (U-value: 5.7, SHGC: 0.47)
FF W11	NW	3.36	0	0	awning (adjustable) >=900 mm	standard aluminium, single clear, (or U-value: 7.63, SHGC: 0.75)
FF W12	NW	3.36	0	0	awning (adjustable) >=900 mm	standard aluminium, single clear, (or


U-value: 7.63, SHGC: 0.75)




Site Area	696.7 m2			
MAX FSR	0.6:1 (418.02 m2))		
GFA	Existing	Compliant	Proposed	Compliant
First Floor	na	na	111.5	
Ground Floor	198 m2		261.2	
L Gnd Floor	na			
Total	212.1 m2	YES	372.7 sqm	YES
EOD	0.00.4	VEO	0.50.4	\/50




Existing Ground Floor GFA

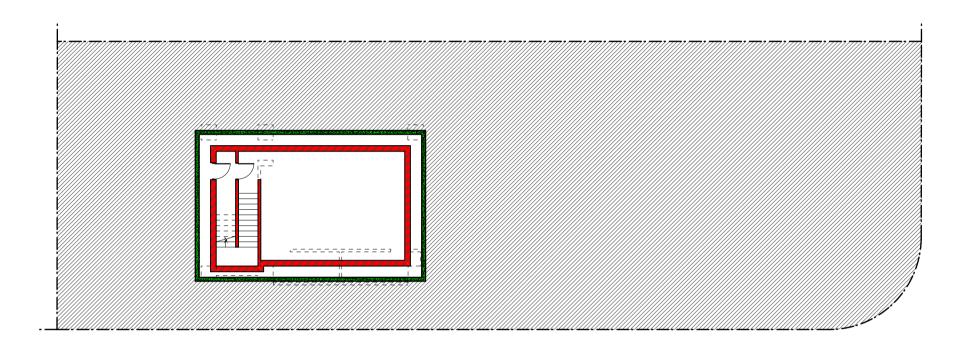

Proposed Basement Floor GFA

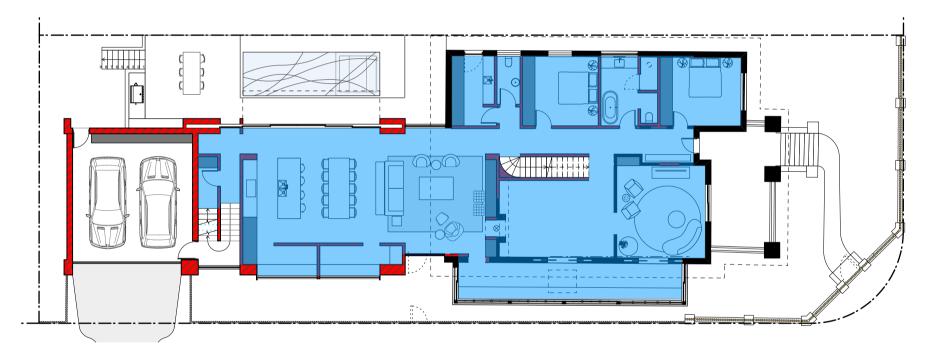

Proposed Ground Floor GFA

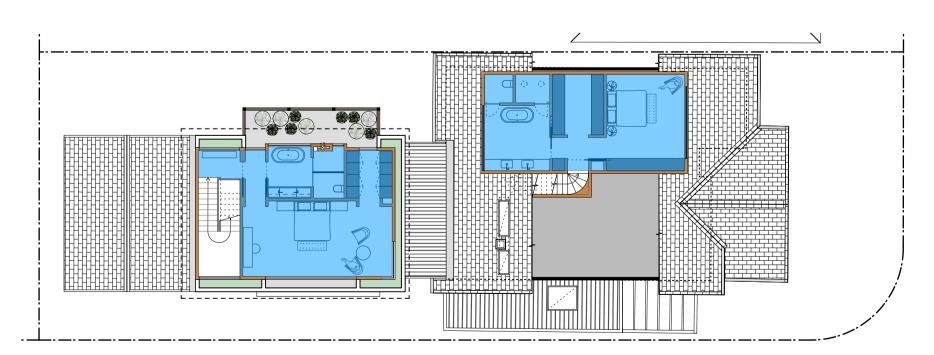

Proposed First Floor GFA





PO Box 849, Manly NSW 1655 info@bkharchitects.com.au 0422 392 710

Thomas Residence

32 Reddall Street Manly NSW

drawing title **COVER PAGE** 02.03.2021


project number

drawing number

A01-A

Development Application All works to be in accordance with Australian Standards, The Building Code of Australia, other relevant codes, and with Manufacturers' recommendations and instructions.

Do not scale from drawings. Verify all dimensions on site prior to construction. amendment

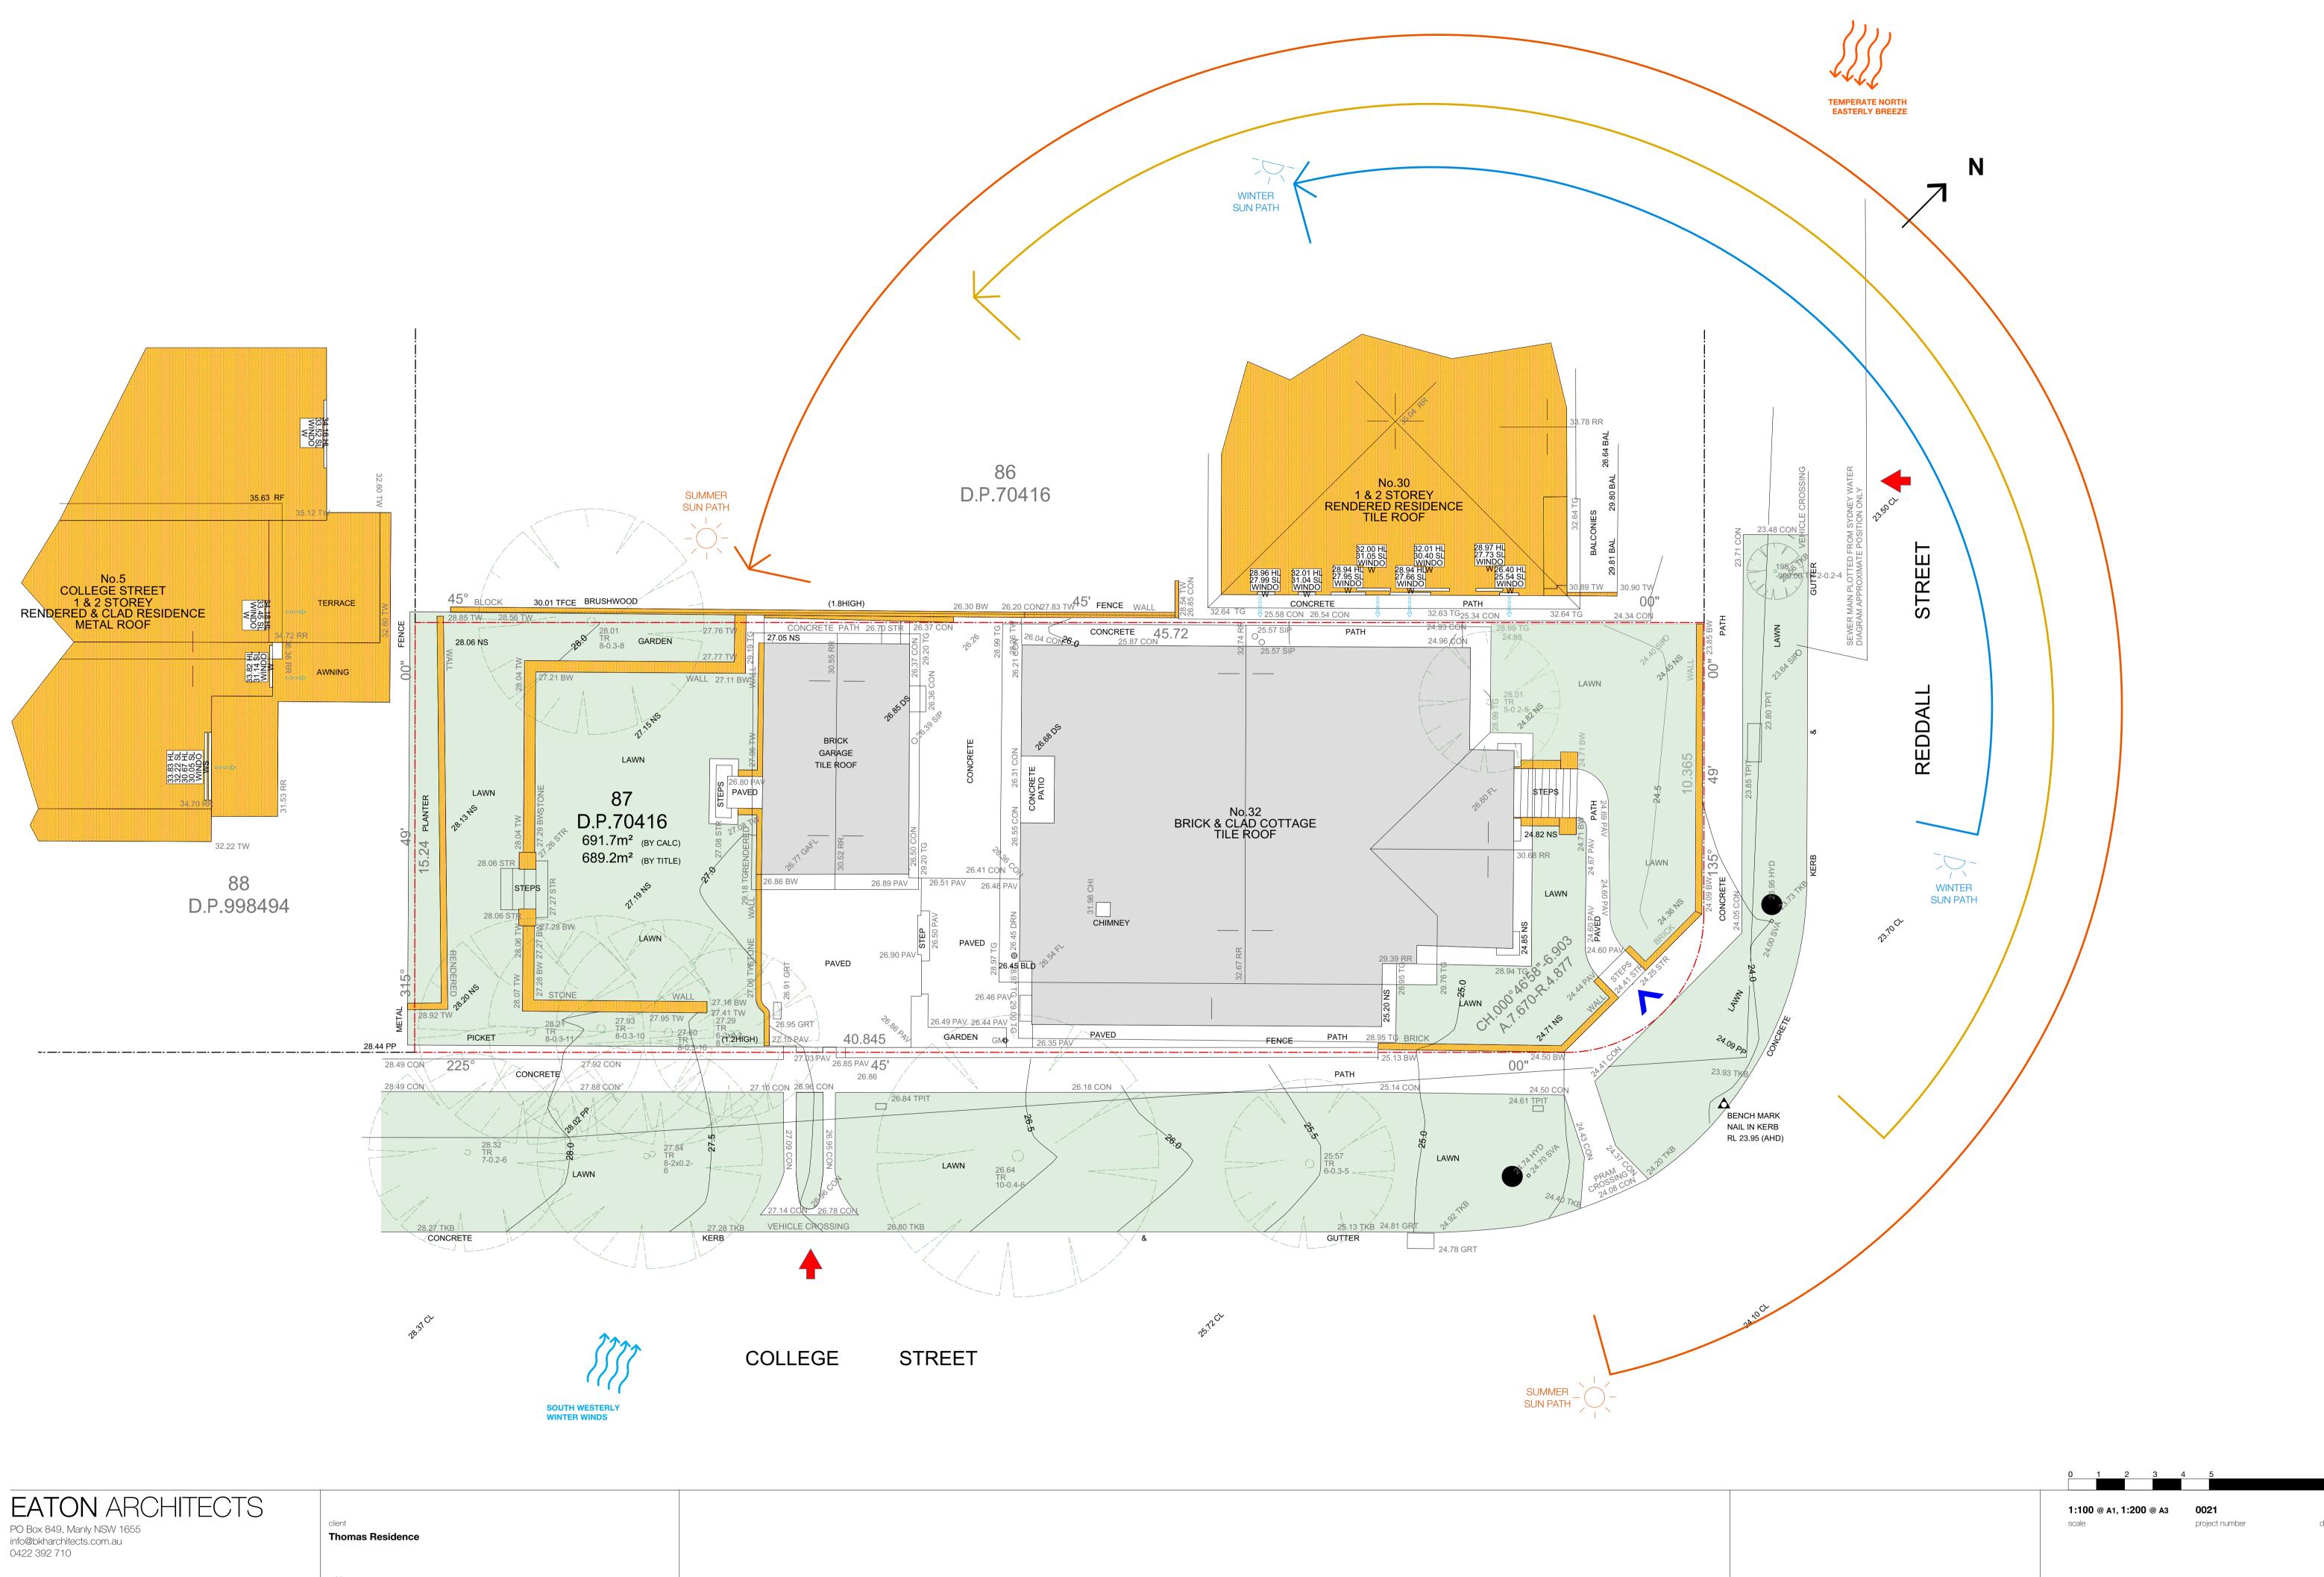


All works to be in accordance with Australian Standards, The Building Code of Australia, other relevant codes, and with Manufacturers' recommendations and instructions.


Do not scale from drawings. Verify all dimensions on site prior to construction.


32 Reddall Street Manly NSW


drawn by drawing title drawing number A02-A SITE ANALYSIS PLAN 02.03.2021 amendment

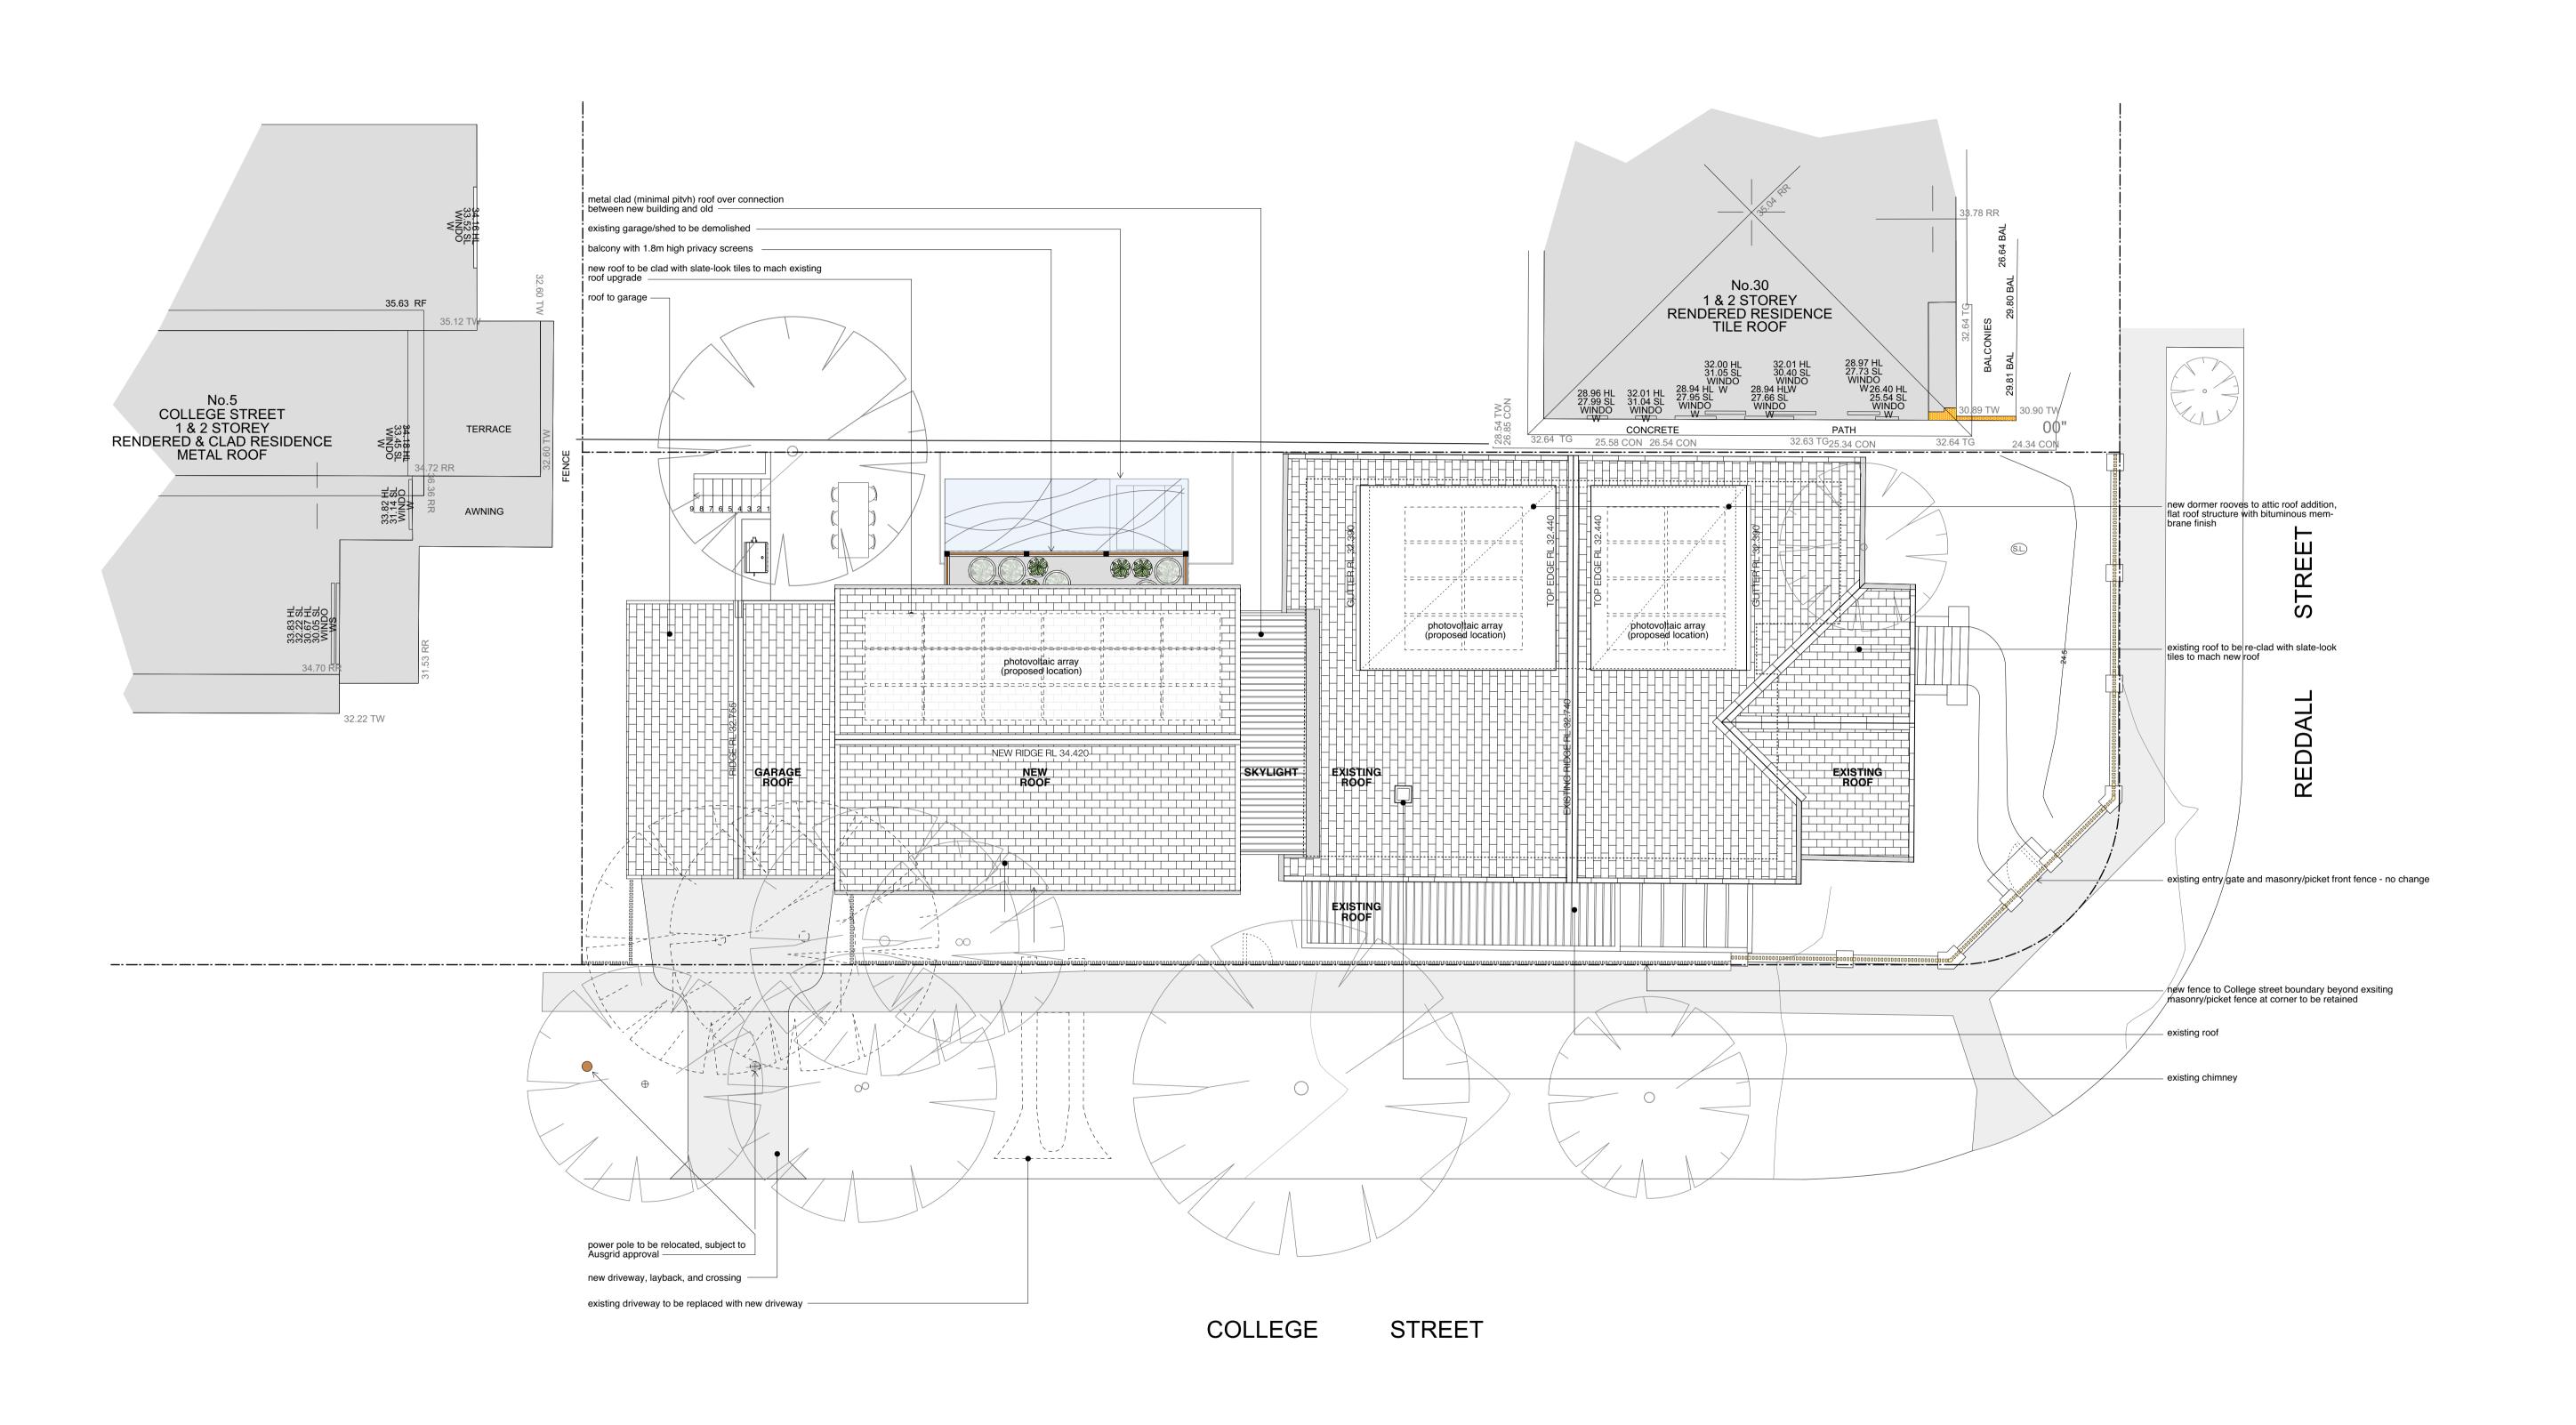



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EATON ARCHITECTS PO Box 849, Manly NSW 1655 info@bkharchitects.com.au 0422 392 710	client Thomas Residence			1:100 @ A1, 1:200 @ A3 scale	0021 project number	JE drawn by
	address 32 Reddall Street Manly NSW			drawing title		drawing number
All works to be in accordance with Australian Standards, The Building Code of Australia, other relevant codes, and with Manufacturers' recommendations and instructions. Do not scale from drawings. Verify all dimensions on site prior to construction.		A Development Application 02 amendment	2.03.2021	SITE PLAN		A03-A

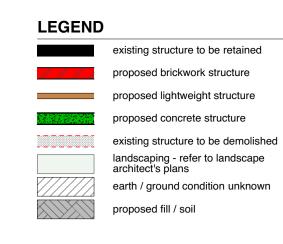


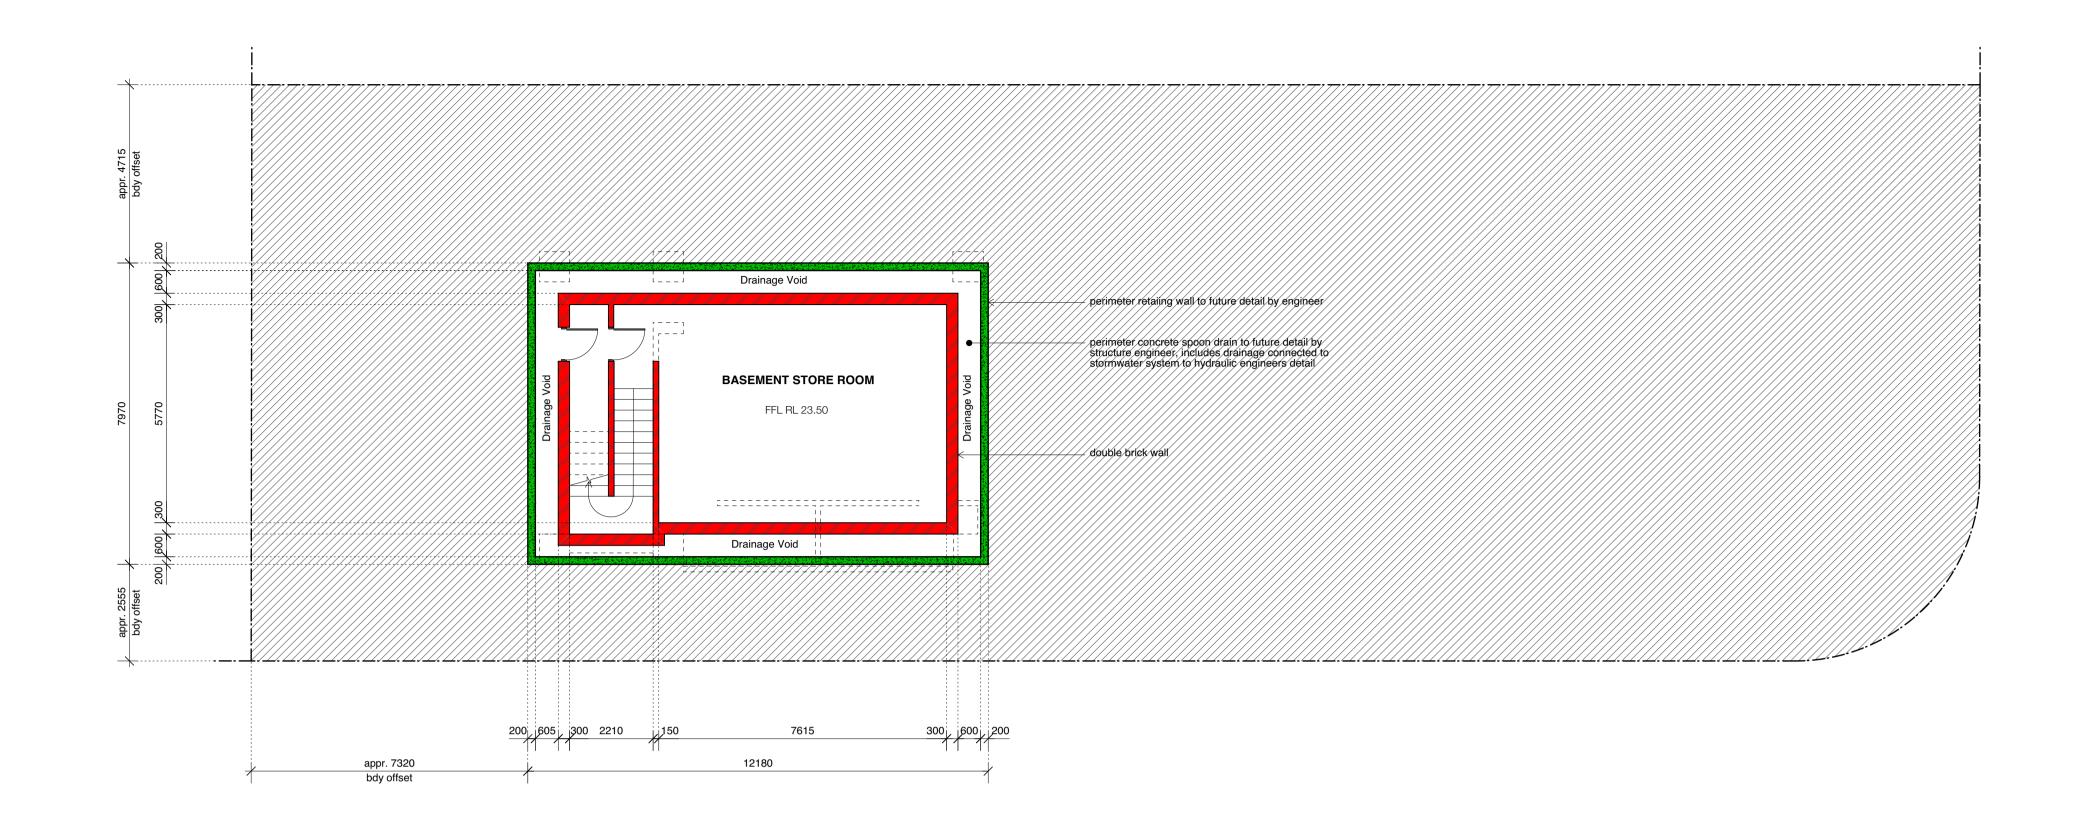


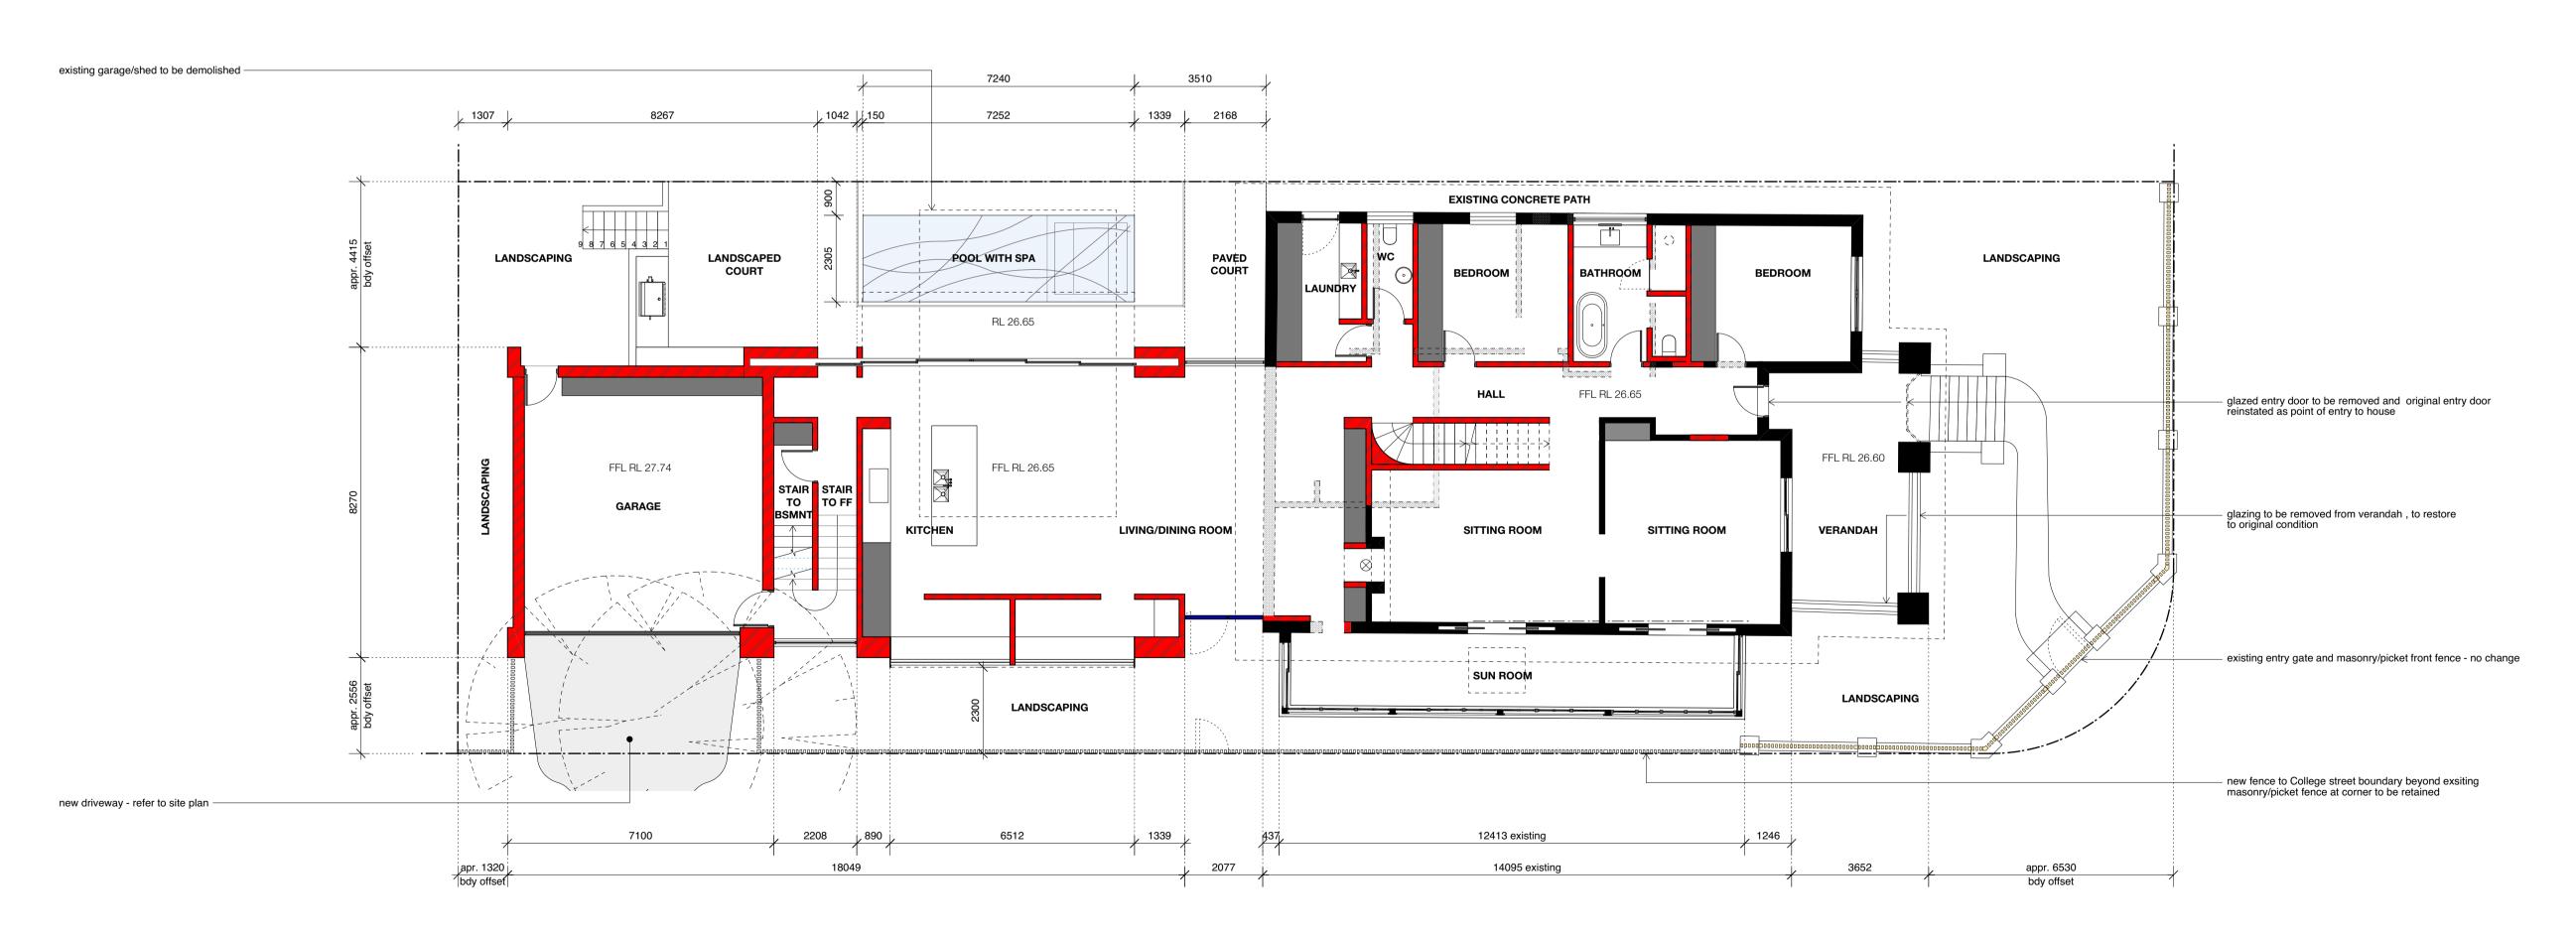

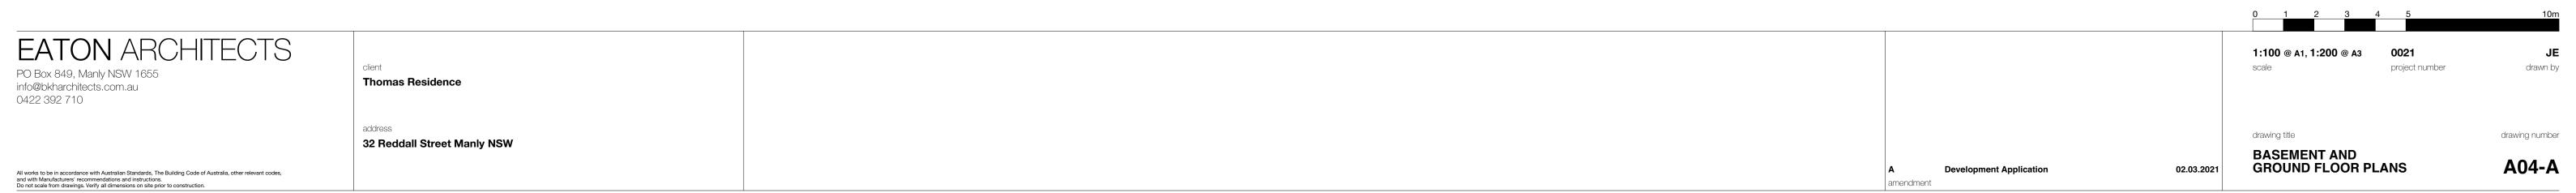

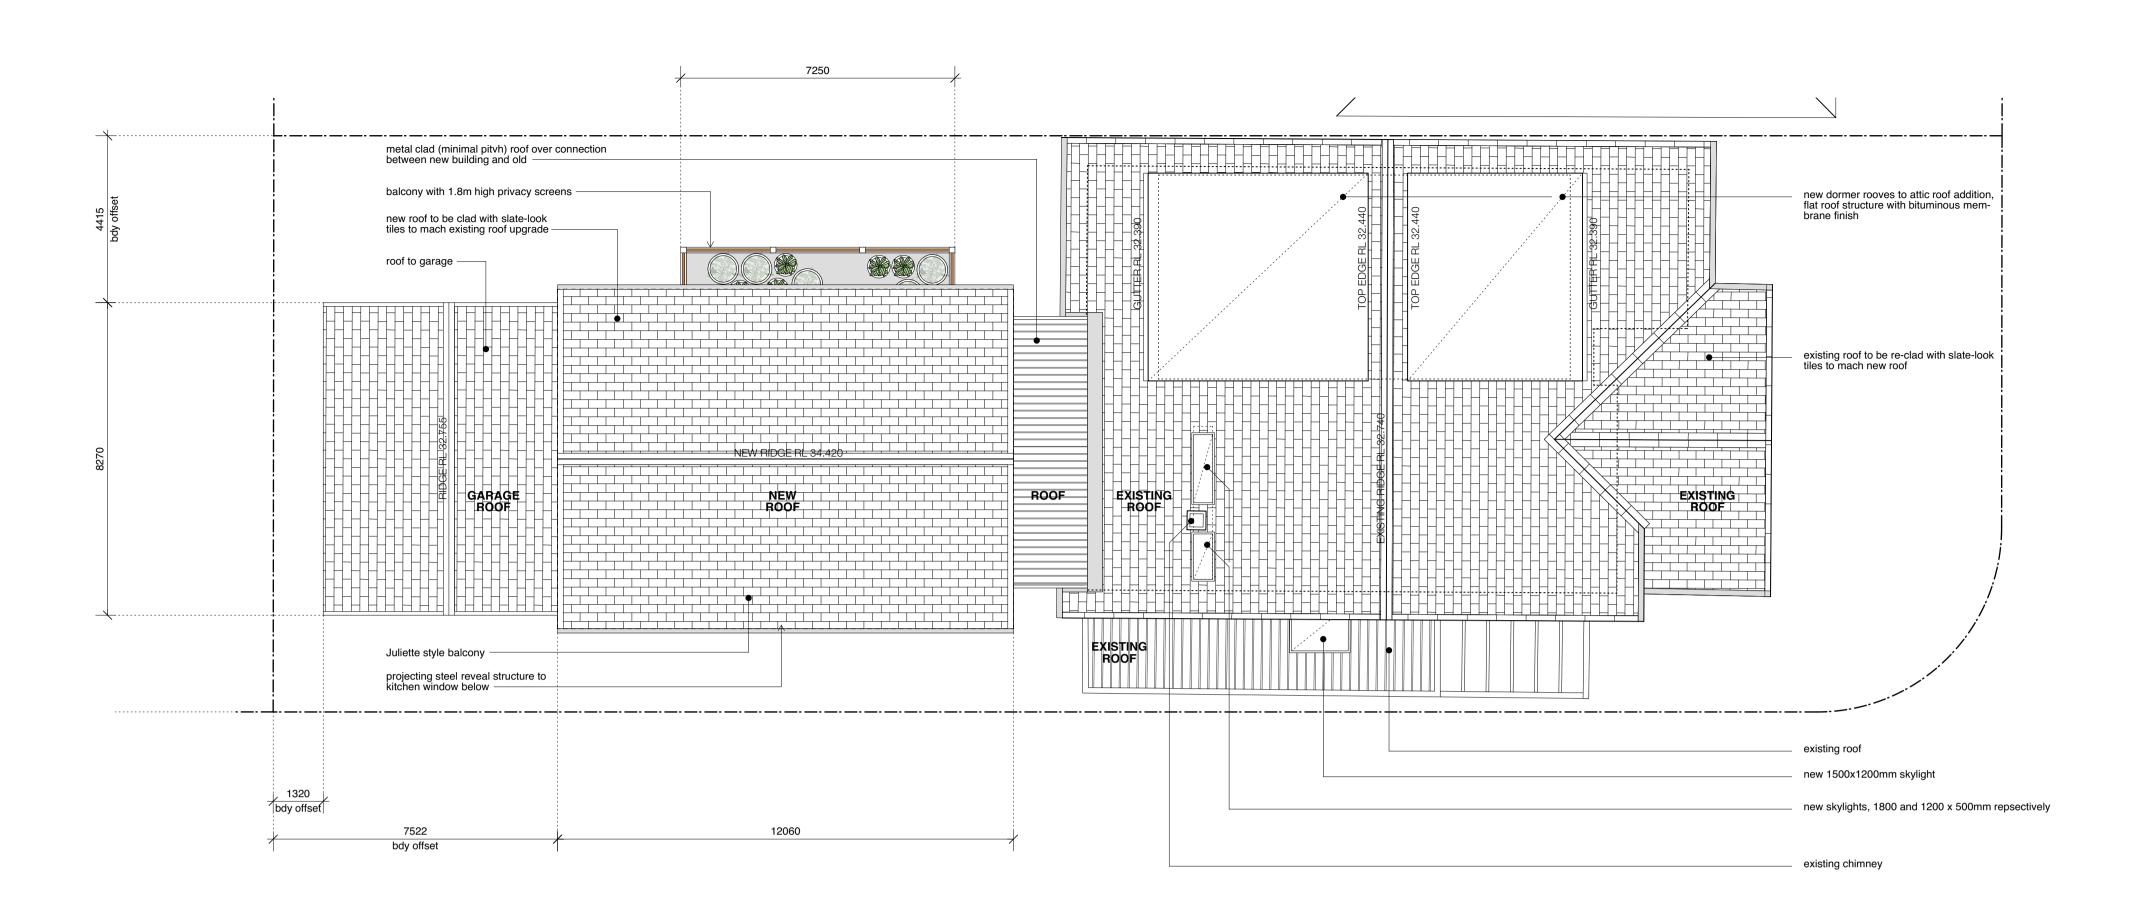


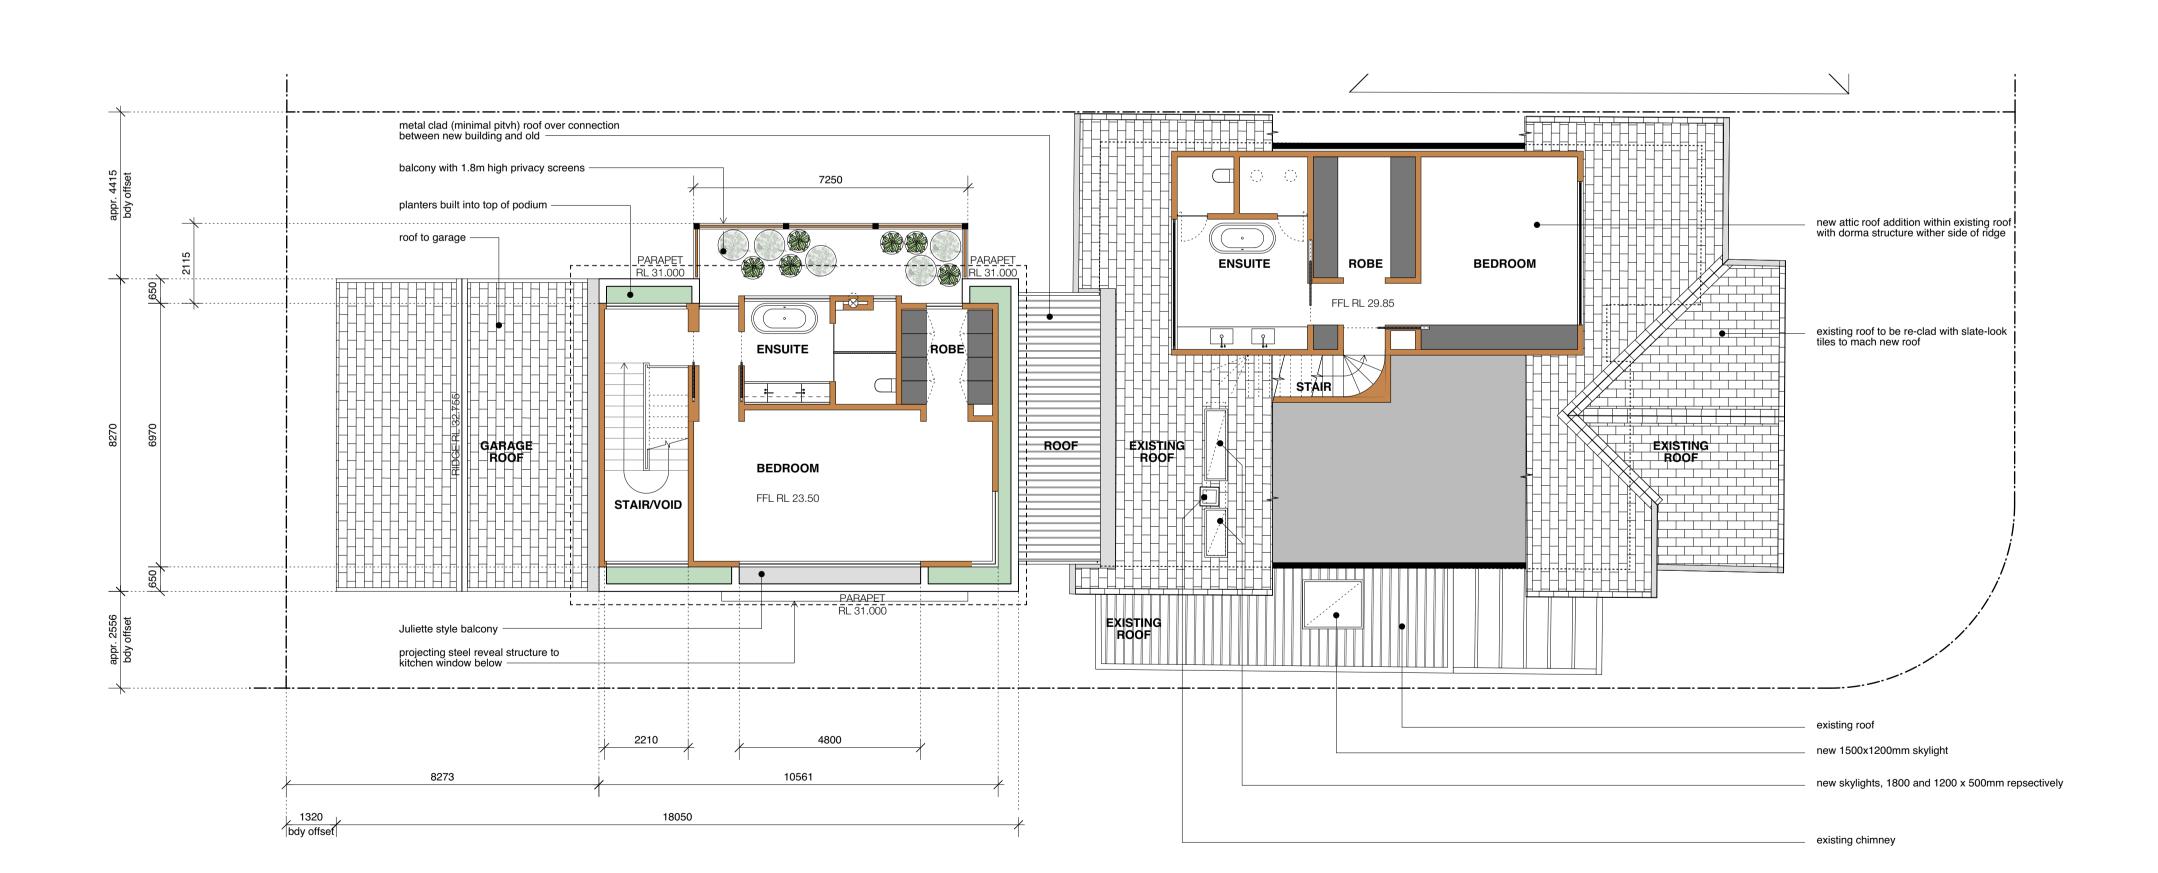

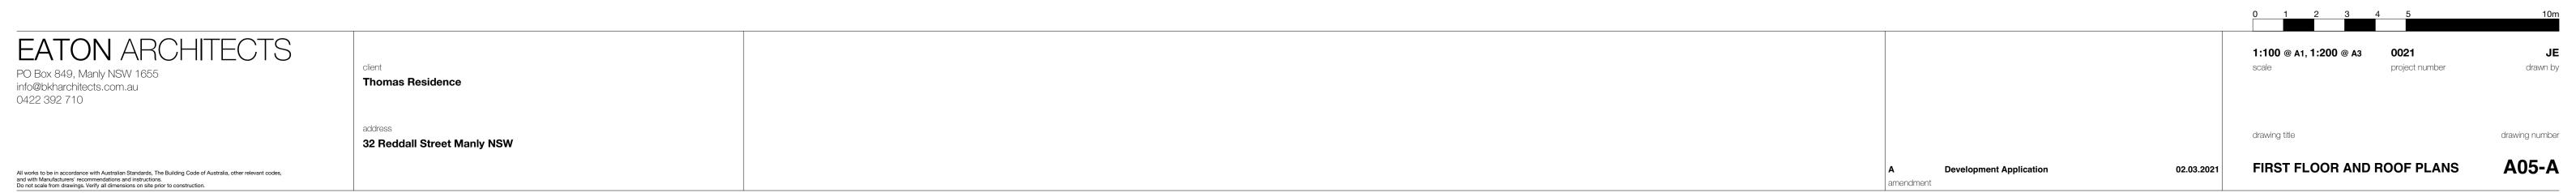

existing structure to be retained
proposed brickwork structure
proposed lightweight structure
proposed concrete structure
existing structure to be demolished
landscaping - refer to landscape
architect's plans
earth / ground condition unknown

proposed fill / soil

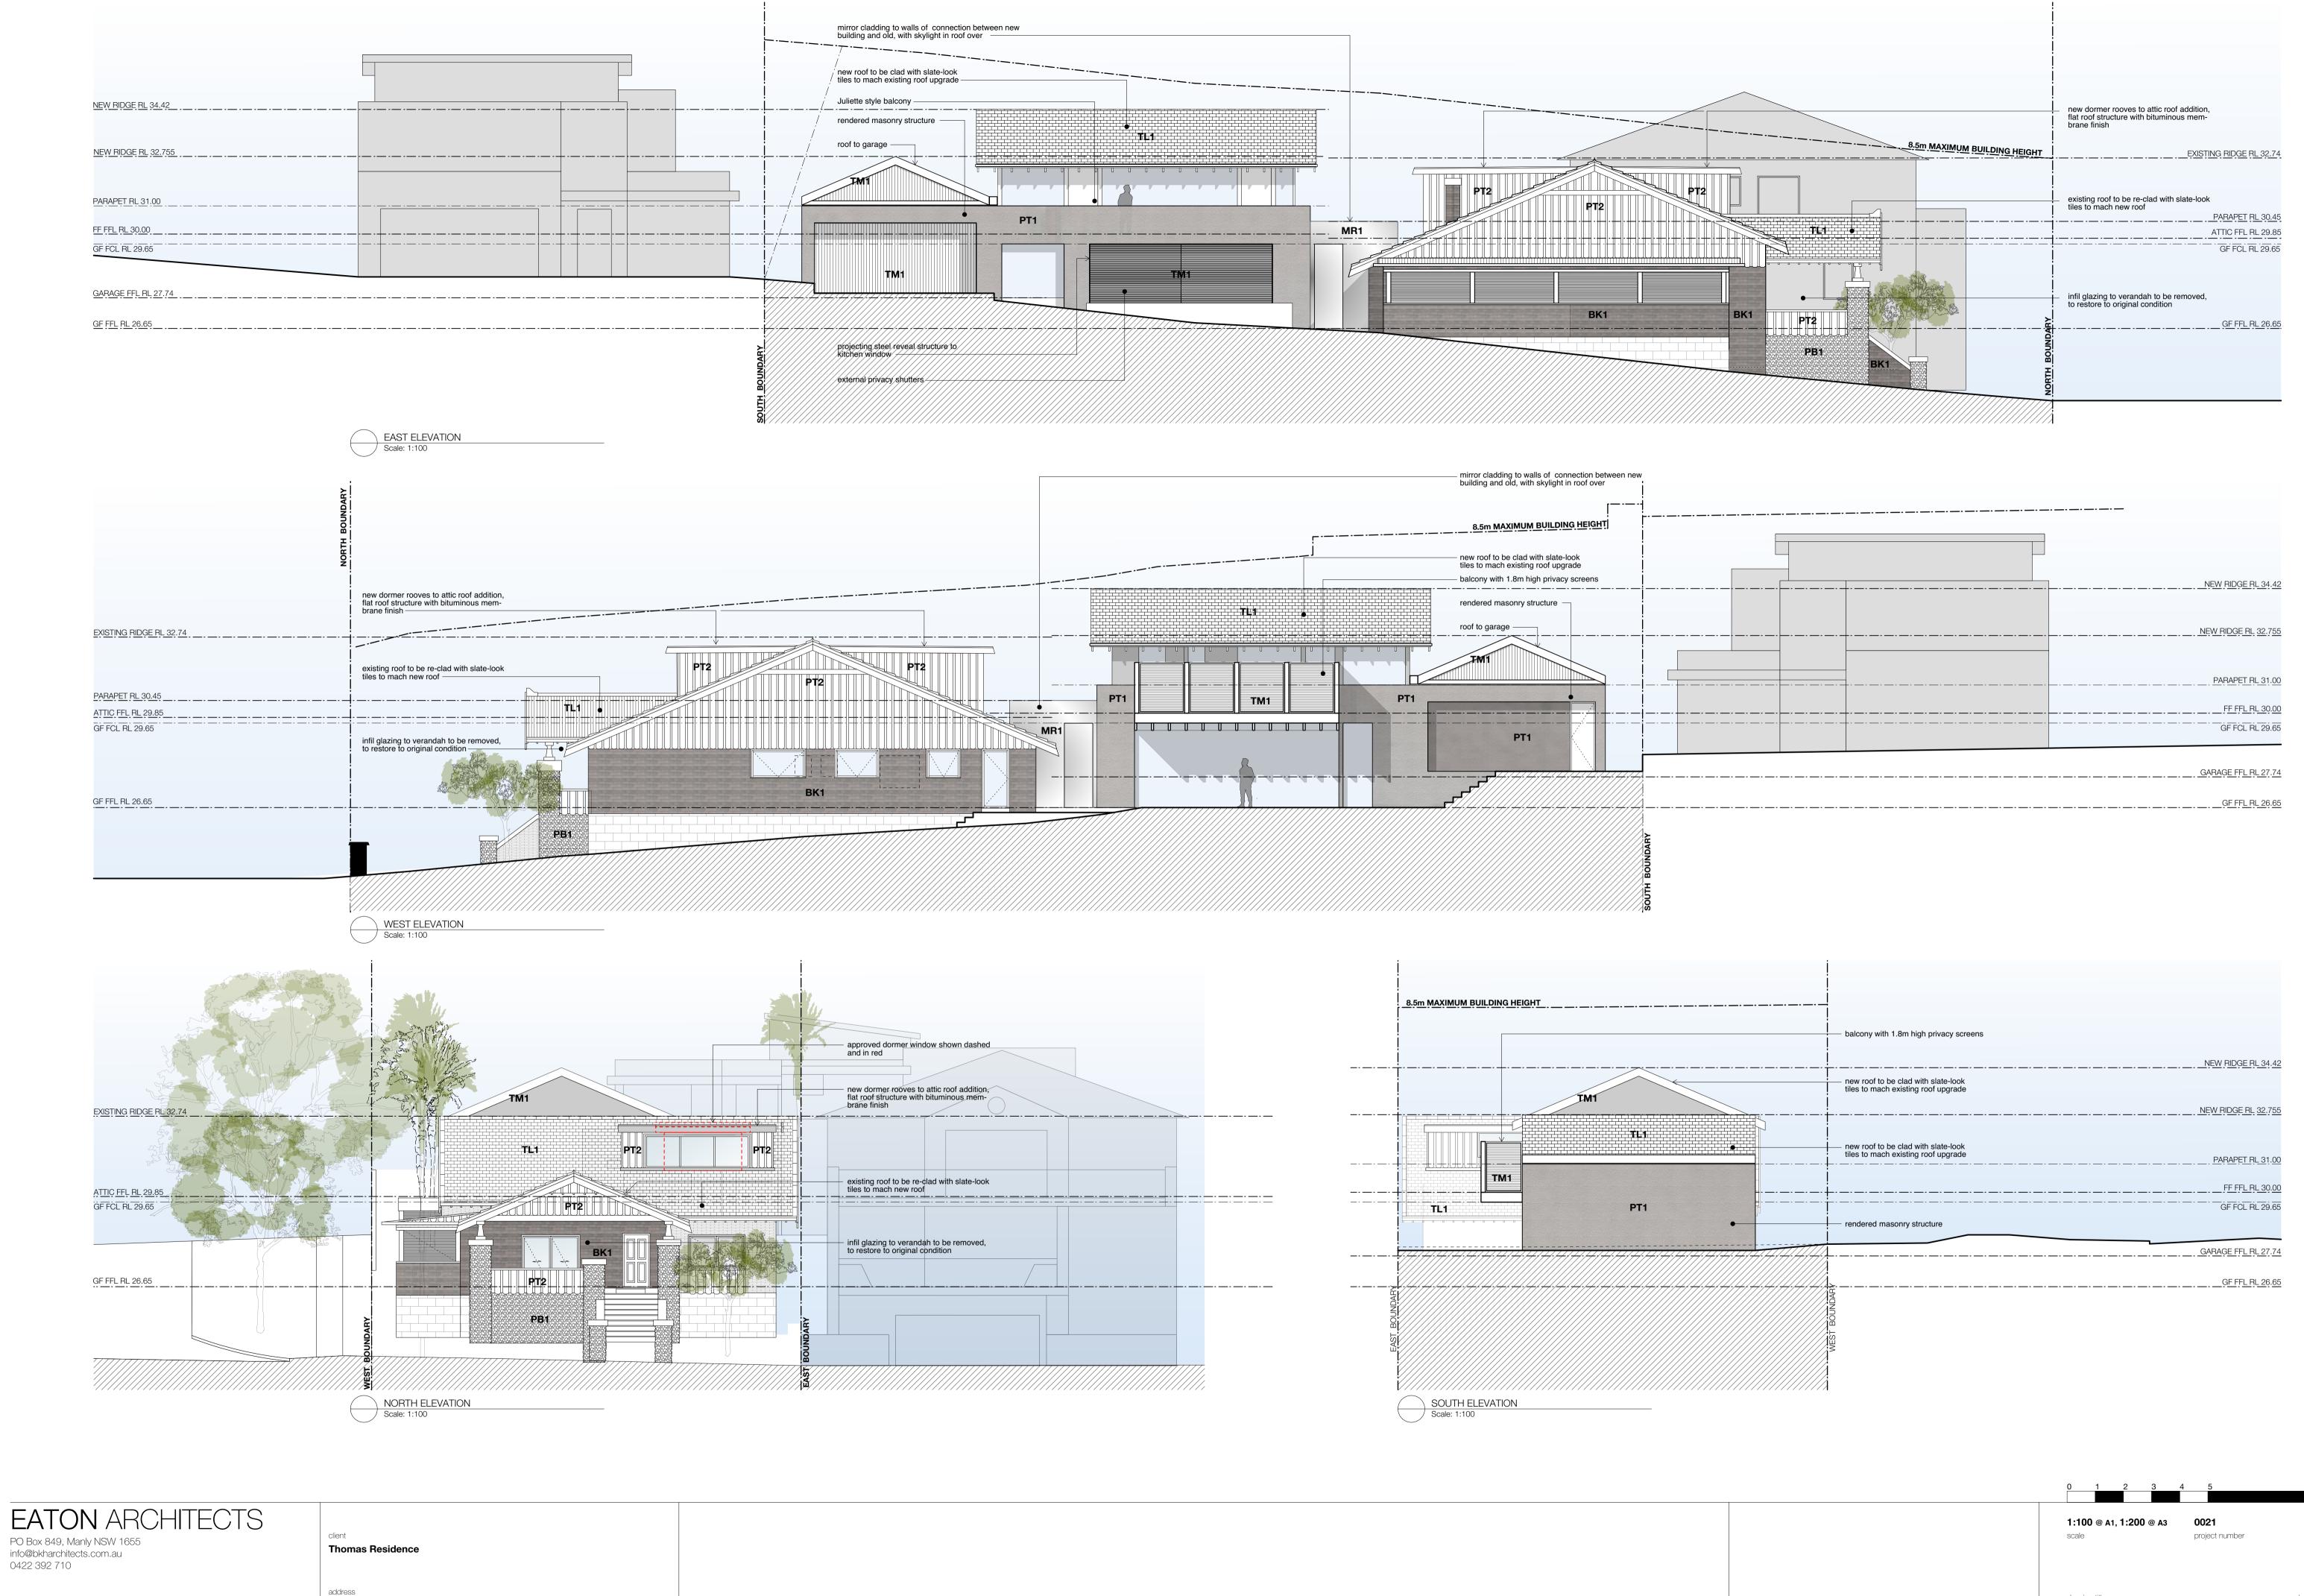


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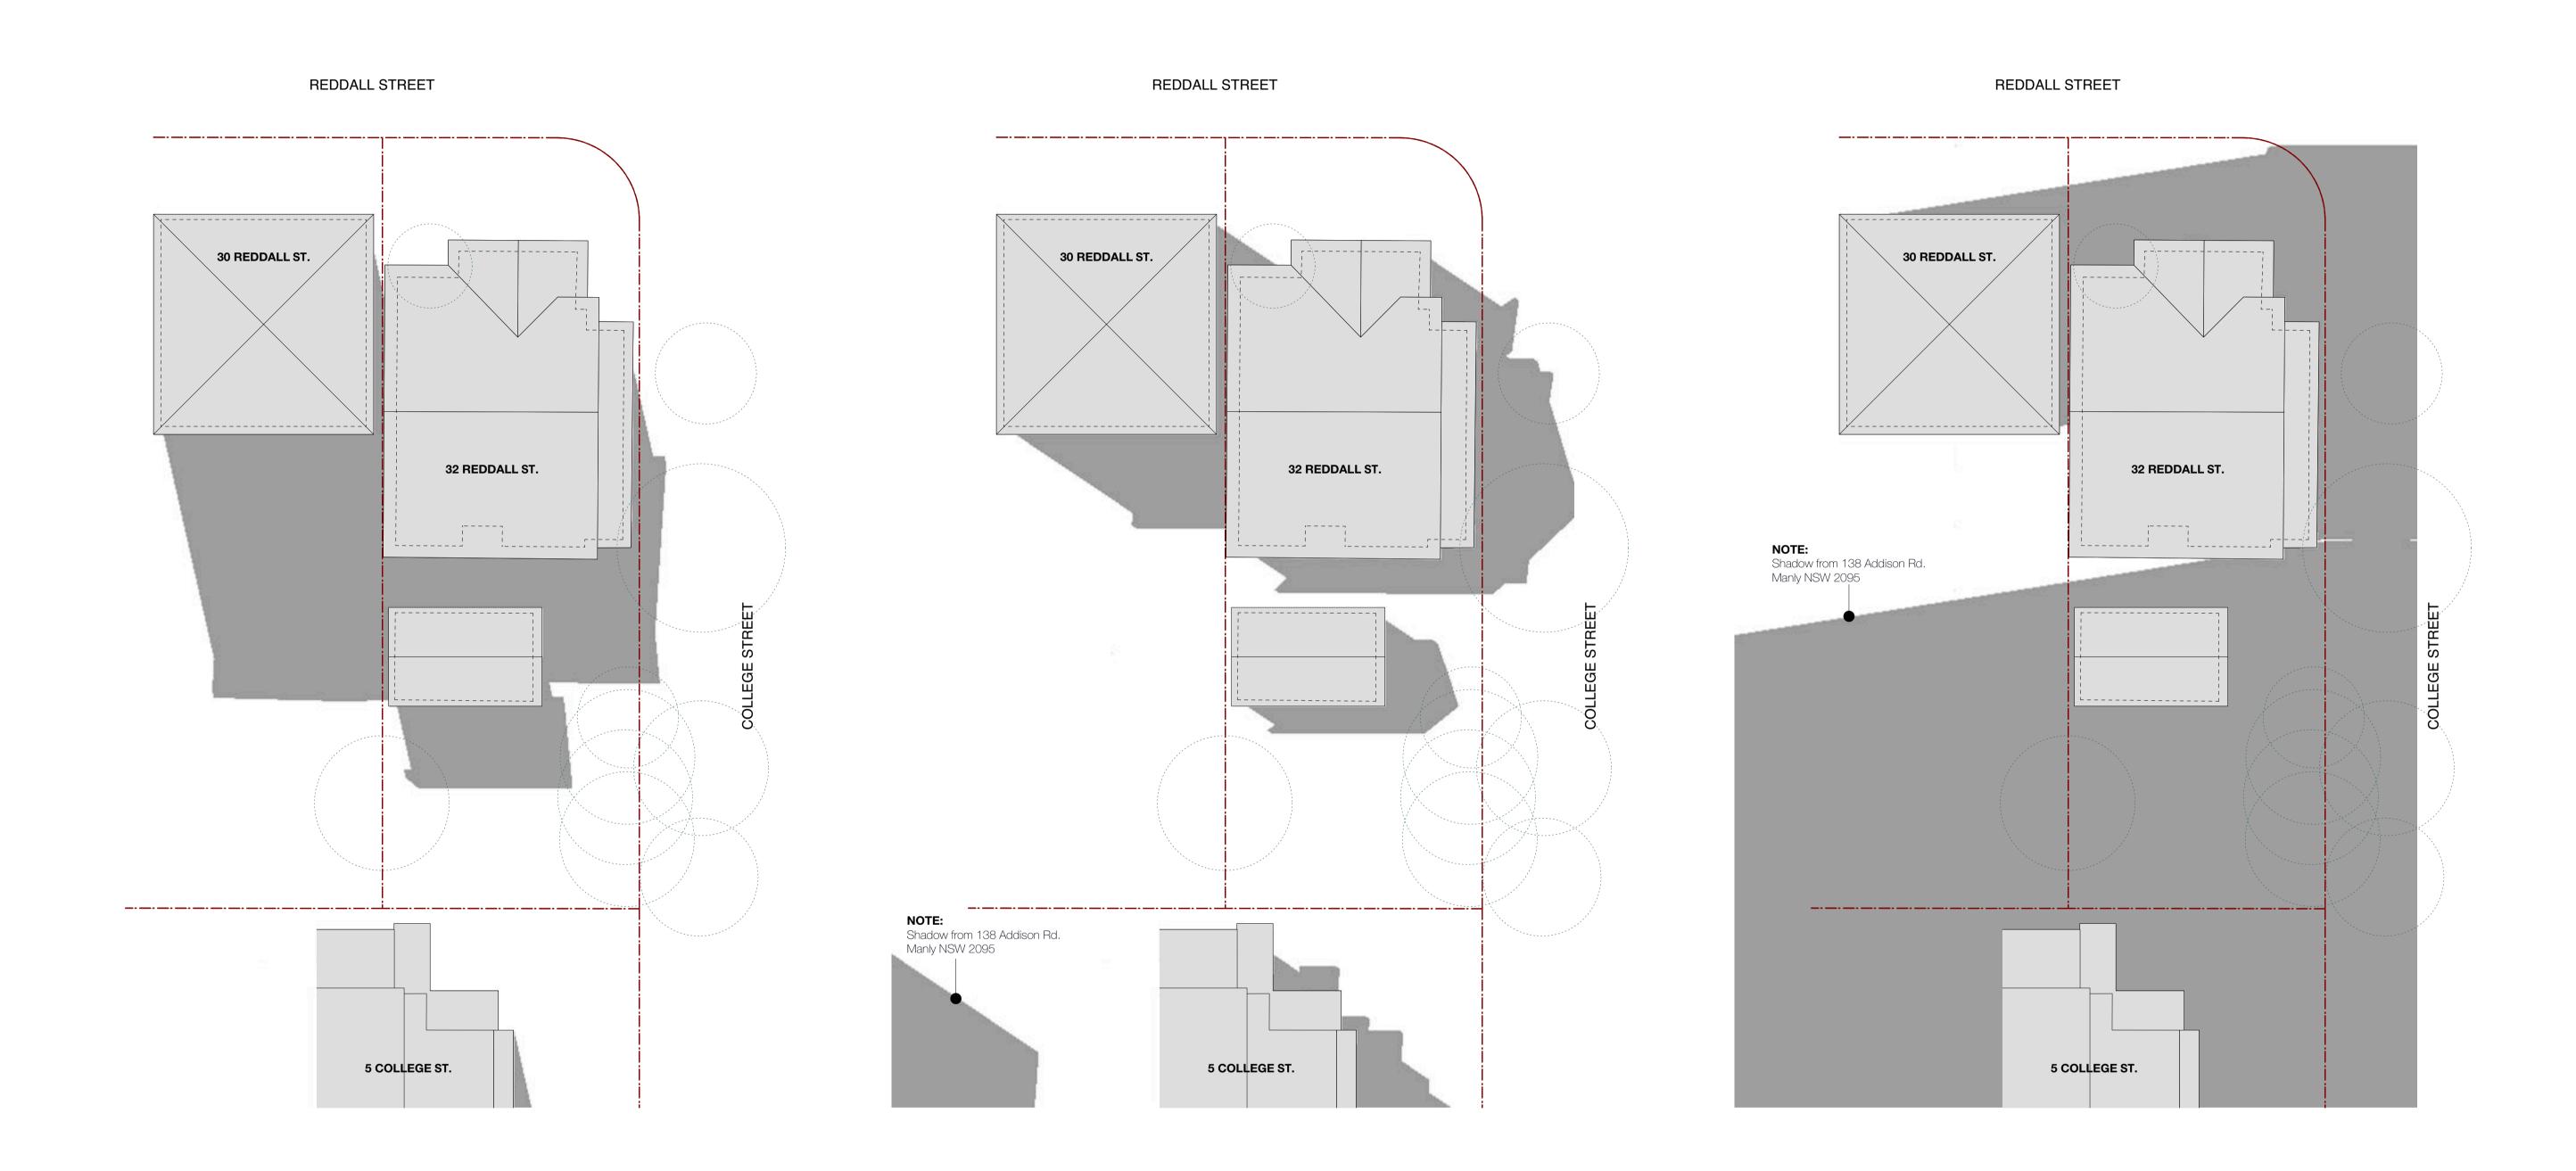
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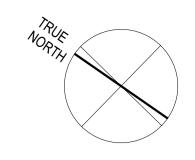



EXISTING SHADOW - 21 June 9:00 am EXISTING SHADOW - 21 June 12:00 pm EXISTING SHADOW - 21 June 3:00 pm

EATON ARCHITECTS 1:200 @ A1 client project number drawn by PO Box 849, Manly NSW 1655 info@bkharchitects.com.au 0422 392 710 **Thomas Residence** drawing number 32 Reddall Street Manly NSW **SHADOW DIAGRAMS** A07-A **EXISTING SHADOWS** 02.03.2021 All works to be in accordance with Australian Standards, The Building Code of Australia, other relevant codes, and with Manufacturers' recommendations and instructions.

Do not scale from drawings. Verify all dimensions on site prior to construction.


amendment

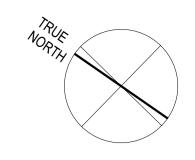

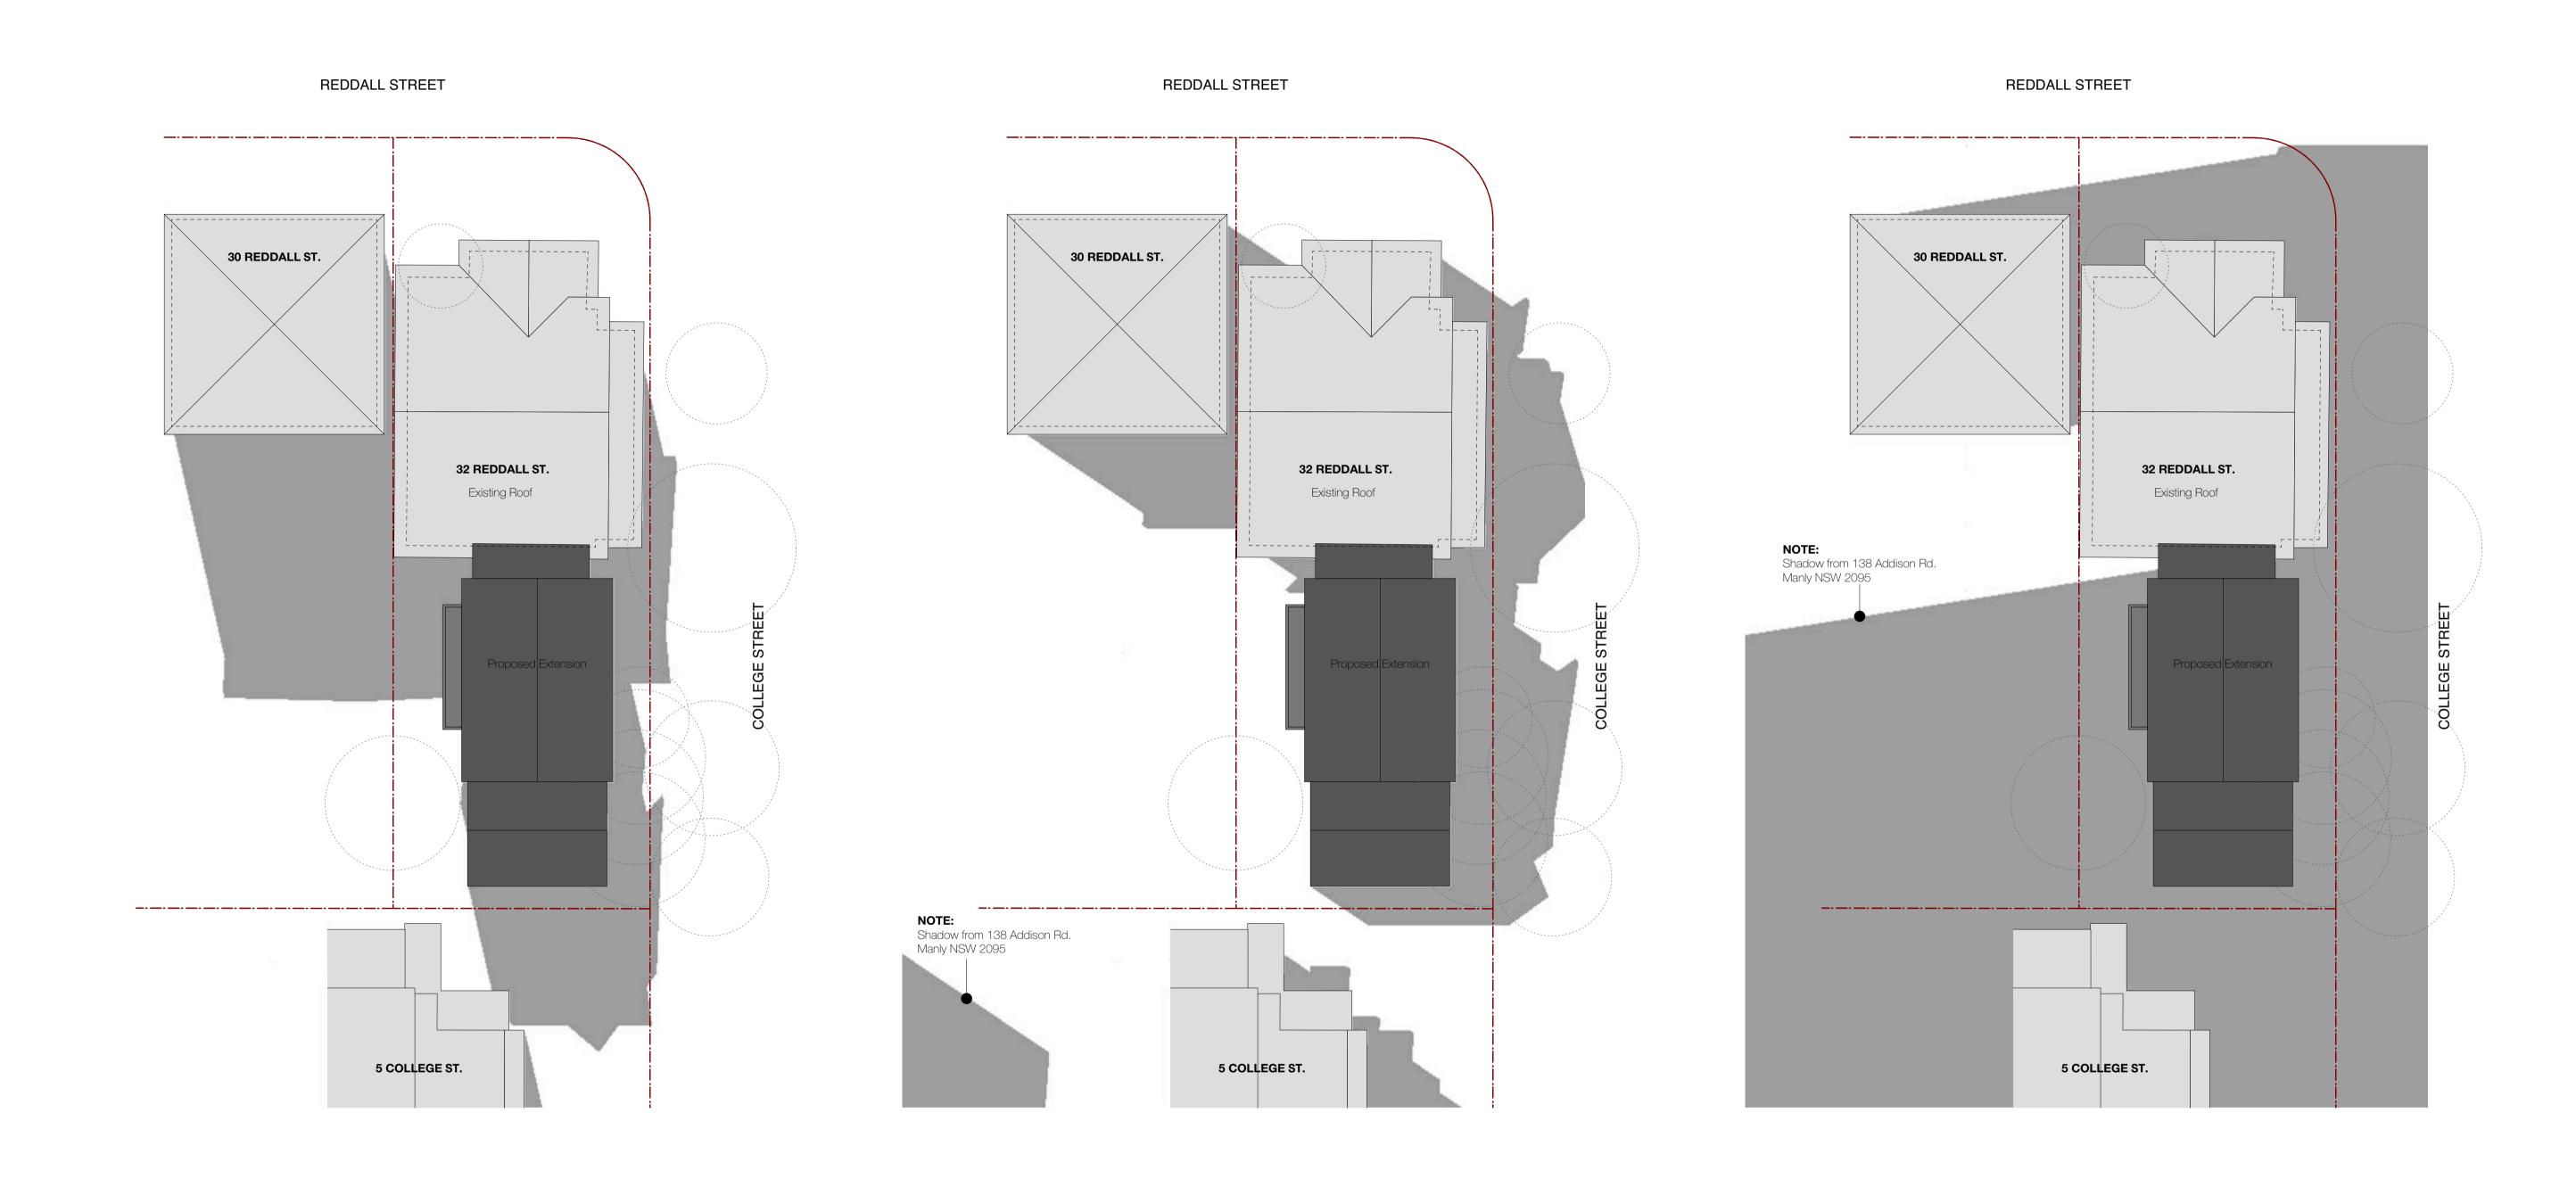

PROPOSED SHADOW - 21 June 9:00 am PROPOSED SHADOW - 21 June 12:00 pm PROPOSED SHADOW - 21 June 3:00 pm

amendment

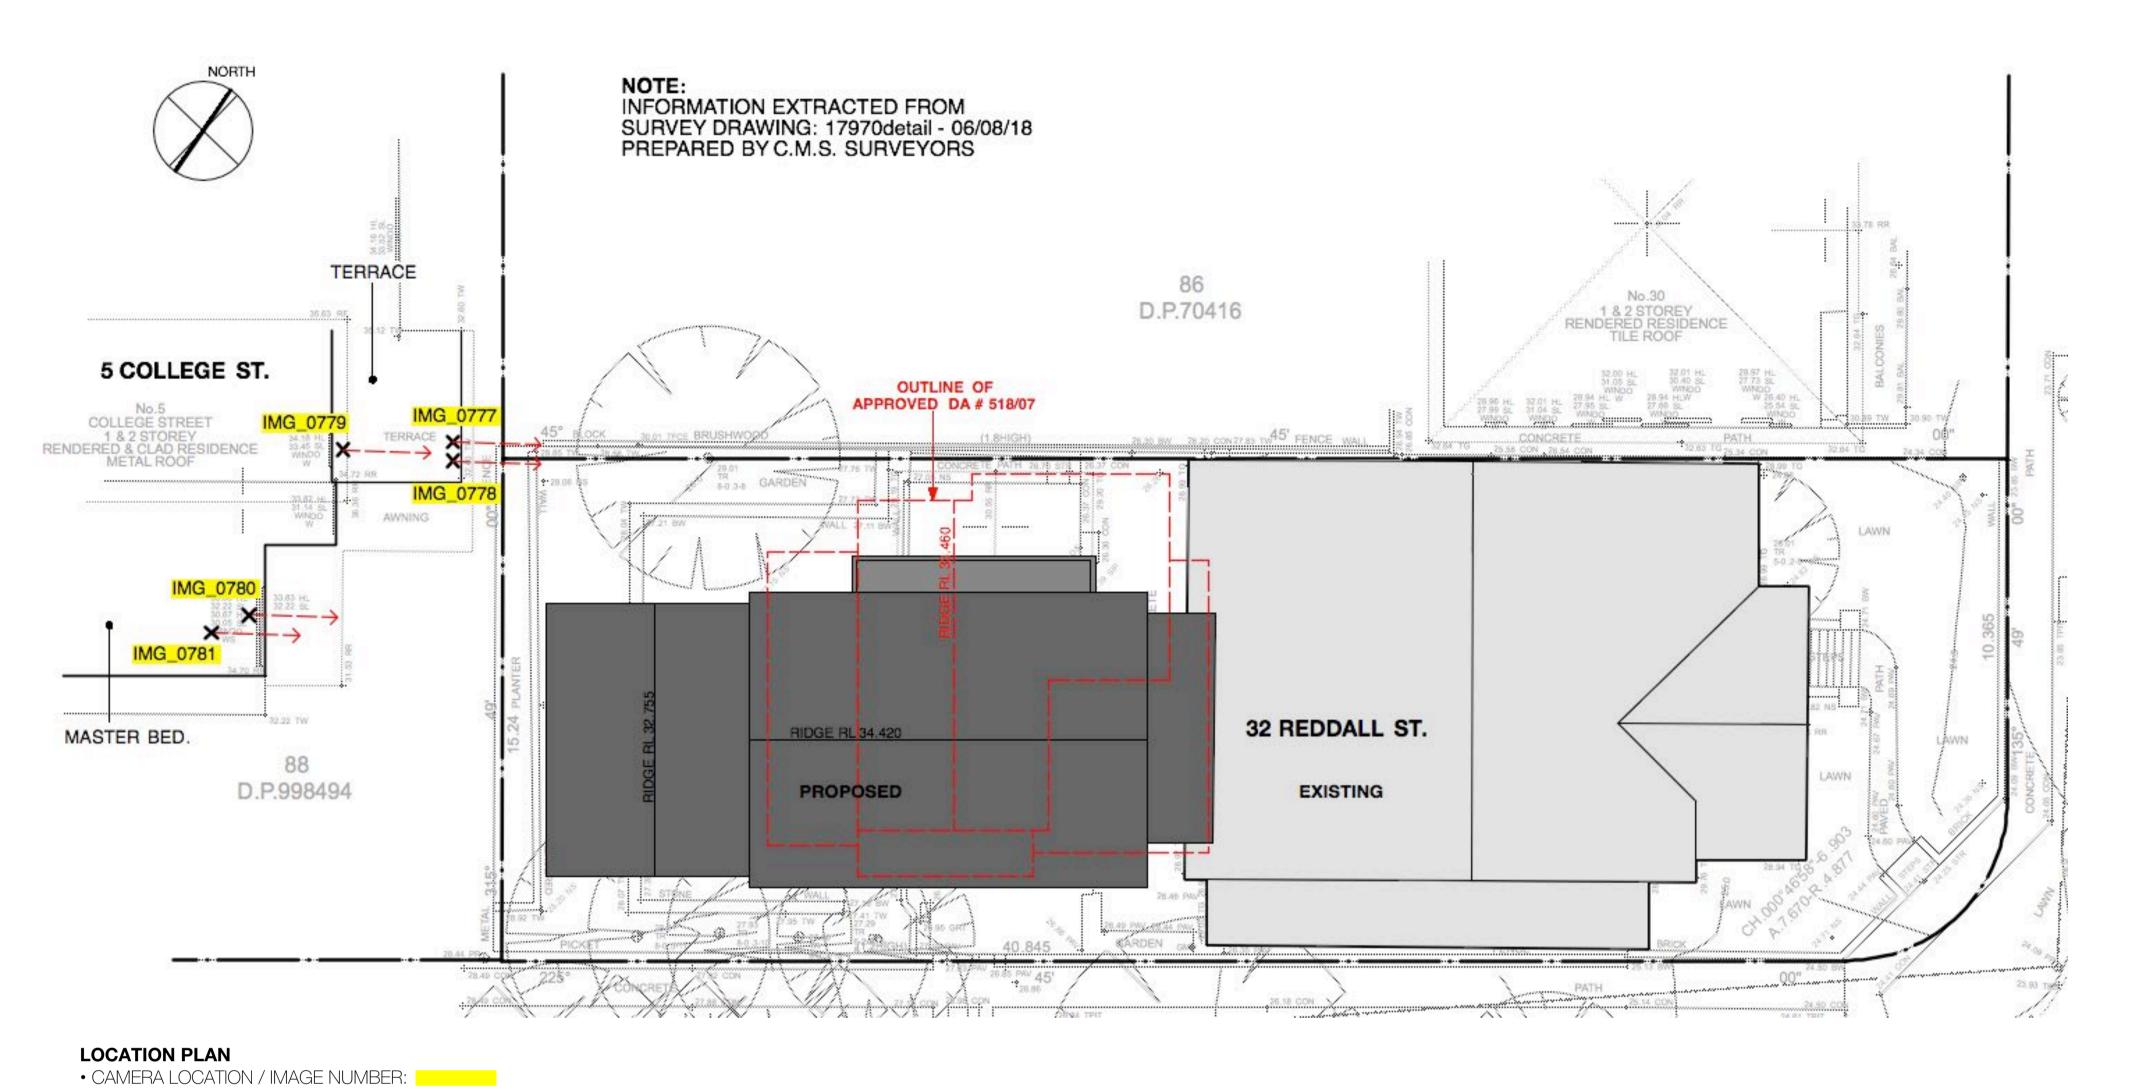


OUTLINE OF EXPENSION

OUTLINE OF APPROVED DAY 578/07

VIEW ANALYSIS REFERENCE IMAGE: IMG_0780

OUTLINE OF PROPOSED EXTENSION

OUTLINE OF APPROVED DA # 518/07

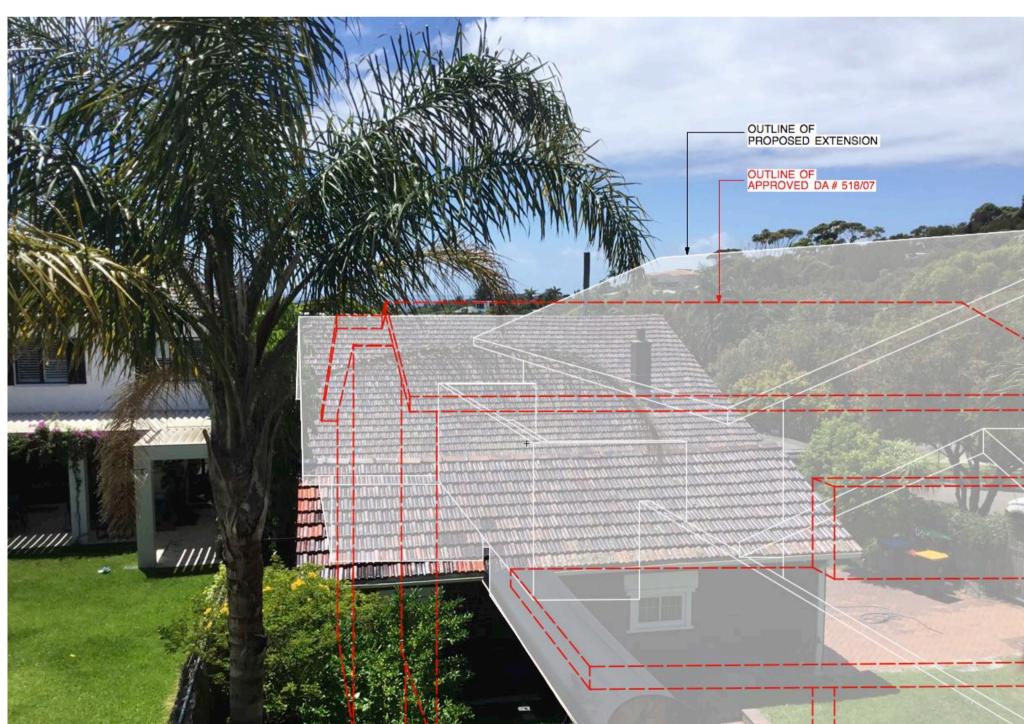





VIEW ANALYSIS REFERENCE IMAGE: IMG_0781

VIEW ANALYSIS
REFERENCE IMAGE: IMG_0777

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PO Box 849, Manly NSW 1655
info@bkharchitects.com.au
0422 392 710

All works to be in accordance with Australian Standards, The Building Code of Australia, other relevant codes, and with Manufacturers' recommendations and instructions.

Do not scale from drawings. Verify all dimensions on site prior to construction.

client
Thomas Residence

address
32 Reddall Street Manly NSW

32 REDDALL STREET, MANLY, NSW 2095

Landscape Documentation for Development Application

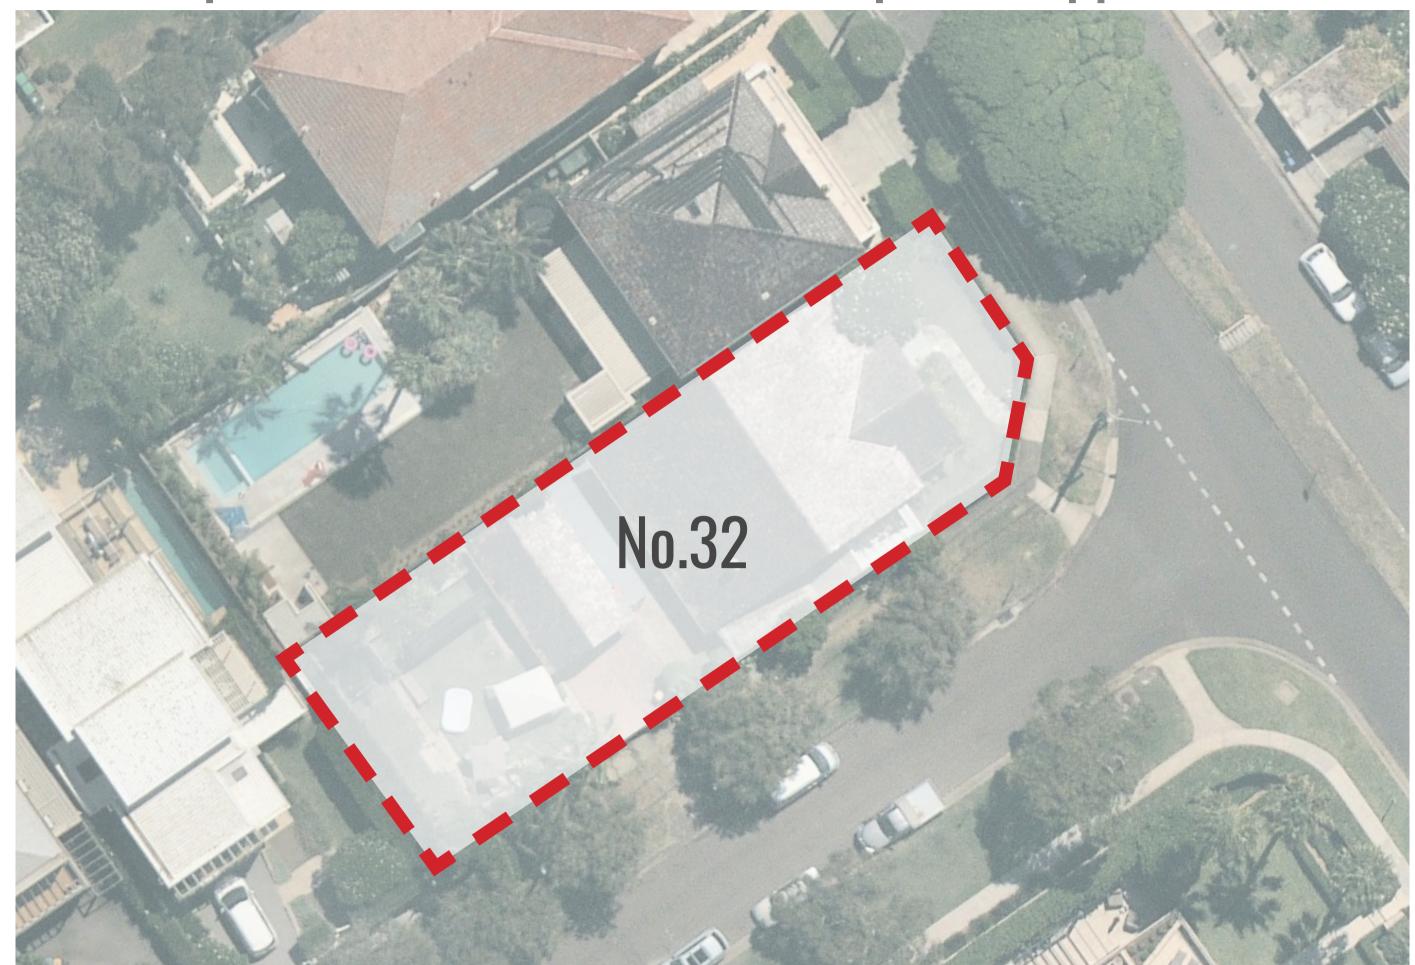


IMAGE TAKEN FROM NEARMAP 2019

Drawing Register

Dwg No.	Drawing Name
LDA-00	Cover Page

Landscape Plan LDA-01

LDA-02 Specification & Details Planting Schedule & Imagery **LDA-03**



COLLEGE STREET

SITE PLAN


Drawing Title: Landscape Cover Sheet DWG No:





Client:	

Scale:	Date:	Job Number:	North:	Revis	sion	FOR DEVELOPN	IENT APF	PLICATION
1:NTS @ A1	05 00 0001	100000		Rev	Date	Description	Drawn	Checked
1:NTS @ A3	25.02.2021	190320		A	10.05.19	FOR DA	TW	LW
	20 D	C		В	20.05.19	STORM-WATER INCORPORATED	TW	BG
Project:	32 REI	dall Street		C	05.02.21	REVISED ARCHITECTURE BASE	TW	BG
			MANIY. NSW 2095	D	25.02.21	STORMWATER INCORPORATED	TW	BG

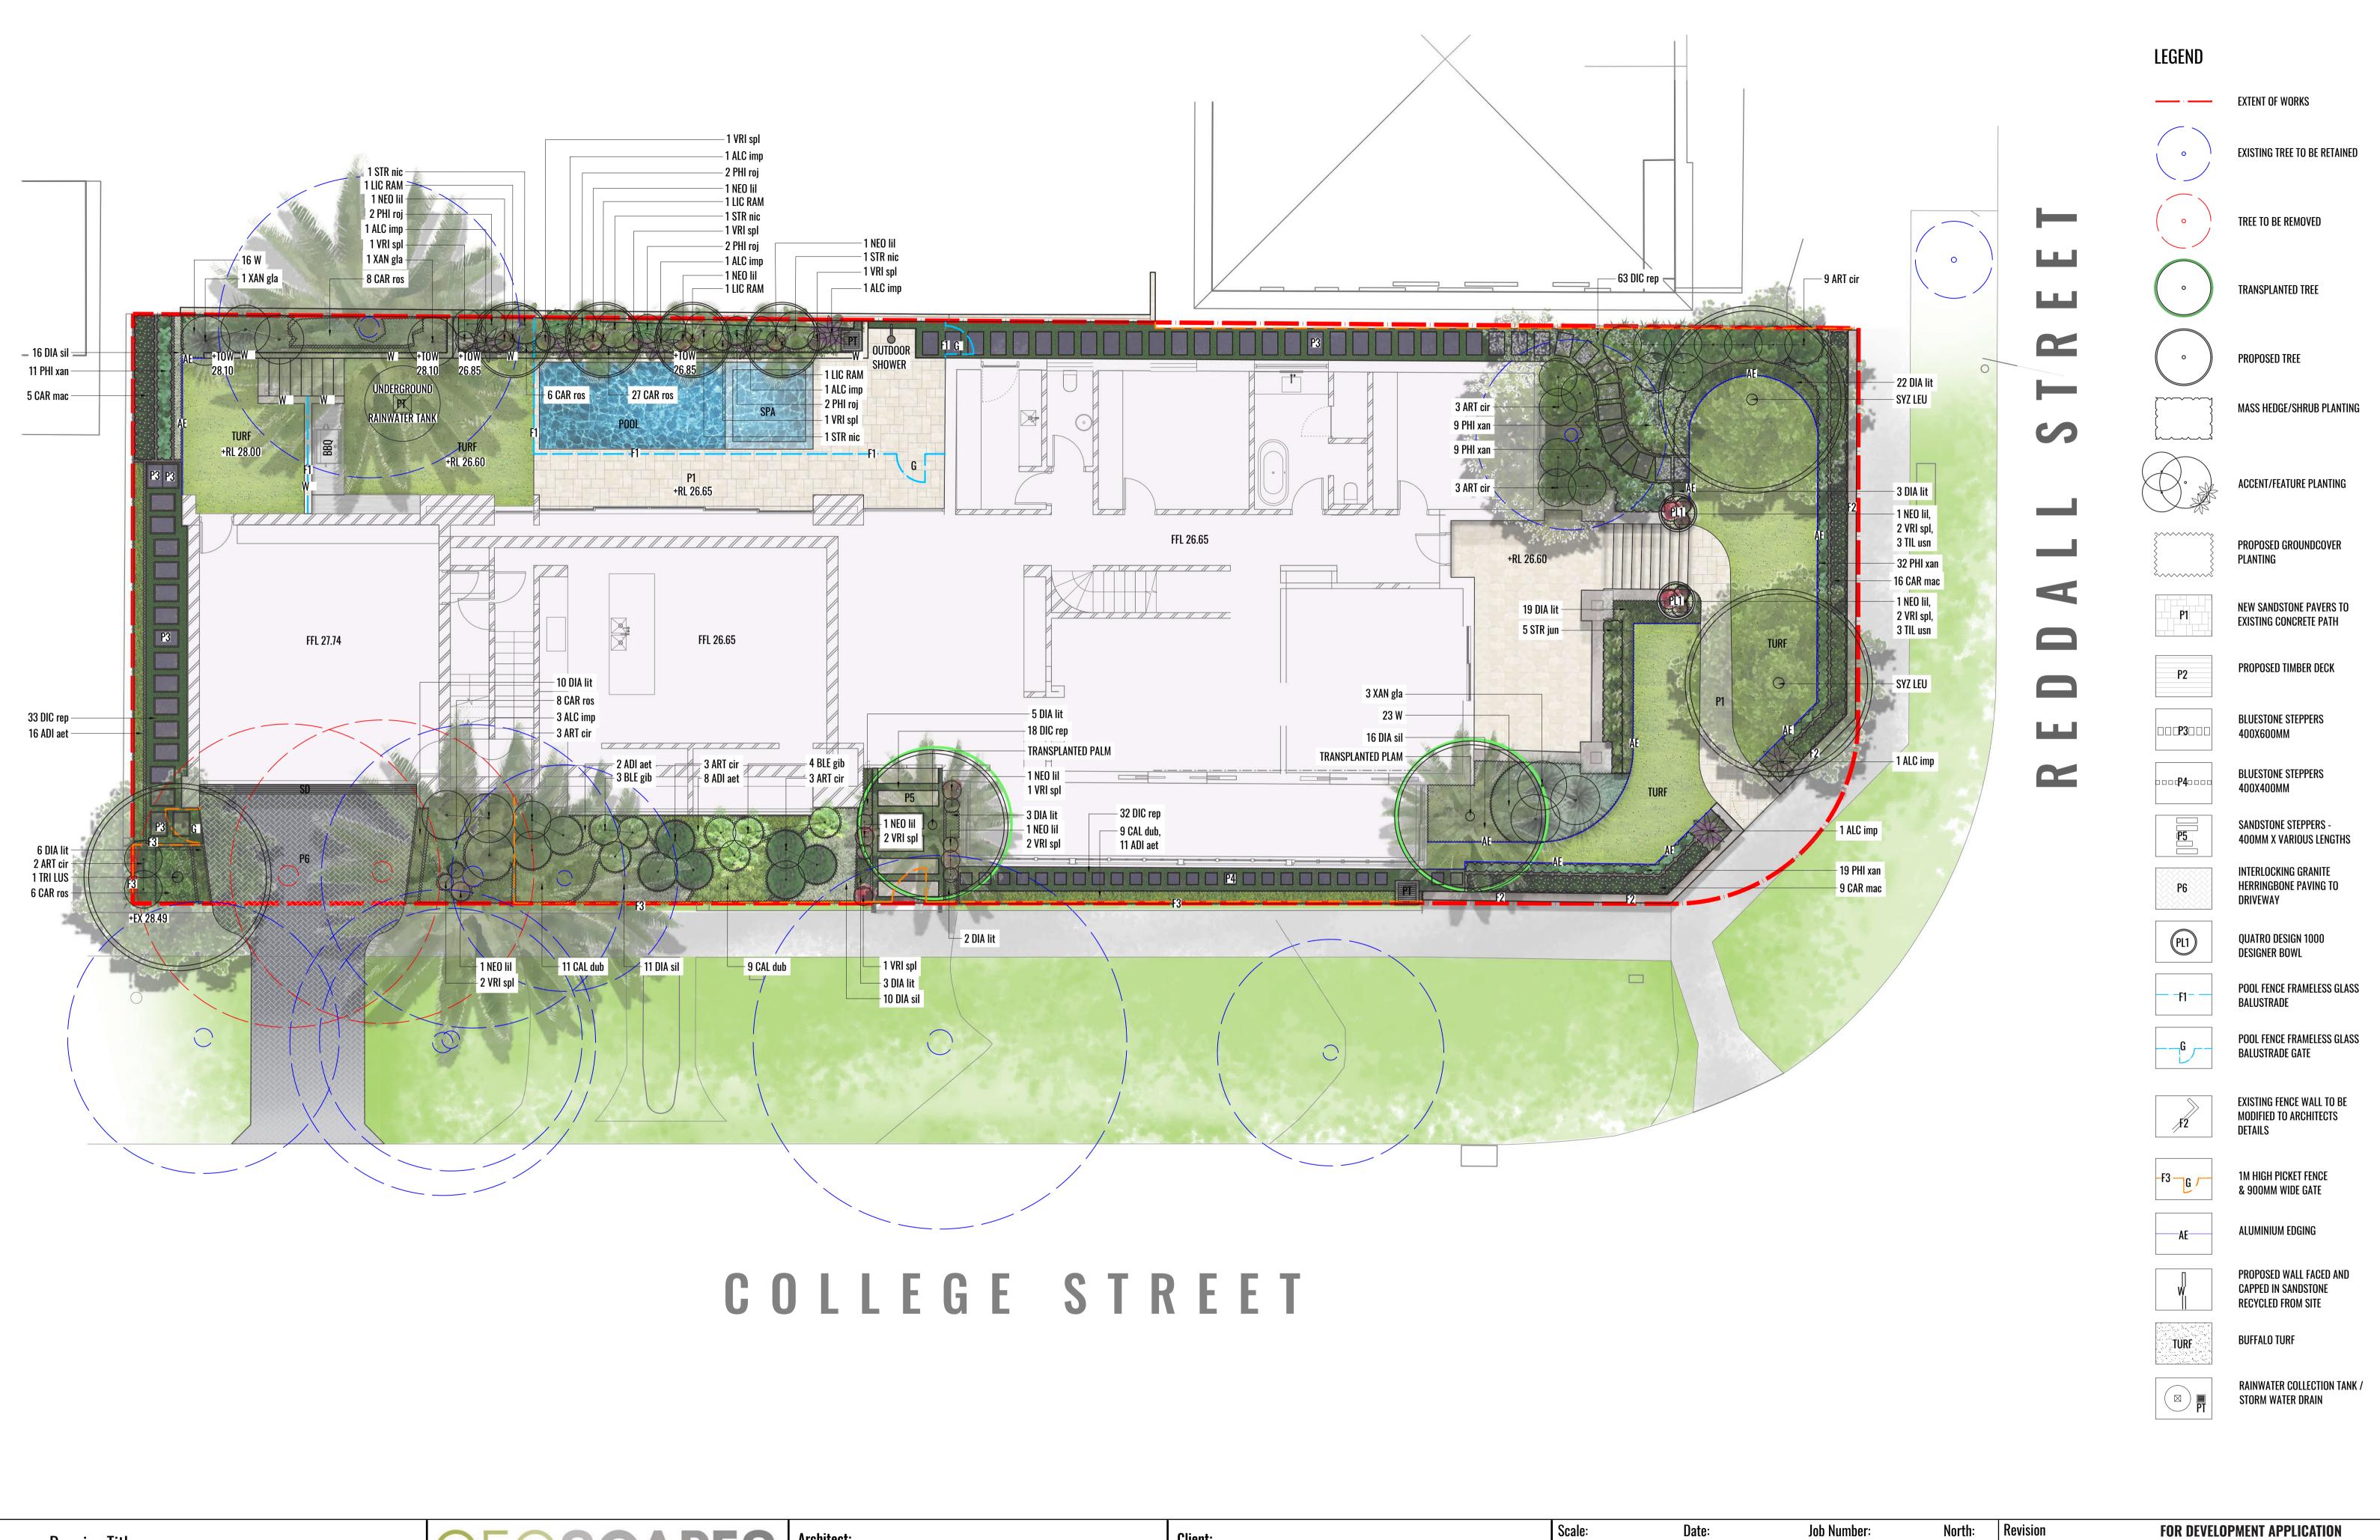

Drawing Title: Landscape Plan

DWG No:

Suite 215, 284 Victoria Ave, Chatswood NSW 2067 Ph. (02) 9411 1485 www.geoscapes.com.au ABN 84 620 205 781 ACN 620 205 781

EATON ARCHITECTS | Steve Thomas

Client:

1:75 @ A1 1:150 @ A3 25.02.2021 190320 32 REDDALL STREET Project:

FOR DEVELOPMENT APPLICATION 20.05.19 STORM-WATER INCORPORATED Manly, NSW 2095 D 25.02.21 STORMWATER INCORPORATED

MAINTENANCE PLAN

Maintenance shall mean the care and maintenance of the landscape works by accepted horticultural practice as rectifying any defects that become apparent in the landscape works under normal use. The landscape contractor shall attend the site on a **weekly basis** to maintain the landscape works commencing from practical completion.

Rubbish Removal

The Landscape Contractor shall undertake rubbish removal from the site on a **weekly basis** to ensure the site remains in tidy condition.

Weed Eradication

Weed growth that may occur in grassed, planted or mulched areas is to be removed using environmentally acceptable methods i.e. non-residual glyphosate herbicide (e.g. 'Roundup', applied in accordance with the manufacturer's direction.

Tree Replacement

Trees shall show signs of healthy vigorous growth and be free from disease and not exhibit signs of stress prior to handover to the client. Any trees or plant that die or fail to thrive, or are damaged or stolen will be replaced. Replacement material shall have the initial maintenance period extended in accordance with the landscape contract conditions. Trees and plant materials shall be equal to the minimum requirements of species specified and approved material delivered to site. Should the condition decline from the approved sample the Superintendent reserves the right to reject the tree / plants. Frequency: as required.

Stakes

Adjust and/or replace stakes and ties where required. Remove staking and guying when instructed by the Superintendent

Pruning

Selective pruning may be required during the establishment period to promote a balanced canopy structure. These activities shall be carried out to the best horticultural and industry practice. All pruned material is to be removed from site.

Mulched Surfaces

All planter beds and garden areas shall have a minimum depth of 75mm organic mulch. All mulch is to be free of deleterious matter such as soil, weeds, sticks and should conform to AS 4454.

Mulched surfaces are to be kept clean and tidy and free of any deleterious material and foreign matter. Reinstate depths to a uniform level of 75mm with mulch as specified, mulch to be free of any wood material impregnated with CCA or similar toxic treatment. Top up mulch levels prior to handover to client & estate management.

Watering

Implement an appropriate hand watering regime in areas not irrigated in association with current watering programme to maintain plant health and vigour. The program shall reflect seasonal conditions and plant species.

Frequency: Weekly or as required.

Soil In Natural Ground

Non-Australian native garden beds to have soil installed consisting of 50% existing site topsoil and 50% new topsoil equal or equivalent to 'Organic Garden Mix' as supplied by Australian Native Landscapes. Australian native garden beds to have soil installed consisting of 50% existing site topsoil and 50% new topsoil equal or equivalent to 'Native Low 'P' Mix' as supplied by Australian Native Landscapes. Soil to conform to AS4419 refer to typical detail.

Pest and Disease Control

The Landscape Contractor shall spray for pests and disease infestations when the pest and fungal attack has been positively identified and when their populations have increased to a point that will become detrimental to plant growth. Apply all pesticides to manufacturer's directions. Frequency: weekly inspection

Fertilising

Generally check for signs of nutrient deficiencies (yellowing of leaves, failure to thrive), and adapt fertiliser regime to suit. Fertiliser should be applied at the beginning and the end of the (summer) growing season.

Irrigation

A sub surface dripper style, electrically automated self timed irrigation system is recommended to be supplied to all garden bed areas and planter container. Regular checks are to be made to ensure continued successful operation. The Landscape Contractor shall be responsible for coordination and engagement of a specialist irrigation designer and installation contractor to design, supply and install an automatic subterranean drip irrigation system to all raised planter beds.

The irrigation system will need to provide designated landscaped areas with enough water for vigorous healthy plant growth. As a general rule landscaped areas will need 20-25mm, species dependant, of water per week. The landscape Contractor will need to monitor natural rainfall using a rain switch in order to set irrigation flow rates accordingly on a monthly basis.

Standards

All grown or purchased plant stock must conform to all the conditions and requirements given in NATSPEC Guide: Specifying Trees. Soils to be in accordance with AS4419, mulching composts and conditioners to be in accordance with AS4454. Soils should conform to best practice specifications as listed in the Landscape Soils Handbook (Simon Leake & Elke Haege 2017).

Drawing Title:

DWG No:



Architect:




Client:

Steve Thomas

Job Number: Revision FOR DEVELOPMENT APPLICATION Date: AS SHOWN Description Drawn | Checked Rev Date 25.02.202 190320 **A** 10.05.19 FOR DA LW TW 20.05.19 STORM-WATER INCORPORATED BG 32 REDDALL STREET C 05.02.21 REVISED ARCHITECTURE BASE TW BG Manly, NSW 2095 D 25.02.21 STORMWATER INCORPORATED

TYPICAL LANDSCAPE DETAILS

TAKE CARE TO ENSURE FOLIAGE, BRANCHES, TRUNKS AND ROOT CROWNS ARE NOT DAMAGED BEFORE, DURING AND AFTER PLANTING.

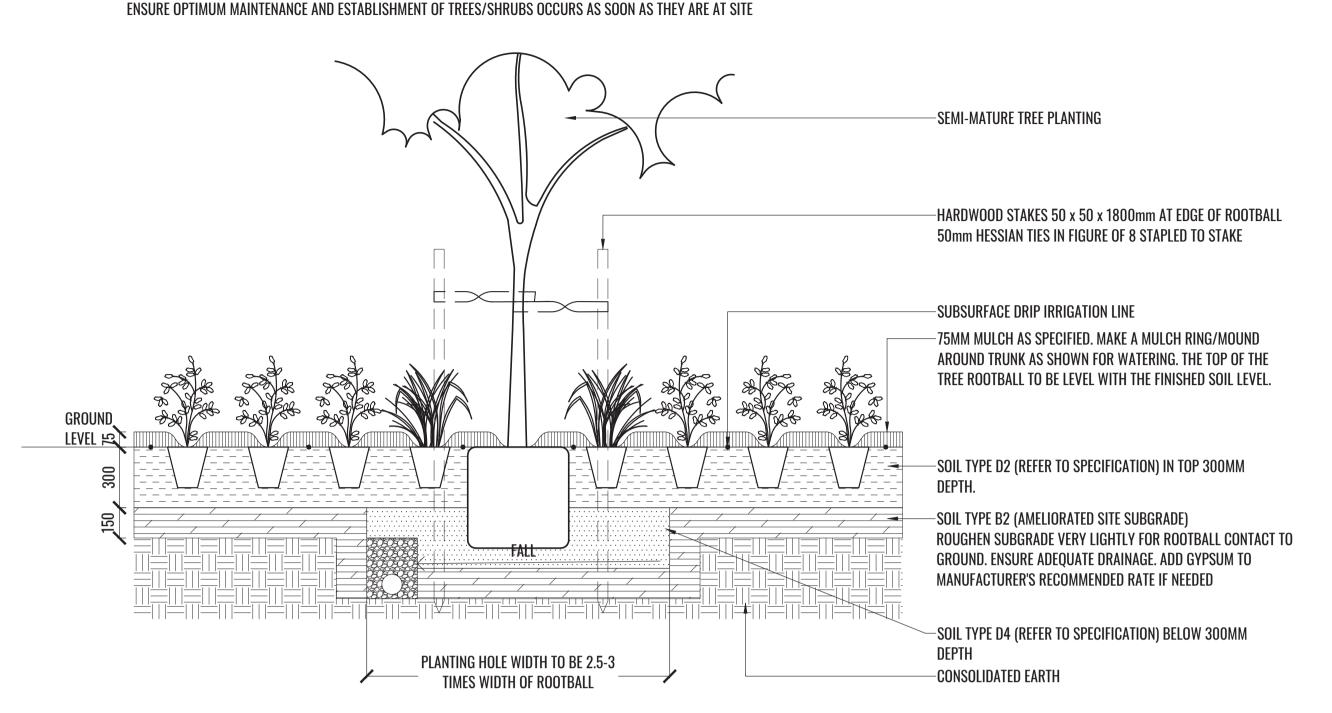

Scale:

@ A1

Project:


REMOVE ANY STAKES, TIES AND LABELS. WATER ROOTBALL THOROUGHLY.

TOP OF ROOTBALL TO FINISH FLUSH WITH TOP OF SOIL

MASS PLANTING AND TREE DETAIL

TYPICAL SECTION

TURF WITH TURF UNDERLAY (REFER TO SPECIFICATION)

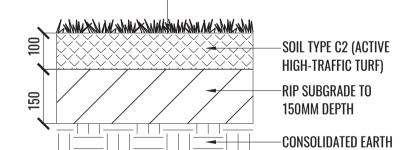

	TURF DETAIL	
<	TYPICAL SECTION	SCALE 1:10

PLANTING SCHEDULE

							Long Nosed
CODE	BOTANICAL NAME	COMMON NAME	MATURE HEIGHT	SIZE	PLANTING DENSITY	QTY	Bandicoot Planting
	Trees		<u> </u>				
SYZ LEU	Syzygium leuhmannii	Riberry Tree	15m	100L	As Shown	2	
TRI LUS	Tristaniopsis laurina 'Luscious'	Water Gum	12m	100L	As Shown	1	
LIC RAM	Licuala ramsayi	Australian Fan Palm	10-20m	100L	As Shown	4	
	Shrubs	<u>, </u>	•	,			
ART cir	Arthropodium cirratum	New Zealand Rock Lily	1m	300mm	As Shown	26	
CAR mac	Carissa macrocarpa 'Emerald Star'	Natal Plum	1m	300mm	700ctrs	30	
PHI xan	Philodendron 'Xanadu'	Xanadu Philodendron	0.8m	200mm	4/m2 or 3/Lm	80	
STR jun	Strelitzia juncea	Narrow-Leaved Bird of Paradise	1.2m	200mm	As Shown	5	
STR nic	Strelitzia nicolai	Giant White Bird of Paradise	5m	300mm	As Shown	4	
BLE gib	Blechnum gibbum 'Silver Lady'	Silver Lady Fern	1m	300mm	As Shown	7	
	Accents / Feature Plants						
ALC imp	Alcantarea imperialis 'Purpurea'	Giant Bromeliad	1m	300mm	As Shown	10	
NEO IiI	Neoregelia 'Lila'	Pink Bromeliad	0.5-1m	300mm	As Shown	10	
PHI roj	Philodendron 'Rojo Congo'	Rojo Congo Philodendron	0.6m	300mm	As Shown	8	
VRI spl	Vriesea splendens	Flaming Sword Bromeliad	0.5-1m	300mm	As Shown	17	
XAN gla	Xanthorrhoea glauca	Grass Tree	2m	100L	As Shown	5	*
	Grasses & Groundcovers		•	•			
ADI aet	Adiantum aethiopicum	Maidenhair Fern	0.5m	140mm	6/m2	37	*
CAL dub	Calochlaena dubia	Brascken Fern	0.6m	140mm	5/m2	29	*
CAR ros	Carpobrotus rossii	Native Pig Face	0.3m	140mm	4/m2 or 3/Lm	55	
DIA lit	Dianella caerulea 'Little Jess'	Dianella Little Jess	0.4m	140mm	6/m2 or 4/Lm	73	*
DIA sil	Dianella 'Silver Streak	Silver Streak Flax Lily	0.5m	140mm	5/m2 or 4/Lm	53	*
DIC rep	Dichondra repens	Kidney Weed	0.1m	140mm	6/m2	146	
SEN ser	Senecio serpens	Blue Chalksticks	0.3m	140mm	4/m2	39	

^{**} Final numbers to be confirmed within CC stage

PLANT IMAGES



Syzygium leuhmannii



Tristaniopsis laurina 'Luscious'



Licuala ramsayi



Arthropodium cirratum



Philodendron 'Xanadu'



Strelitzia nicolai



Carissa 'Emerald Star'



Philodendron 'Rojo Congo'




Xanthorrhoea glauca



Vriesea splendensV



Alcantarea imperialis 'Purpurea'

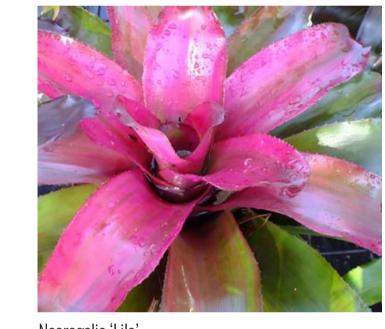

Neoregelia 'Lila'



Calochlaena dubia



Blechnum gibbum 'Silver Lady'



Dianella 'Silver Streak'



Dianella 'Little Jess'



Adiantum aethiopicum



Dichondra repens

Senecio serpens





EATON ARCHITECTS | Steve Thomas

Architect:

Client:

Scale:	Date:	Job Number:	North:	Revis	ion	FOR DEVELOPMENT APPLIC		
NTS @ A1	05 00 0001	100000		Rev	Date	Description	Drawn	Checked
NTS @ A3	25.02.2021	190320		A	10.05.19	FOR DA	TW	LW
ъ	20 D-2	C		В	20.05.19	STORM-WATER INCORPORATED	TW	BG
Project:	32 RED	dall Street		C	05.02.21	REVISED ARCHITECTURE BASE	TW	BG
			Manly, NSW 2095	D	25.02.21	STORMWATER INCORPORATED	TW	BG