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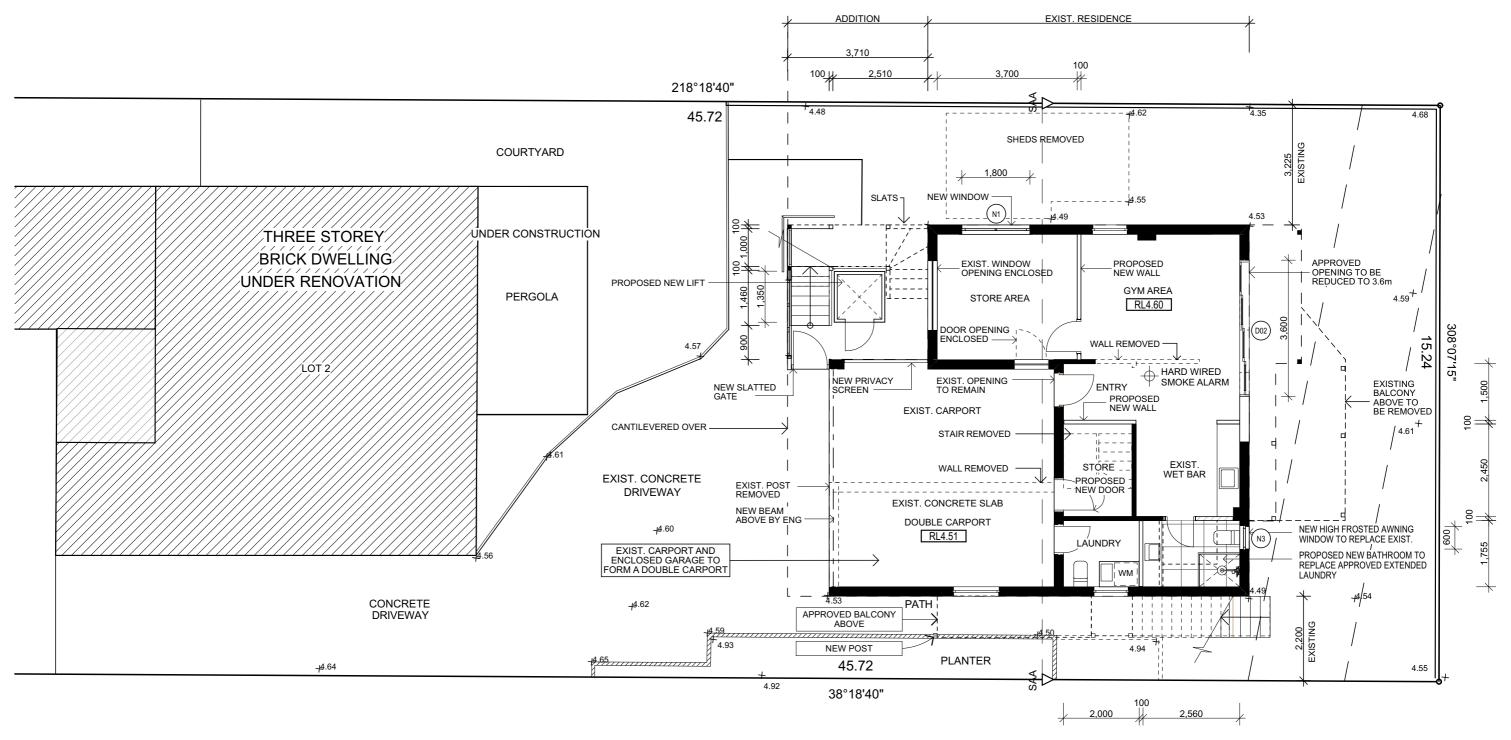
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	REV:	DATE:	DESCRIPTION:
	В	12/11/19	CORRECT ROOF RIDGE RL13.04
1	С	29/01/20	WINDOWS UPDATED
	D	20/05/20	SECTION 4.55 SHOWN
	Е	29/07/20	SECTION 4.55 SHOWN IN RED

PROJECT DETAILS: SECTION 4.55 - ALTERATIONS AND ADDITIONS 1/2 DARLEY ST - EAST MONA VALE	DATE: MAY/20	DRAWN BY:	SCALE: 1:200 @ A3
DRAWING TITLE: SITE ANALYSIS PLAN	JOB No: 800/20	CHECKED BY:	DRAWING No: 01 E



GROUND FLOOR PLAN - NO CHANGE

Floor Area = 63,37m²



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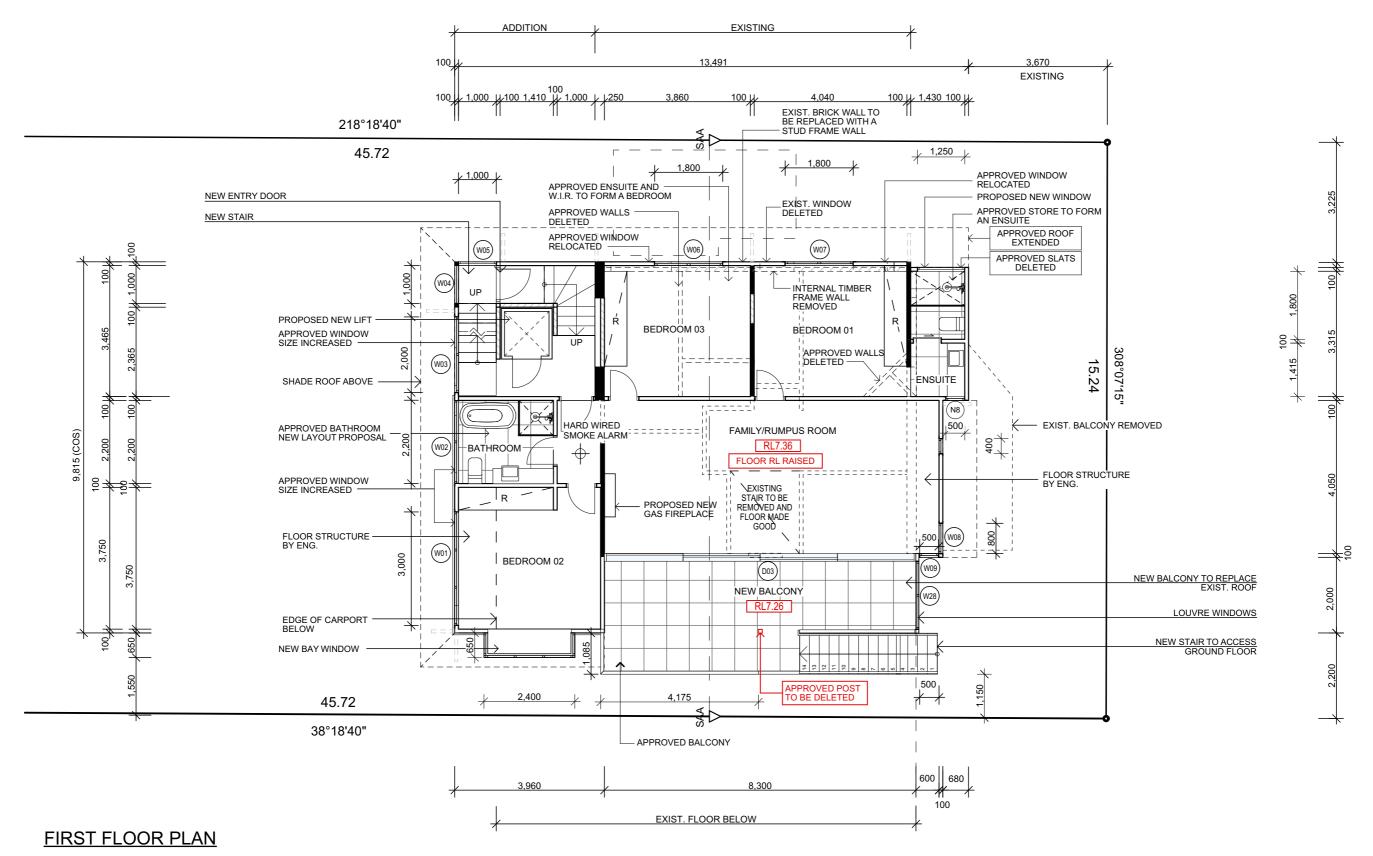
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DRAWING TITLE: GROUND FLOOR PLAN	JOB No: 800/20	CHECKED BY:	DRAWING No: 02 E



Floor Area = 97,15m²

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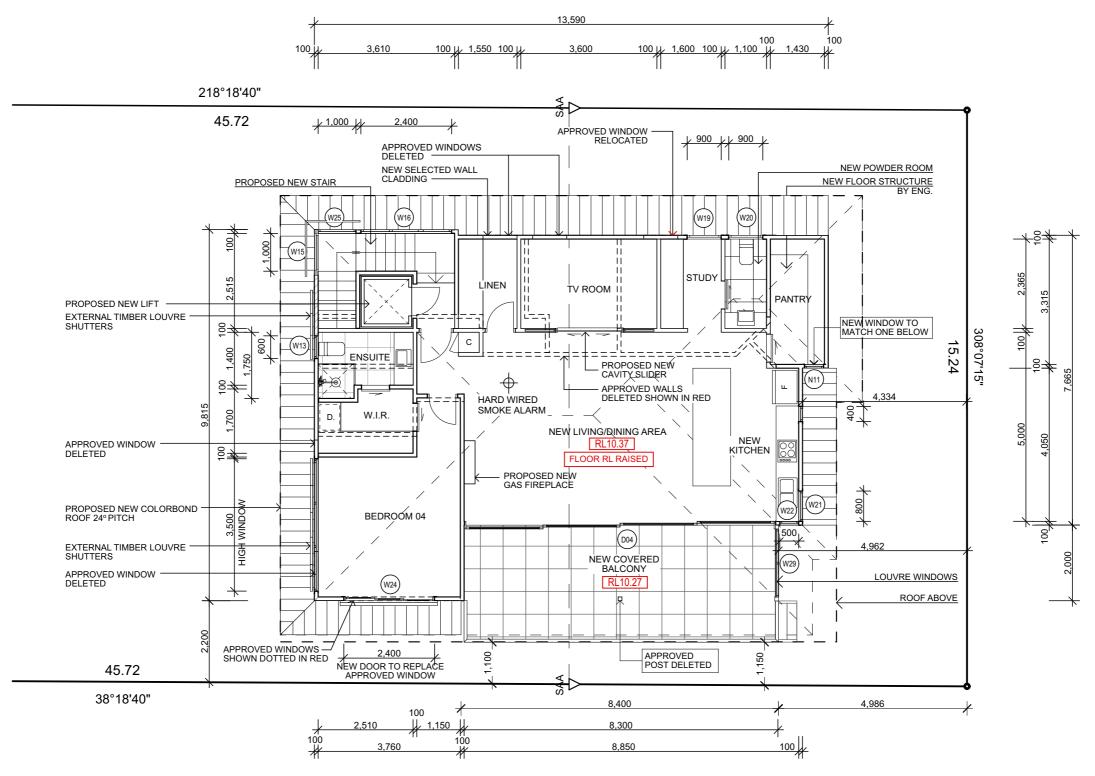
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DRAWING TITLE: FIRST FLOOR PLAN	JOB No: 800/20	CHECKED BY:	DRAWING No: 03 E



TOP FLOOR PLAN

Floor Area = 102,13m²

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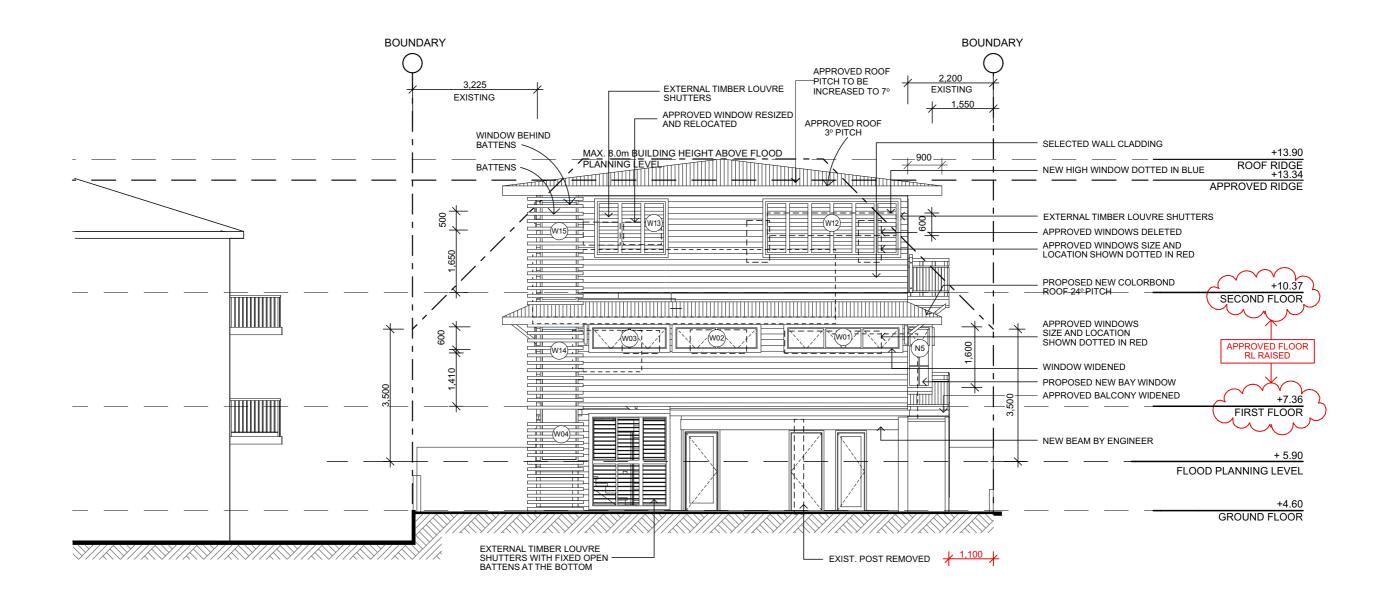
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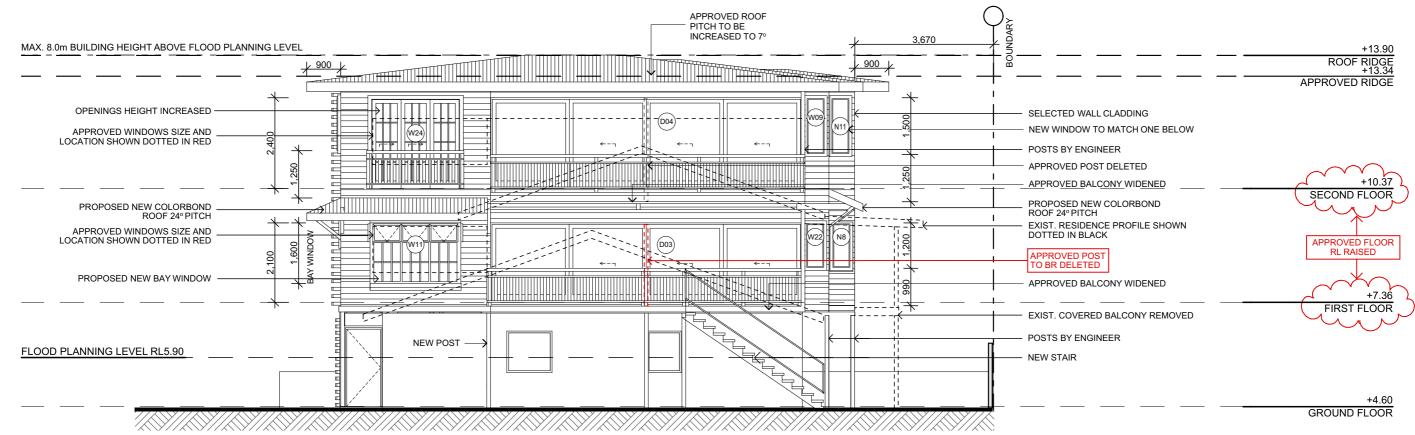
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DRAWING TITLE: TOP FLOOR AREA	JOB No: 800/20	CHECKED BY:	DRAWING No: 04 E

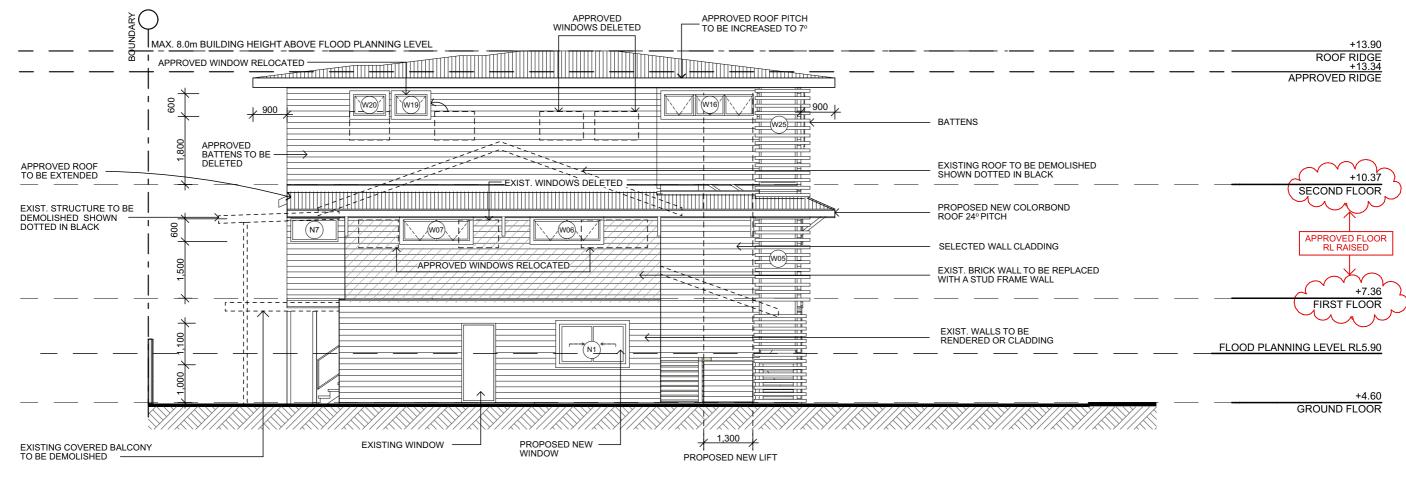


SOUTH WEST ELEVATION

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SOUTH EAST ELEVATION



SCALE:

DRAWING No:

1:100 @ A3

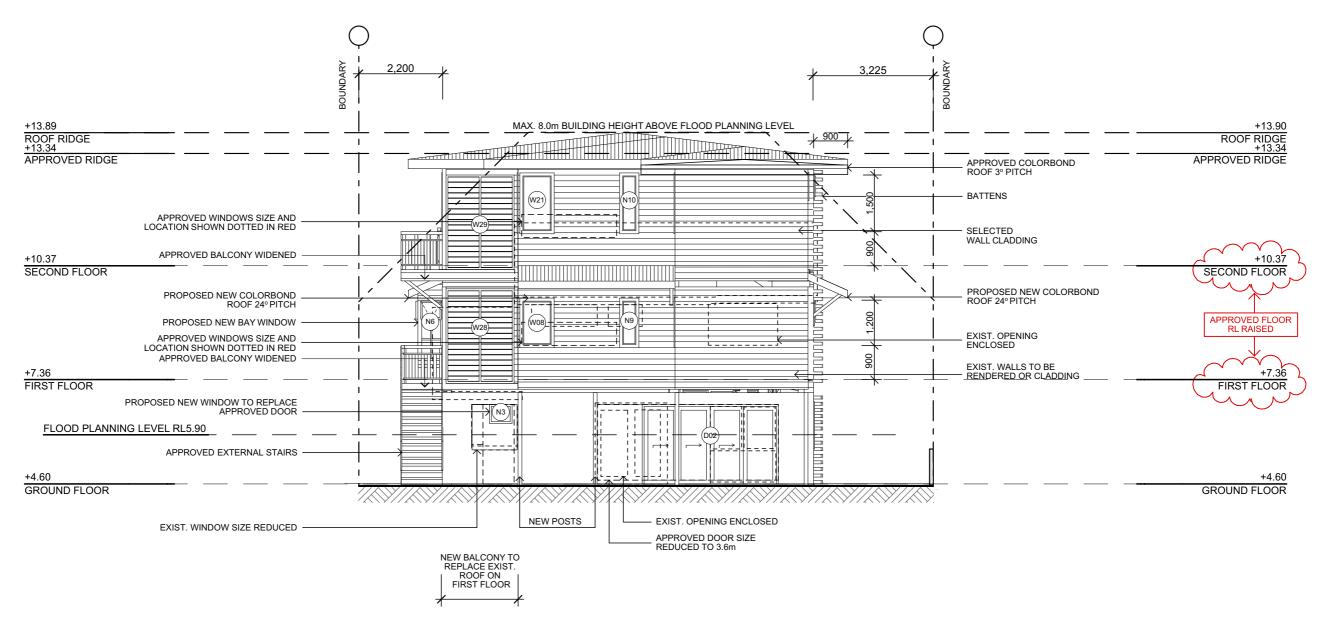
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NORTH WEST ELEVATION

a practicing engineer

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NORTH EAST ELEVATION

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BASIX COMMITMENTS:

Insulation Requirements:

- Concrete slab on ground floor = nil
- Floor above existing dwelling or building = nil
- External wall (other/undecided) = R1.3 (or 1.7 including construction)
- Flat ceiling, pitched roof = Ceiling: R0.70 (up), roof: foil backed blanket (55mm)
- Raked Ceiling, pitched/skillion roof: framed = Ceiling R1.00 (up), roof: foil backed blanket (55mm)

Lighting:

- A minimum of 40% of new or altered light fixtures are fitted with fluorescent, compact fluorescent, or ligth-emitting-diode (LED) lamps.

Fixtures:

- Tap rating = no greater than 9 litres per minute or minimum 3 star water rating.
- Shower rating = no greater than 9 litres per minute or minimum 3 star water rating.
- WC rating = no greater than 4 litres per average flush or minimum 3 star water rating.

ROOFING

- COLORBOND ROOF CLADDING

GUTTERS AND DOWNPIPES

- COLORBOND GUTTERS AND DOWNPIPES
- MINIMUM SLOPE OF EAVES AND GUTTERS 1:200

FLASHING AND CAPPINGS

- SELECTION AND INSTALLATION OF METAL RAINWATER GOODS - FLASH PROJECTIONS ABOVE THE ROOF WITH TWO PART
- FLASHINGS CONSISTING OF AN APRON FLASHING AND OVER FLASHING, WITH AT LEAST 100mm OVERLAP
- PROVIDE FOR INDEPENDENT MOVEMENT BETWEEN ROOF AND PROJECTION

TERMITE CONTROL

- TO AS3660.1

BATHROOMS, LAUNDRY AND ENSUITES

- ALL WATERPROOFING TO AS 3740 PROVIDE A GUARANTEED FLEXIBLE WATERPROOF MEMBRANE TO ALL WET AREA FLOORS & SHOWERS WALLS TO MANUFACTURERS INSTRUCTIONS

TIMBER FRAMING

- USE TREATED TIMBER WHERE REQUIRED FOR DURABILITY - DO NOT USE TIMBER UNSUITABLE FOR EXPOSURE TO MOISTURE IN EXPOSED LOCATION
- ALL WORKMANSHIP AND MATERIALS SHALL BE IN ACCORDANCE WITH AS1684 AND 1720 AS APPLICABLE
- PROVIDE STRUCTURE BRACING IN ACCORDANCE WITH AS1684 - PROVIDE STRUCTURE TIEDOWN IN ACCORDANCE WITH AS1684
- USE GALVANISED FIXINGS WHERE EXPOSED TO WEATHER

CONCRETE

- ALL WORKMANSHIP AND MATERIALS SHALL BE IN ACCORDANCE WITH CURRENT EDITIONS OF THE AS3600
- FOOTINGS TO BE IN ACCORDANCE WITH AS1480
- ALL REINFORCEMENTS SHALL CONFORM TO AS1302, AS1303 AND AS1304

INTERNAL LININGS

- PROVIDE PLASTERBOARD LINING

SEDIMENT CONTROL

- A FILTER CLOTH SYSTEM SHALL BE INSTALLED TO STOP ANY SEDIMENT ENTERING COUNCILS STORMWATER SYSTEM

SMOKE DETECTORS/ALARMS

- NCC VOL 2 PART 3.7.2. FIRE/SMOKE DETECTORS COMPLYING WITH THE REQUIREMENTS OF THE LOCAL GOVERNMENT ACT AND/OR STATE OR TERRITORY REGULATIONS MUST BE FITTED IN THE LOCATIONS REQUIRED AND APPROVED BY THE AUTHORITY AND SHALL BE INSTALLED IN ACCORDANCE WITH AS3786
- INSTALLATIONS IN BUILDINGS OTHER THAN CLASS 1 AND 10 MUST BE INSTALLED AND MANAGED TO COMPLY WITH NCC SPEC. E2.2a. - MULTIPLE ALARMS WITHIN HOUSES AND SOLE OCCUPANCY UNITS MUST BE HARD WIRED AND INTERCONNECTED

WASTE MANAGEMENT

- ALL WASTE SHALL BE TAKEN AWAY BY TRUCKS TO A SUITABLE LANDFILL OR RECYCLE DEPOT
- ALL WASTE SHALL BE COVERED DURING TRANSPORTATION
- WASTE GENERATED DURING CONSTRUCTION SHALL BE PLACED IN STEEL BINS AND TAKEN AWAY BY AN APPROVED CONTRACTOR TO A APPROVED LANDFILL SITE

ALL PLANS ARE TO BE READ IN CONJUNCTION AND COMPLY WITH THE BASIX CERTIFICATE. BUSHFIRE AND GEOTECH

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SPECIFICATION NOTES:

- LIGHT FRAME WALLS FINISHED OFF WITH SELECTED CLADDING

- ALUMINIUM FRAMED WINDOWS AND DOORS

- WEATHER STRIPPING IS TO BE PROVIDED TO ALL

- TIMBER FLOOR FRAMING TO BE FINISHED WITH SELECTED FLOORING

MEMBRANE TO ENSUITES, BATHROOMS AND LAUNDRY

- NEW DOWNPIPES TO BE CONNECTED INTO EXISTING STORMWATER LINE

- PROVIDE ACOUSTIC INSULATION BETWEEN FLOORS

- TILES ON COMPRESSED FC & WATERPROOF

- 1.000mm HIGH BALUSTRADE TO BCA AND TO NCC

BALUSTRADE

FLOORS

STORMWATER

INSULATION

EXTERNAL WALLS

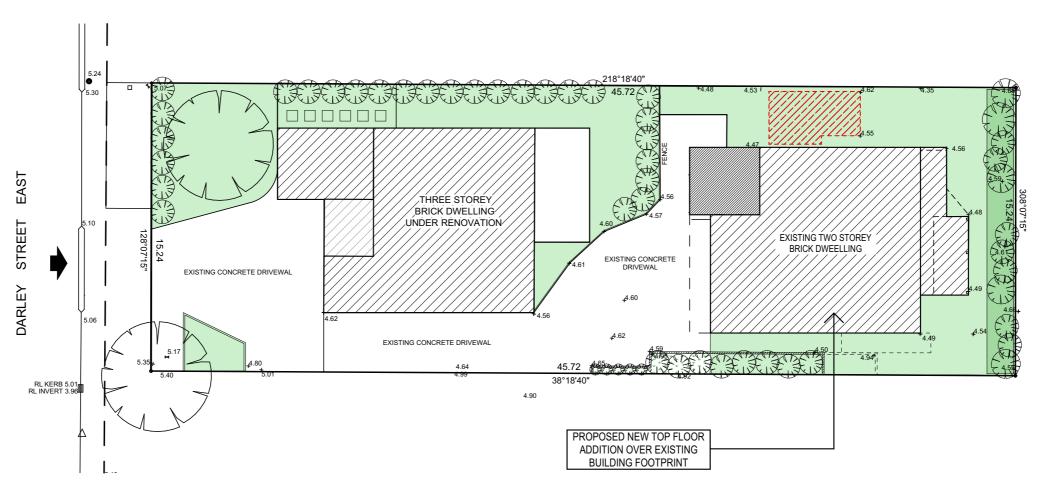
DOORS AND WINDOWS

EXTERNAL WINDOWS AND DOORS

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LANDSCAPED CALCULATION PLAN

NOTE: NO CHANGE

FLOODING NOTES:

Building Componebts and Structural Soundness - C1

All new development shall be design and constructed as flood compatible buildings in accordance with Reducing Vulnerability of Buildings to Flood DAmage: Guidance on Building in Flood Prone Areas, Hawkesbury-Nepean Floodplain Management Steering Commitee (2006).

Building Componebts and Structural Soundness - C2

All new development shall be design and constructed to ensure structural integrity up to the Flood Planning level of 5.55m AWD, taking into account the forces of floodwater, wave action, flowing water with debris, buoyancy and immersion. Structural certification shall be provided confirming the above.

Building Componebts and Structural Soundness - C3

All new electrical equipment, power points, wiring, fuel lines, sewerage systems or any other service pipes and connections must be waterproof and/or located above the Flood Planning of 5.55M AHD. All existing electrical equipment and power points located below the Flood Planning Level must have residual current devices installed cut electricity supply during flood events.

Storages of goods - D1

Hazardous or potentially polluting materials shall not be stored below the Flood Planning Level of 5.55M AHD unless adequately protected from floodwaters in accordance with industry standards.

Car parking - G6

The car port is to be designed to allow flood waters to pass through and perimeter walls are to have a minimum of 50% OPEN AREA BELOW THE 1% FLOOD LEVEL OF 5.05m AHD. The floor level of the car port is to remain at the existing level.

LEGEND	FILL	PERCENTAGE	TOTAL AREA
SITE AREA			695.50m ²
LANDSCAPE CONTROL REQUIRED		MIN.50%	347.75m ²
EXISTING LANDSCAPE AREA		34.7%	241.68m²
LANDSCAPE AREA - NOT COUNTED			5.40m ²
NEW LANDSCAPE AREA		1.9%	12.55m ²
TOTAL NEW LANDSCAPE AREA		36.5%	254.23m ²
EXISTING HARD SURFACE AREA			453.82m ²
HARD SURFACE TO REMAIN			440.52m ²

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