DEVELOPMENT APPLICATION (DA)

- SUBJECT SITE



LOCATION:
6 MOIRA PLACE, FRENCHS FOREST
LOT 13
DP 1071450

PROPOSAL: CARPORT WITH STOREROOM

DRAWING LIST:

- I. COVER SITE PARTICULARS
- 2. NOTES + A.S, NCC SPECIFICATIONS.
- 3. SITE PLAN.
- 4. SITE ANALYSIS, EROSION CONTROL + WASTE MANAGEMENT.
- 5. HARD / SOFT LANDSCAPE RATIOS (EXISTING AND PROPOSED).
- 6. GROUND FLOOR DEMOLITION.
- 7. CARPORT FLOOR PLAN PROPOSED.
- 8. PROPOSED ELEVATIONS 1.
- 9. PROPOSED ELEVATIONS 2.
- 10. SECTION A-A + CARPORT ROOF PLAN + COLOURS









DEVELOPMENT APPLICATION (DA)

REFER TO "BUSHFIRE HAZARD SOLUTIONS" BUSHFIRE ASSESSMENT REPORT 250669 SUMMARY AND RECOMMENDATIONS FOR ALL REQUIREMENTS INCLUDING PLANNING FOR BUSHFIRE PROTECTION (PBP)

OWNER / BUILDER TO SUPPLY ALL CONSULTANT REPORTS SPECIFICATIONS AND DOCUMENTATION AS REQUIRED BY CERTIFIER (CIVIL, STRUCTURAL, HYDRAULIC, GEOTECHNICAL AND OTHERS AS

OWNER / BUILDER TO PREPARE AND SUPPLY PROJECT SPECIFICATION.

 $\frac{\text{IMPORTANT:}}{\text{ANY PROPOSED DESIGN OR PRODUCT CHANGES AFTER APPROVAL OF THE CONSTRUCTION CERTIFICATE (CC) ARE TO BE <math display="block">\frac{\text{IMMEDIATELY}}{\text{IMMEDIATELY}}$ NOTIFIED TO THE PRINCIPAL CERTIFYING AUTHORITY (PCI) FOR REVIEW

STRUCTURAL ENGINEER'S INSPECTION REPORTS REQUIRED FOR ALL CONCRETE ELEMENTS. STEEL AND TIMBER FRAMING AND CERTIFICATION OF COMPLETED WORKS.

CIVIL / HYDRAULIC ENGINEERS INSPECTION REPORTS AND OR CERTIFICATION OF COMPLETED WORKS REQUIRED.

GEOTECHNICAL ENGINEER'S INSPECTION REPORTS AND OR CERTIFICATION REQUIRED.

SYDNEY WATER SEWER - WATER SERVICES COORDINATOR TO PROVIDE CERTIFICATION AS REQUIRED - OWNER / BUILDER TO SUPPLY SYDNEY WATER TAP IN IF REQUIRED

PROVIDE ASBESTOS CLEARANCE CERTIFICATE SHOULD ASBESTOS BE

TERMITE MANAGEMENT INSTALLATION OF PERIMETER \$ COLLARS TO BE IN ACCORDANCE WITH NCC 2022 - ABCB HOUSING PROVISIONS PART 3.4 \$ AS 3660. I TERMITE MANAGEMENT NEW BUILDING WORK.

ALL EXTERNAL TIMBER FRAMED WALLS TO BE WRAPPED IN A COMPLIANT BREATHABLE VAPOUR PERMEABLE MEMBRANE, INSTALLED WITH AS/NZS 4200 | \$ AS/N7S 4200 2

METAL ROOF DESIGN AND INSTALLATION SHALL BE IN ACCORDANCE WITH NCC 2022 - ABCB HOUSING PROVISIONS PART 7 AND AS 1562.

ALL EXTERNAL WALL CLADDING MUST COMPLY WITH THE REQUIREMENTS OF NCC 2022 - ABCB HOUSING PROVISIONS PART 7 AND AS 1684 AND ALL RELEVANT CODEMARK CERTIFICATES, AND AS 3959-2018 CONSTRUCTION OF BUILDINGS IN BUSH FIRE-PRONE AREAS SECTIONS 3 + 8 (BAL 40) & SECTION 7.5 OF PLANNING FOR BUSHFIRE

PROVIDE PLASTERBOARD LINING INSTALLED TO MANUFACTURERS SPECIFICATION AND AS 2589.

ALL WATERPROOFING TO COMPLY WITH NCC 2022 - ABCB HOUSING PROVISIONS PART 10 AND AS 3740 AND PROVIDE A GUARANTEED FLEXIBLE WATERPROOF MEMBRANE TO ALL WET AREA FLOORS AND SHOWER WALLS TO MANUFACTURERS SPECIFICATION AND INSTALLATION INSTRUCTIONS

PROVIDE HARD WIRED AND INTERCONNECTED SMOKE ALARM DEVICES SMOKE ALARMS TO BE INSTALLED IN ACCORDANCE WITH NCC 2022 ABCB HOUSING PROVISIONS PART 9.5. NSW 9.5.1 AND AS 3786

CONDENSATION MANAGEMENT MUST BE ADHERED TO IN ACCORDANCE WITH NCC 2022 HOUSING PROVISIONS PART 10.8.

FIRE SEPARATING WALL: A WALL WITHIN 900mm OF THE BOUNDARY INSTALLATION CERTIFICATE (FRL 60 / 60 / 60) INCLUDING ACOUSTIC SOUND (Rw) + CTR 50 TO NCC 2022 - ABCB HOUSING PROVISIONS PART 9, PART 10.7 AND AS 1530 ALL PARTS.

BUSHFIRE PRONE AREAS CERTIFICATE FOR BUILDING NCC 2022 -VOLUME 2 PART NSW H7D4 CONSTRUCTION IN BUSHFIRE PRONE AREAS AND AS 3959 CONSTRUCTION OF A BUILDING IN BUSHFIRE PRONE AREAS AND PLANNING FOR BUSHFIRE PROTECTION 2019.

RESIDENTIAL SLABS, FOOTINGS AND CONCRETE STRUCTURES TO COMPLY WITH NCC 2022 ABCB HOUSING PROVISIONS PART 3 AND PART 4 AND AS 2870 RESIDENTIAL SLABS AND FOOTINGS AND AS 3600 CONCRETE STRUCTURES.

DAMP PROOF COURSE AND FLASHINGS TO COMPLY WITH NCC 2022 ABCB HOUSING PROVISIONS PARTS 5, 7 AND 12 AND AS/NZS 2904 DAMP PROOF COURSES AND FLASHINGS.

TIMBER FRAMED INSTALLATION TO BE IN ACCORDANCE WITH NCC 2022 ABCB HOUSING PROVISIONS PART 6 AND AS 1684 RESIDETIAL TIMBER FRAMED CONSTRUCTION AND AS/NZS 1170 STRUCTURAL DESIGN ACTIONS.

MASONRY STRUCTURES TO BE IN ACCORDANCE WITH NCC 2022 ABCB HOUSING PROVISIONS PART 5 AND AS 3700 MASONRY STRUCTURES.

ROOF AND WALL CLADDING INSTALLATION TO BE IN ACCORDANCE WITH NCC 2022 ABCB HOUSING PROVISIONS PART 7 AND AS 1562 DESIGN AND INSTALLATION OF SHEET ROOF AND WALL CLADDING

WATERPROOF INSTALLATION TO BE IN ACCORDANCE WITH NCC 2022 ABCB HOUSING PROVISIONS PART TO AND AS 3740 WAFRPROOFING OF DOMESTIC WET AREAS (INTERNAL) AND AS 4654 WATERPROOF MEMBRANES FOR EXTERNAL LISE

PLUMBER TO PROVIDE NSW FAIR TRADING PLUMBING AND DRAINAGE CERTIFICATE TO AS 3500 PLUMBING AND DRAINAGE, STORMWATER TO

ELECTRICAL CERTIFICATE OF COMPLIANCE BY LICENSED ELECTRICIAN TO BE IN ACCORDANCE WITH AS/NZS 3000 WIRING RULES.

STEEL STRUCTURE INSTALLATION CERTIFICATE TO BE IN ACCORDANCE WITH NCC 2022 ABCB HOUSING PROVISIONS PARTS 4, 5 + 6 AND AS

STEEL FRAMING TO BE IN ACCORDANCE WITH NCC 2022 ABCB HOUSING PROVISIONS PART 6 AND AS 4100 STEEL STRUCTURES AND AS/NZS 4600 COLD FORMED STEEL STRUCTURES AND NASH

CONCRETE STRUCTURES TO BE IN ACCORDANCE WITH AS 3600 CONCRETE STRUCTURES OR AS 2783 USE OF REINFORCED CONCRETE FOR SMALL SWIMMING POOLS.

NOTES - ADDITIONAL

DO NOT SCALE FROM DRAWINGS

THESE DRAWINGS HAVE BEEN PREPARED FOR (DA) DEVELOPMENT APPLICATION, REFER TO CONSTRUCTION CERTIFICATE (CC) FOR APPROVAL CONDITIONS.

ALL WORK TO BE CARRIED OUT IN ACCORDANCE WITH LOCAL COUNCIL CODES, NATIONAL CONSTRUCTION CODE NCC 2022 ABCB HOUSING PROVISIONS CODE AND ALL RELEVANT AUSTRALIAN STANDARDS

ALL STRUCTURAL MODIFICATIONS + ADDITIONS AS PER STRUCTURAL ENGINEERS DESIGN AND SPECIFICATION

REFER TO ALL CONSULTING ENGINEERS SPECIFICATIONS FOR ALL CIVIL, STRUCTURAL, HYDRAULIC, STORMWATER, FIRE AND FLOOD RELATED REQUIREMENTS.

WIND RATING: ROOF AND WALL FRAMES: REFER TO FRAMING MANUFACTURERS DESIGN AND SPECIFICATION

WINDOW SIZES TO BE CHECKED AND CONFIRMED ON SITE PRIOR TO PLACING ORDER, DIMENSIONS OF WINDOWS WITHIN BRICK EXTERNAL WALLS ARE SHOWN

(ACTUAL BRICK OPENING SIZE TO BE CONFIRMED ON SITE).

REFER TO BUILDERS SPECIFICATION FOR ALL MATERIALS AND FINISHES AND NATIONAL CONSTRUCTION CODE (NCC - BCA) COMPLIANCE.

THE BUILDER AND ALL CONSULTANTS, SUPPLIERS AND MANUFACTURERS TO CHECK AND CONFIRM ALL DIMENSIONS ON SITE PRIOR TO ORDERING ANY PRODUCTS AND OR MATERIALS.

FLOOR FINISHES BY OWNER THE OWNER IS RESPONSIBLE FOR THE SELECTION OF SURFACE FINISHES IN THE PEDESTRIAN TRAFFICABLE AREAS OF THIS BUILDING, SURFACES SHOULD BE SELECTED IN ACCORDANCE WITH AS HB 197: 1999 AND AS/ANZ 4586:2004

REFER TO STRUCTURAL FIRE ENGINEERS SPECIFICATIONS FOR ALL FIRE RATING RELATED REQUIREMENTS.

CONTRACTORS SHOULD BE REQUIRED TO MAINTAIN A TIDY WORK SITE DURING CONSTRUCTION, MAINTENANCE OR DEMOLITION TO REDUCE THE RISK OF TRIPS AND FALLS IN THE WORK PLACE. MATERIALS FOR CONSTRUCTION OR MAINTENANCE SHOULD BE STORED IN DESIGNATED AREAS AWAY FROM ACCESS WAYS AND WORK AREAS.

BUILDING OWNERS AND OCCUPIERS SHOULD MONITOR THE PEDESTRIAN ACCESS WAYS AND IN PARTICULAR ACCESS TO AREAS WHERE MAINTENANCE IS CARRIED OUT TO ENSURE THAT SURFACE HAVE NOT MOVED OR CRACKED SO THAT THEY BECOME UNEVEN AND PRESENT A TRIP HAZARD. SPILLS, LOOSE MATERIAL STRAY OBJECTS OR ANY OTHER MATTER THAT MAY CAUSE SLIP OR TRIP HAZARD SHOULD BE CLEANED OR REMOVED FROM ACCESS WAYS.

AUSTRALIAN STANDARDS COMPLIANCE SPECIFICATION:

AS 3959 - 2018 CONSTRUCTION OF BUILDINGS IN BUSHFIRE - PRONE AREAS SECTIONS 3 \$ 8 (BAL 40)

PLANNING FOR BUSHFIRE PROTECTION (PFBP) 2019 SECTION 7.5

AS 1562.1-2018 DESIGN AND INSTALLATION OF METAL ROOF AND WALL CLADDING

AS 3786 - SMOKE ALARMS

AS 2601 - DEMOLITION OF STRUCTURES

AS 4100 + AS 1554 STRUCTURAL STEFLWORK AS 3959 - 2009 CONSTRUCTION

AS 3600 - CONCRETE

AS 2870 - SITE CLASSIFICATION AS 2890 - DRIVEWAY GRADIENTS

AS 1562 - 1992 ROOF SHEETING

AS 2588 - 1998 PLASTERBOARD AS 3740 - 2010 WATERPROOF MEMBRANES

AS 3500 - PLUMBING AND DRAINAGE WORK

AS 4285 - 2007 SKYLIGHTS

AS 2047 + AS 1288 GLAZING ASSEMBLIES AS 1720.1 - 2010 TIMBER RETAINING WALLS

AS 3700 - 2011 + AS 3600 - 2009 RETAINING WALLS

AS/NZS 4200. I PLIABLE BUILDING MEMBRANES AND UNDERLAYS

NATIONAL CONSTRUCTION CODE

NCC 2022 - ABCB HOUSING PROVISIONS CODE

NOTE:

ALL PLUMBING AND DRAINAGE SYSTEMS TO BE IN ACCORDANCE WITH THE NATIONAL CONSTRUCTION CODE (NCC) **VOLUME THREE AND RELEVANT AUSTRALIAN STANDARDS**



ALL WINDOW + DOORS SIZES TO BE CHECKED AND CONFIRMED ON SITE BY SUPPLIER PRIOR TO MANUFACTURE REFER TO BASIX COMMITMENTS

BUSHFIRE PRONE LAND REFER TO "BUSHFIRE HAZARD SOLUTIONS" **BUSHFIRE ASSESSMENT REPORT 250669** SUMMARY AND RECOMMENDATIONS FOR ALL BAL RATING + BUSHFIRE RELATED CONSTRUCTION AND LANDSCAPING REQUIREMENTS INCLUDING PLANNING FOR BUSHFIRE PROTECTION (PBP) 2019

ALL EARTHWORKS "IF REQUIRED" TO COMPLY WITH CURRENT STATE ENVIRONMENTAL PLANNING POLICY REQUIREMENTS CLAUSE 3.30

SURVEYOR NOTE: SET OUT / SURVEY MARKS

PRIOR TO ANY CONSTRUCTION WORK, SURVEY MARKS SHOULD BE PLACED TO DEFINE THE PROPERTY BOUNDARIES.

NOTES + A.S, NCC SPECIFICATIONS



ACCREDITED

LUKE MCARTHUR + NICOLE MCDONALD

6 MOIRA PLACE FRENCHS FOREST 2086 CARPORT + STORE ROOM

DRAWING TITLE: NOTES + A.S, NCC SPECIFICATIONS. DATE: 05.09.24

DETAILS:

DRAWN: B.B CHECKED: L.M + N.M

SCALE: N.T.S **REVISIONS**:

A. First issue. Client for planning portal submission.

В. -C. -

D. -


STAGE: DEVELOPMENT APPLICATION (DA)

NORTH:

24.03.25

REVISION:

DRAWING No: 2 / 10

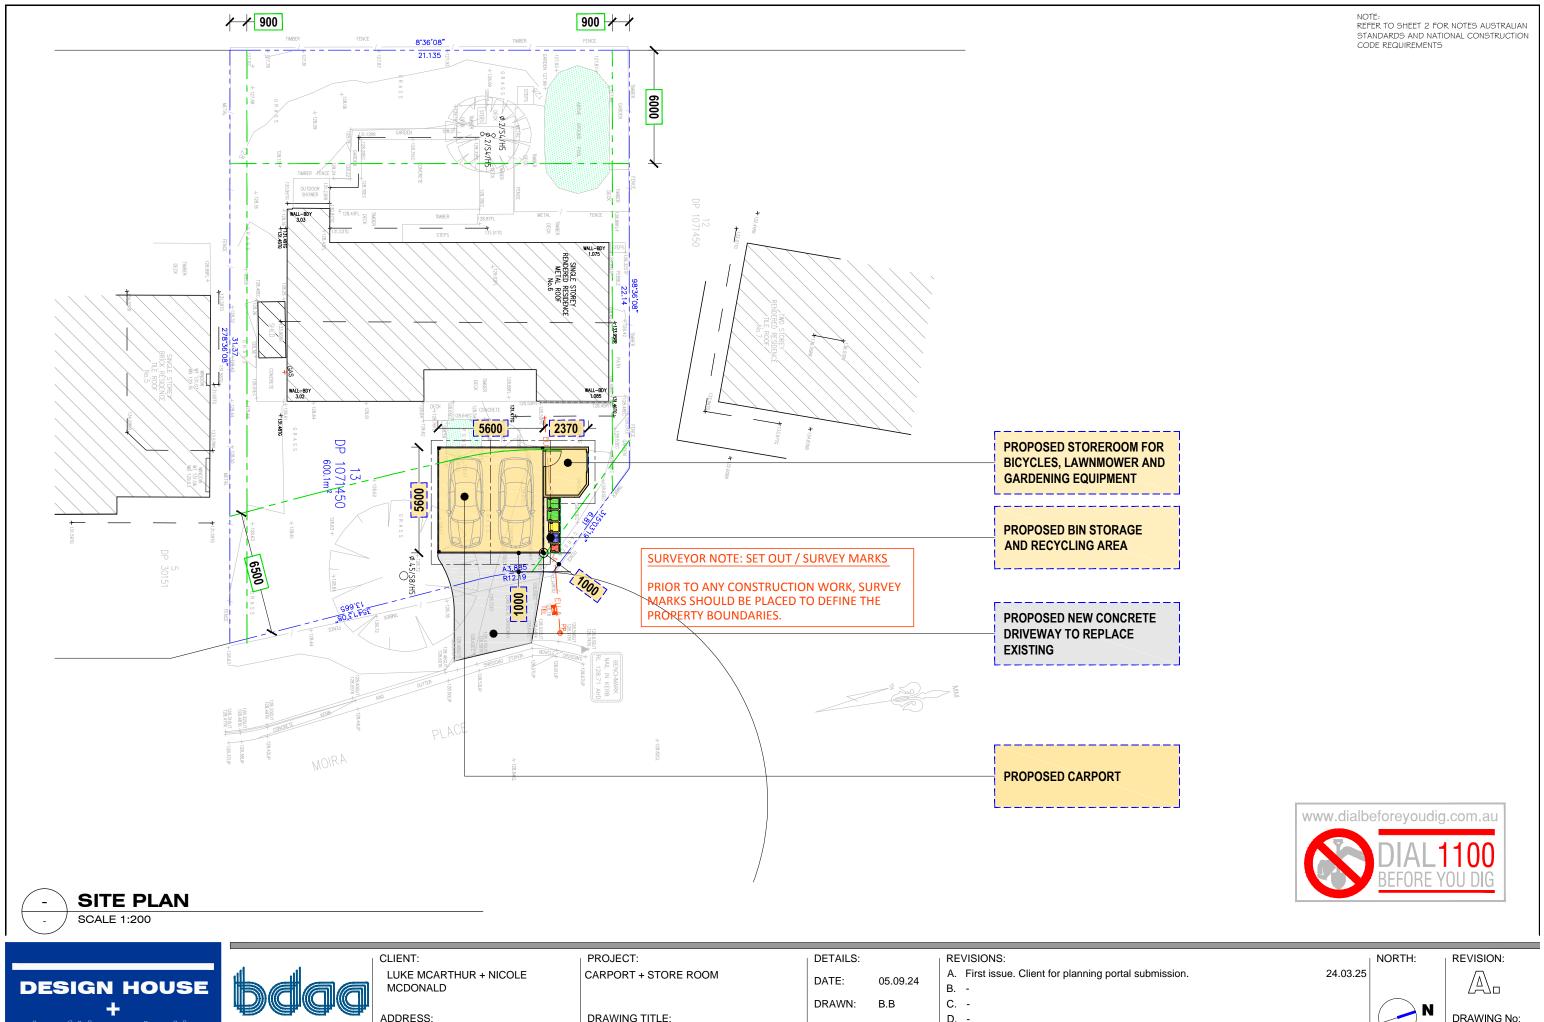





6 MOIRA PLACE FRENCHS FOREST 2086 DRAWING TITLE: SITE PLAN

CHECKED: L.M + N.M


1:200


SCALE:

STAGE: DEVELOPMENT APPLICATION (DA)



DRAWING No: 3 / 10

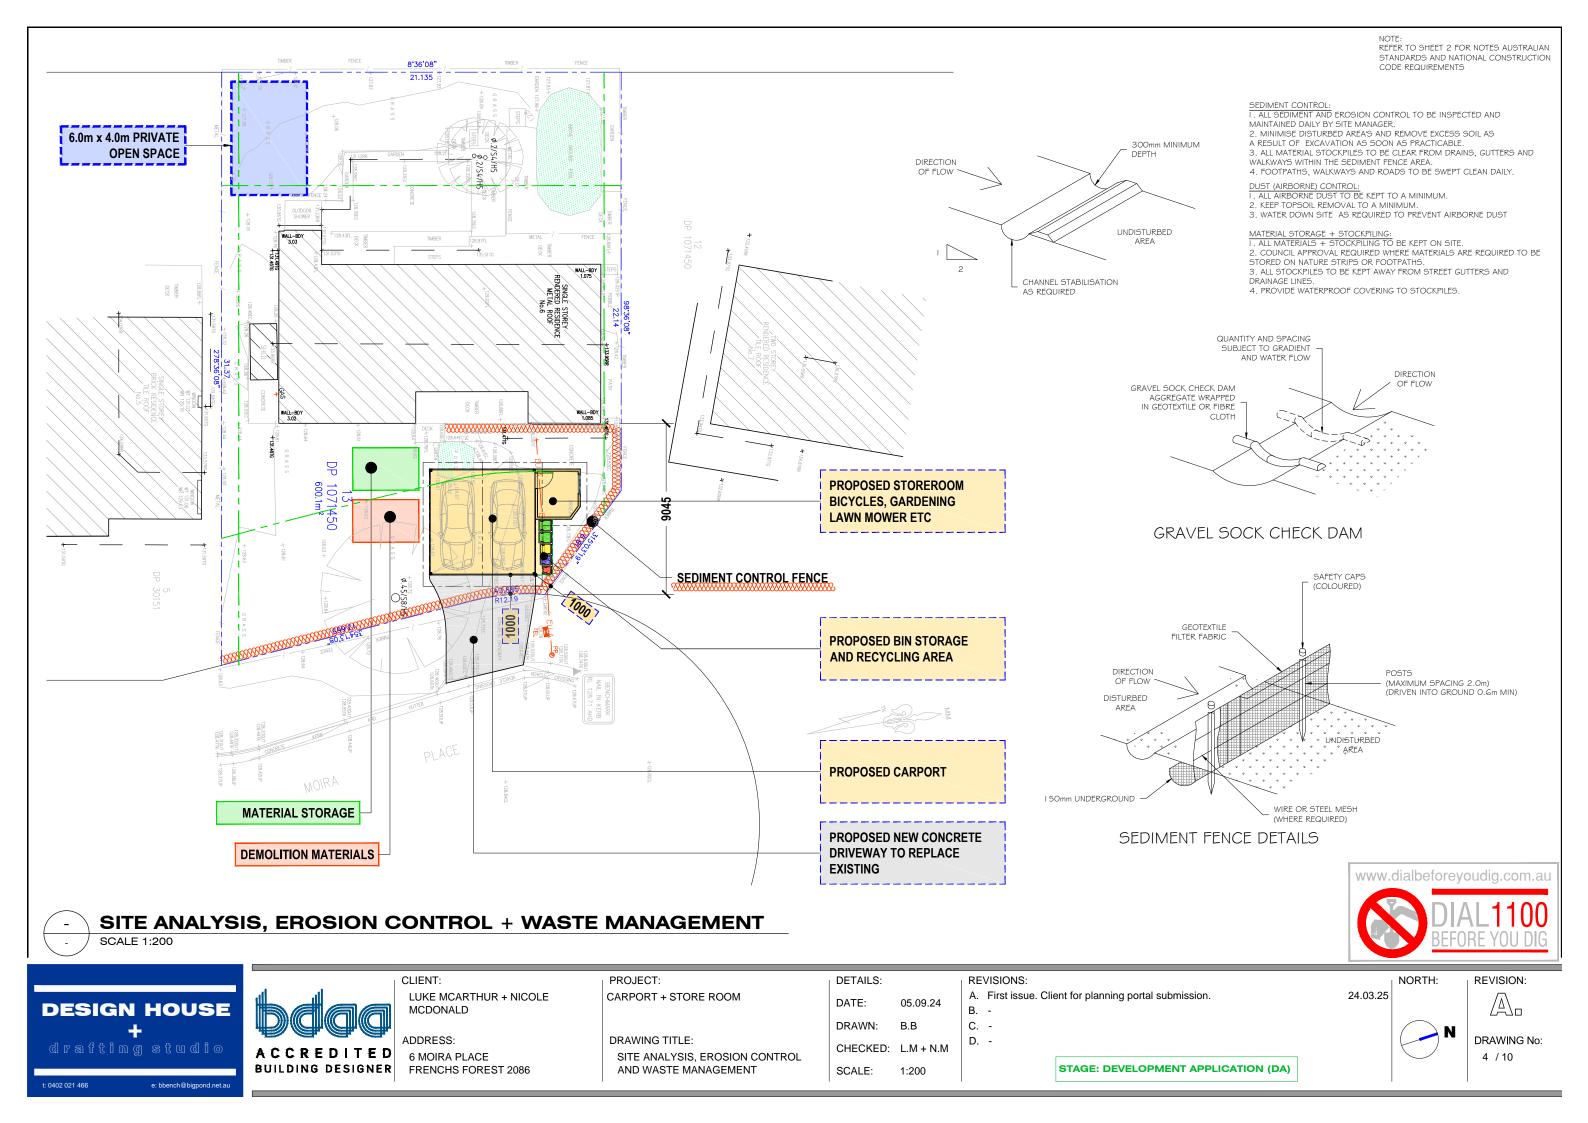

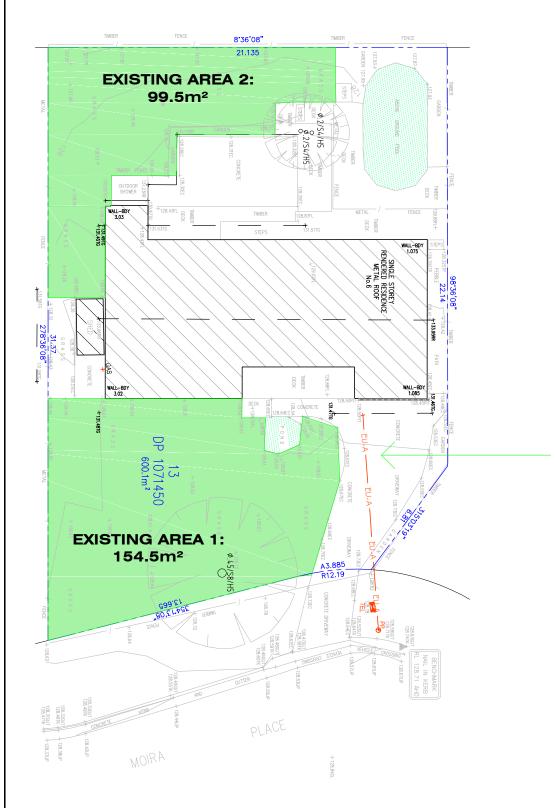

SITE AREA TOTAL (FROM SURVEY): 600.1m²

EXISTING LANDSCAPED AREA:

AREA 1 + AREA 2 254.0m² = 42.3%


PROPOSED LANDSCAPED AREA:

AREA 1 + AREA 2 + AREA 3

 $243.5m^2 = 40.5\%$

MINIMUM WIDTH 2.0m



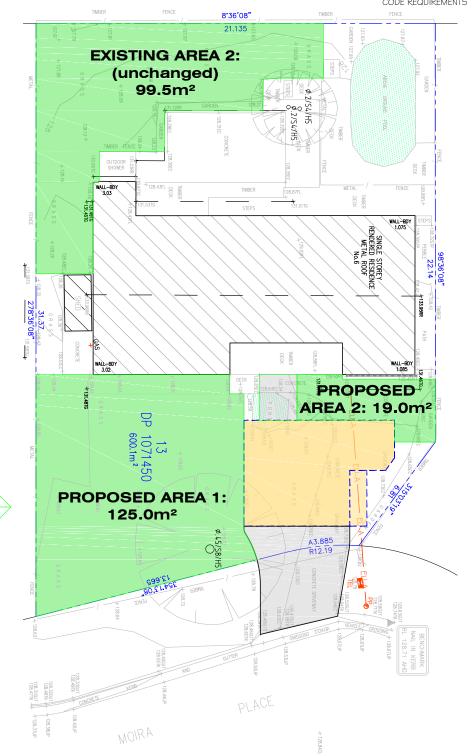



LANDSCAPE PLAN - PROPOSED

DESIGN HOUSE drafting studio

ACCREDITED BUILDING DESIGNER

LANDSCAPE PLAN - EXISTING

CLIENT: LUKE MCARTHUR + NICOLE MCDONALD

6 MOIRA PLACE FRENCHS FOREST 2086

PROJECT: CARPORT + STORE ROOM

DRAWING TITLE: LANDSCAPE PLAN

05.09.24 DATE: DRAWN: CHECKED: L.M + N.M

1:200

DETAILS:

SCALE:

A. First issue. Client for planning portal submission. B. -C. -


24.03.25

NORTH:

DRAWING No: 5 / 10

REVISION:

STAGE: DEVELOPMENT APPLICATION (DA)

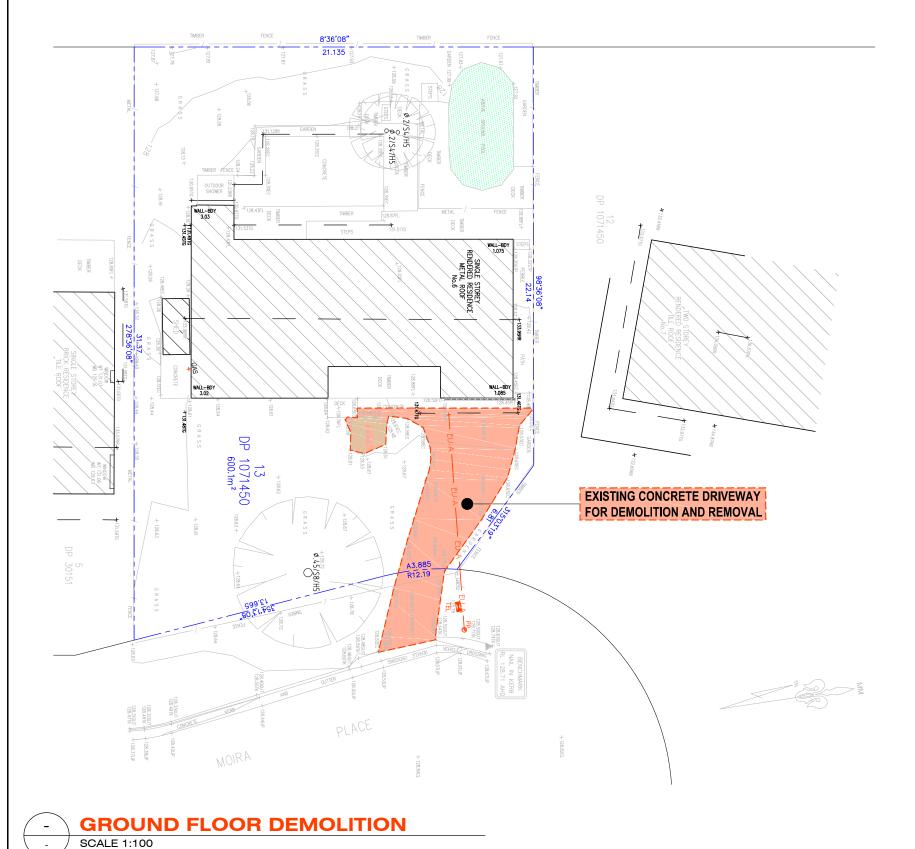

BUSHFIRE PRONE LAND
REFER TO "BUSHFIRE HAZARD SOLUTIONS"
BUSHFIRE ASSESSMENT REPORT 250669
SUMMARY AND RECOMMENDATIONS FOR ALL
BAL RATING + BUSHFIRE RELATED CONSTRUCTION
AND LANDSCAPING REQUIREMENTS INCLUDING
PLANNING FOR BUSHFIRE PROTECTION (PBP) 2019





LUKE MCARTHUR + NICOLE MCDONALD

ADDRESS:
6 MOIRA PLACE
FRENCHS FOREST 2086

PROJECT: CARPORT + STORE ROOM

DRAWING TITLE:
GROUND FLOOR DEMOLITION

DETAILS:

DATE: 05.09.24

DRAWN: B.B

DRAWN: B.B
CHECKED: L.M + N.M
SCALE: 1:100

REVISIONS:

A. First issue. Client for planning portal submission.

B. -

C. -


STAGE: DEVELOPMENT APPLICATION (DA)

24.03.25 NORTH:



REVISION:

DRAWING No: 6 / 10

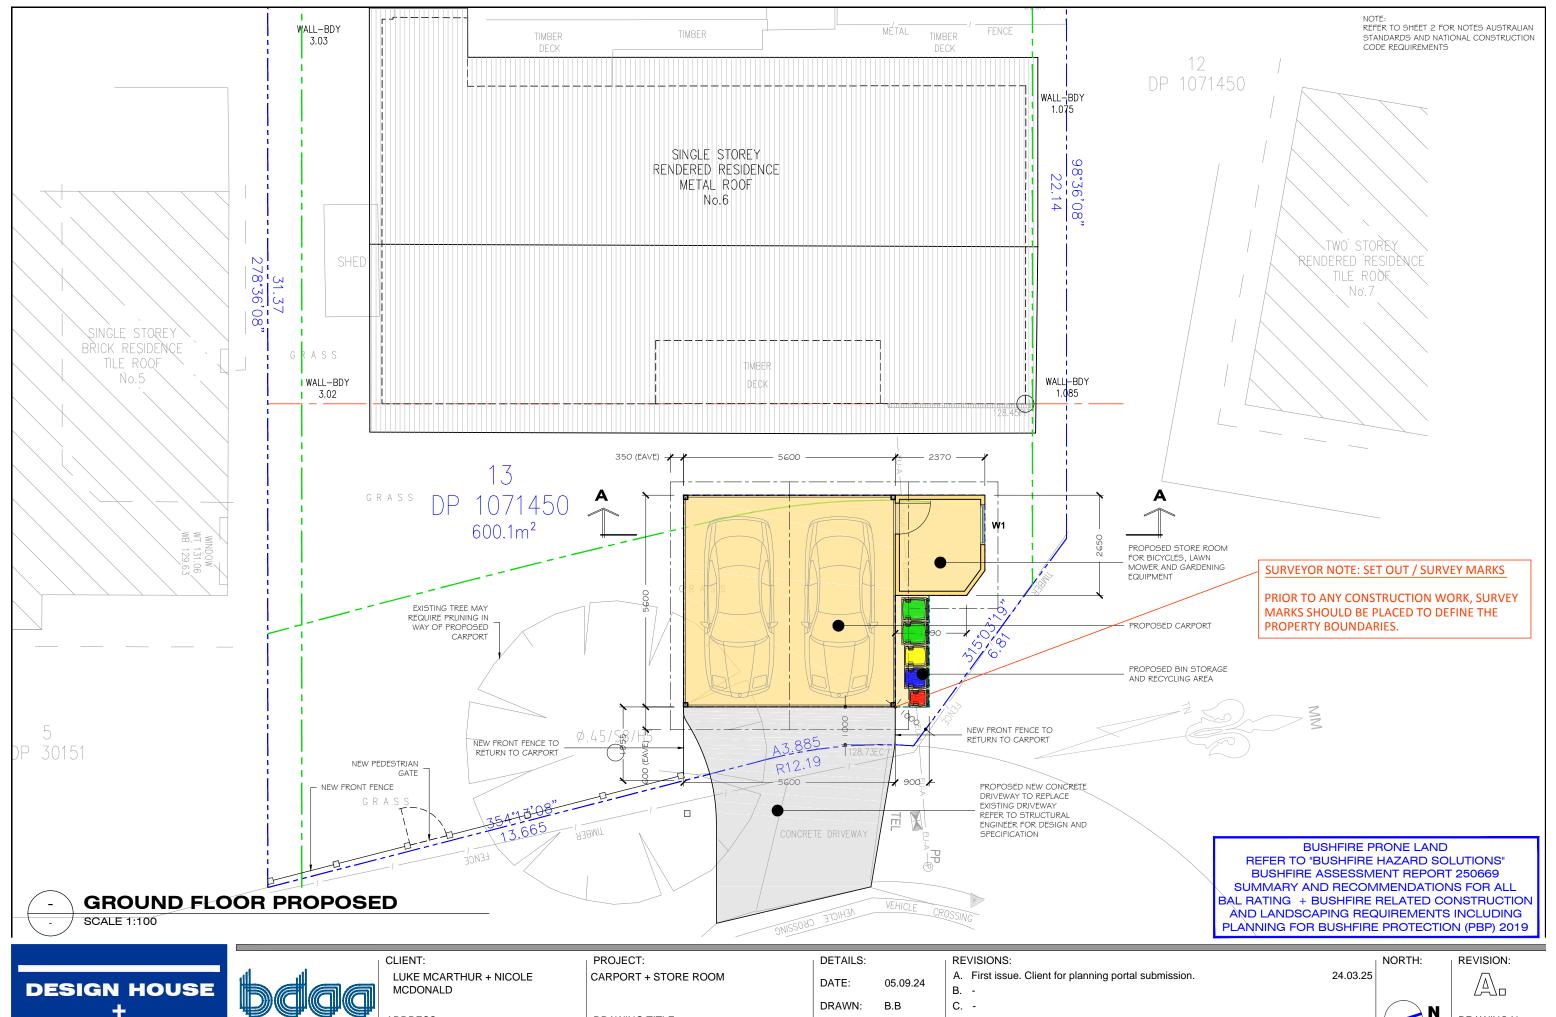






6 MOIRA PLACE FRENCHS FOREST 2086 DRAWING TITLE: GROUND FLOOR PROPOSED

CHECKED: L.M + N.M SCALE: 1:100

STAGE: DEVELOPMENT APPLICATION (DA)



DRAWING No: 7 / 10

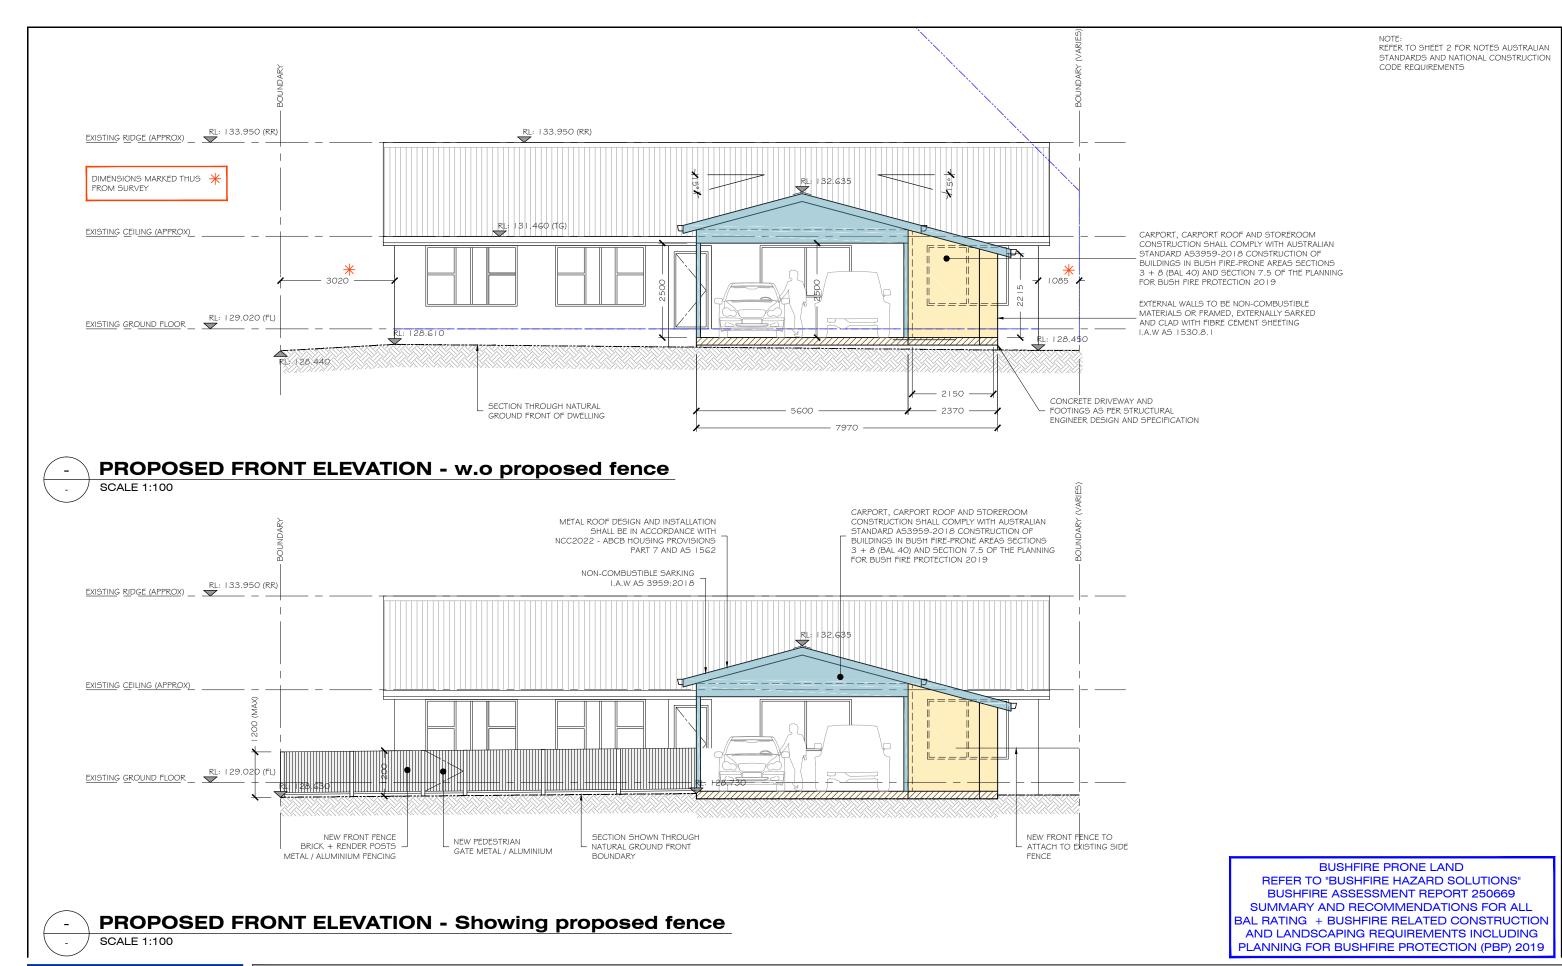





CLIENT: LUKE MCARTHUR + NICOLE MCDONALD

6 MOIRA PLACE FRENCHS FOREST 2086

PROJECT: CARPORT + STORE ROOM

DRAWING TITLE: PROPOSED ELEVATIONS 1

05.09.24 B. -B.B C. -CHECKED: L.M + N.M

DETAILS:

DRAWN:

SCALE:

1:100

DATE:


A. First issue. Client for planning portal submission.

24.03.25

REVISION:

STAGE: DEVELOPMENT APPLICATION (DA)

DRAWING No: 8 / 10

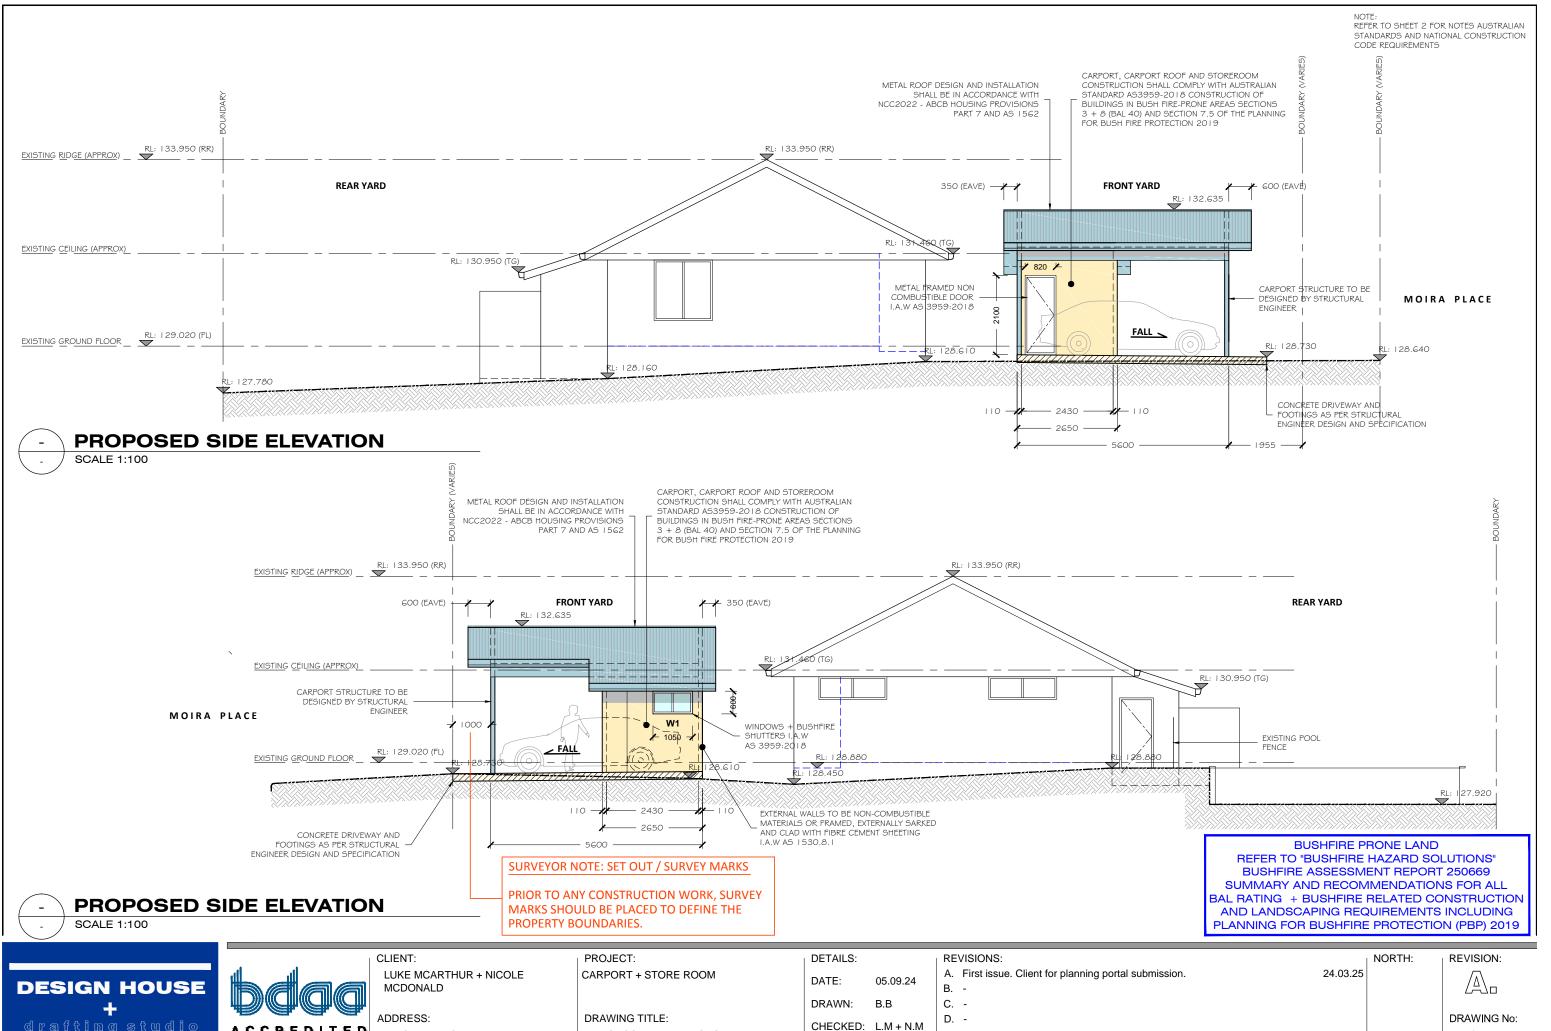






6 MOIRA PLACE FRENCHS FOREST 2086 PROPOSED ELEVATIONS 2


SCALE:

1:100

9 / 10

STAGE: DEVELOPMENT APPLICATION (DA)

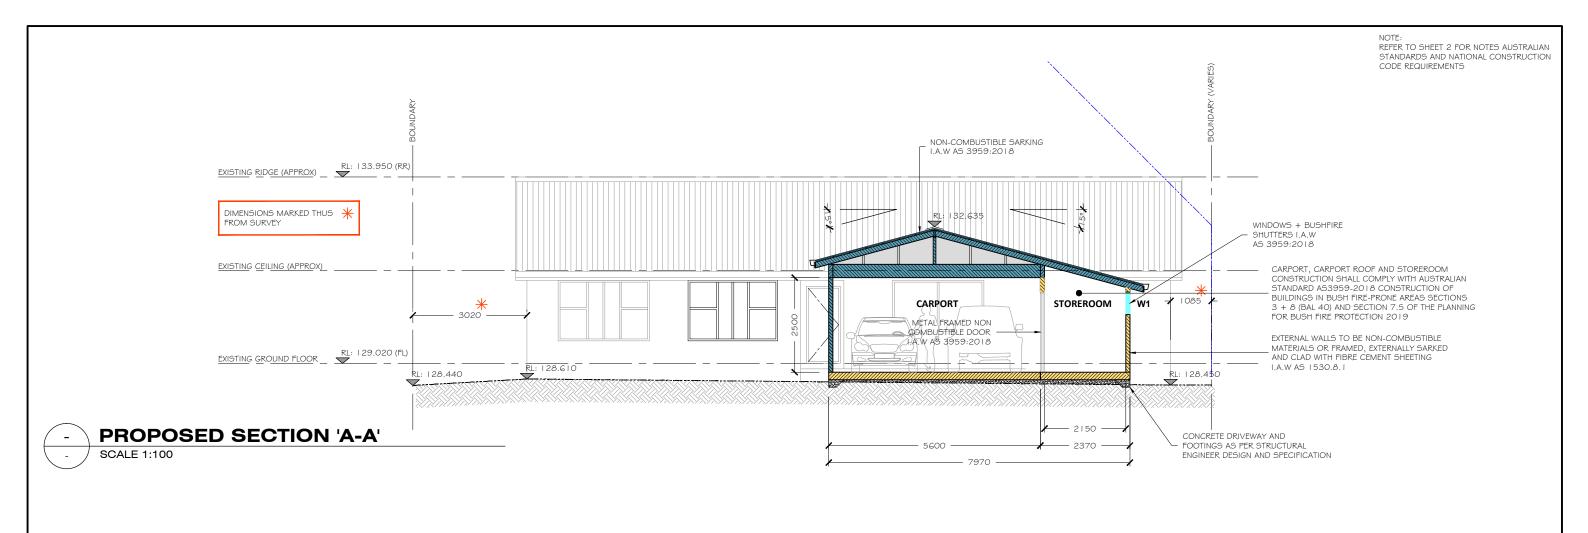

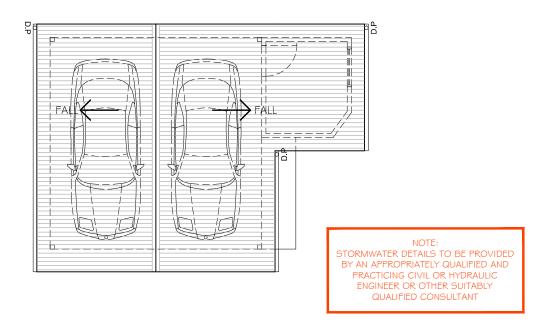

MATERIAL FINISHES + COLOURS :

ROOF: MONUMENT

GUTTERS + FLASHINGS : MONUMENT

DOWNPIPES: MONUMENT

EXTERNAL WALLS: BALTIC SAND

STOREROOM WINDOW:
ALUMINIUM FRAMES: WHITE



Dultux
Battic Sand
201544

BUSHFIRE PRONE LAND
REFER TO "BUSHFIRE HAZARD SOLUTIONS"
BUSHFIRE ASSESSMENT REPORT 250669
SUMMARY AND RECOMMENDATIONS FOR ALL
BAL RATING + BUSHFIRE RELATED CONSTRUCTION
AND LANDSCAPING REQUIREMENTS INCLUDING
PLANNING FOR BUSHFIRE PROTECTION (PBP) 2019

24.03.25



SCALE 1:100



PROPOSED ROOF PLAN

CLIENT: LUKE MCARTHUR + NICOLE MCDONALD

ADDRESS: 6 MOIRA PLACE FRENCHS FOREST 2086 PROJECT: CARPORT + STORE ROOM

DRAWING TITLE:
PROPOSED SECTION 'A-A'
+ ROOF PLAN + COLOURS

DETAILS:

DATE: 05.09.24

DRAWN: B.B

DRAWN: B.B

CHECKED: L.M + N.M

SCALE: 1:100

REVISIONS:

A. First issue. Client for planning portal submission.

B. C. D.
STAGE: DEVELOPMENT APPLICATION (DA)

NORTH

REVISION:

DRAWING No: 10/10