

- 6. ROOF FINISHES TO BE IN ACCORDANCE WITH THE BASIX REPORT.
- 7. EXTERNAL WALL FINISHES TO BE IN ACCORDANCE WITH THE BASIX REPORT.
- 8. ALL WINDOWS AND DOORS TO HAVE WEATHER STRIPPING.
- 9. ALL WINDOWS & DOORS AS NOTED ON PLAN WITH SPECIFIED COLOUR FINISH.
- 10. ALL PAINTING TO OWNERS REQUIREMENTS.
- 11. ALL POWER OUTLETS & SWITCHES TO OWNERS REQUIREMENTS.
- 12. ALL GLAZING TO CODE AS1288
- 14. SMOKE DETECTOR DENOTED SD ON PLAN TO BCA/39
- 16. ALL TIMBER FRAMING TO CODE AS1684
- 17. ALL WORK CARRIED OUT TO BE IN ACCORDANCE WITH THE BCA.

- SHEETING THRU-OUT IN ACCORDANCE WITH THE BASIX REPORT.

- 13. ALL PEST TREATMENT TO CODE AS3660.1-2000
- 15. ALL WATERPROOFING TO WET AREAS TO CODE AS3740



PART 3.8 OF THE B.C.A. AND AS3740

WITH PART 3.8.3 OF THE B.C.A.

- ALL DAMP AND WEATHERPROOFING TO COMPLY WITH PART 3.8 OF THE B.C.A.

- FLOOR SURFACES OF WATER CLOSETS, SHOWER COMPARTMENTS AND THE A LIKE

TO BE OF MATERIALS IMPERVIOUS TO MOISTURE AND WALLS FINISHED WITH AN

CLOTHS WASHING, DRYING AND COOKING FACILITIES TO BE PROVIDED TO COMPLY

- ROOFING TO COMPLY WITH PART 3.5.1 OF THE B.C.A. AND AS/NZ1562

APPROVED IMPERVIOUS FINISH TO COMPLY WITH THE REQUIREMENTS OF

ABN 65 687 862 151 | Builders Lic. 158741C

ABOVE NOTES TO BE READ IN-CONJUNCTION

WITH THE ARCHITECTURAL PLANS AND THE

STRUCTURAL ENGINEERS DETAILS

Address: 39 Gavenlock Road Tuggerah NSW 2259 Australia PO Box: 5240 Chittaway Bay NSW 2261 Australia P 4352 1189 | F 4352 1198 | E info@classicbuilding.com.au W www.classicbuilding.com.au

© This drawing and design remains the property of CLASSIC COUNTRY COTTAGES and may not be copied in whole or in part without prior approval of **CLASSIC COUNTRY COTTAGES**

DA ISSUE PLANS

CLIENT: MR. R. & MRS. M. LOWERY 66 ADAMS STREET CURL CURL

PROPOSED NEW DWELLING:

SITE PLAN

| JOB No. | CC150 | REV: | С | PAGE No. | 01 |
|---------|------------|--------|-------|----------|-------|
| DATE: | 26/10/2018 | SCALE: | 1:200 | DRAWN: | B. W. |

ROOF AREA TO RAINWATER TANK (MINIMUM) INDIGENOUS OR LOW WATER USE SPECIES OF VEGETATION HOT WATER SERVICE TO BE GAS INSTANTANEOUS WITH A PERFORMANCE OF 4.5 STARS OR BETTER.

COOLING SYSTEM IN AT LEAST 1 LIVING AREA & 1 BEDROOM: CEILING FANS + 3-PHASE A/C; EER 3.0-3.5 HEATING SYSTEM IN AT LEAST 1 LIVING AREA & 1 BEDROOM: 3-PHASE A/C; EER 3.0-3.5

THE FOLLOWING ROOMS REQUIRE "DEDICATED" LED LIGHTING: AT LEAST 5 BEDROOMS/STUDY, AT LEAST 3 LIVING/DINING ROOMS, THE KITCHEN, ALL BATHROOMS/TOILETS, THE LAUNDRY, ALL HALLWAYS.

A WINDOW AND/OR SKYLIGHT MUST BE INSTALLED IN THE FOLLOWING ROOMS: THE KITCHEN & 4 BATHROOMS/TOILETS.

TO BE READ IN CONJUNCTION WITH NaTHERS CERTIFICATE No: 0002873016-01

WALLS TO BE FIBRO CAVITY PANEL ON BATTENS, ROOF TO BE CORRUGATED IRON, FLOOR TO BE SUSPENDED TIMBER FLOOR + CONCRETE SLAB ON GROUND

R2.5 WALL INSULATION, R4.0 CEILING INSULATION, R3.0 FLOOR INSULATION

PROPOSED GROUND FLOOR REAR DECK AREA _____ = 30.0

PROPOSED FIRST FLOOR FRONT DECK AREA _____ = 19.2

POST LANDSCAPED AREA > 2.0m WIDE (SEE LANDSCAPE PLAN) = 258.5

OTHER PAVED AREAS (SEE LANDSCAPE PLAN) = 325.3

TOTAL PROPOSED O.S.D. IMPERVIOUS AREA ._____ = 378.8

PROPOSED TOTAL FIRST FLOOR AREA

POST DEVELOPMENT HARDSTAND

2 CAR PARKING SPACES PROVIDED IN GARAGE

ALM-001-03 A ALUMINIUM A SG HIGH SOLAR GAIN LOW-E & ALM-001-03 A ALUMINIUM B SG HIGH SOLAR GAIN LOW-E


4.8 ertificate date: HOUSE 66 Adams Stree 70 MJ/m


Jamie Bonnefin 100765 25 Jun 2018


sq. m.


SQ. M




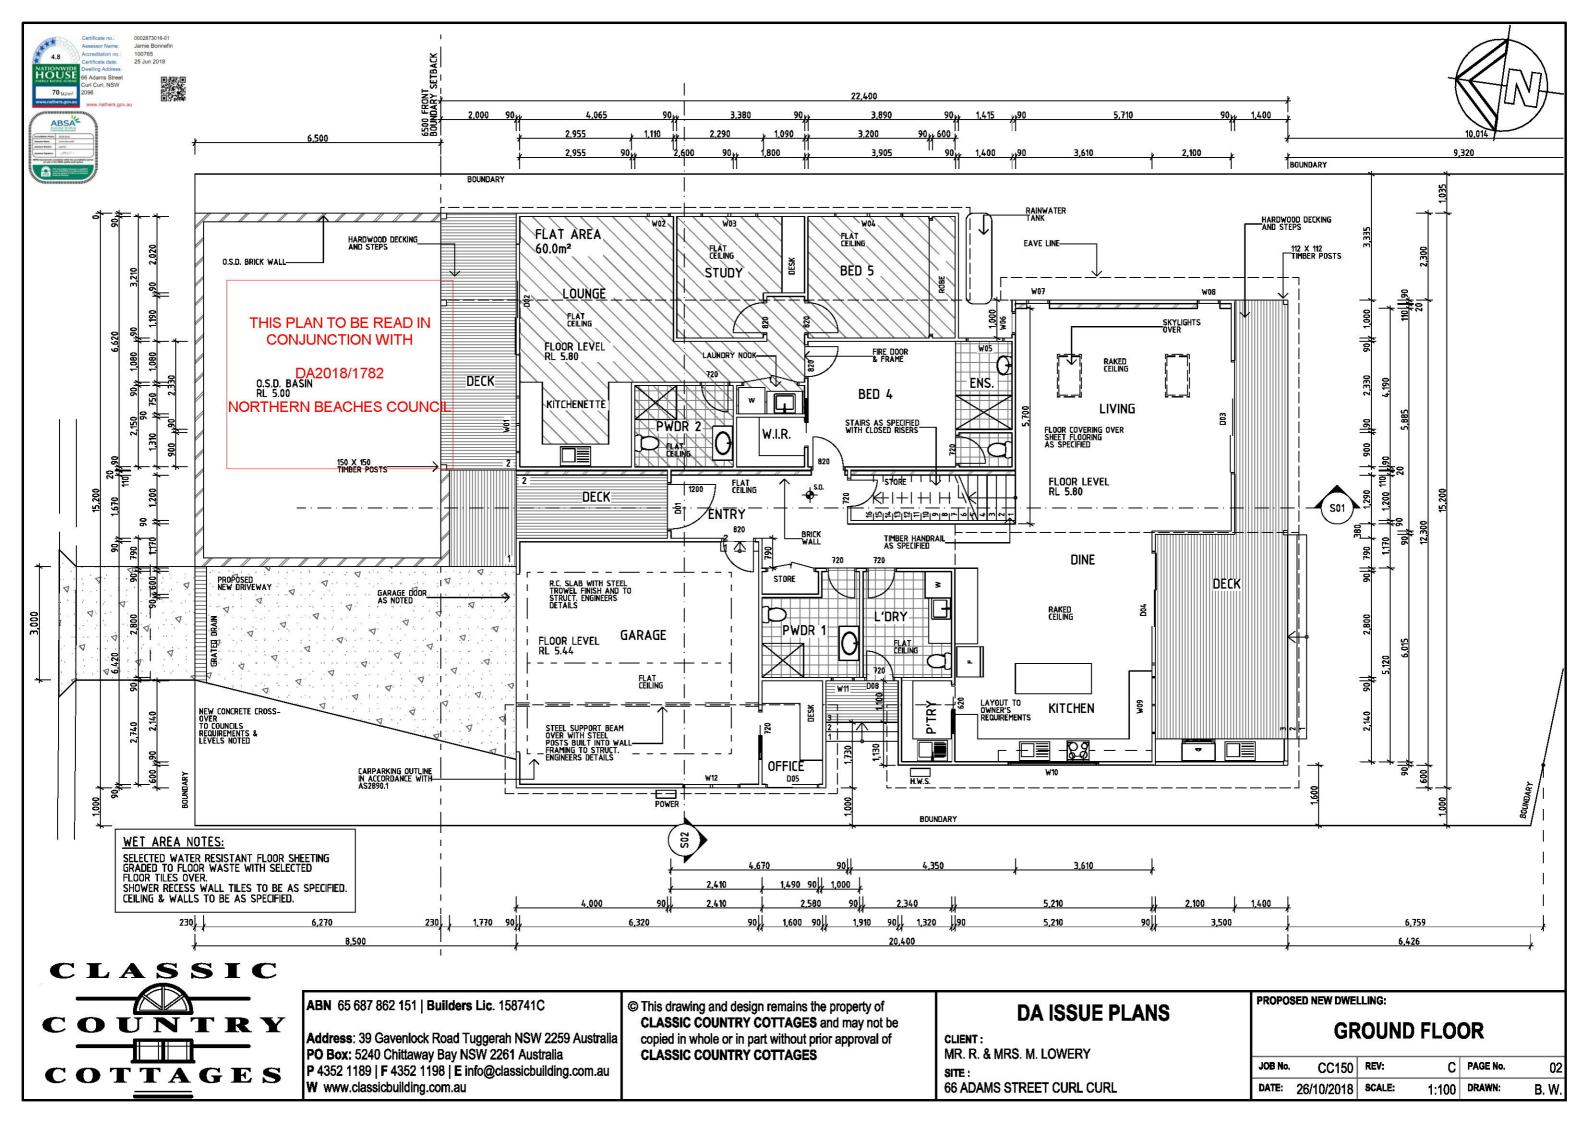


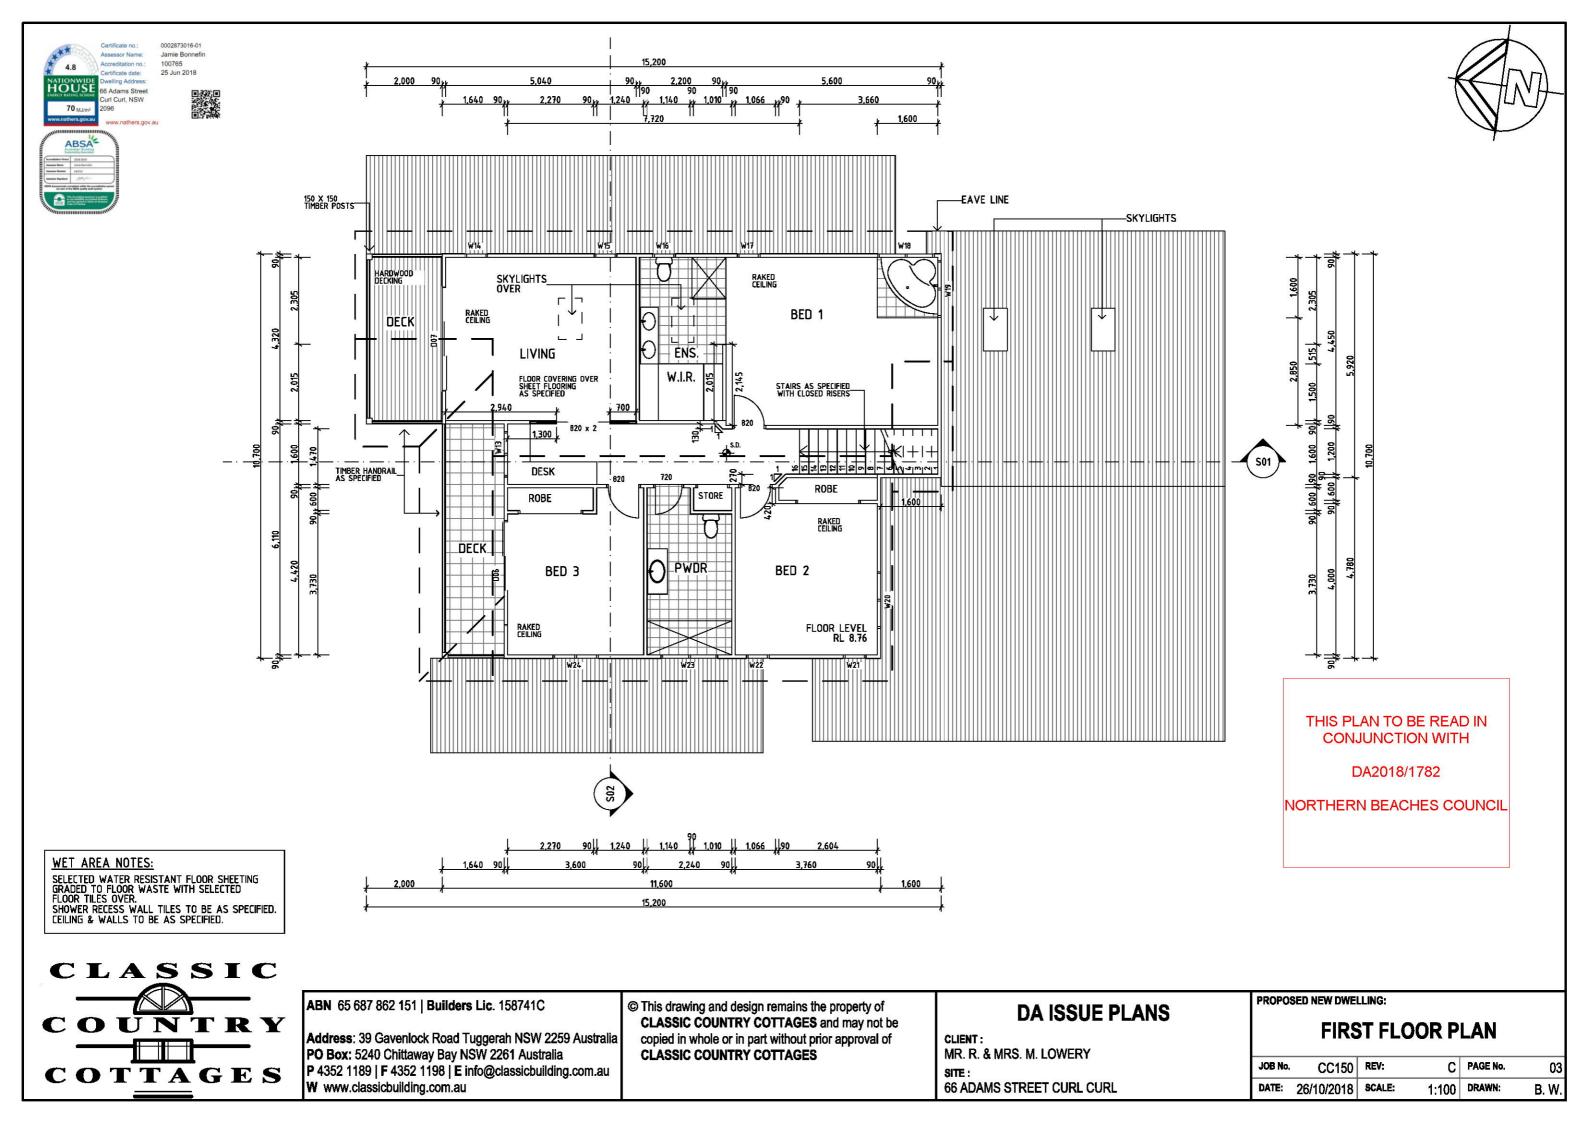


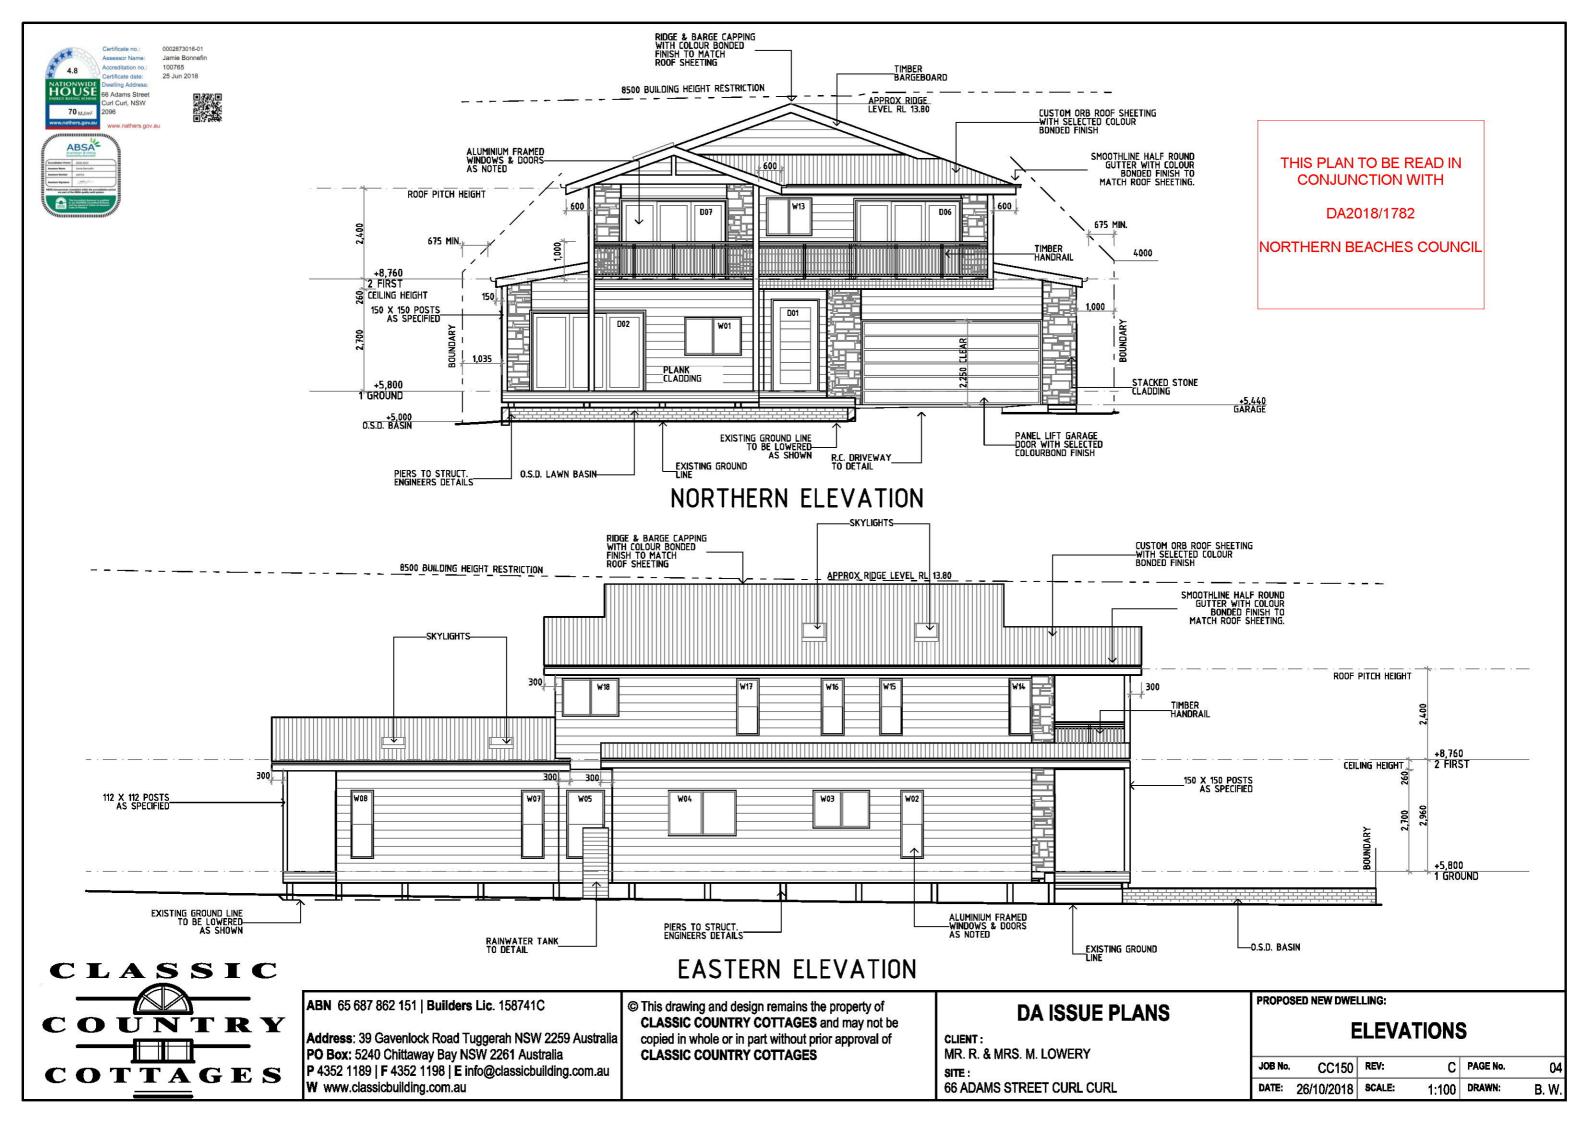

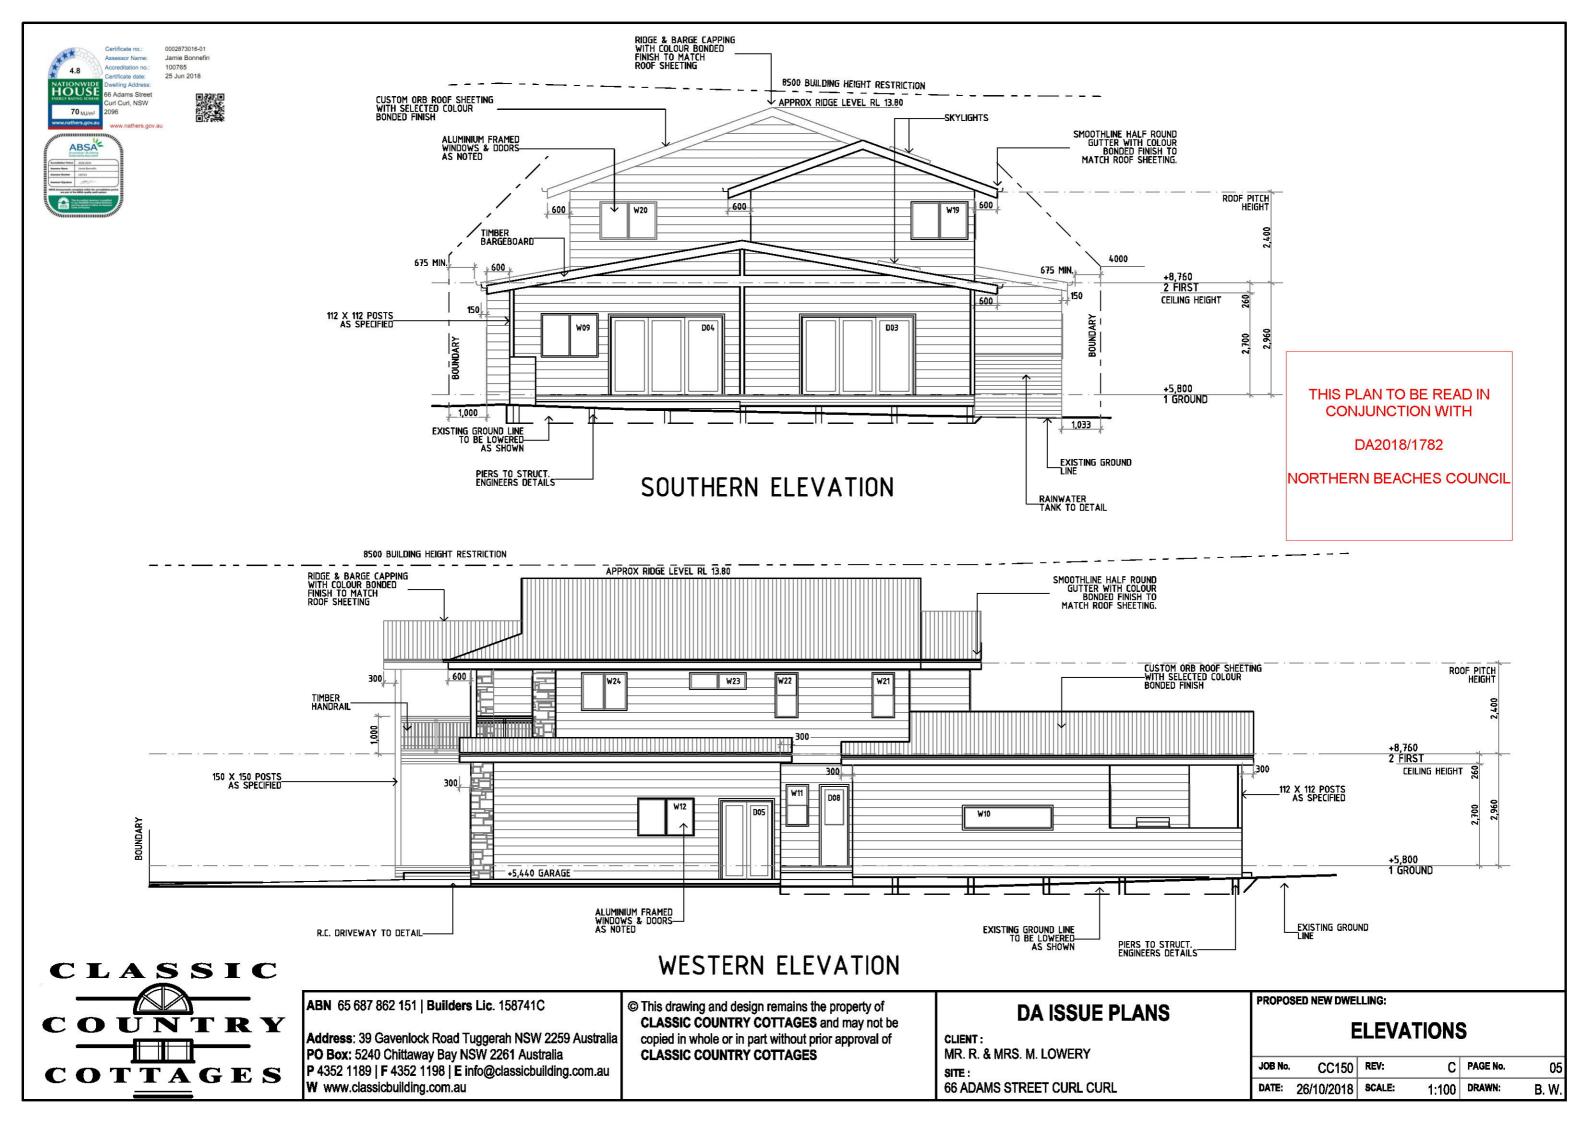


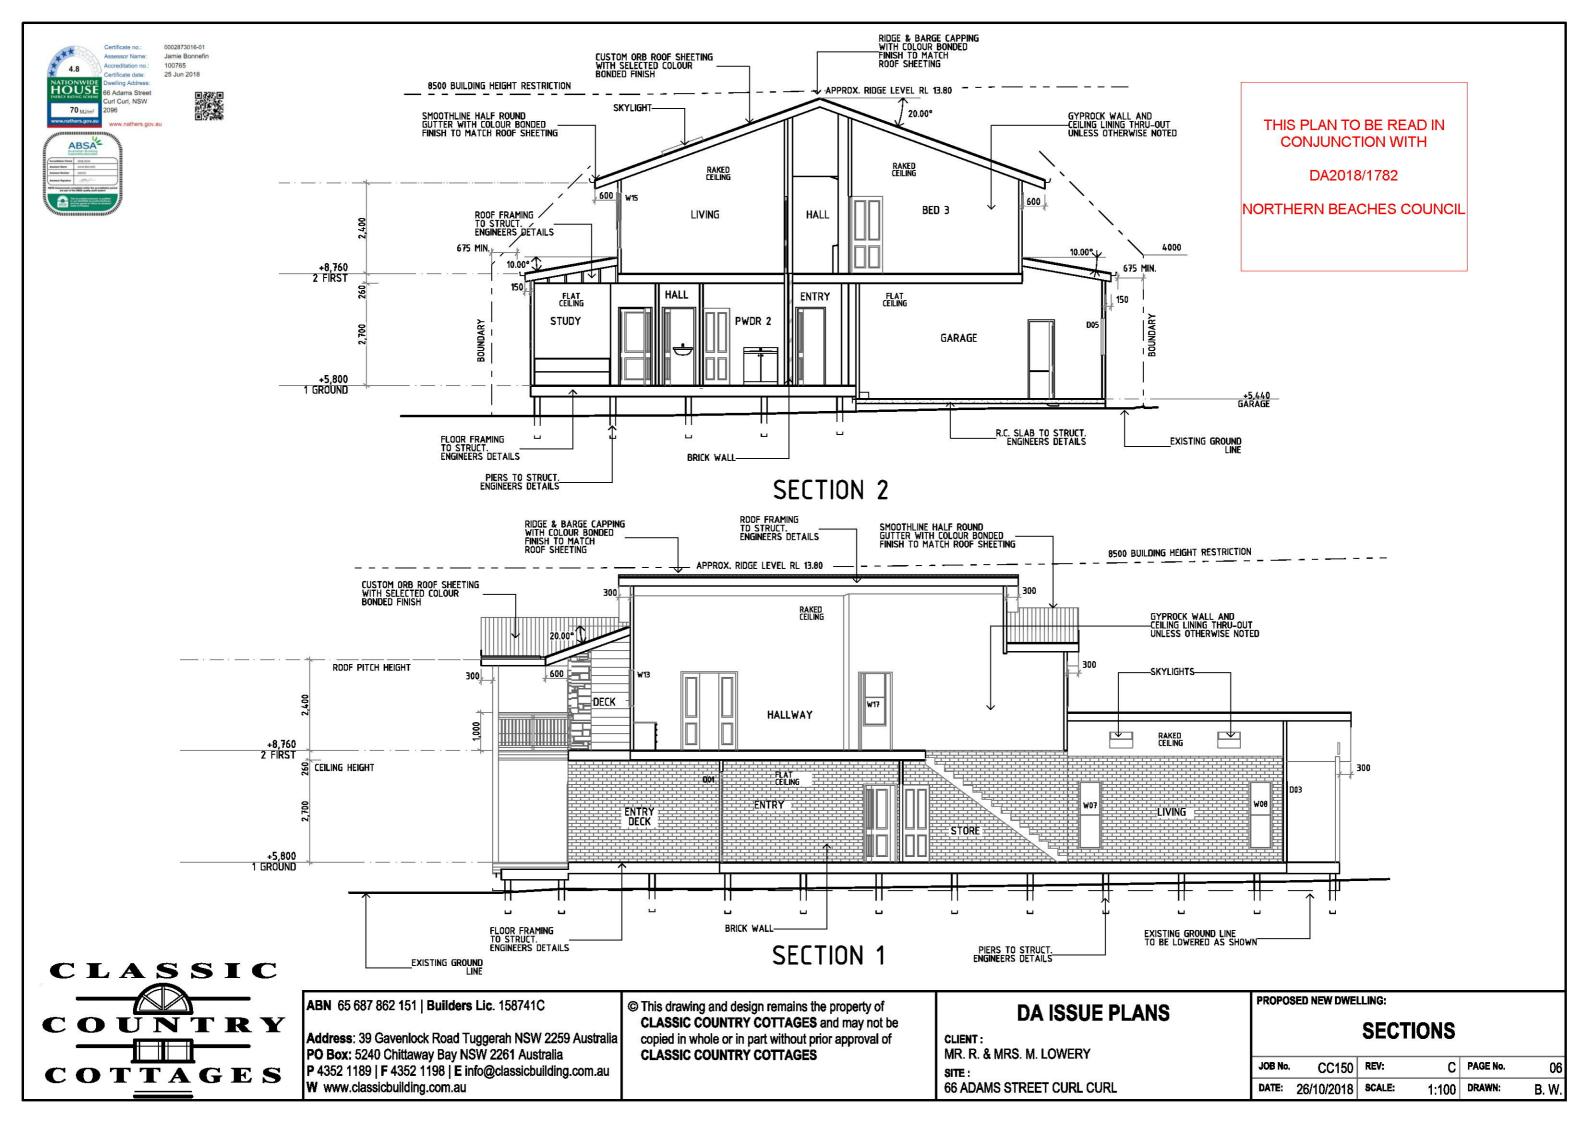

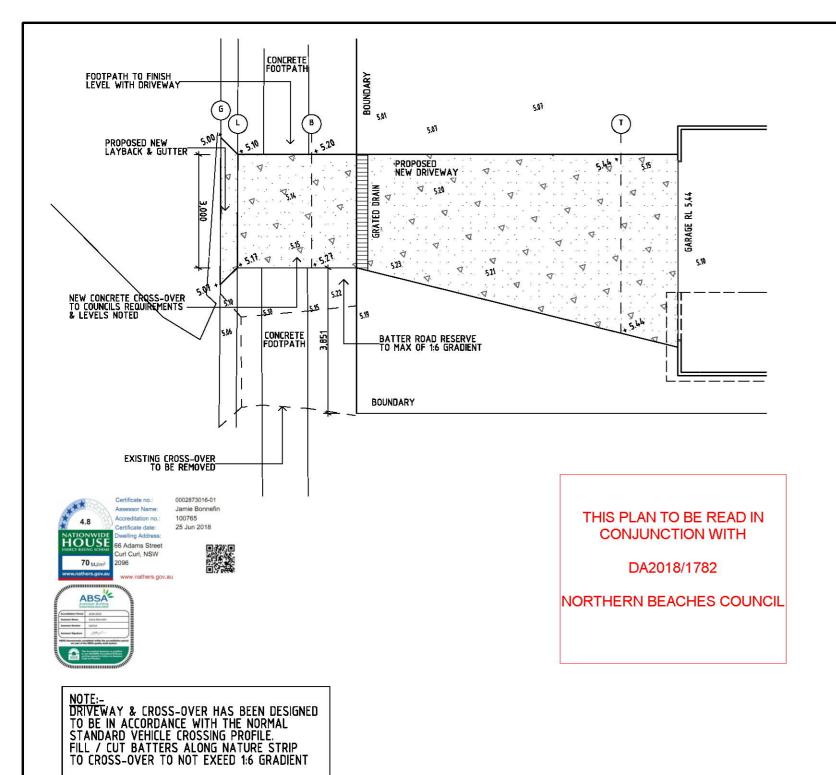

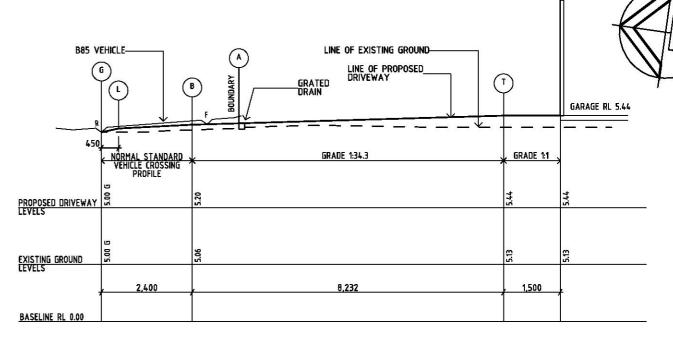

LONGITUDINAL SECTION ON EASTERN EDGE OF DRIVEWAY

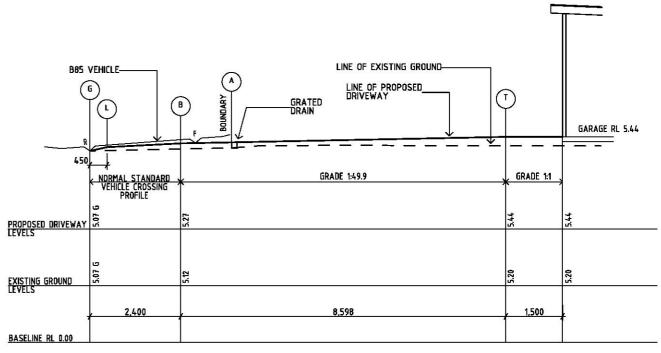

LONGITUDINAL SECTION ON WESTERN EDGE OF DRIVEWAY

CLASSIC COUNTRY COTTAGES

NOTE:DRIVEWAY CROSSOVER TO BE IN ACCORDANCE
WITH THE COUNCIL'S CIVIL INFRASTRUCTURE
WORKS, DEVELOPMENT & SUBDIVISION 2003 AND
AUSTRALIAN STANDARD AS1428.1:2001-DESIGN
FOR ACCESS AND MOBILITY & TO PROVIDE FOR

INTERNAL DRIVEWAY FINISH IS TO BE STABLE SURFACE FOR ALL WEATHER CONDITIONS.

ABN 65 687 862 151 | Builders Lic. 158741C

Address: 39 Gavenlock Road Tuggerah NSW 2259 Australia PO Box: 5240 Chittaway Bay NSW 2261 Australia P 4352 1189 | F 4352 1198 | E info@classicbuilding.com.au W www.classicbuilding.com.au

This drawing and design remains the property of CLASSIC COUNTRY COTTAGES and may not be copied in whole or in part without prior approval of CLASSIC COUNTRY COTTAGES


DA ISSUE PLANS


CLIENT:
MR. R. & MRS. M. LOWERY
SITE:
66 ADAMS STREET CURL CURL


PROPOSED NEW DWELLING:

DRIVEWAY SET-OUT PLAN

| JOB No. | CC150 | REV: | С | PAGE No. | 07 |
|---------|------------|--------|-------|----------|-------|
| DATE: | 26/10/2018 | SCALE: | 1:100 | DRAWN: | B. W. |

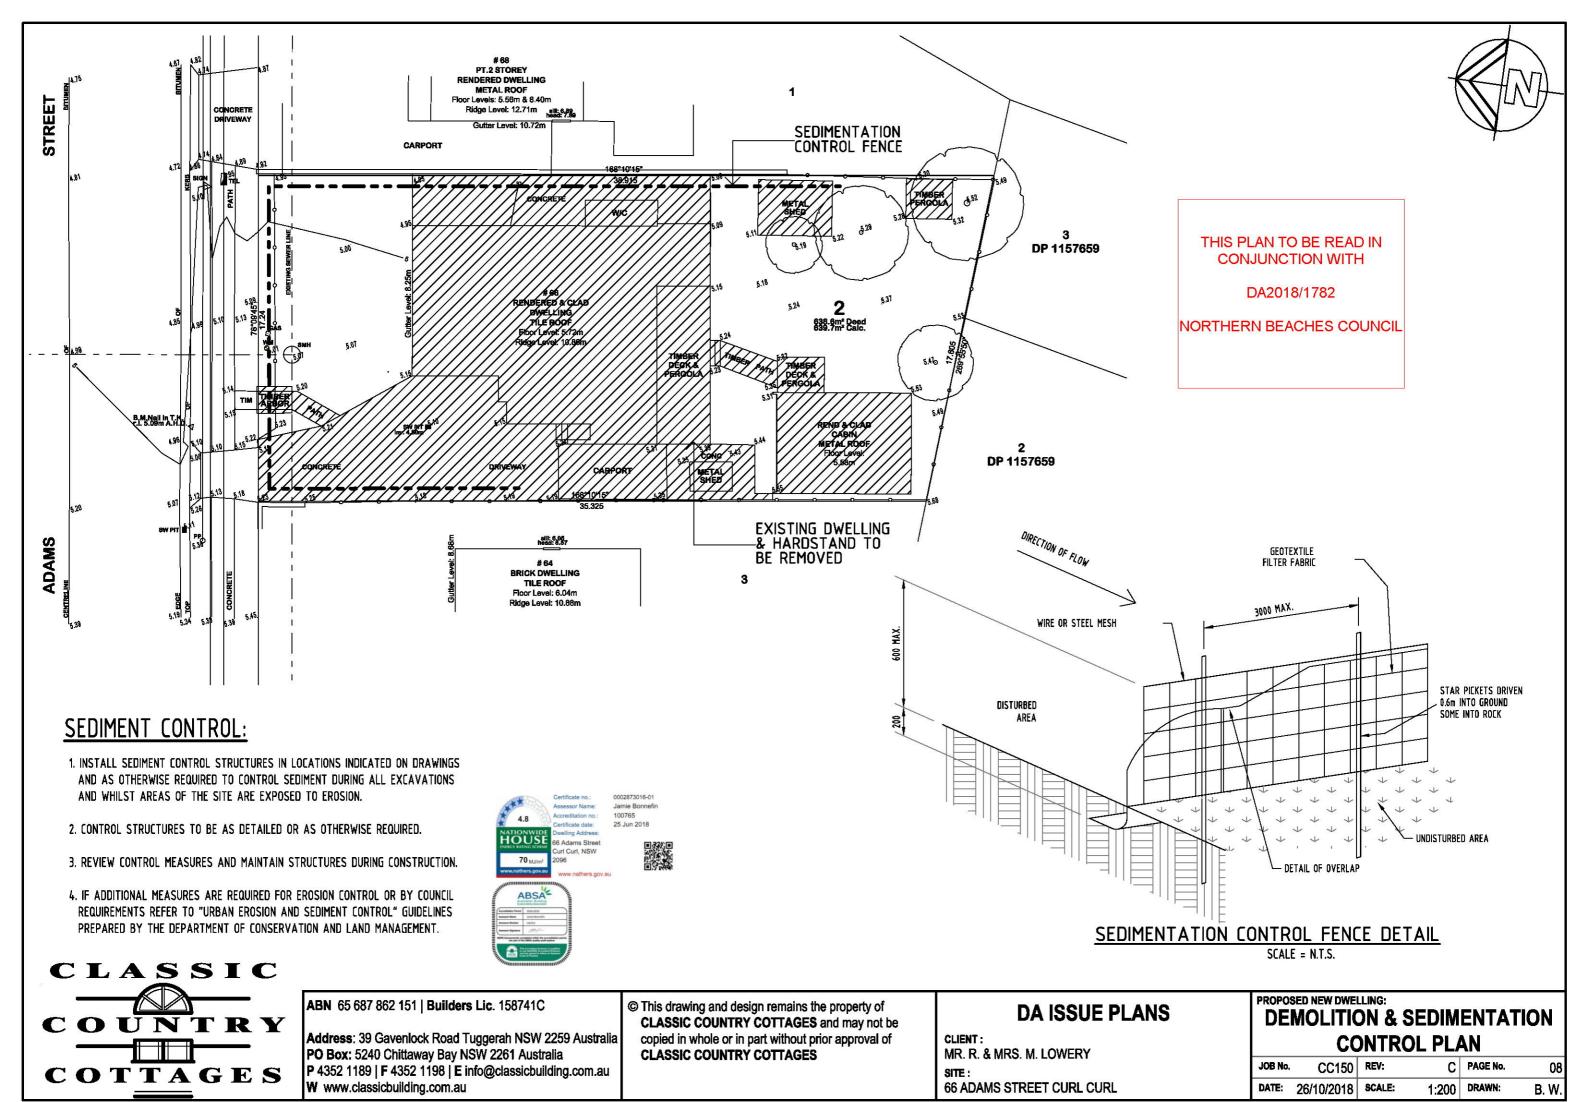

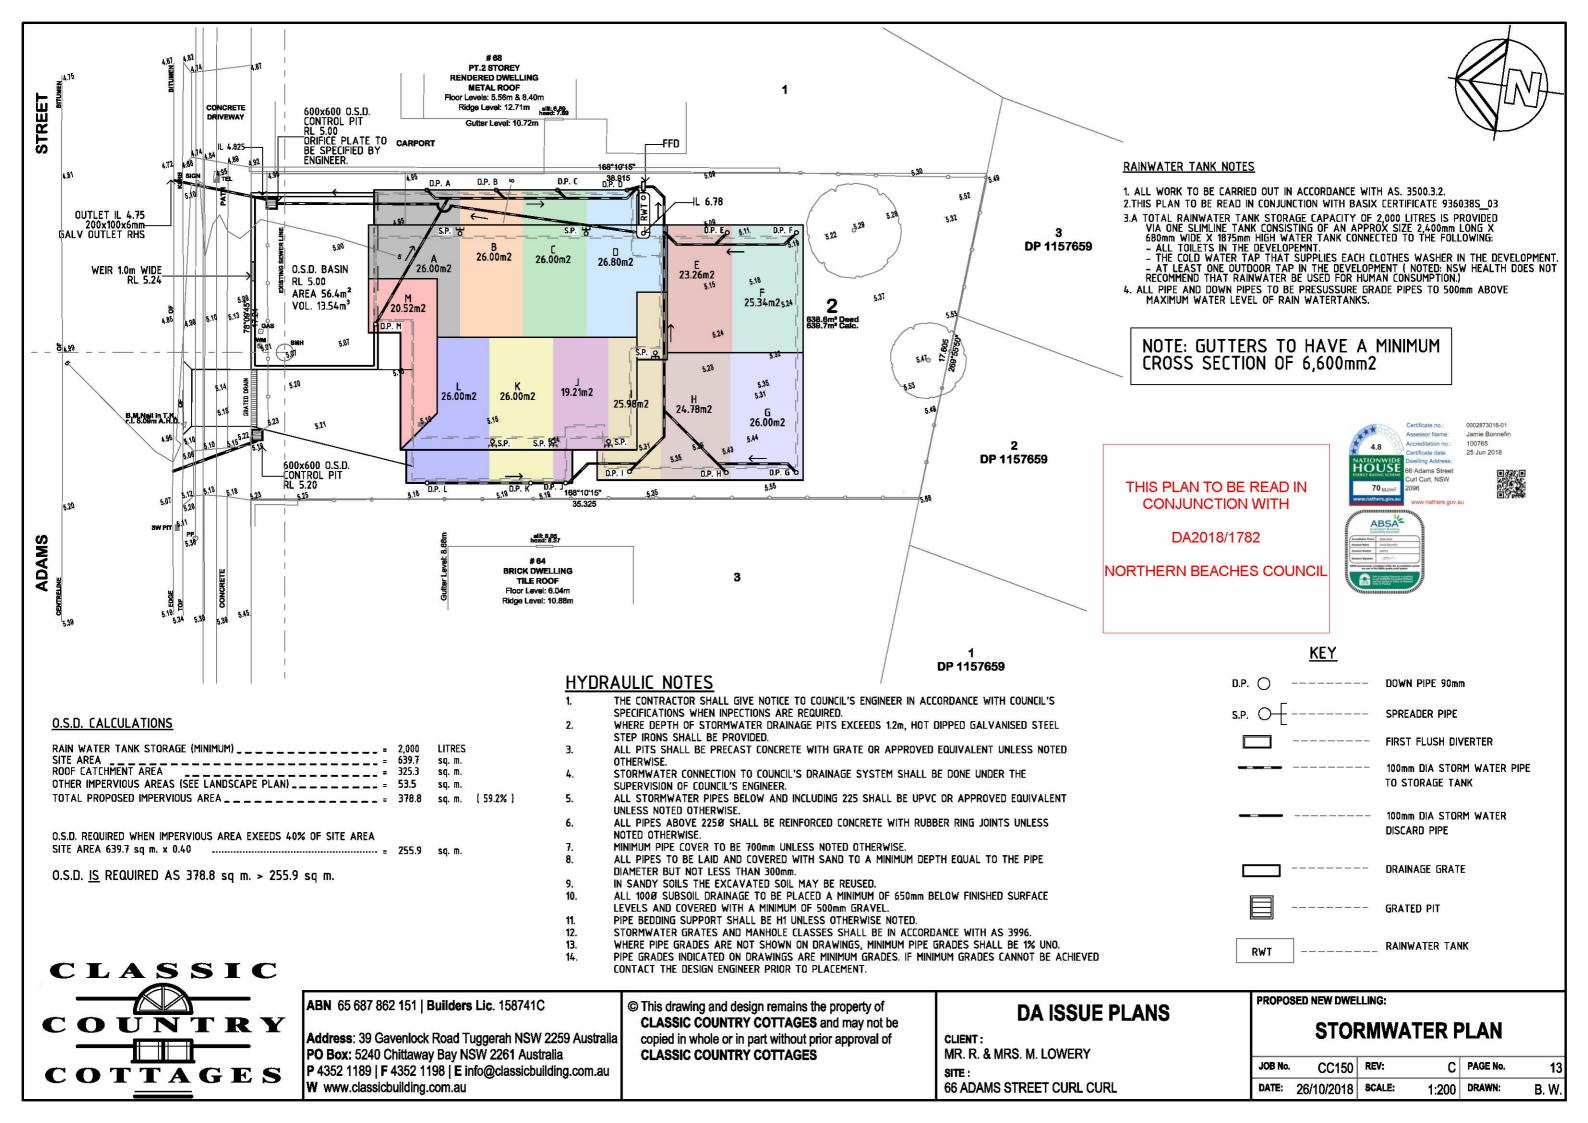

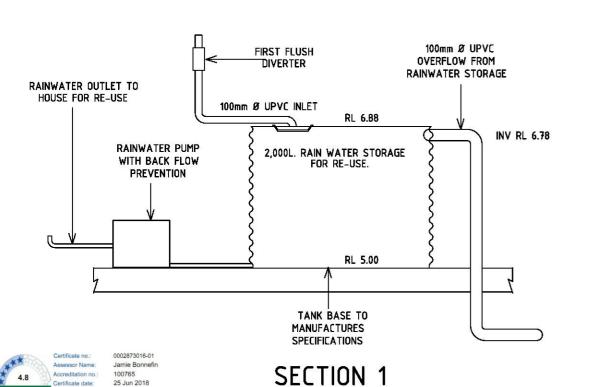

WATER TANK

SCALE 1:50

RAINWATER TANK NOTES

- 1. ALL WORK TO BE CARRIED OUT IN ACCORDANCE WITH AS, 3500.3.2. 2.THIS PLAN TO BE READ IN CONJUNCTION WITH BASIX CERTIFICATE 936038S 03
- 3.A TOTAL RAINWATER TANK STORAGE CAPACITY OF 2,000 LITERS IS PROVIDED
 VIA ONE SLIMLINE TANK CONSISTING OF AN APPROX SIZE 2,400mm LONG X
 680mm WIDE X 1875mm HIGH WATER TANK CONNECTED TO THE FOLLOWING:

 ALL TOILETS IN THE DEVELOPEMNT.

 THE COLD WATER TAP THAT SUPPLIES EACH CLOTHES WASHER IN THE DEVELOPMENT.

 AT LEAST ONE OUTDOOR TAP IN THE DEVELOPMENT (NOTED): NSW HEALTH DOES NOT RECOMMEND THAT RAINWATER BE USED FOR HUMAN CONSUMPTION.)
- 4. ALL PIPE AND DOWN PIPES TO BE PRESUSSURE GRADE PIPES TO 500mm ABOVE MAXIMUM WATER LEVEL OF RAIN WATERTANKS.

NOTE: GUTTERS TO HAVE A MINIMUM CROSS SECTION OF 6,600mm2

THIS PLAN TO BE READ IN **CONJUNCTION WITH**


DA2018/1782

NORTHERN BEACHES COUNCIL


70 MJ/

HYDRAULIC NOTES

- THE CONTRACTOR SHALL GIVE NOTICE TO COUNCIL'S ENGINEER IN ACCORDANCE WITH COUNCIL'S SPECIFICATIONS WHEN INPECTIONS ARE REQUIRED.
- WHERE DEPTH OF STORMWATER DRAINAGE PITS EXCEEDS 1.2m, HOT DIPPED GALVANISED STEEL STEP IRONS SHALL BE PROVIDED
- ALL PITS SHALL BE PRECAST CONCRETE WITH GRATE OR APPROVED EQUIVALENT UNLESS NOTED
- STORMWATER CONNECTION TO COUNCIL'S DRAINAGE SYSTEM SHALL BE DONE UNDER THE
- SUPERVISION OF COUNCIL'S ENGINEER. ALL STORMWATER PIPES BELOW AND INCLUDING 225 SHALL BE UPVC OR APPROVED EQUIVALENT UNLESS NOTED OTHERWISE.
- ALL PIPES ABOVE 2250 SHALL BE REINFORCED CONCRETE WITH RUBBER RING JOINTS UNLESS NOTED OTHERWISE.
- MINIMUM PIPE COVER TO BE 700mm UNLESS NOTED OTHERWISE.
- ALL PIPES TO BE LAID AND COVERED WITH SAND TO A MINIMUM DEPTH EQUAL TO THE PIPE DIAMETER BUT NOT LESS THAN 300mm.
- IN SANDY SOILS THE EXCAVATED SOIL MAY BE REUSED.
- ALL 100Ø SUBSOIL DRAINAGE TO BE PLACED A MINIMUM OF 650mm BELOW FINISHED SURFACE LEVELS AND COVERED WITH A MINIMUM OF 500mm GRAVEL.
- PIPE BEDDING SUPPORT SHALL BE H1 UNLESS OTHERWISE NOTED.
- STORMWATER GRATES AND MANHOLE CLASSES SHALL BE IN ACCORDANCE WITH AS 3996
- 13. WHERE PIPE GRADES ARE NOT SHOWN ON DRAWINGS, MINIMUM PIPE GRADES SHALL BE 1% UNO.
- PIPE GRADES INDICATED ON DRAWINGS ARE MINIMUM GRADES. IF MINIMUM GRADES CANNOT BE ACHIEVED CONTACT THE DESIGN ENGINEER PRIOR TO PLACEMENT.

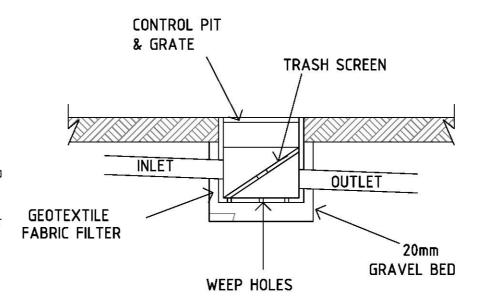



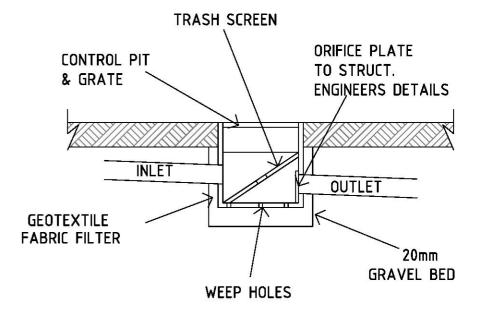

SCALE N.T.S.

DATE: 26/10/2018 SCALE:



ABN 65 687 862 151 | Builders Lic. 158741C

Address: 39 Gavenlock Road Tuggerah NSW 2259 Australia PO Box: 5240 Chittaway Bay NSW 2261 Australia P 4352 1189 | F 4352 1198 | E info@classicbuilding.com.au W www.classicbuilding.com.au

© This drawing and design remains the property of **CLASSIC COUNTRY COTTAGES** and may not be copied in whole or in part without prior approval of **CLASSIC COUNTRY COTTAGES**

DA ISSUE PLANS

CLIENT: MR. R. & MRS. M. LOWERY

66 ADAMS STREET CURL CURL

| PROPOSED NEW DWELLING: | |
|------------------------|---|
| | _ |

| | STORMWATER DETAIL | | | | |
|---------|-------------------|------|---|----------|--|
| JOB No. | CC150 | REV: | С | PAGE No. | |

1:50 DRAWN:

B.W.

