

ACTION PLANS

m: 0426 957 518

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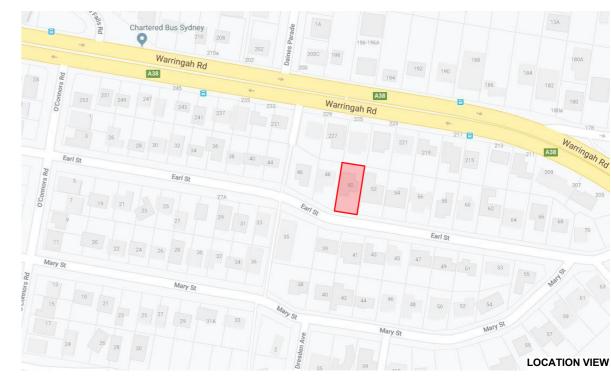
DEVELOPMENT APPLICATION

These plans are for Development Approval only.

SHEET NUMBER	CHEET NAME	DATE PUBLISHED
DA00	COVER	05-Feb-21
DA01	SITE ANALYSIS	05-Feb-21
DA02	SITE / ROOF / SEDIMENT EROSION / WASTE MANAGEMENT / STORMWATER CONCEPT PLAN	05-Feb-21
DA03	EXISTING GROUND FLOOR PLAN	05-Feb-21
DA04	PROPOSED GROUND FLOOR PLAN	05-Feb-21
DA05	PROPOSED FIRST FLOOR PLAN	05-Feb-21
DA06	NORTH / EAST ELEVATION	05-Feb-21
DA07	SOUTH / WEST ELEVATION	05-Feb-21
DA08	LONG / CROSS SECTION	05-Feb-21
DA09	AREA CALCULATIONS	05-Feb-21
DA10	SAMPLE BOARD	05-Feb-21
DA11	WINTER SOLSTICE 9 AM	05-Feb-21
DA12	WINTER SOLSTICE 12 PM	05-Feb-21
DA13	WINTER SOLSTICE 3 PM	05-Feb-21
DA14	BASIX COMMITMENTS - HOUSE	05-Feb-21
DA15	BASIX COMMITMENTS - SECONDARY DWELLING	05-Feb-21
DA16	BASIX COMMITMENTS - SECONDARY DWELLING	05-Feb-21

ITEM DETAILS	DEVELOPMENT APPLICATION				
ADDRESS	50 EARL STREET, BEACON HILL NSW 2	100			
LOT & DP/SP	LOT 29 DP 25164				
COUNCIL	NORTHERN BEACHS COUNCIL (WARRI	NGAH)			
SITE AREA	678.3m²				
FRONTAGE	18.290m				
CONTROLS	PERMISSIBLE / REQUIRED	EXISTING	PROPOSED	COMPLIANCE	
	m / m² / %	m / m² / %	m / m² / %		
<u>LEP</u>					
LAND ZONING	R2 – LOW DENSITY RESIDENTIAL	R2	R2	YES	
MINIMUM LOT SIZE	600m²	678.3m ²	UNCHANGED	YES	
FLOOR SPACE RATIO	NOT IDENTIFIED	N/A	N/A	N/A	
MAXIMUM BUILDING HEIGHT	8.5m	5.15m	8.43m	YES	
<u>HAZARDS</u>					
ACID SULFATE SOILS	NOT IDENTIFIED	N/A	N/A	N/A	
FLOOD PLANNING	NOT IDENTIFIED	N/A	N/A	N/A	
DEVELOPMENT ON SLOPING LAND	AREA B: FLANKING SLOPES 5 TO 25°	N/A	N/A	N/A	
COASTAL HAZARDS	NOT IDENTIFIED	N/A	N/A	N/A	
HIGH/MED/LOW FLOOD RISK PRECINCT	NOT IDENTIFIED	N/A	N/A	N/A	
NATIVE VEGETATION	NOT IDENTIFIED	N/A	N/A	N/A	
WILDLIFRE CORRIDORS	NOT IDENTIFIED	N/A	N/A	N/A	
WATERWAYS AND RIPARIAN LAND	NOT IDENTIFIED	N/A	N/A	N/A	
THREATEND HIGH CONSERVATION HABITAT	NOT IDENTIFIED	N/A	N/A	N/A	
LAND ADJOINING PUBLIC OPEN SPACE	NOT IDENTIFIED	N/A	N/A	N/A	
DCP					
WALL HEIGHT	7.2m	4.97m	7.12	YES	
NUMBER OF STOREYS	N/A	1	2	YES	
SIDE BOUNDARY ENVELOPE	4m	N/A	N/A	NO	
SIDE BOUNDARY SETBACKS	0.9m	E: 1.09m W: 0.83m	E: 1m W: UNCHANGED	YES	
FRONT BOUNDARY SETBACK	6.5m	11.64m	6.59m	YES	
REAR BOUNDARY SETBACK	6.0m	3.15m	UNCHANGED	YES	
LANDSCAPE OPEN SPACE	40% (271.32m²)	46.50% (315.46m²)	35.30% (239.44m²)	NO	
PRIVATE OPEN SPACE	60m²	170.05m²	UNCHANGED	YES	

50 EARL STREET BEACON HILL, NSW, 2100



NCC & AS COMPLIANCES SPECIFICATIONS

- EARTHWORKS - PART 3.1.1 OF NCC - EARTH RETAINING STRUCTURES - PART 3.1.2 OF NCC - DRAINAGE - PART 3.1.3 OF NCC - TERMITE-RISK MANAGEMENT - PART 3.1.4 OF NCC

- FOOTINGS & SLAB - PART 3.2 OF NCC INCLUDING AS2870

- MASONRY - PART 3.3 OF NCC INCLUDING AS3700 - FRAMING - PART 3.4 OF NCC

- SUB FLOOR VENTILATION - PART 3.4.1 OF NCC

- ROOF CLADDING AND WALL-CLADDING - PART 3.5 OF NCC - GLAZING - PART 3.6 OF NCC INCLUDING AS1288

- FIRE SAFETY - PART 3.7 OF NCC

- FIRE SEPERATION - PART 3.7.2 OF NCC

- FIRE PROTECTION OF SEPERATING WALLS AND FLOORS- PART 3.7.3 OF NCC

- SMOKE ALARMS - PART 3.7.5 OF NCC

- WET AREAS AND EXTERNAL WATERPROOFING - PART 3.8.1 OF NCC

- ROOM HEIGHTS - PART 3.8.2 OF NCC

- FACILITIES - PART 3.8.3 OF NCC

- LIGHT - PART 3.8.4 OF NCC

- VENTILATION - PART 3.8.5 OF NCC

- SOUND INSULATION - PART 3.8.6 OF NCC

- STAIRWAYAND RAMP CONSTRUCTION - PART 3.9.1 OF NCC - BARRIERS AND HANDRAILS - PART 3.9.2 OF NCC

- SWIMMING POOLS - PART 3.10.1 OF NCC

- CONSTRUCTION IN BUSHFIRE PRONE AREAS - PART 3.10.5 OF NCC

- FENCING & OTHER PROVISIONS - REGS & AS1926

- DEMOLITION WORKS - AS2601-1991 THE DEMOLITION OF STRUCTURES. - ALL WATERPROOF MEMBRANES TO COMPLY WITH WITH AS 3740-2010

- ALL PLUMBING & DRAINAGE WORK TO COMPLY WITH AS 3500 - SITE CLASSIFICATION AS TO AS 2870

- ALL PLASTERBOARD WORK TO COMPLY WITH AS 2588-1998

- ALL STRUCTURAL STEEL WORK TO COMPLY WITH AS 4100 & AS 1554

- ALL CONCRETE WORK TO COMPLY WITH AS 3600


- ALL ROOF SHEETING WORK TO COMPLY WITH AS 1562-1992 - ALL SKYLIGHTS TO COMPLY WITH WITH AS 4285-2007

- ALL CERAMIC TILING TO COMPLY WITH AS 3958.1-2007 & 3958.2-1992 - ALL GLAZING ASSEMBLIES TO COMPLY WITH AS2047 & 1288

- ALL TIMBER RETAINING WALLS ARE TO COMPLY WITH AS 1720.1-2010,

AS 1720.2-2006, AS 1720.4-2006, AS 1170.1-1989 & AS 1170.4-2007 - ALL RETAINING WALLS ARE TO COMPLY WITH 3700 - 2011 & AS 3600 -2009

- ALL CONSTRUCTION TO COMPLY TO AS3959- 2009

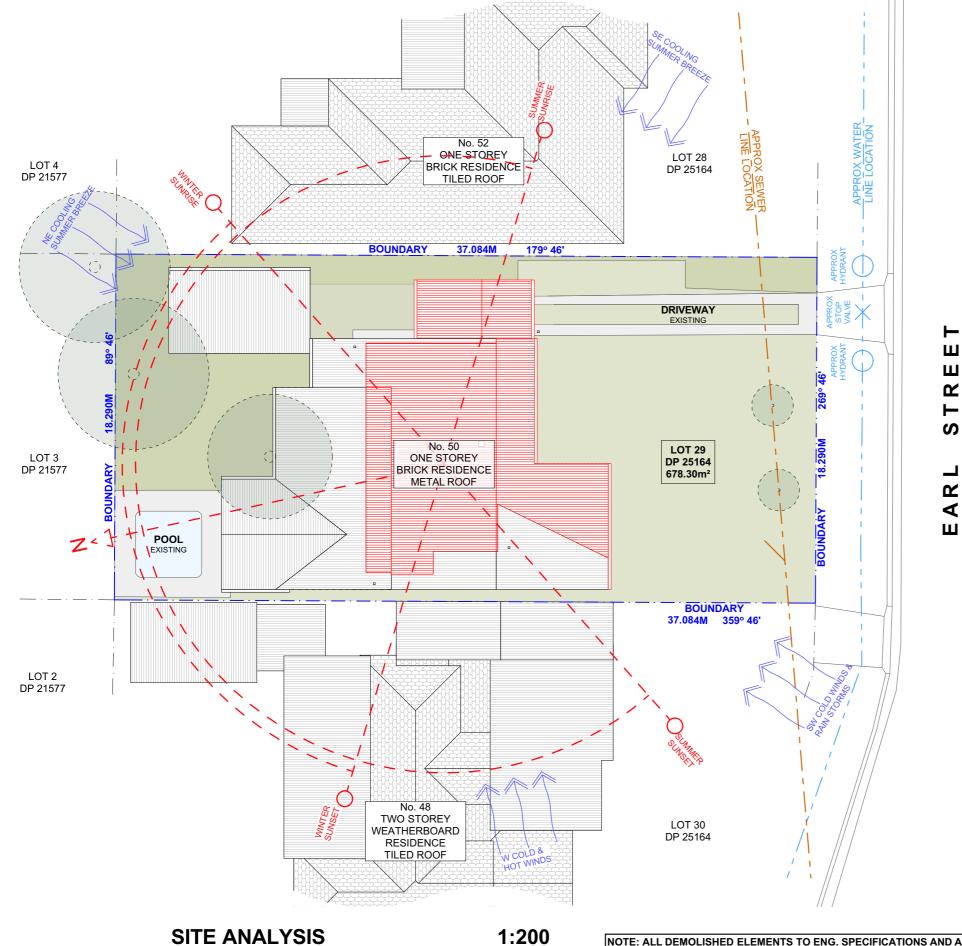



EXTERNAL VIEW



LOCATION VIEW



DRAWING NAME

REV. DATE

COMMENTS

NOTE: ALL DEMOLISHED ELEMENTS TO ENG. SPECIFICATIONS AND AS. 2601 - 2001

LEGEND

LANDSCAPING **PAVING**

PROJECT ADDRESS 50 EARL STREET BEACON HILL, NSW, 2100

SHAUN & AMANDA PEARSON

CLIENT

DRAWING NO.

DA01

SITE ANALYSIS

SCALE 1:200 @A3

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DRWN

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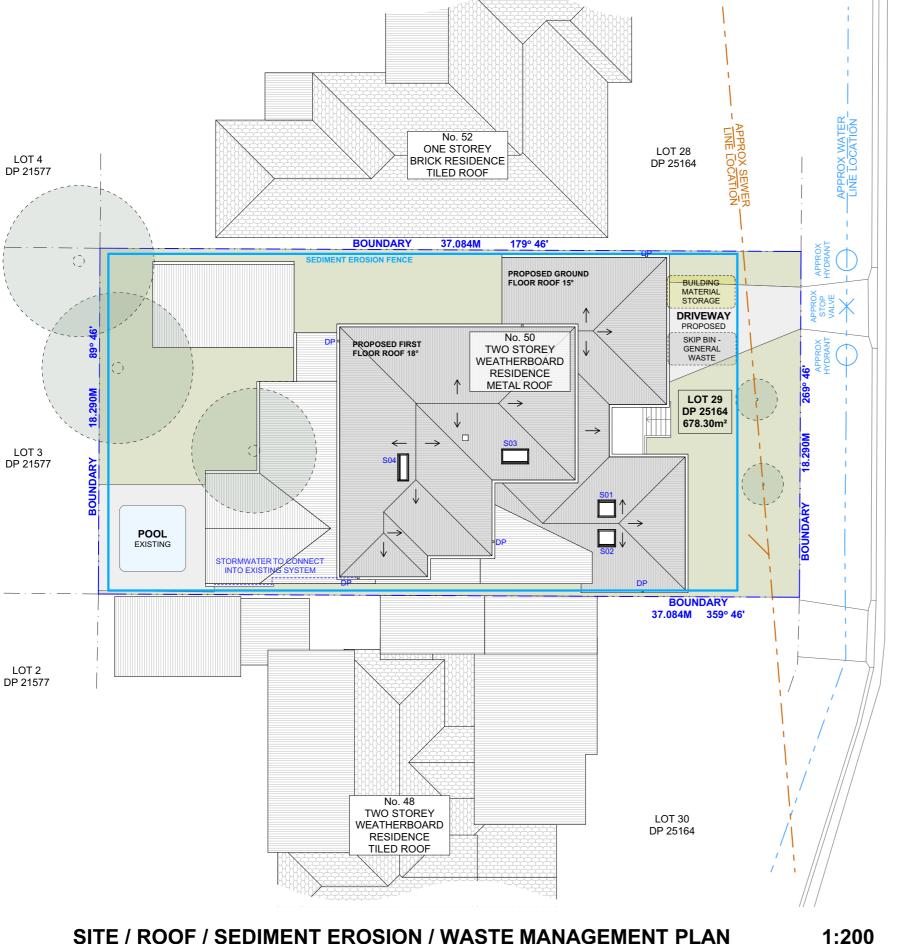
Do not scale measure from drawings. Figured dimensions are to be used only.

The Builder/Contractor shall check and verify all levels and dimensions on site prior to commencement of any work, creation of shop drawings, or fabrication of components.

All errors and omissions are to be verified by the Builder/Contractor and referred to the designer prior to the commencement of works. DESIGN PLAN 30.10.2020 commencement of works.

WATER - DEMOLISHED

DATE Friday, February 5, 2021



3m MAX DISTURBED AREA POSTS DRIVEN 0.6m INTO GROUND DETAIL OF OVERLAP WIRE OR STEEL MESH (WHERE REQUIRED) ↓ UNDISTURBED AREA **SEDIMENT FENCE**

DUST CONTROL:

TO REDUCE DUST GENERATED BY WIND ACTION, THE REMOVAL OF THE TOP SOIL IS TO BE MINIMISED. TO PREVENT DUST GENERATION, WATERING DOWN OF THE SITE, ESPECIALLY DURING THE MOVEMENT OF MACHINERY IS REQUIRED. WHERE EXCAVATING INTO ROCK, KEEP THE SURFACE MOIST TO MINIMISE DUST. CONSTRUCT A GRAVEL ENTRY/EXIT POINT USING BLUE METAL AND RESTRICT ALL VEHICLE MOVEMENTS WITHIN THE SITE TO A MINIMUM. ENSURE WIND BREAKS, SUCH AS EXISTING FENCES ARE MAINTAINED DURING THE CONSTRUCTION PHASE UNTIL NEW LANDSCAPING IS PROVIDED OR REINSTATED. PREVENT DUST BY COVERING STOCKPILES

SEDIMENT NOTE:

1. ALL EROSION AND SEDIMENT CONTROL MEASURES TO BE INSPECTED AND MAINTAINED DAILY BY THE SITE MANAGER.

2. MINIMISE DISTURBED AREAS, REMOVE EXCESS SOIL FROM EXCAVATEDAREA AS SOON AS POSSIBLE. 3. ALL MATERIAL STOCKPILE TO BE CLEAR FROM DRAINS, GUTTERS AND FOOTPATHS, OR WITHIN SEDIMENT FENCE AREA.

4. DRAINAGE TO BE CONNECTED TO STORMWATER AS SOON AS POSSIBLE. IF STORED ON SITE, IT MUST BE FILTERED BEFORE RELEASING INTO STORMWATER SYSTEM OR WATERWAYS.

5. ROADS AND FOOTPATHS TO BE SWEPT DAILY.

STOCKPILES:

ALL STOCKPILES ARE TO BE KEPT ON-SITE WHERE POSSIBLE. ANY MATERIALS PLACED ON THE FOOTPATHS OR NATURE STRIPS REQUIRE COUNCIL'S PERMISSION.

ALL STOCKPILES ARE TO BE PLACED AWAY FROM THE DRAINAGE LINES AND STREET GUTTERS. IT IS BEST TO LOCATE THESE ON THE HIGHEST PART OF THE SITE IF POSSIBLE. PLACE WATERPROOF COVERING OVER STOCKPILES.

IF REQUIRED PROVIDE DIVERSION DRAIN & BANK AROUND STOCKPILES.

GUTTER PROTECTION:


PROVIDE PROTECTION TO DOWNHILL GRATE IN GUTTER BY MEANS OF SAND BAGS OR BLUE METAL WRAPPED IN GEOTEXTILE FABRIC. WHEN SOIL OR SAND BUILDS UP AROUND THIS SEDIMENT BARRIER, THE MATERIAL SHOULD BE RELOCATED BACK TO THE SITE FOR DISPOSAL.

NOTE: ALL PROPOSED STORMWATER TO CONNECT WITH EXISTING

SITE / ROOF / SEDIMENT EROSION / WASTE MANAGEMENT PLAN



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SHAUN & AMANDA PEARSON

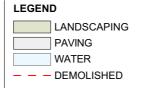PROJECT ADDRESS 50 EARL STREET BEACON HILL, NSW,

DATE Friday, February 5, 2021


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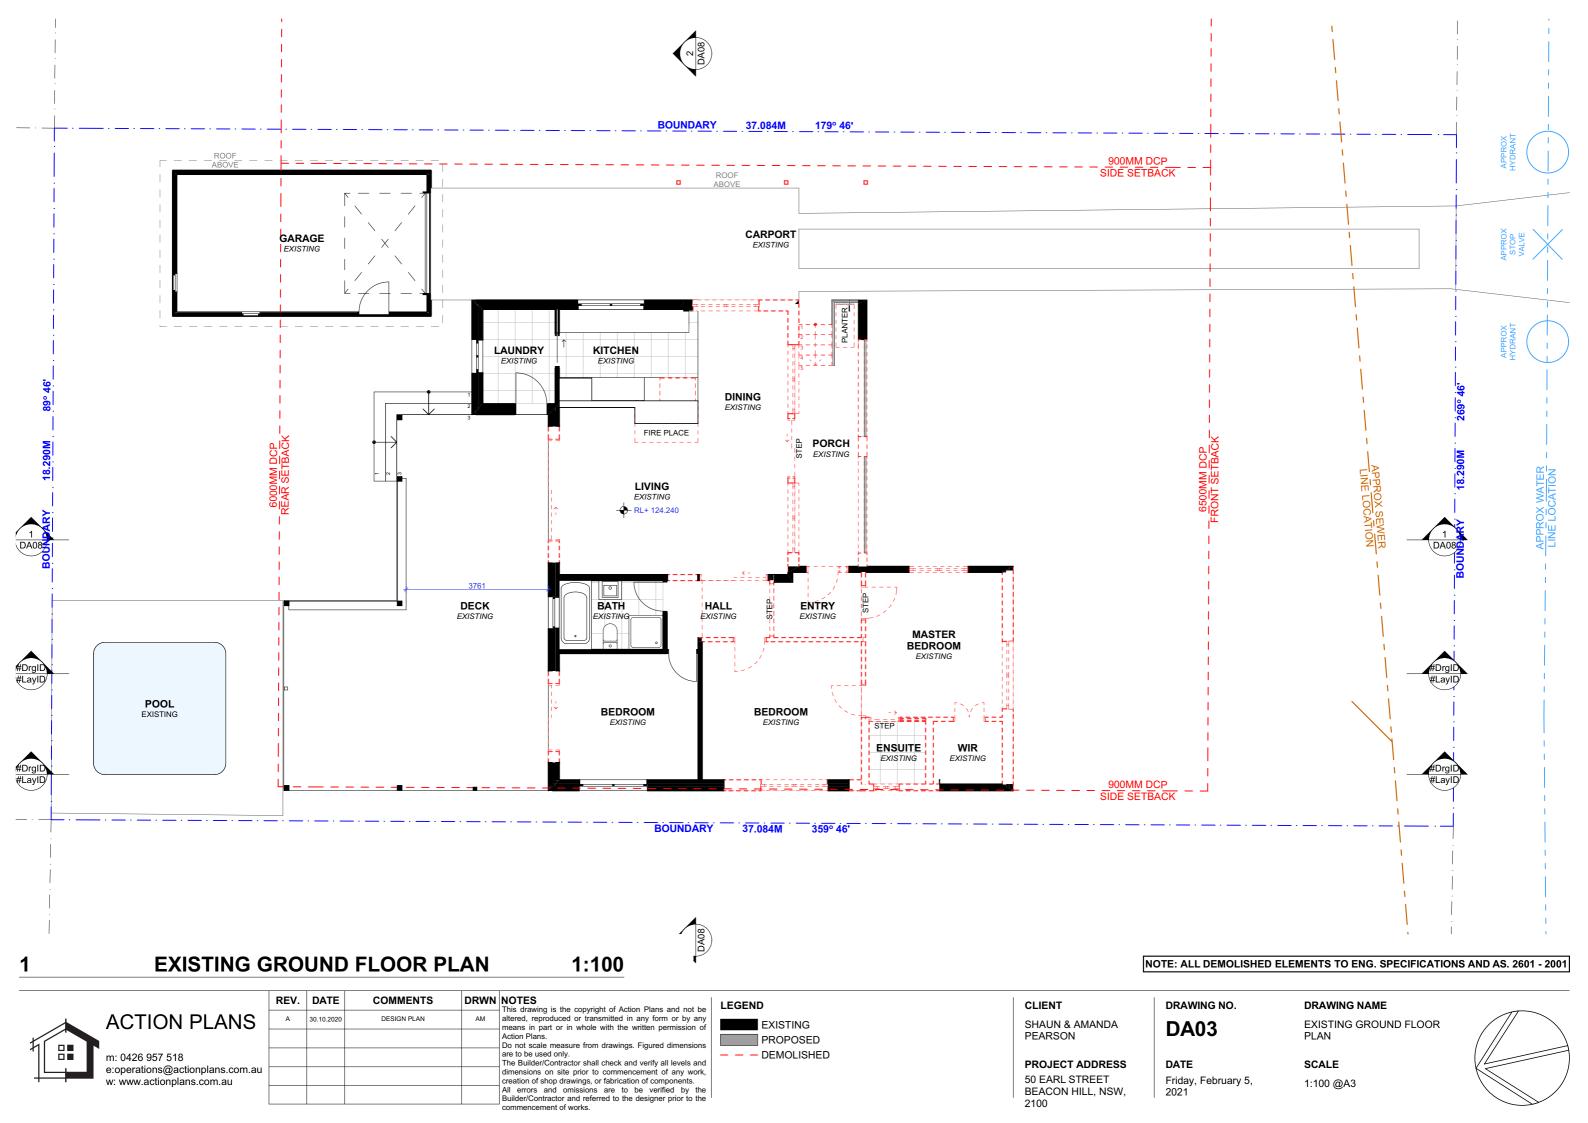
DA02


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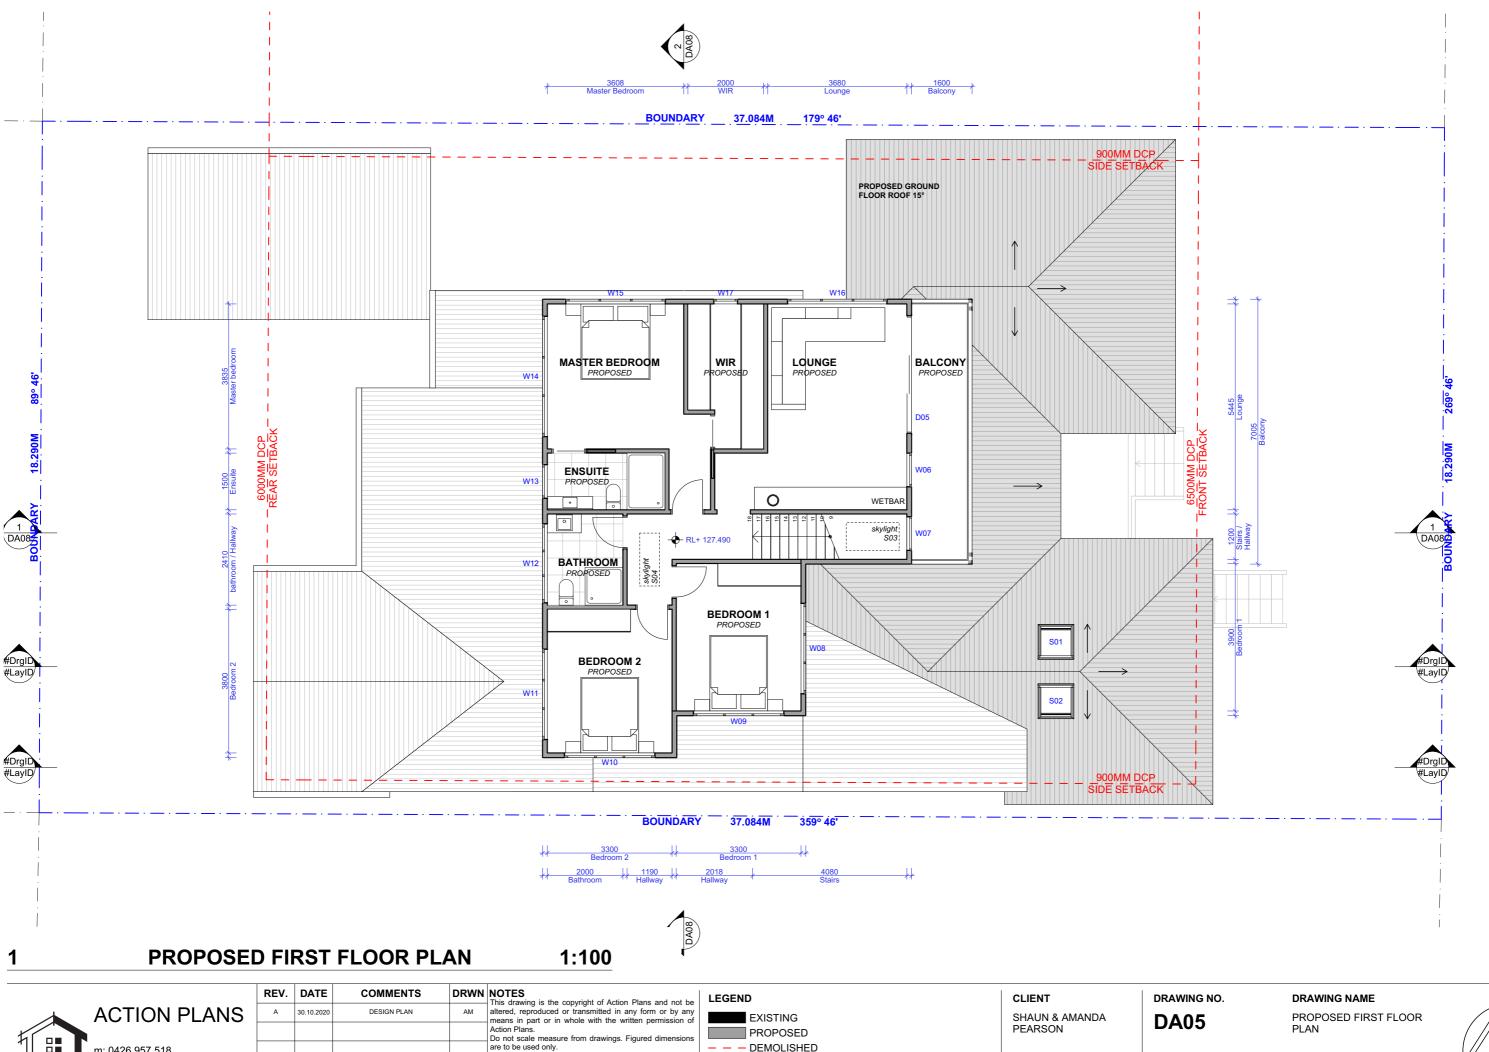
DRAWING NAME

SITE / ROOF / SEDIMENT EROSION / WASTE MANAGEMENT / STORMWATER SONCEPT PLAN





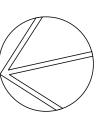

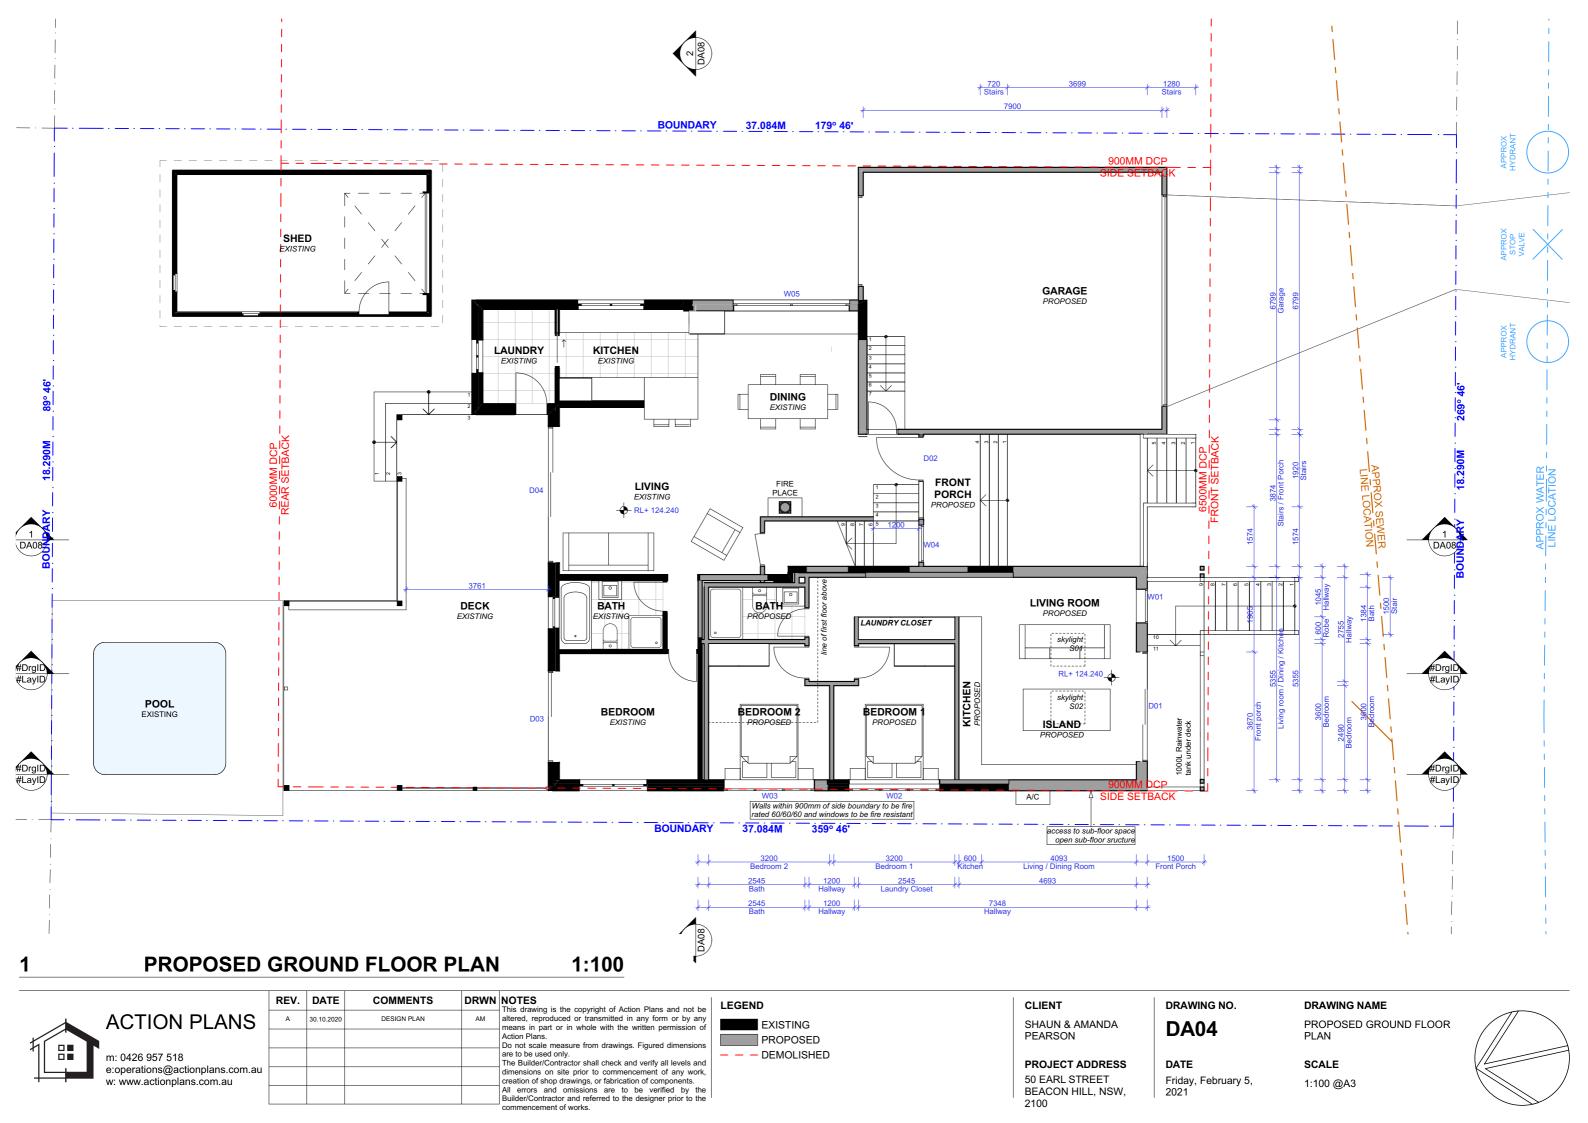



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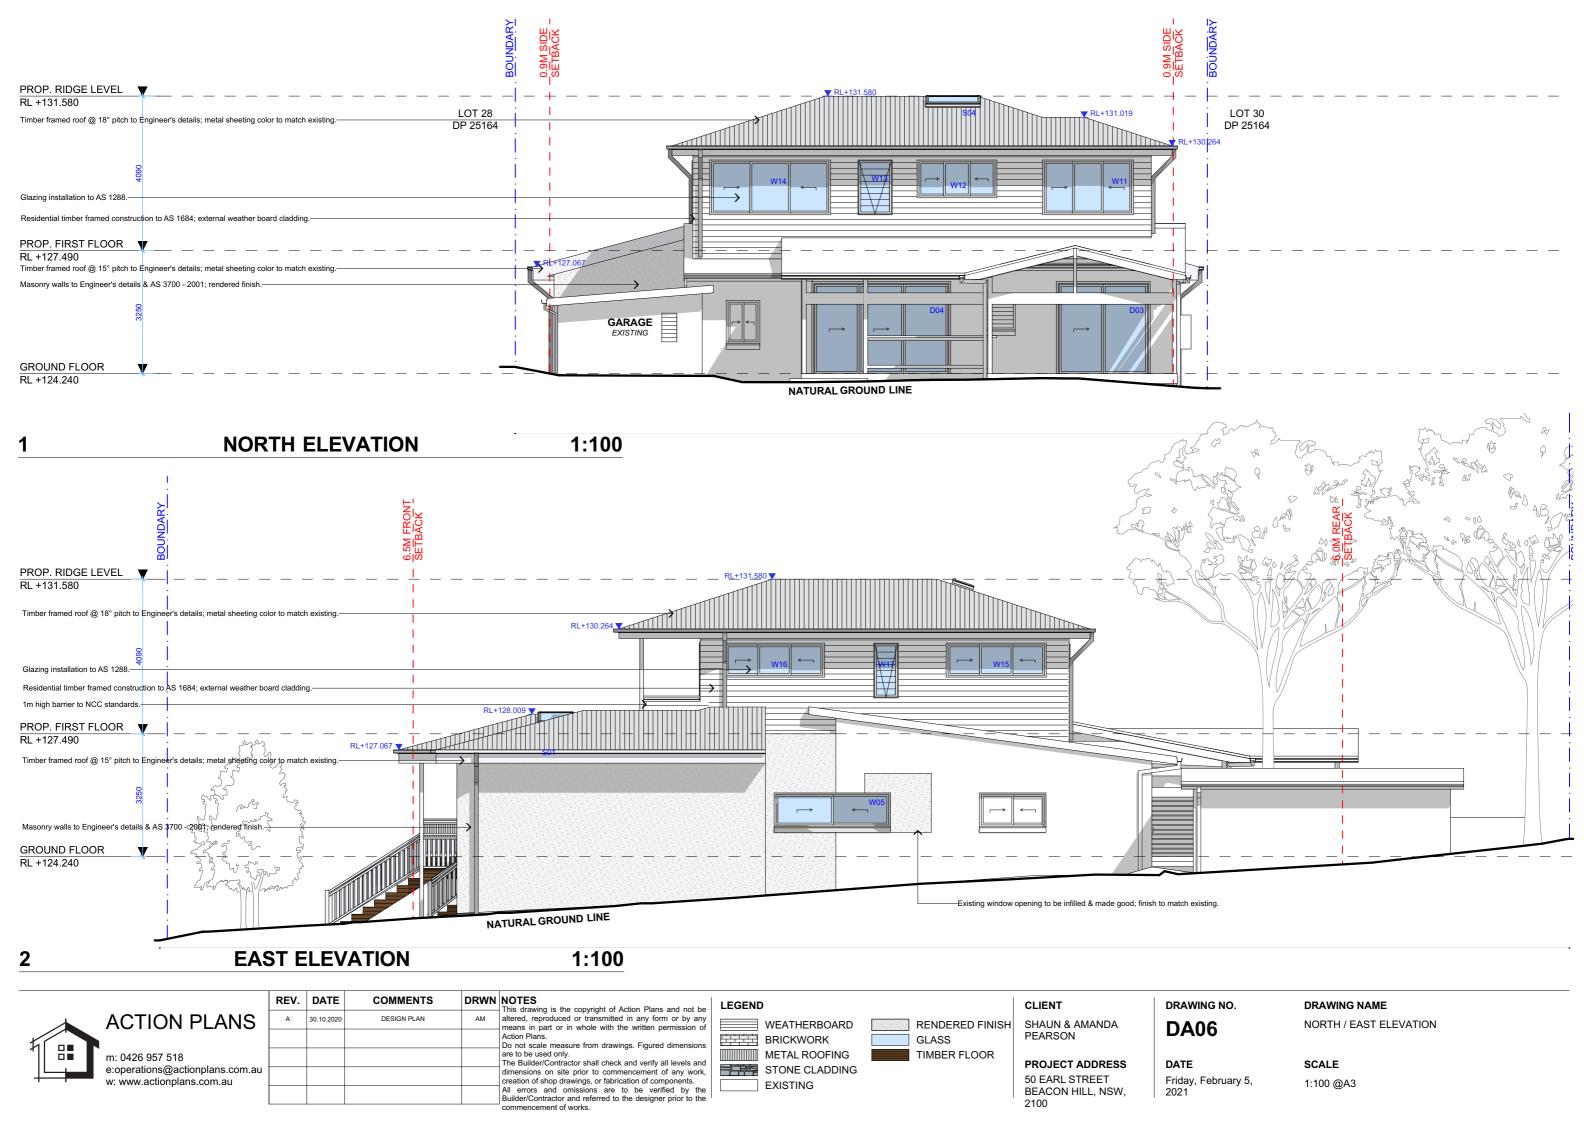
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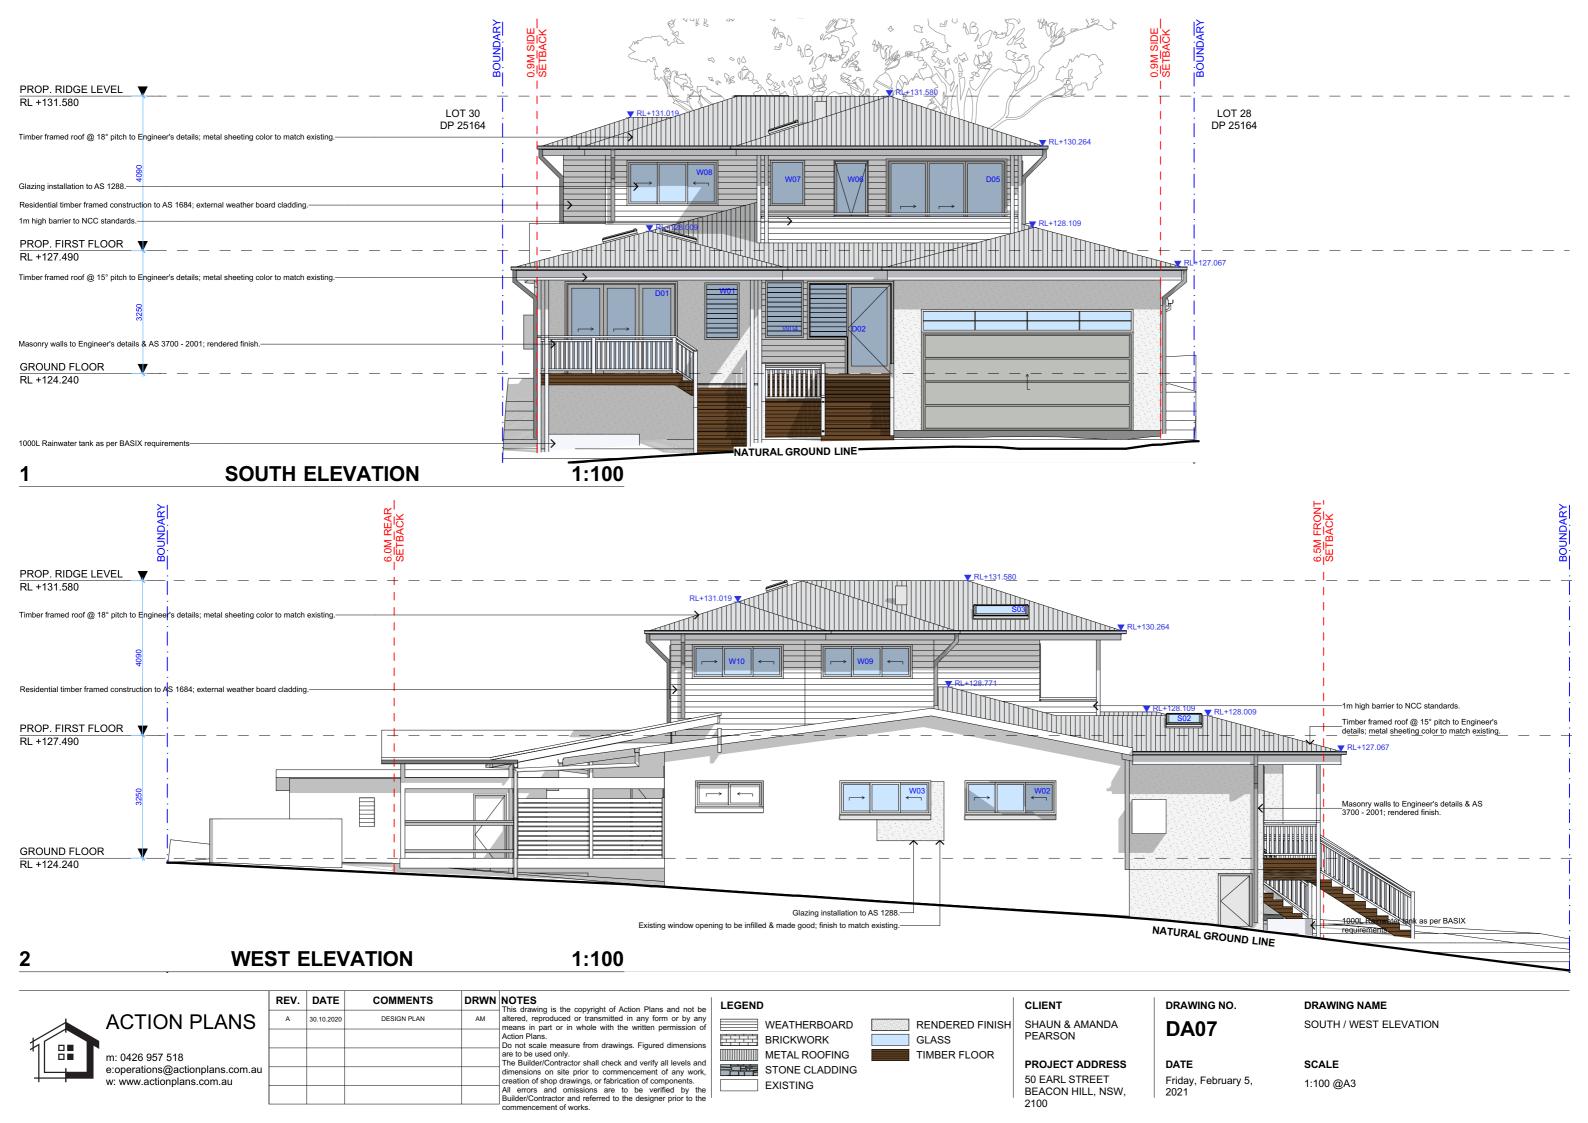
DATE Friday, February 5, 2021


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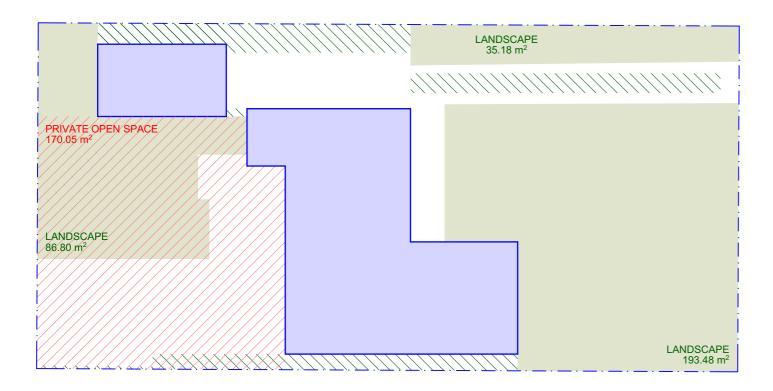
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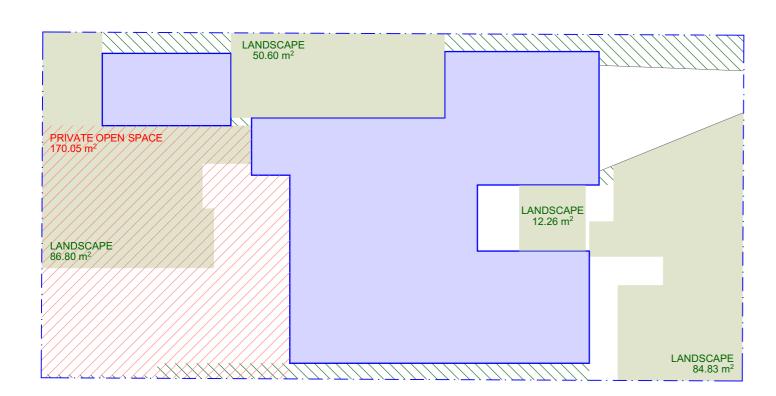








EXISTING AREA CALCULATIONS 1:200

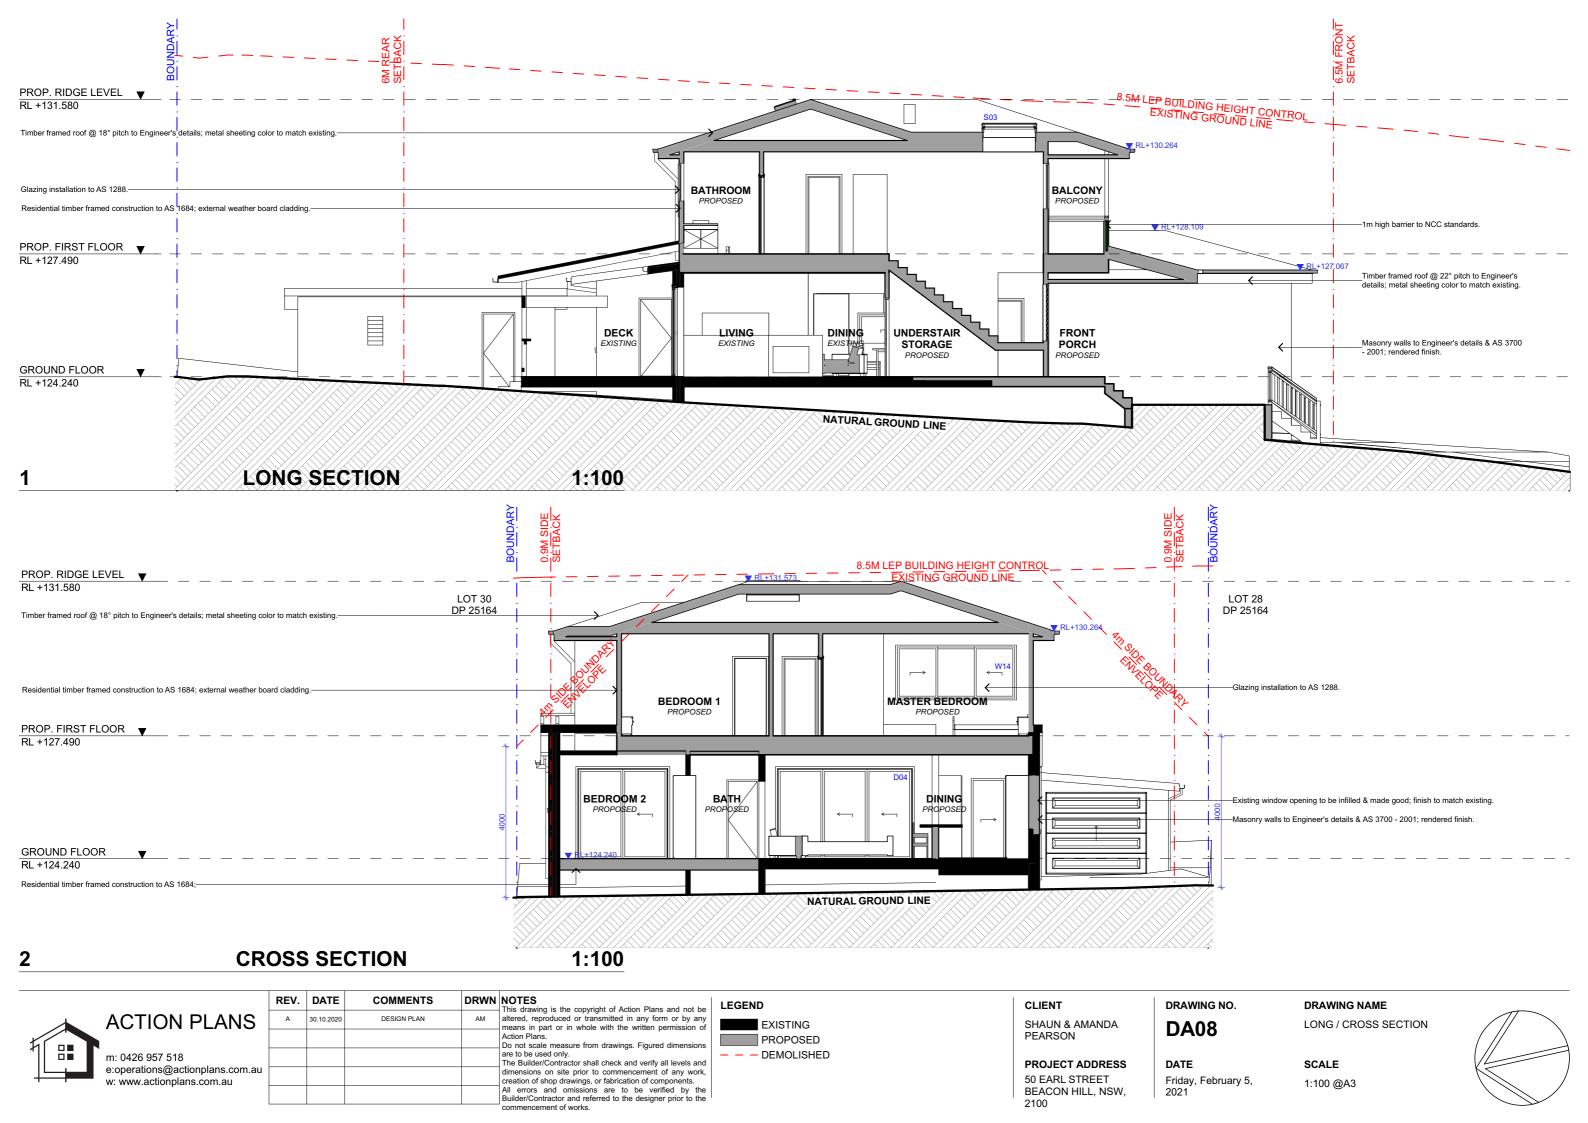

PROPOSED AREA CALCULATIONS 1:200 2

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LEGEND

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PROJECT ADDRESS 50 EARL STREET BEACON HILL, NSW, 2100

DRAWING NO. **DA09**

SCALE

DRAWING NAME

1:200 @A3

AREA CALCULATIONS

SITE AREA: 678.3m²



BUILDING FOOTPRINT



LANDSCAPE AREA:

40.00% (271.32 m²) 46.50% (315.46 m²) REQUIRED EXISTING 34.57% (234.49 m²) PROPOSED




EXCLUDED LANDSCAPE AREA AREAS LESS THAN 2m²



PRIVATE OPEN SPACE

REQUIRED 60.00m² **EXISTING** 170.05m² PROPOSED 170.05m²

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PROPOSED FRONT PERSPECTIVE

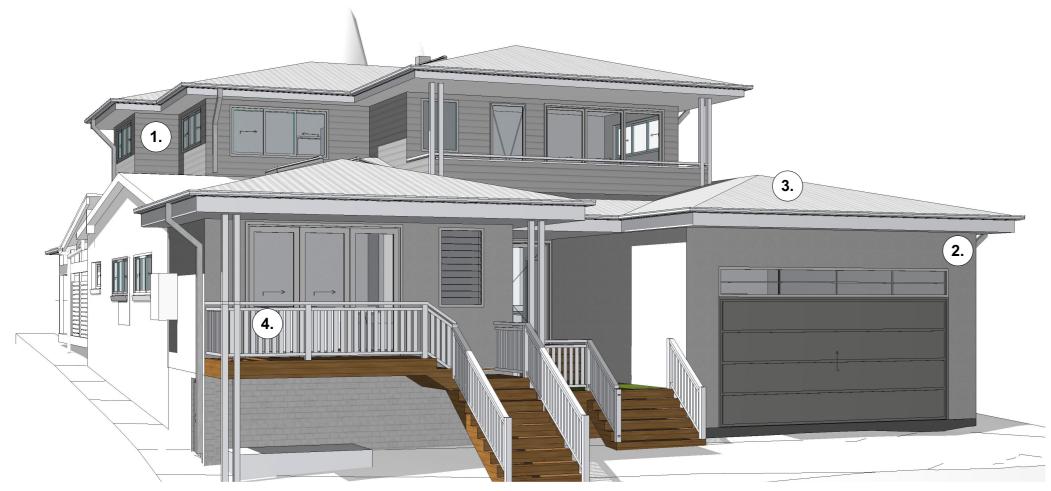SAMPLE BOARD



Weatherboards - Colour to be confirmed by client



Rendered brickwork - Colour to be confirmed by client



Colorbond roof sheeting brickwork - Colour to be confirmed by client



Aluminium framed window and door

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LEGEND

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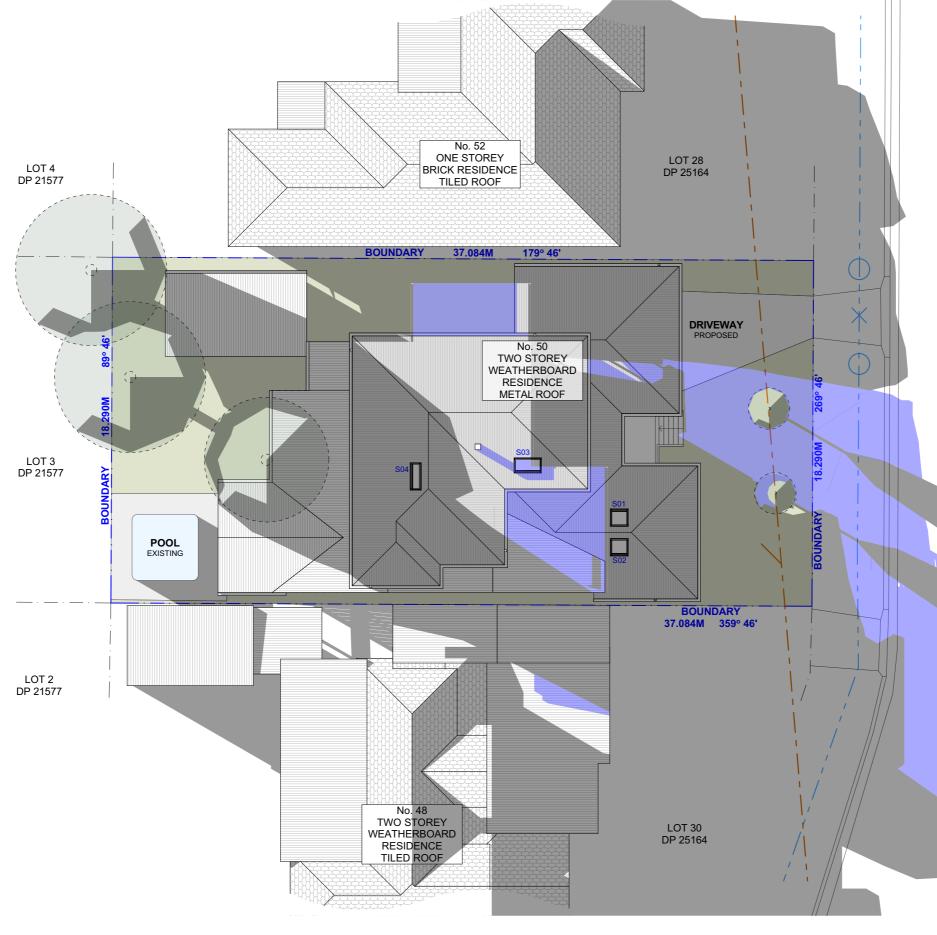
DA10

DATE

Friday, February 5, 2021

DRAWING NAME SAMPLE BOARD

SCALE @A3



1 WINTER SOLSTICE 9AM 1:200



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EXISTING SHADOWS PROPOSED SHADOWS


CLIENT SHAUN & AMANDA PEARSON


PROJECT ADDRESS 50 EARL STREET BEACON HILL, NSW, 2100 DRAWING NO.

DATEFriday, February 5, 2021

DRAWING NAME
WINTER SOLSTICE 9 AM

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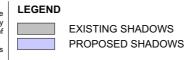


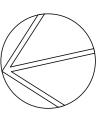

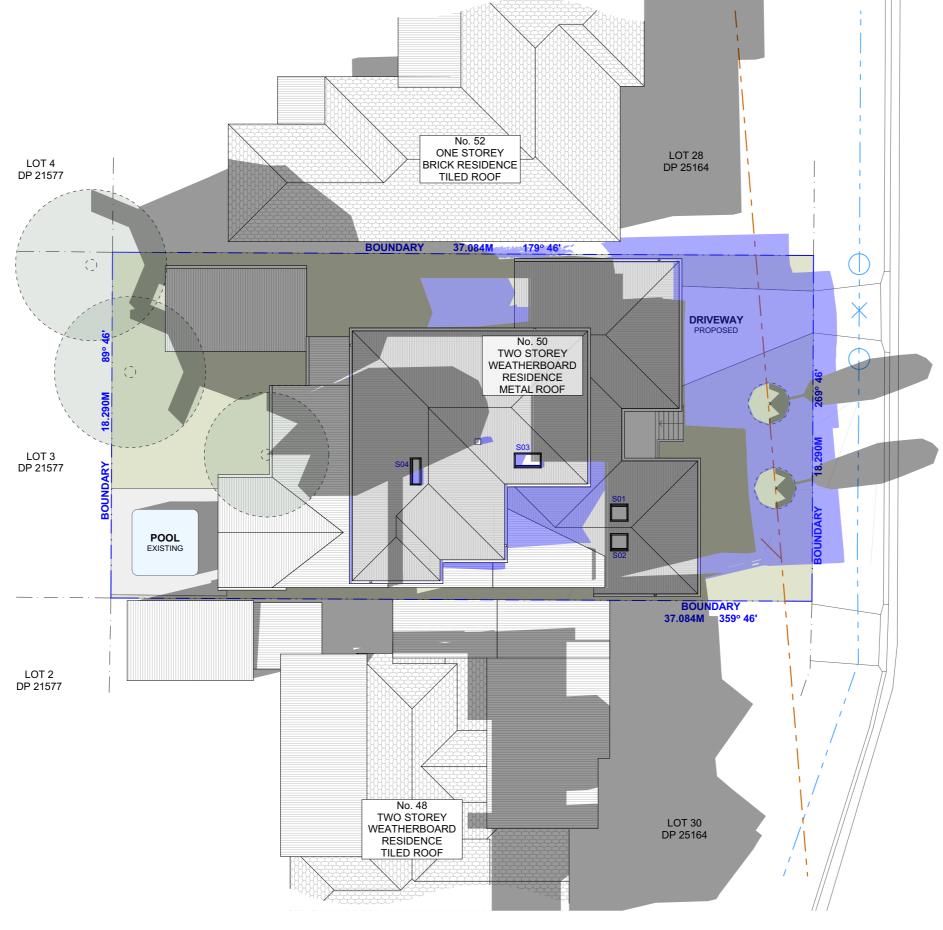1 WINTER SOLSTICE 12PM 1:200



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PROJECT ADDRESS
50 EARL STREET
BEACON HILL, NSW,
2100


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DA12

12	WINTER SOLS

DATEFriday, February 5, 2021

DRAWING NAMEWINTER SOLSTICE 12 PM



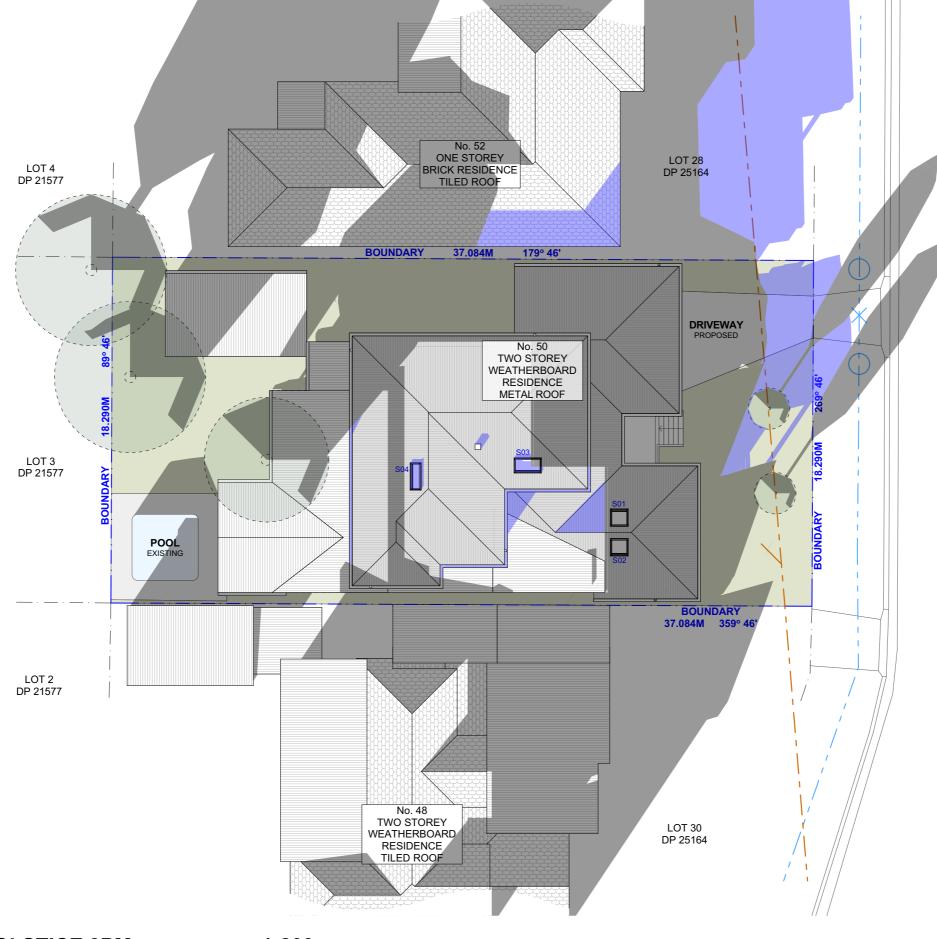


1:200 **WINTER SOLSTICE 3PM**



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CLIENT SHAUN & AMANDA PEARSON

PROJECT ADDRESS 50 EARL STREET BEACON HILL, NSW, 2100

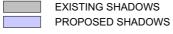DRAWING NO. **DA13**

DATE


Friday, February 5, 2021

DRAWING NAME

SCALE

1:200 @A3

WINTER SOLSTICE 3 PM

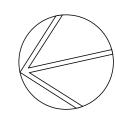



Building Sustainability Index www.basix.nsw.gov.au

Alterations and Additions

Certificate number: A358137_05

This certificate confirms that the proposed development will meet the NSW government's requirements for sustainability, if it is built in accordance with the commitments set out below. Terms used in this certificate, or in the commitments, have the meaning given by the document entitled "BASIX Alterations and Additions" Definitions" dated 06/10/2017 published by the Department. This document is available at www.basix.nsw.gov.au

Secretary
Date of issue: Friday, 05, February 2021
To be valid, this certificate must be lodged within 3 months of the date of issue.



Project address			
Project name	50 Earl Street Beacon Hill NSW 2100_05		
Street address	50 Earl Street Beacon Hill 2100		
Local Government Area	Northern Beaches Council		
Plan type and number	Deposited Plan DP25164		
Lot number	29		
Section number			
Project type			
Dwelling type	Separate dwelling house		
Type of alteration and addition	My renovation work is valued at \$50,000 or more, and does not include a pool (and/or spa).		

Certificate Prepared by (please complete before submitting to Council or PCA)
Name / Company Name: Action Plans
ABN (if applicable): 17118297587

In these commitments, "applicant" means the person carrying out the development.

Commitments identified with a " \checkmark " in the "Show on DA plans" column must be shown on the plans accompanying the development application for the proposed development (if a development application is to be lodged for the proposed development).

project

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escription

Commitments identified with a "
in the "Show on CC/CDC plans & specs" column must be shown in the plans and specifications accompanying the application for a construction certificate / complying development certificate for the proposed development.

Commitments identified with a " $\sqrt{}$ " in the "Certifier check" column must be certified by a certifying authority as having been fulfilled, before a final occupation certificate for the development may be issued.

Fixtures and systems	Show on DA Plans	Show on CC/CDC Plans & specs	Certifier Check
Lighting			
The applicant must ensure a minimum of 40% of new or altered light fixtures are fitted with fluorescent, compact fluorescent, or light-emitting-diode (LED) lamps.		✓	~
Fixtures	1	'	
The applicant must ensure new or altered showerheads have a flow rate no greater than 9 litres per minute or a 3 star water rating.		V	✓
The applicant must ensure new or altered toilets have a flow rate no greater than 4 litres per average flush or a minimum 3 star water rating.		✓	✓
The applicant must ensure new or altered taps have a flow rate no greater than 9 litres per minute or minimum 3 star water rating.		✓	

Construction			Show on DA Plans	Show on CC/CDC Plans & specs	Certifier Check
nsulation requirements					
	tion is not required where the area of new con-	s) in accordance with the specifications listed in struction is less than 2m2, b) insulation specified	V	✓	~
Construction	Additional insulation required (R-value)	Other specifications			
suspended floor with enclosed subfloor: framed (R0.7).	R0.60 (down) (or R1.30 including construction)				
floor above existing dwelling or building.	nil				
external wall: brick veneer	R1.16 (or R1.70 including construction)				
external wall: framed (weatherboard, fibro, metal clad)	R1.30 (or R1.70 including construction)				
internal wall shared with garage: single skin masonry (R0.18)	nil				
flat ceiling, pitched roof	ceiling: R2.25 (up), roof: foil/sarking	light (solar absorptance < 0.475)			

Glazing requ	uirements						Show on DA Plans	Show on CC/CDC Plans & specs	Certifier Check
Windows and	d glazed do	ors							
					nading devices, in accordance with reach window and glazed door.	the specifications listed in the table below.	✓	~	~
The following r	equirements r	must also	be satisfie	ed in relation	n to each window and glazed door:			✓	~
have a U-value	and a Solar	Heat Gain	Coefficie	nt (SHGC) r		d glass may either match the description, or, e below. Total system U-values and SHGCs		✓	~
					f each eave, pergola, verandah, bal than 2400 mm above the sill.	cony or awning must be no more than 500 mm	✓	✓	~
For projections least that show			ne ratio of	the projection	on from the wall to the height above	the window or glazed door sill must be at	✓	✓	~
Pergolas with polycarbonate roof or similar translucent material must have a shading coefficient of less than 0.35.								~	V
Pergolas with fixed battens must have battens parallel to the window or glazed door above which they are situated, unless the pergola also shades a perpendicular window. The spacing between battens must not be more than 50 mm.								✓	~
Overshadowing specified in the					nt and distance from the centre and	the base of the window and glazed door, as	✓	✓	~
Windows a	nd glazed o	doors gl	azing re	equireme	nts		1		
Window / door no.	Orientation	Area of glass inc. frame (m2)	Oversha Height (m)	Distance (m)	Shading device	Frame and glass type			
W04	S	1.5	0	0	eave/verandah/pergola/balcony >=450 mm	standard aluminium, single clear, (or U-value: 7.63, SHGC: 0.75)			
W05	E	2.76	4.06	9.465	eave/verandah/pergola/balcony >=450 mm	standard aluminium, single toned, (or U-value: 7.57, SHGC: 0.57)			
W06	S	1.36	0	0	eave/verandah/pergola/balcony >=450 mm	standard aluminium, single clear, (or U-value: 7.63, SHGC: 0.75)			

Glazing requ	irements						Show on DA Plans	Show on CC/CDC Plans & specs	Certifier Check
Window / door no.	Orientation	Area of glass inc. frame (m2)	Oversha Height (m)	dowing Distance (m)	Shading device	Frame and glass type			
W07	S	1.08	0	0	eave/verandah/pergola/balcony >=450 mm	standard aluminium, single clear, (or U-value: 7.63, SHGC: 0.75)			
W08	S	2.9	0	0	eave/verandah/pergola/balcony >=450 mm	standard aluminium, single clear, (or U-value: 7.63, SHGC: 0.75)			
W09	W	2.17	0	0	projection/height above sill ratio >=0.43	standard aluminium, single clear, (or U-value: 7.63, SHGC: 0.75)			
W10	W	2.17	0	0	projection/height above sill ratio >=0.43	standard aluminium, single clear, (or U-value: 7.63, SHGC: 0.75)			
W11	N	3.5	0	0	projection/height above sill ratio >=0.36	standard aluminium, single clear, (or U-value: 7.63, SHGC: 0.75)			
W12	N	2.11	0	0	projection/height above sill ratio >=0.43	standard aluminium, single clear, (or U-value: 7.63, SHGC: 0.75)			
W13	N	1.32	0	0	projection/height above sill ratio >=0.36	standard aluminium, single clear, (or U-value: 7.63, SHGC: 0.75)			
W14	N	4.64	0	0	projection/height above sill ratio >=0.36	standard aluminium, single clear, (or U-value: 7.63, SHGC: 0.75)			
W15	E	2.39	0	0	projection/height above sill ratio >=0.43	standard aluminium, single clear, (or U-value: 7.63, SHGC: 0.75)			
W16	E	2.39	0	0	projection/height above sill ratio >=0.43	standard aluminium, single clear, (or U-value: 7.63, SHGC: 0.75)			
D02	S	5.28	0	0	projection/height above sill ratio >=0.36	standard aluminium, single clear, (or U-value: 7.63, SHGC: 0.75)			
D03	N	5.8	0	0	eave/verandah/pergola/balcony >=900 mm	standard aluminium, single clear, (or U-value: 7.63, SHGC: 0.75)			
D04	N	8.64	0	0	eave/verandah/pergola/balcony >=900 mm	standard aluminium, single clear, (or U-value: 7.63, SHGC: 0.75)			
D05	S	7.46	0	0	eave/verandah/pergola/balcony >=450 mm	standard aluminium, single clear, (or U-value: 7.63, SHGC: 0.75)			
W17	E	0.95	0	0	eave/verandah/pergola/balcony >=450 mm	standard aluminium, single clear, (or U-value: 7.63, SHGC: 0.75)			
Skylights			•	•					
The applicant m	nust install the	e skylight	s in accord	dance with the	ne specifications listed in the table b	pelow.	✓	✓	✓
The following re	equirements r	must also	be satisfie	ed in relation	to each skylight:			✓	~
Each skylight mathematic that the sable below.		tch the de	escription,	or, have a U	l-value and a Solar Heat Gain Coef	ficient (SHGC) no greater than that listed in		✓	~
Skylights gl									
Skylight numbe	er Area of o		Shading	device	Frame and	glass type			
S03	1.092		no shadi	ng	timber, dou	ble clear/air fill, (or U-value: 4.3, SHGC: 0.5)			
S04	0.77		no shadi	na	timber, dou	ble clear/air fill, (or U-value: 4.3, SHGC: 0.5)			



	REV.	DATE	COMMENTS	DRWN	NOTES This drawing is the copyright of Action Plans and not be altered, reproduced or transmitted in any form or by any means in part or in
	Α	30.10.2020	DESIGN PLAN	AM	whole with the written permission of Action Plans. Do not scale measure from drawings. Figured dimensions are to be used only.
					The Builder/Contractor shall check and verify all levels and dimensions on site prior to commencement of any work, creation of shop drawings, or fabrication of components.
ıu					All errors and omissions are to be verified by the Builder/Contractor and referred to the designer prior to the commencement of works. All window & door dimensions, orientation, glazing materials, opening types, frame types are to be confirmed by a suitably qualified
					person prior to the ordering of any such materials are to take place. U value takes precedence over glazing type/colour in all cases.
					all new glazing must meet the BASIX specified frame and glass type, <u>OR</u> meet the specified U value and SHGC value.

CLIENT

SHAUN & AMANDA PEARSON

PROJECT ADDRESS 50 EARL STREET BEACON HILL, NSW, 2100

DRAWING NO.

BASIX COMMITMENTS - HOUSE

DRAWING NAME

DA14

2021

DATE Friday, February 5,



Building Sustainability Index www.basix.nsw.gov.au

Single Dwelling

Certificate number: 1043236S_03

This certificate confirms that the proposed development will meet the NSW government's requirements for sustainability, if it is built in accordance with the commitments set out below. Terms used in this certificate, or in the commitments, have the meaning given by the document entitled "BASIX Definitions" dated 10/09/2020 published by the Department. This document is available at www.basix.nsw.gov.au

Secretary
Date of issue: Friday, 30 October 2020
To be valid, this certificate must be lodged within 3 months of the date of issue.



Project summary						
Project name	50 Earl Street Beacon Hill	NSW 2100_03				
Street address	50 Earl Street Beacon Hill	2100				
Local Government Area	Northern Beaches Council					
Plan type and plan number	deposited 25164					
Lot no.	29					
Section no.	-					
Project type	attached dwelling house					
No. of bedrooms	2					
Project score						
Water	✓ 40	Target 40				
Thermal Comfort	✓ Pass	Target Pass				
Energy	✓ 50	Target 50				

Certificate Prepared by
Name / Company Name: Action Plans
ABN (if applicable): 17118297587

Project name	50 Earl Street Beacon Hill NSW 2100_03
Street address	50 Earl Street Beacon Hill 2100
Local Government Area	Northern Beaches Council
Plan type and plan number	Deposited Plan 25164
Lot no.	29
Section no.	-
Project type	
Project type	attached dwelling house
No. of bedrooms	2
Site details	
Site area (m²)	678
Roof area (m²)	61
Conditioned floor area (m2)	59.95
Unconditioned floor area (m2)	0.0
Total area of garden and lawn (m2)	31

Assessor details and thermal loads							
Assessor number n/a							
Certificate number	n/a						
Climate zone	n/a						
Area adjusted cooling load (MJ/m².year)	n/a						
Area adjusted heating load (MJ/m².year)	n/a						
Project score							
Water	✓ 40	Target 40					
Thermal Comfort	✓ Pass	Target Pass					
Energy	✓ 50	Target 50					

Schedule of BASIX commitments

The commitments set out below regulate how the proposed development is to be carried out. It is a condition of any development consent granted, or complying development certificate issued, for the proposed development, that BASIX commitments be complied with.

Water Commitments	Show on DA plans	Show on CC/CDC plans & specs	Certifier check
Fixtures			
The applicant must install showerheads with a minimum rating of 4 star (> 4.5 but <= 6 L/min plus spray force and/or coverage tests) in all showers in the development.		~	~
The applicant must install a toilet flushing system with a minimum rating of 5 star in each toilet in the development.		~	~
The applicant must install taps with a minimum rating of 5 star in the kitchen in the development.		~	
The applicant must install basin taps with a minimum rating of 5 star in each bathroom in the development.		~	
Alternative water			
Rainwater tank			
The applicant must install a rainwater tank of at least 1000 litres on the site. This rainwater tank must meet, and be installed in accordance with, the requirements of all applicable regulatory authorities.	~	~	~
The applicant must configure the rainwater tank to collect rain runoff from at least 80 square metres of the roof area of the development (excluding the area of the roof which drains to any stormwater tank or private dam).		~	~
The applicant must connect the rainwater tank to:			
all toilets in the development		~	•
the cold water tap that supplies each clothes washer in the development		✓	-

Thermal Comfort Commitments	Show on DA plans	Show on CC/CDC plans & specs	Certifier check
General features			
The dwelling must not have more than 2 storeys.	•	~	~
The conditioned floor area of the dwelling must not exceed 300 square metres.	V	~	~
The dwelling must not contain open mezzanine area exceeding 25 square metres.	V	~	~
The dwelling must not contain third level habitable attic room.	V	~	~
Floor, walls and ceiling/roof			
The applicant must construct the floor(s), walls, and ceiling/roof of the dwelling in accordance with the specifications listed in the table below.	~	~	~

Construction	Additional insulation required (R-Value)	Other specifications
floor - concrete slab on ground	nil	
external wall - brick veneer	1.86 (or 2.40 including construction)	
ceiling and roof - flat ceiling / pitched roof	ceiling: 2.75 (up), roof: foil/sarking	unventilated; light (solar absorptance < 0.475)

Note	Insulation specified in this Certificate must be installed in accordance with Part 3.12.1.1 of the Building Code of Australia.
Note	In some climate zones, insulation should be installed with due consideration of condensation and associated interaction with adjoining building materials.

Thermal Comfort Commitments	Show on DA plans	Show on CC/CDC plans & specs	Certifier check
Windows, glazed doors and skylights			
The applicant must install the windows, glazed doors and shading devices described in the table below, in accordance with the specifications listed in the table. Relevant overshadowing specifications must be satisfied for each window and glazed door.	~	~	~
The dwelling may have 1 skylight (<0.7 square metres) which is not listed in the table.	~	~	~
The following requirements must also be satisfied in relation to each window and glazed door:	~	~	~
For the following glass and frame types, the certifier check can be performed by visual inspection.			-
- Aluminium single clear			
- Aluminium double (air) clear			
- Timber/uPVC/fibreglass single clear			
- Timber/uPVC/fibreglass double (air) clear			
The applicant must install the skylights described in the table below, in accordance with the specifications listed in the table. Total skylight area must not exceed 3 square metres (the 3 square metre limit does not include the optional additional skylight of less than 0.7 square metres that does not have to be listed in the table).	~	~	~

Skylight no.	Maximum area (square metres)	Туре	Shading device
S01	0.81	aluminium, moulded plastic single clear	no shading
S02	0.81	aluminium, moulded plastic single clear	no shading

window/glazed door no.	height (mm)	(mm)	Type	10%)	Oversnadowing				
South facing	South facing								
D01	2400	2900	aluminium, single, clear	eave 2200 mm, 750 mm above head of window or glazed door	not overshadowed				
W01	1500	910	aluminium, single, clear	eave 2200 mm, 750 mm above head of window or glazed door	not overshadowed				
West facing									
Window/glazed door no.	Maximum height (mm)	Maximum width (mm)	Туре	Shading Device (Dimension within 10%)	Overshadowing				
W03	900	2410	aluminium, single, clear	eave 210 mm, 2665 mm above head of window or glazed door	not overshadowed				



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	REV.	DATE	COMMENTS	DRWN	NOTES
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NOTES

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All errors and omissions are to be verified by the Builder/Contractor and referred to the designer prior to the commencement of works.

All window & door dimensions, orientation, glazing materials, opening types, frame types are to be confirmed by a suitably qualified person prior to the ordering of any such materials are to take place.

U value takes precedence over glazing type/colour in all cases.

all new glazing must meet the BASIX specified frame and glass type, *QR* meet the specified U value and SHGC value.

2100

CLIENT

SHAUN & AMANDA PEARSON

PROJECT ADDRESS 50 EARL STREET BEACON HILL, NSW, DRAWING NO.

DA15

BASIX COMMITMENTS -SECONDARY DWELLING

DRAWING NAME

DATE Friday, February 5, 2021

Energy Commitments	Show on DA plans	Show on CC/CDC plans & specs	Certifier check
Hot water			
The applicant must install the following hot water system in the development, or a system with a higher energy rating: gas instantaneous with a performance of 4.5 stars.	~	~	~
Cooling system			
The applicant must install the following cooling system, or a system with a higher energy rating, in at least 1 living area: 1-phase airconditioning; Energy rating: EER 3.5 - 4.0	~	~	
The applicant must install the following cooling system, or a system with a higher energy rating, in at least 1 bedroom: 1-phase airconditioning; Energy rating: EER 3.5 - 4.0	~	~	
The cooling system must provide for day/night zoning between living areas and bedrooms.		•	•
Heating system			
The applicant must install the following heating system, or a system with a higher energy rating, in at least 1 living area: 1-phase airconditioning; Energy rating: EER 3.5 - 4.0		~	~
The applicant must install the following heating system, or a system with a higher energy rating, in at least 1 bedroom: 1-phase airconditioning; Energy rating: EER 3.5 - 4.0	~	~	
The heating system must provide for day/night zoning between living areas and bedrooms.		~	~
Ventilation			
The applicant must install the following exhaust systems in the development:			
At least 1 Bathroom: individual fan, ducted to façade or roof; Operation control: manual switch on/off		✓	-
Kitchen: individual fan, ducted to façade or roof; Operation control: manual switch on/off		✓	~
Laundry: natural ventilation only, or no laundry; Operation control: n/a		✓	•
Artificial lighting			
The applicant must ensure that the "primary type of artificial lighting" is fluorescent or light emitting diode (LED) lighting in each of the following rooms, and where the word "dedicated" appears, the fittings for those lights must only be capable of accepting fluorescent or light emitting diode (LED) lamps:			
at least 2 of the bedrooms / study; dedicated			

Energy Commitments	Show on DA plans	Show on CC/CDC plans & specs	Certifier check	
at least 1 of the living / dining rooms; dedicated		~	~	
the kitchen; dedicated		•	•	
all bathrooms/toilets; dedicated		•	-	
the laundry; dedicated		•	•	
all hallways; dedicated		•	•	
Other				
The applicant must install a gas cooktop & gas oven in the kitchen of the dwelling.		~		
The applicant must construct each refrigerator space in the development so that it is "well ventilated", as defined in the BASIX definitions.	~			
The applicant must install a fixed outdoor clothes drying line as part of the development.		~		

In these commitments, "applicant" means the person carrying out the development.

Commitments identified with a 💓 in the "Show on DA plans" column must be shown on the plans accompanying the development application for the proposed development (if a development application is to be lodged for the proposed development).

Commitments identified with a 🥥 in the "Show on CC/CDC plans and specs" column must be shown in the plans and specifications accompanying the application for a construction certificate / complying development certificate for the proposed development.

Commitments identified with a 🤟 in the "Certifier check" column must be certified by a certifying authority as having been fulfilled, before a final occupation certificate(either interim or final) for the development may be issued.

REV. DATE

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	А	30.10.2020	DESIGN PLAN	AM	whole with the written po
					The Builder/Contractor drawings, or fabrication
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					all new glazing must me

COMMENTS

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neet the BASIX specified frame and glass type, <u>OR</u> meet the specified U value and SHGC value.

CLIENT

SHAUN & AMANDA PEARSON

PROJECT ADDRESS 50 EARL STREET BEACON HILL, NSW, 2100

DRAWING NO.

DA16

Friday, February 5, 2021

DATE

BASIX COMMITMENTS -SECONDARY DWELLING

DRAWING NAME