# FOR DA SUBMISSION Request for Additional Information

# NEW DWELLLING

18 CLYDE ROAD, DEE WHY 2099



#### **GENERAL NOTES**

- 1. ONLY FIGURED DIMENSIONS ARE TO BE USED. DO NOT SCALE DIMENSIONS FROM THESE DRAWINGS.
- 2. ALL FIGURED DIMENSIONS ARE TO BE CONFIRMED ON SITE BY THE BUILDER PRIOR TO THE COMMENCEMENT OF ANY WORK.
- 3. ALL FINISHED LEVELS ARE TO AN ASSUMED DATUM. ALL LEVELS TO BE CONFIRMED ON SITE BY THE BUILDER PRIOR TO THE COMMENCEMENT OF CONSTRUCTION.
- 4. ALL WORKMANSHIP, MATERIALS AND CONSTRUCTION TO BE IN ACCORDANCE WITH ALL RELEVANT BUILDING CODES AND STANDARDS. ALL LOCAL COUNCIL REQUIREMENTS ARE TO BE STRICTLY ADHERED TO.
- 5. ALL SERVICES AND UTILITES ARE TO BE IDENTIFIED BY THE BUILDER PRIOR TO THE COMMENCEMENT OF ANY WORK.
- 6. OPENING SIZES ARE NOMINAL ONLY AND ARE TO BE ADJUSTED TO SUIT INDIVIDUAL MANUFACTURERS REQUIREMENTS.
- 7. ALL FLASHING AND WATERPROOFING TO BE PROVIDED BY THE BUILDER.


|             | SHEET LIST               |       |
|-------------|--------------------------|-------|
| DRAWING NO. | TITLE                    | SCALE |
| D01         | COVER PAGE               |       |
| D02         | SITE PLAN                | 1:100 |
| D03         | GROUND FLOOR PLAN        | 1:100 |
| D04         | FIRST FLOOR PLAN         | 1:100 |
| D05         | ROOF FLOOR PLAN          | 1:100 |
| D06         | NORTH ELEVATION          | 1:100 |
| D07         | EAST AND WEST ELEVATIONS | 1:100 |
| D08         | SECTIONS                 | 1:100 |
| D09         | SHADOW DIAGRAMS          | 1:500 |
| D10         | LANDSCAPE(EXPORT)        | 1:100 |
| D11         | NOTIFICATION PLAN        |       |






| н | DATE       | AMENDMENTS                         | NO   | BY |   |
|---|------------|------------------------------------|------|----|---|
|   | 19/11/2019 | FOR DA SUBMISSION                  | 01.1 | AW |   |
|   | 23/03/2020 | Request for additional information | 02   | AW |   |
|   |            |                                    |      |    |   |
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|   |            |                                    |      |    |   |
|   |            |                                    |      |    | 1 |

| ADDRESS        | DRAWING TITLE             | DRAWING STATUS |            |       |   |
|----------------|---------------------------|----------------|------------|-------|---|
| 18 Clyde Road, | COVER PAGE                | DA             | SUBMISSIO  | NC    |   |
| Dee Why 2099   |                           | DRAWN BY       | DATE       | SCALE |   |
| CLIENT         | PROJECT                   | AW             | 24/03/2020 |       | Œ |
| Steve Moran    | ADDITIONS AND ALTERATIONS | DWG NO         | JOB NUMBER | ISSUE |   |
|                |                           | D01            | 19070      | 02    |   |

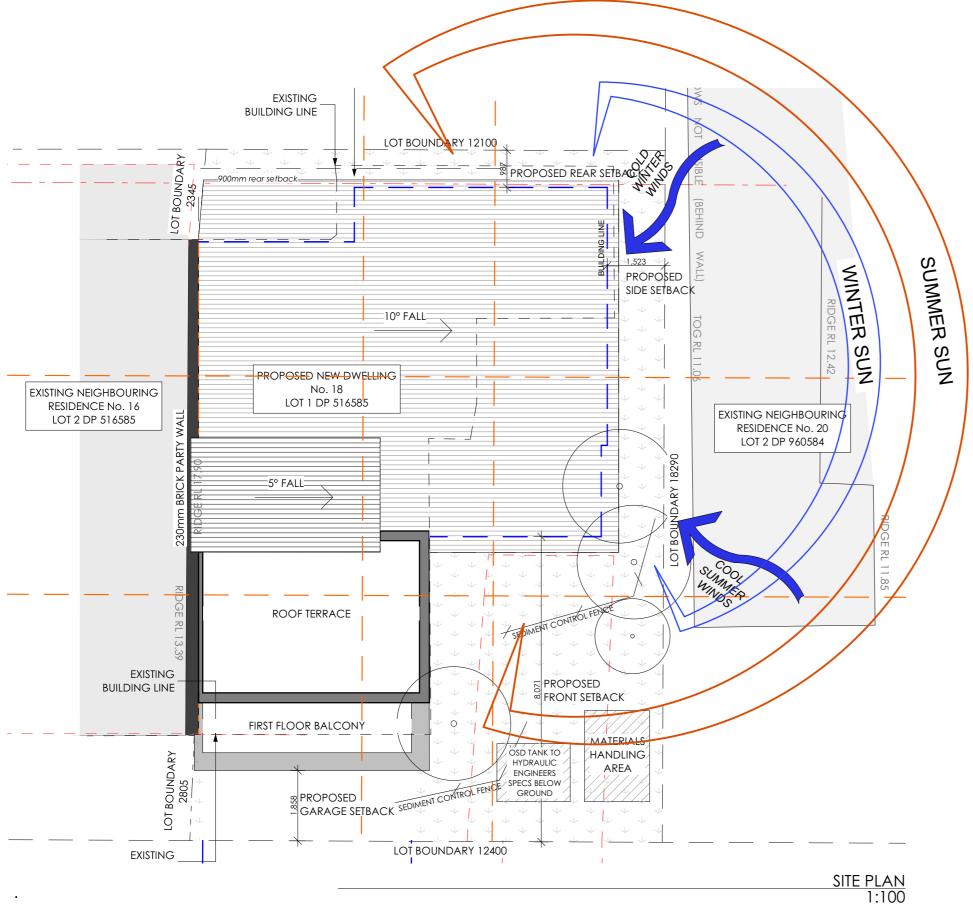

#### SEDIMENT FENCE SEDIMENT CONTROL MESH ON DOWN SLOPE BDY AS SHOWN ON PLANS, FABRIC TO BE TRENCHED 100mm & FIXED TO HARDWOOD STAKES GEOTEXTILE FILTER RUNOFF FABRIC POSTS DRIVEN IN MIN 600mm INTO GROUND

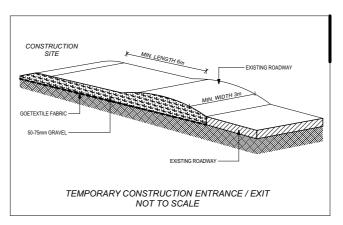

#### **NOTE**

FRAMING TO AS 1685 - 2010 CONCRETE FOOTING TO AS 2870 - 2011 PLUMBING TO AS 3500 - 2003 MASONRY TO AS 4773 & 3700 TERMITE CONTROL TO A\$2049 DOORS AND WINDOWS TO AS 2047

**ROOFING TO AS 2050** 

#### **DUST CONTROL**

TO REDUCE DUST GENERATED BY WIND ACTION, THE REMOVAL OF THE TOP SOIL IS TO BE MINIMISED. TO PREVENT DUST GENERATION, WATERING DOWN OF THE SITE, ESPECIALLY DURING THE MOVEMENT OF MACHINERY IS REQUIRED. WHERE EXCAVATING INTO ROCK, KEEP THE SURFACE MOIST TO MINIMISE DUST, CONSTRUCT A GRAVEL ENTRY/EXIT POINT USING BLUE METAL AND RESTRICT ALL VEHICLE MOVEMENTS WITHIN THE SITE TO A MINIMUM. ENSURE WIND BREAKS, SUCH AS EXISTING FENCES ARE MAINTAINED DURING THE CONSTRUCTION PHASE UNTIL NEW LANDSCAPING IS PROVIDED OR REINSTATED. PREVENT DUST BY COVERING STOCKPILES

#### SEDIMENT NOTE


. ALL EROSION AND SEDIMENT CONTROL MEASURES TO BE INSPECTED AND MAINTAINED DAILY BY THE SITE MANAGER.

. MINIMISE DISTURBED AREAS, REMOVE EXCESS SOIL FROM EXCAVATED AREA AS SOON AS POSSIBLE.

3. ALL MATERIAL STOCKPILE TO BE CLEAR FROM DRAINS, GUTTERS AND FOOTPATHS, OR WITHIN SEDIMENT FENCE AREA.

4. DRAINAGE TO BE CONNECTED TO STORMWATER AS SOON AS POSSIBLE. IF STORED ON SITE, IT MUST BE FILTERED BEFORE RELEASING INTO STORMWATER SYSTEM OR WATERWAYS

5. ROADS AND FOOTPATHS TO BE SWEPT DAILY.

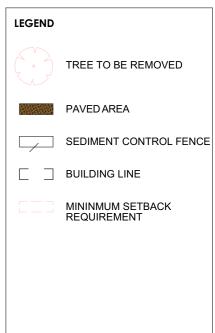

#### SITE STATISTICS DESCRIPTION AREA m<sup>2</sup> SITE SIZE 225.27m<sup>2</sup> LANDSCAPE AREA 79.17m<sup>2</sup> 76.07m<sup>2</sup> **GROUND FLOOR AREA** (32.88m<sup>2</sup> Garage) 98.93m<sup>2</sup> FIRST FLOOR AREA (17.22m<sup>2</sup> Balconies) 7.86m<sup>2</sup> TERRACE AREA (23.08m<sup>2</sup> Balcony)


TOTAL INTERNAL AREA

182.86m<sup>2</sup>



Full Member No. 1672 - 14 FYFFE DESIGN

| DATE       | AMENDMENTS                         | NO   | BY | ADDRESS                        | DRAWING TITLE             | DRAWING STATUS |            |       |
|------------|------------------------------------|------|----|--------------------------------|---------------------------|----------------|------------|-------|
| 19/11/2019 | FOR DA SUBMISSION                  | 01.1 | AW | 18 Clyde Road,<br>Dee Why 2099 | SITE PLAN                 | DA             | SUBMISSI   | ON    |
| 23/03/2020 | Request for additional information | 02   | AW | Dee Wily 2099                  |                           | DRAWN BY       | DATE       | SCALE |
|            |                                    |      |    | CLIENT                         | PROJECT                   | AW             | 24/03/2020 | 1:100 |
|            |                                    |      |    | Steve Moran                    | ADDITIONS AND ALTERATIONS | DWG NO         | JOB NUMBER | ISSUE |
|            |                                    |      |    |                                |                           | D02            | 19070      | 02    |

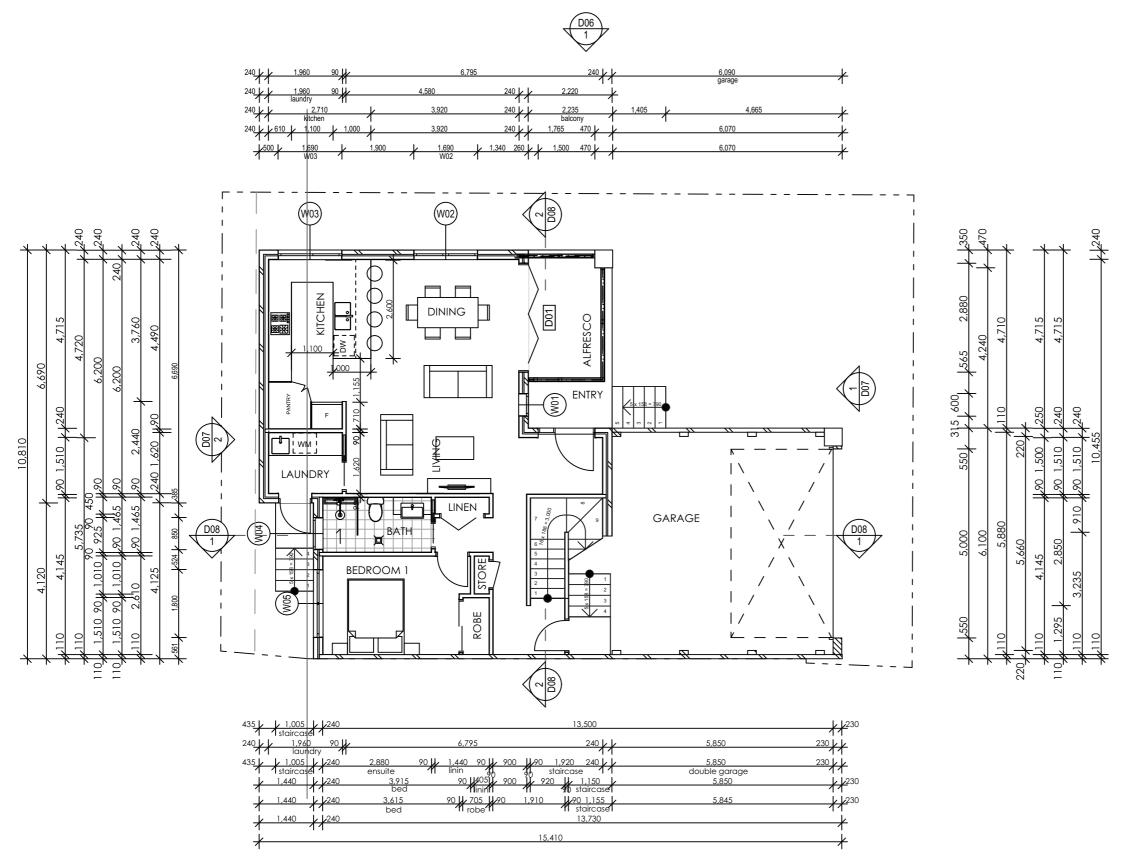

## Specifica tions

#### Water

- 1,500 Rainwater tank, approx. 50% of roof draining to it, connect to WC, garden tap & washing machine
- 3 star showerhead 7.5-9L/m
- 4 star WC
- 4 star taps

#### Thermal

- Light/medium coloured walls
- Dark colour roof
- Raft slab (timber to living areas, tiles to wet areas and carpet to beds
- R2.0 wall insulation to framed wall between house/garage
- 10mm foil faced foam cavity insulation to cavity brick external walls (excluding garage)
- R3.5 ceiling insulation (excluding garage\_
- Anticon insulation to roof
- Self sealing exhaust fans to wet areas with shower
- Surface mounted lighting
- Weather stripping
- Standard windows (wideline spec)
- Sliding/fixed Uw 6.4 & shgc 0.76 clear glass
- Bifold door Uw 6.2 & shgc 0.62 clear glass
- Awning Uw 6.5 & shgc 0.63 clear glass
- Louver Uw 6.0 & shgc 0.67 clear glass (assumed
- Entry frame/hung door Uw5.9 & shgc 0.6 clear glass

#### Energy

- Gas instantaneous HWS 6 stars
- Three phase reverse cycle A/C
- Exhaust fan to wet areas with a shower, ducted to outside air
- Rangehood, ducted to outside air
- Gas cooktop, electric oven
- External clothesline

**GROUND FLOOR PLAN** 1:100



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| DATE       | AMENDMENTS                         | NO   | BY |
|------------|------------------------------------|------|----|
| 19/11/2019 | FOR DA SUBMISSION                  | 01.1 | AW |
| 23/03/2020 | Request for additional information | 02   | AW |
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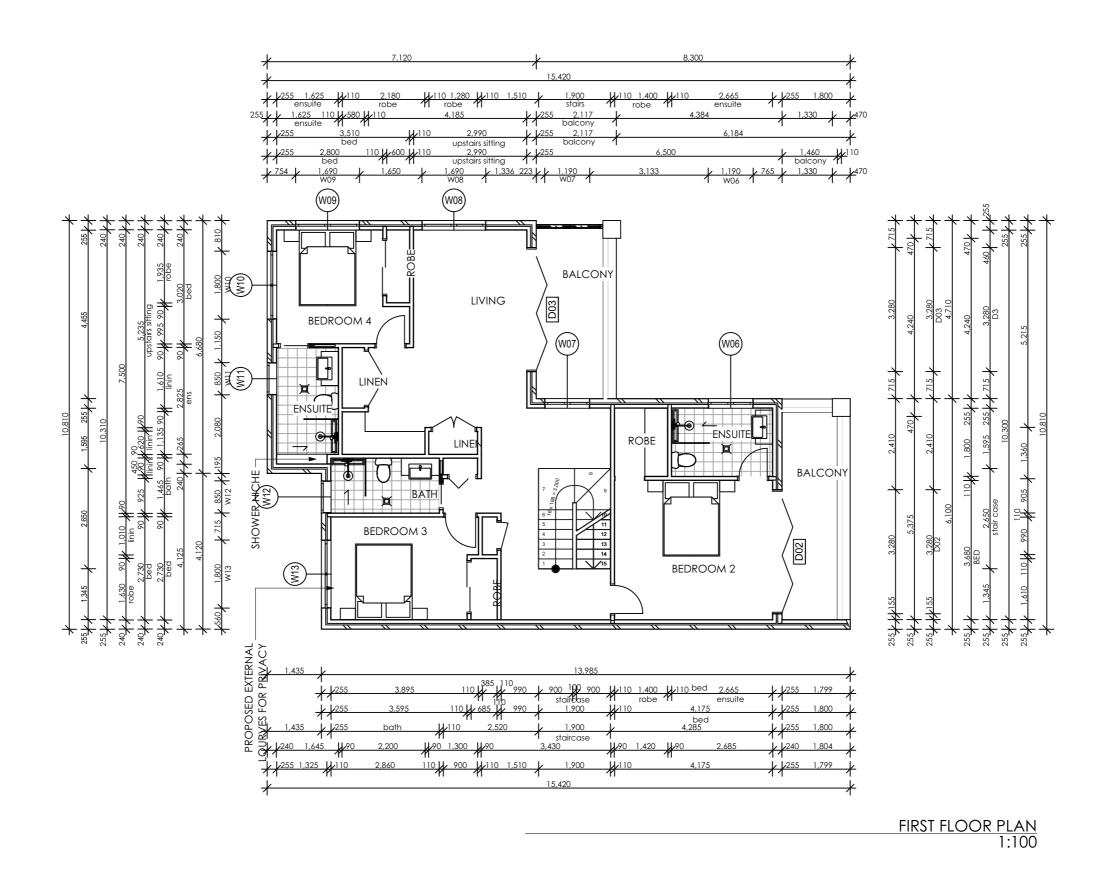
|   | ADDRESS        |
|---|----------------|
|   | 18 Clyde Road, |
| _ | Dee Why 2099   |
|   | CLIENT         |

Steve Moran

DRAWING TITLE **GROUND FLOOR PLAN** 

DRAWING STATUS DRAWN BY AW ADDITIONS AND ALTERATIONS DWG NO


DA SUBMISSION DATE **SCALE** 24/03/2020 1:100 JOB NUMBER ISSUE D03 19070 02








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|  | DATE       | AMENDMENTS                         | NO   | BY   | 18 Clyde Road, | FIRST FLOOR PLAN          |                | SUBMISSI   | OΝ    |
|  | 19/11/2019 | FOR DA SUBMISSION                  | 01.1 | AW   | Dee Why 2099   | TIKST LOOK LEAN           |                | 3001711331 | ON    |
|  | 23/03/2020 | Request for additional information | 02   | AW   | Dee Wily 2077  |                           | DRAWN BY       | DATE       | SCALE |
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|  |            |                                    |      |      | Steve Moran    | ADDITIONS AND ALTERATIONS | DWG NO         | JOB NUMBER | ISSUE |
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ROOF PLAN 1:100

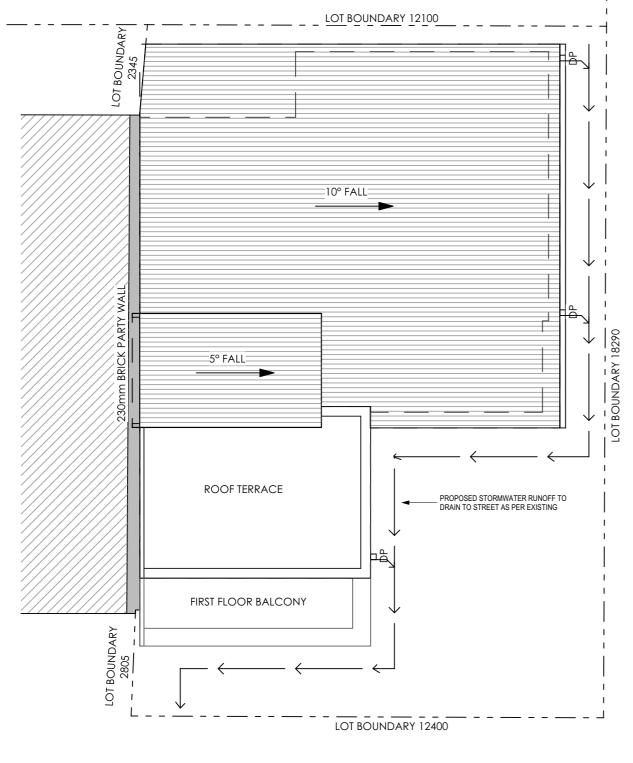ROOF TERRACE FLOOR PLAN 1:100

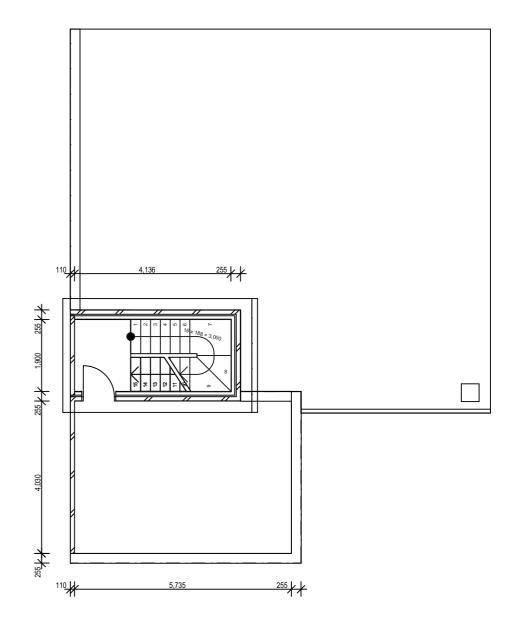DA SUBMISSION

24/03/2020

19070

JOB NUMBER

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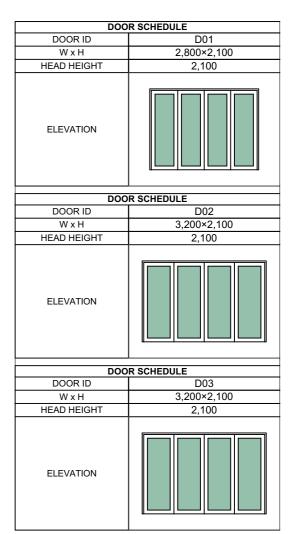
D05



FYFFE DESIGN

| DATE       | AMENDMENTS                         | NO   | BY | ADDRESS                        |                           | DRAWING STATUS |     |
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| 19/11/2019 | FOR DA SUBMISSION                  | 01.1 | AW | 18 Clyde Road,<br>Dee Why 2099 | ROOF FLOOR PLAN           | DA             | k . |
| 23/03/2020 | Request for additional information | 02   | AW | Dee Why 2099                   |                           | DRAWN BY       | С   |
|            |                                    |      |    | CLIENT                         | PROJECT                   | AW             |     |
|            |                                    |      |    | Steve Moran                    | ADDITIONS AND ALTERATIONS | DWG NO         | J   |
|            |                                    |      |    |                                |                           | D05            |     |





NORTH ELEVATION 1:100

| WINDOW SCHEDULE |           |           |           |         |             |           |           |           |           |           |         |         |             |
|-----------------|-----------|-----------|-----------|---------|-------------|-----------|-----------|-----------|-----------|-----------|---------|---------|-------------|
| WINDOW ID       | W01       | W02       | W03       | W04     | W05         | W06       | W07       | W08       | W09       | W10       | W11     | W12     | W13         |
| WxH             | 600×1,800 | 1,690×860 | 1,690×860 | 850×850 | 1,800×1,275 | 1,190×860 | 1,190×860 | 1,690×860 | 1,690×860 | 1,800×850 | 850×850 | 850×850 | 1,800×1,200 |
| HEAD HEIGHT     | 2,054     | 2,100     | 2,100     | 2,100   | 2,100       | 2,100     | 2,100     | 2,100     | 2,100     | 2,100     | 2,100   | 2,100   | 2,100       |
| ELEVATION       |           |           |           |         |             |           |           |           |           |           |         |         |             |





NORTH

| DATE       | AMENDMENTS                         | NO   | BY | ADDRESS        | DRAWING TITLE             | DRAWING STATUS |            |       |
|------------|------------------------------------|------|----|----------------|---------------------------|----------------|------------|-------|
| DATE       | AMENDMENTS                         | INO  | DI | 18 Clyde Road, | NORTH ELEVATION           | DA             | SUBMISSI   | ON    |
| 19/11/2019 | FOR DA SUBMISSION                  | 01.1 | AW | Dee Why 2099   | THORITIZE TY MIGHT        |                | 000/1001   | 011   |
| 23/03/2020 | Request for additional information | 02   | AW | Dee Wily 2077  |                           | DRAWN BY       | DATE       | SCALE |
|            |                                    |      |    | CLIENT         | PROJECT                   | AW             | 24/03/2020 | 1:100 |
|            |                                    |      |    | Steve Moran    | ADDITIONS AND ALTERATIONS | DWG NO         | JOB NUMBER | ISSUE |
|            |                                    |      |    |                |                           |                |            |       |
|            |                                    |      |    |                |                           | D06            | 19070      | 02    |







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|            | 4.45 ND.45 NTC                     |      | D)/ | ADDRESS        | DRAWING TITLE                     | DRAWING STATUS |    |
|------------|------------------------------------|------|-----|----------------|-----------------------------------|----------------|----|
| DATE       | AMENDMENTS                         | NO   | BY  | 18 Clyde Road, | EAST AND WEST ELEVATIONS          | DA             |    |
| 19/11/2019 | FOR DA SUBMISSION                  | 01.1 | AW  | Dee Why 2099   | LY 101 7 (ND VY LOT ELE V7 (NO NO |                | •  |
| 23/03/2020 | Request for additional information | 02   | AW  | Dee Wily 2077  |                                   | DRAWN BY       | С  |
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|            |                                    |      |     | Steve Moran    | ADDITIONS AND ALTERATIONS         | DWG NO         | J. |
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DA SUBMISSION

24/03/2020

19070

JOB NUMBER


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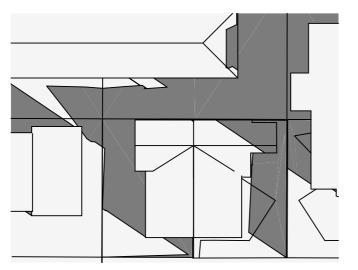
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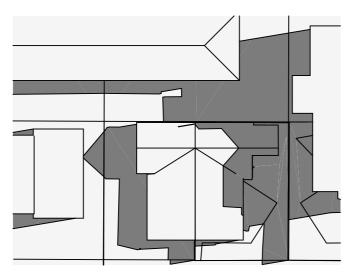





| DATE       | AMENDMENTS                         | NO   | BY | ADDRESS<br>18 Clyde Road, | DRAWING TITLE SECTIONS    | DRAWING STATUS | SUBMISSI   | ON    |
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| 19/11/2019 | FOR DA SUBMISSION                  | 01.1 | AW | Dee Why 2099              | SECTIONS                  | DA             | SUDIVIISSI |       |
| 23/03/2020 | Request for additional information | 02   | AW | Dee Wily 2099             |                           | DRAWN BY       | DATE       | SCALE |
|            |                                    |      |    | CLIENT                    | PROJECT                   | AW             | 24/03/2020 | 1:100 |
|            |                                    |      |    | Steve Moran               | ADDITIONS AND ALTERATIONS | DWG NO         | JOB NUMBER | ISSUE |
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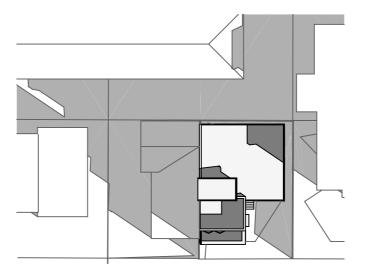
21 JUNE 9AM - EXISTING 1:500




21 JUNE 12PM - EXISTING 1:500

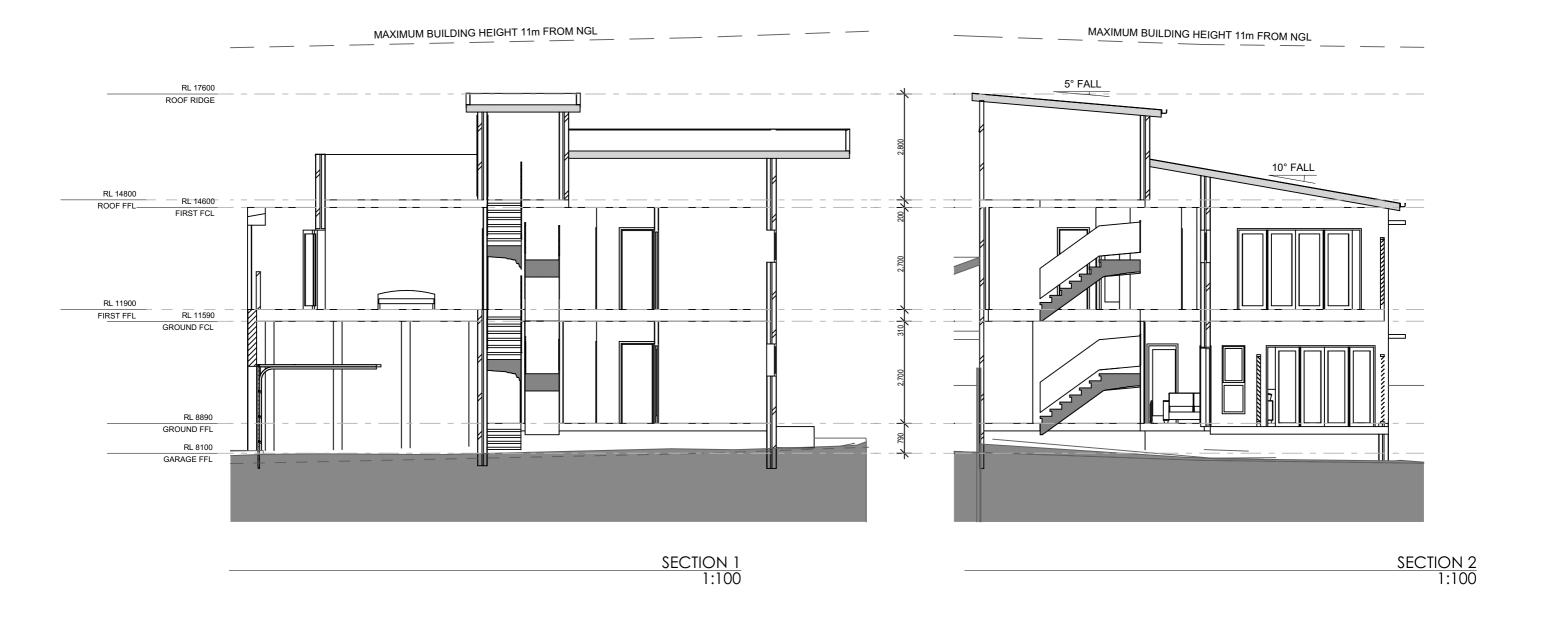


21 JUNE 3PM - EXISTING 1:500

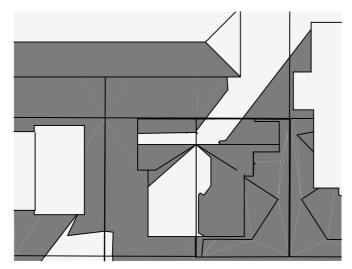

21 JUNE 9AM - PROPOSED 1:500

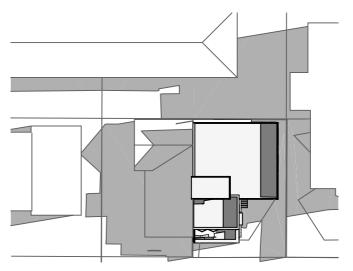

21 JUNE 12PM - PROPOSED 1:500

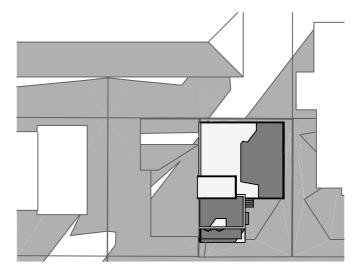


21 JUNE 12PM - PROPOSED 1:500



FYFFE DESIGN

| DATE       | AMENDMENTS                         | NO   | BY | 18   |
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| 19/11/2019 | FOR DA SUBMISSION                  | 01.1 | AW |      |
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| ADDRESS        | DRAWING TITLE             | DRAWING STATUS |            |       |
|----------------|---------------------------|----------------|------------|-------|
| 18 Clyde Road, | SHADOW DIAGRAMS           | DA SUBMISSION  |            |       |
| Dee Why 2099   |                           | DRAWN BY       | DATE       | SCALE |
| CLIENT         | PROJECT                   | AW             | 24/03/2020 | 1:500 |
| Steve Moran    | ADDITIONS AND ALTERATIONS | DWG NO         | JOB NUMBER | ISSUE |
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| 19/11/2019 | FOR DA SUBMISSION                  | 01.1 | AW | Dee Why 2099   | THO THE CONTROL OF TH |                | . 300/////33/ |          |
| 23/03/2020 | Request for additional information | 02   | AW | Dee Wily 2099  |  | DRAWN BY       | DATE          | SCALE    |
|            |                                    |      |    | CLIENT         | PROJECT  | AW             | 24/03/2020    |          |
|            |                                    |      |    | Steve Moran    | ADDITIONS AND ALTERATIONS  | DWG NO         | JOB NUMBER    | ISSUE    |
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|            |                                    |      |    |                |  | D11            | 19070         | (        |

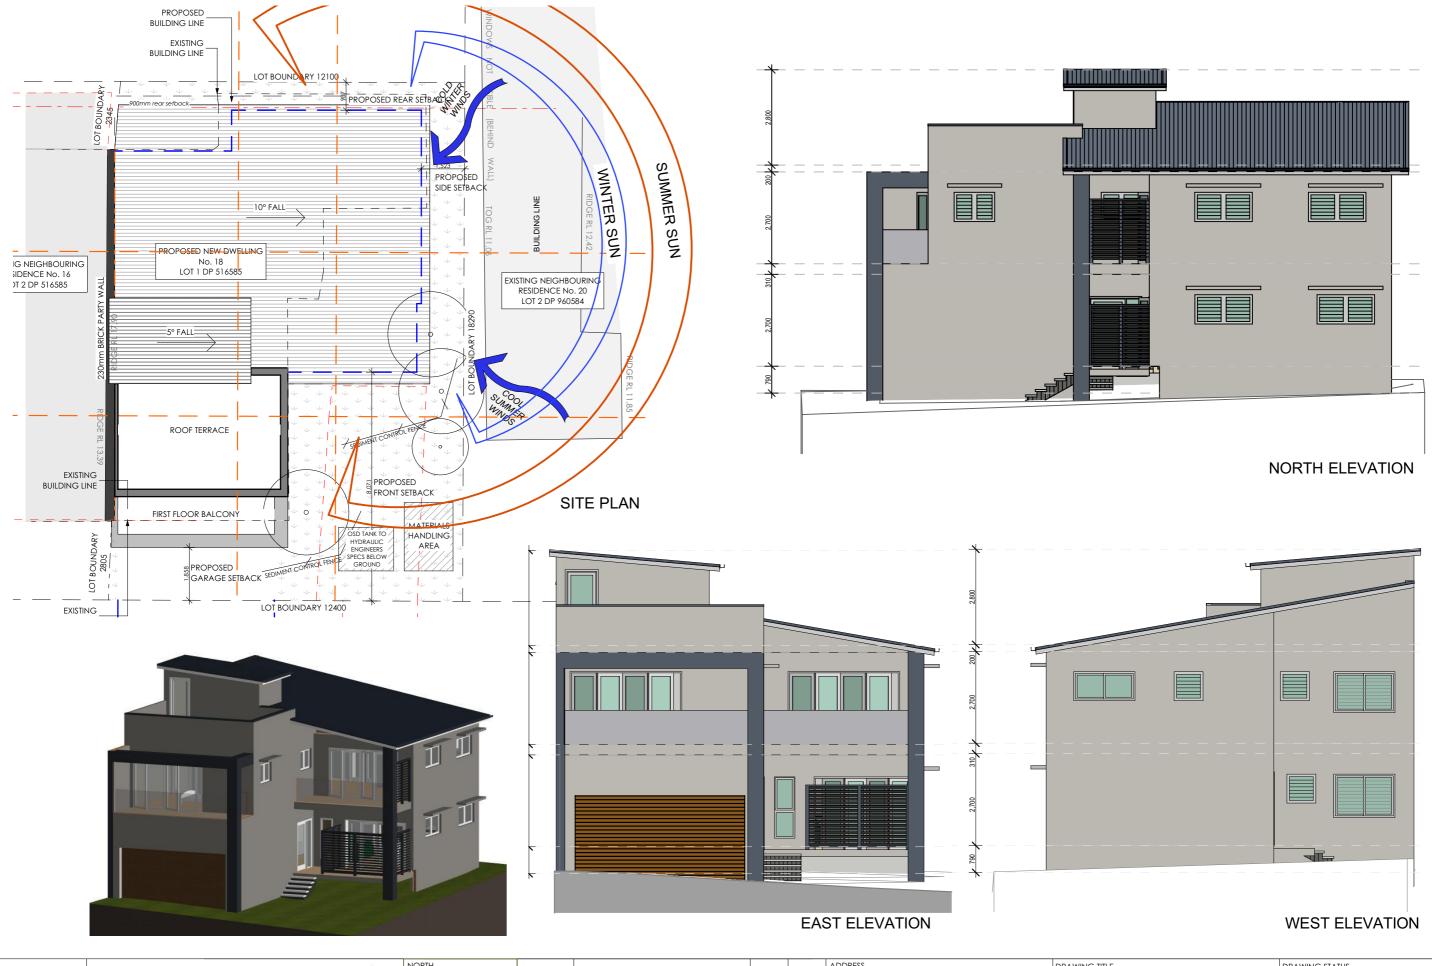

Building Sustainability Index www.basix.nsw.gov.au

#### Single Dwelling

Certificate number: 1043987S

This certificate confirms that the proposed development will meet the NSW government's requirements for sustainability, if it is built in accordance with the commitments set out below. Terms used in this certificate, or in the commitments, have the meaning given by the document entitled "BASIX Definitions" dated 06/10/2017 published by the Department. This document is available at www.basix.nsw.gov.au

Secretary
Date of issue: Friday, 01 November 2019
To be valid, this certificate must be lodged within 3 months of the date of issue.



| Project summary           |                     |             |
|---------------------------|---------------------|-------------|
| Project name              | FYF001              |             |
| Street address            | 18 Clyde Road DEE   | WHY 2099    |
| Local Government Area     | Northern Beaches (  | Council     |
| Plan type and plan number | deposited 516585    |             |
| Lot no.                   | 1                   |             |
| Section no.               | -                   |             |
| Project type              | separate dwelling h | ouse        |
| No. of bedrooms           | 4                   |             |
| Project score             |                     |             |
| Water                     | <b>✓</b> 43         | Target 40   |
| Thermal Comfort           | ✓ Pass              | Target Pass |
| Energy                    | <b>✓</b> 55         | Target 50   |

| Project address                    |                            |  |  |  |
|------------------------------------|----------------------------|--|--|--|
| Project name                       | FYF001                     |  |  |  |
| Street address                     | 18 Clyde Road DEE WHY 2099 |  |  |  |
| Local Government Area              | Northern Beaches Council   |  |  |  |
| Plan type and plan number          | Deposited Plan 516585      |  |  |  |
| Lot no.                            | 1                          |  |  |  |
| Section no.                        | -                          |  |  |  |
| Project type                       |                            |  |  |  |
| Project type                       | separate dwelling house    |  |  |  |
| No. of bedrooms                    | 4                          |  |  |  |
| Site details                       |                            |  |  |  |
| Site area (m²)                     | 225                        |  |  |  |
| Roof area (m²)                     | 112                        |  |  |  |
| Conditioned floor area (m2)        | 159.0                      |  |  |  |
| Unconditioned floor area (m2)      | 12.0                       |  |  |  |
| Total area of garden and lawn (m2) | 65                         |  |  |  |

| Name / Company Name: Thermal Performance |            |  |  |  |  |  |
|--|------------|--|--|--|--|--|
| ABN (if applicable): 64 137 428 767      |            |  |  |  |  |  |
|  |            |  |  |  |  |  |
| Assessor details and thermal loads       |            |  |  |  |  |  |
| Assessor number                          | 20731      |  |  |  |  |  |
| Certificate number                       | 0004327904 |  |  |  |  |  |

Certificate Prepared by

| Assessor details and thermal loads |   |  |  |  |  |  |  |
|------------------------------------|---|--|--|--|--|--|--|
| 20731                              |   |  |  |  |  |  |  |
| 0004327904                         |   |  |  |  |  |  |  |
| 56                                 |   |  |  |  |  |  |  |
| 13                                 |   |  |  |  |  |  |  |
| 27                                 |   |  |  |  |  |  |  |
|                                    |   |  |  |  |  |  |  |
| <b>✓</b> 43                        | Target 40   |  |  |  |  |  |  |
| ✓ Pass                             | Target Pass   |  |  |  |  |  |  |
| <b>✓</b> 55                        | Target 50   |  |  |  |  |  |  |
|                                    | 20731<br>0004327904<br>56<br>13<br>27<br>✓ 43<br>✓ Pass |  |  |  |  |  |  |

| Water Commitments   | Show on DA plans | Show on CC/CDC plans & specs | Certifier<br>check |
|---|------------------|------------------------------|--------------------|
| Fixtures  |                  |                              |                    |
| The applicant must install showerheads with a minimum rating of 3 star (> 7.5 but <= 9 L/min) in all showers in the development.  |                  | ~                            | ~                  |
| The applicant must install a toilet flushing system with a minimum rating of 4 star in each toilet in the development.  |                  | ~                            | ~                  |
| The applicant must install taps with a minimum rating of 4 star in the kitchen in the development.  |                  | ~                            |                    |
| The applicant must install basin taps with a minimum rating of 4 star in each bathroom in the development.  |                  | ~                            |                    |
| Alternative water   |                  |                              |                    |
| Rainwater tank  |                  |                              |                    |
| The applicant must install a rainwater tank of at least 1500 litres on the site. This rainwater tank must meet, and be installed in accordance with, the requirements of all applicable regulatory authorities.                 | ~                | ~                            | ~                  |
| The applicant must configure the rainwater tank to collect rain runoff from at least 100 square metres of the roof area of the development (excluding the area of the roof which drains to any stormwater tank or private dam). |                  | ~                            | ~                  |
| The applicant must connect the rainwater tank to:   |                  |                              |                    |
| all toilets in the development  |                  | •                            | -                  |
| the cold water tap that supplies each clothes washer in the development   |                  | •                            | -                  |
| <ul> <li>at least one outdoor tap in the development (Note: NSW Health does not recommend that rainwater be used for human<br/>consumption in areas with potable water supply.)</li> </ul>                                      |                  | •                            | ~                  |

| Thermal Comfort Commitments  | Show on<br>DA plans | Show on CC/CDC plans & specs | Certifier check |
|--|---------------------|------------------------------|-----------------|
| Simulation Method  |                     |                              |                 |
| The applicant must attach the certificate referred to under "Assessor Details" on the front page of this BASIX certificate (the "Assessor Certificate") to the development application and construction certificate application for the proposed development (or, if the applicant is applying for a complying development certificate for the proposed development, to that application). The applicant must also attach the Assessor Certificate to the application for an occupation certificate for the proposed development.  |                     |                              |                 |
| The Assessor Certificate must have been issued by an Accredited Assessor in accordance with the Thermal Comfort Protocol.  |                     |                              |                 |
| The details of the proposed development on the Assessor Certificate must be consistent with the details shown in this BASIX certificate, including the Cooling and Heating loads shown on the front page of this certificate.  |                     |                              |                 |
| The applicant must show on the plans accompanying the development application for the proposed development, all matters which the Assessor Certificate requires to be shown on those plans. Those plans must bear a stamp of endorsement from the Accredited Assessor to certify that this is the case. The applicant must show on the plans accompanying the application for a construction certificate (or complying development certificate, if applicable), all thermal performance specifications set out in the Assessor Certificate, and all aspects of the proposed development which were used to calculate those specifications. | ~                   | •                            | ~               |
| The applicant must construct the development in accordance with all thermal performance specifications set out in the Assessor Certificate, and in accordance with those aspects of the development application or application for a complying development certificate which were used to calculate those specifications.  |                     | ~                            | ~               |
| The applicant must construct the floors and walls of the dwelling in accordance with the specifications listed in the table below.   | ~                   | •                            | ~               |

| floor - concrete slab on ground  |  |                  |                                       |                   |
|--|--|------------------|---------------------------------------|-------------------|
|  | All or part of floor area square metres                            |                  |                                       |                   |
| floor - suspended floor above garage   | All or part of floor area  |                  | 1                                     |                   |
| Energy Commitments   |  | Show on DA plans | Show on CC/CDC plans & specs          | Certifie<br>check |
| Hot water  |  |                  |                                       |                   |
| The applicant must install the following hot water system in the development, or a system to the development or a system in the development or a system to the development of the development or a system to the development of the development or a system to the development of the develo | stem with a higher energy rating: gas                              | ~                | ~                                     | ~                 |
| Cooling system   |  |                  |                                       |                   |
| The applicant must install the following cooling system, or a system with a higher enealronditioning; Energy rating: EER $3.0$ - $3.5$   | ergy rating, in at least 1 living area: 3-phase                    |                  | ~                                     | ~                 |
| The applicant must install the following cooling system, or a system with a higher eneal airconditioning; Energy rating: EER 3.0 - 3.5   | ergy rating, in at least 1 bedroom: 3-phase                        |                  | ~                                     | ~                 |
| The cooling system must provide for day/night zoning between living areas and bedro  | ooms.  |                  | <b>✓</b>                              | •                 |
| Heating system   |  |                  |                                       |                   |
| The applicant must install the following heating system, or a system with a higher enealronditioning; Energy rating: EER $3.5-4.0$   | ergy rating, in at least 1 living area: 3-phase                    |                  | ~                                     | ~                 |
| The applicant must install the following heating system, or a system with a higher ene<br>airconditioning; Energy rating: EER 3.5 - 4.0  | ergy rating, in at least 1 bedroom: 3-phase                        |                  | <b>&gt;</b>                           | •                 |
| The heating system must provide for day/night zoning between living areas and bedr   | ooms.  |                  | <b>✓</b>                              | -                 |
| Ventilation  |  | <u>'</u>         |                                       |                   |
| The applicant must install the following exhaust systems in the development:   |  |                  |                                       |                   |
| At least 1 Bathroom: individual fan, ducted to façade or roof; Operation control: mar  | nual switch on/off   |                  |                                       |                   |
|  |  |                  | ~                                     | ~                 |
| Kitchen: individual fan, ducted to façade or roof; Operation control: manual switch o  | n/off  |                  | ~                                     | •                 |
| Laundry: natural ventilation only, or no laundry; Operation control: n/a   |  |                  | <b>✓</b>                              | •                 |
| Artificial lighting  |  |                  |                                       |                   |
| Artificial lighting  |  |                  |                                       |                   |
| The applicant must ensure that the "primary type of artificial lighting" is fluorescent or<br>following rooms, and where the word "dedicated" appears, the fittings for those lights<br>light emitting diode (LED) lamps:  |  |                  |                                       |                   |
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| The applicant must ensure that the "primary type of artificial lighting" is fluorescent or following rooms, and where the word "dedicated" appears, the fittings for those lights light emitting diode (LED) lamps:  • at least 4 of the bedrooms / study; dedicated  • at least 3 of the living / dining rooms; dedicated   |  |                  | · ·                                   |                   |
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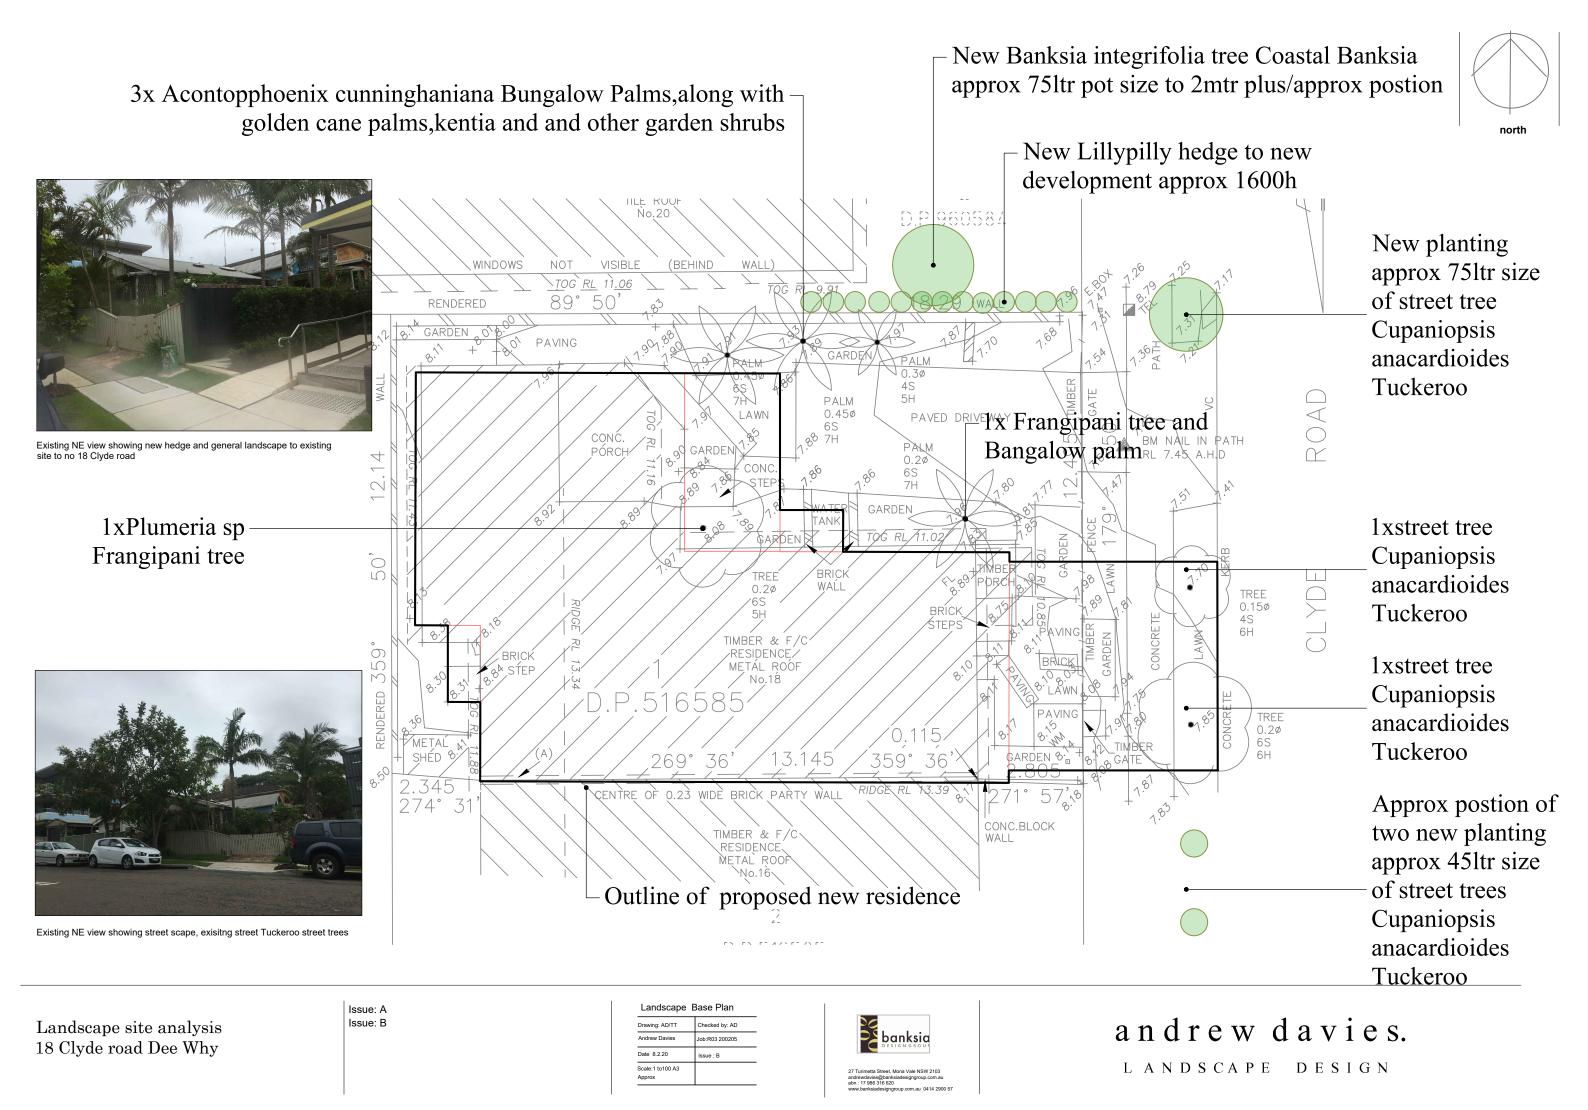



No. 1672 - 14



| ORTH | DATE       | AMENDMENTS                         | NO   | BY |
|------|------------|------------------------------------|------|----|
|      | 19/11/2019 | FOR DA SUBMISSION                  | 01.1 | AW |
|      | 23/03/2020 | Request for additional information | 02   | AW |
|      |            |                                    |      |    |
|      |            |                                    |      |    |
|      |            |                                    |      |    |
|      |            |                                    |      |    |

|                             | ADDRESS            | DRAWING TITLE             | DRAWING STATUS |            |       |     |
|-----------------------------|--------------------|---------------------------|----------------|------------|-------|-----|
| 18 Clyde Road, Dee Why 2099 | BASIXs commitments | da submission             |                |            |       |     |
|                             | Dee Wily 2099      |                           | DRAWN BY       | DATE       | SCALE |     |
|                             | CLIENT             | PROJECT                   | AW             | 24/03/2020 |       | @ A |
|                             | Steve Moran        | ADDITIONS AND ALTERATIONS | DWG NO         | JOB NUMBER | ISSUE |     |
| -                           |                    |                           | D12            | 19070      | 02    |     |



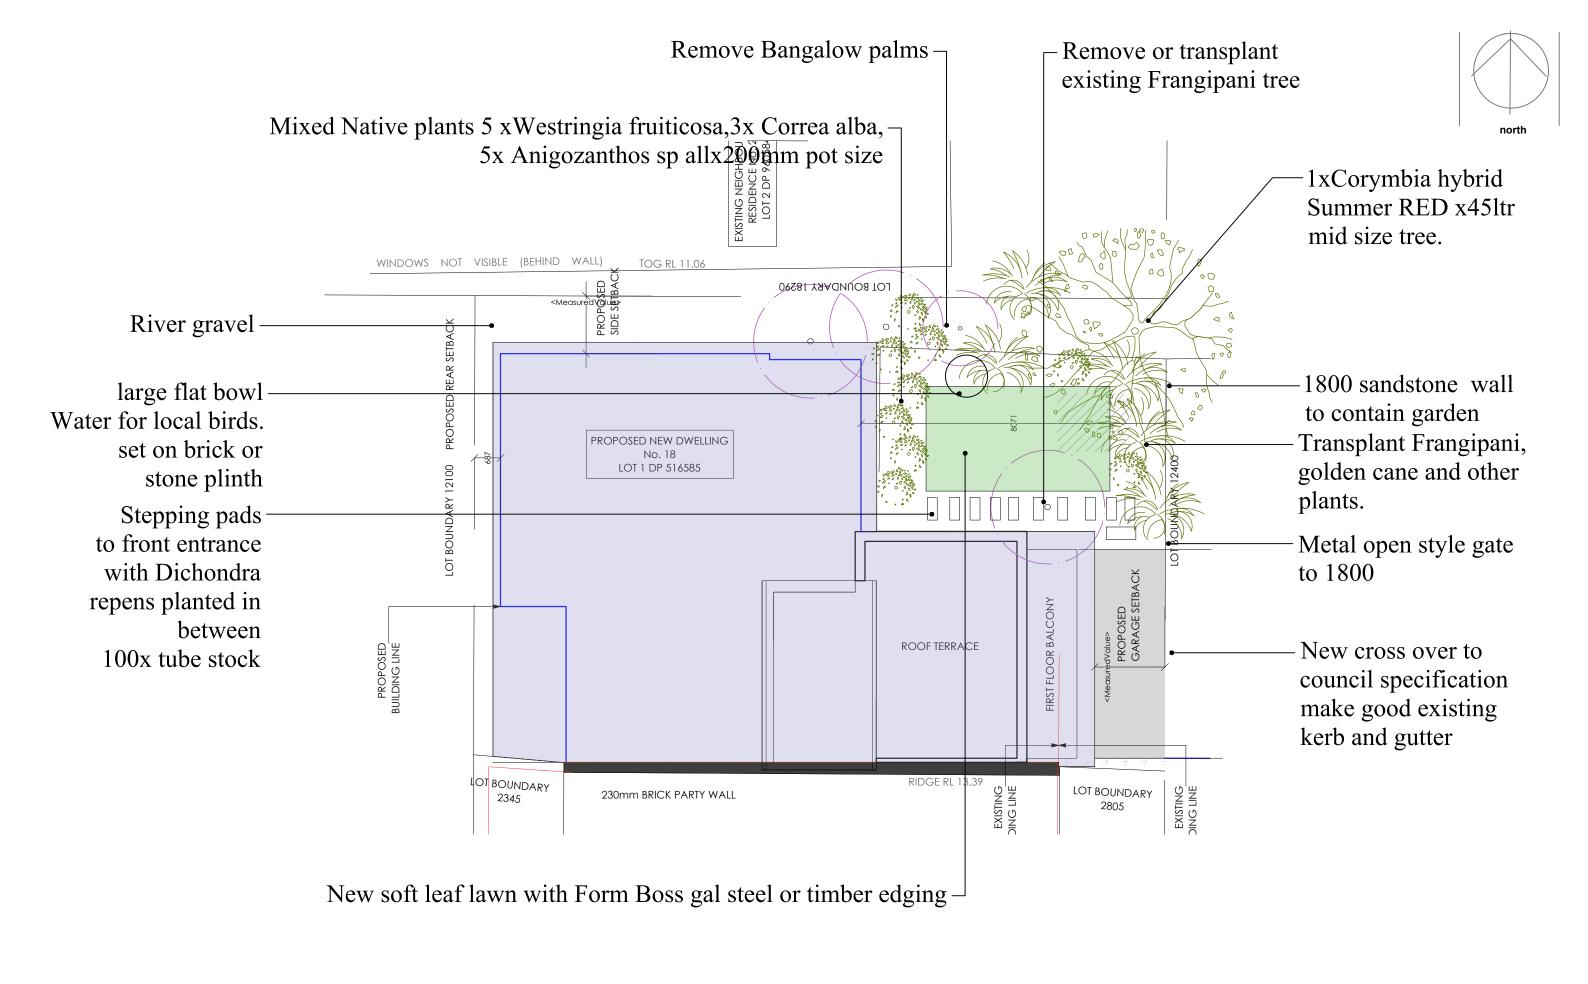

Landscape site plan 18 Clyde road Dee Why Issue: A Issue: B 
 Landscape
 Base Plan

 Drawing: AD/TT
 Checked by: AD

 Andrew Davies
 Job:r03 200205

 Date 8.2.20
 Issue : A

 Scale: 1 to 100 A3
 Annox




andrew davies.

L ANDSCAPE DESIGN

#### Plant schedule

| Anigothanzos sp  | Kangaroo paw             | 200   | .8x.8    | 5   |
|------------------|--------------------------|-------|----------|-----|
| Correa alba      | Corra                    | 200   | 1x1      | 3   |
| Corymbia hybrid  | Eucalyptus Red flowering | 45ltr | 5x5 plus | 1   |
| Dichondra repens | Dichondra                | tube  | .2x.6    | 100 |
|                  |                          |       |          |     |
|                  |                          |       |          |     |
|                  |                          |       |          |     |
|                  |                          |       |          |     |
|                  |                          |       |          |     |
|                  |                          |       |          |     |
|                  |                          |       |          |     |

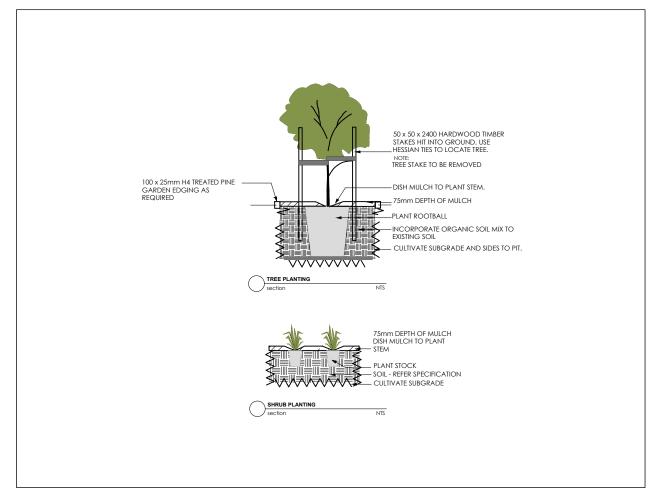

## **Planting detail**

# LANDSCAPE GENERAL SPECIFICATION AND NOTES

All landscape works and material supply, to be in accordance with AS 4000, LCA guidelines and Occupational Health & Safety standards.

All landscape works to comply with relevant Australian Standards and relevant Building Codes of Australia

All dimensions and locations to be checked on site and confirmed by landscape site supervisor pefore commencement of works

Do not scale from drawings. Dimensions take preference

Plant schedule and quantities to be used as guide only and to be confirmed by contractor before final purchase of plants

Final plant positions to be determined on site (by Landscape Supervisor).

DESIGN LIABILITY NOTE: No liability is accepted by these plans. Contractors are required to check ALL construction facts, figures and relevant information pertaining to the soft and hard scape works to be performed. Should anomalies occur, the designer or a representative of Banksia Design Group must be contacted and given due notice and sufficient documentation and, if required, due compensation to allow for adjustment/s to plans, documentation etc

REMOVAL OF NOXIOUS WEEDS: As a duty of care exists for all contractors: if a noxious weed exists onsite it should be removed after discussion with the owner or site supervisor.

ENVIRONMENTAL MANAGEMENT AND SEDIMENT CONTROL: All Landscape works to adhere with Environmental Legislation outlined in the *Protection of the environment operations act* 1997, by the EPA NSW.

It is highly recommended to use Dial Before You Dig services – contact for information at www.dialbeforeyoudig.com.au or call 1100.

TREES: All trees to be staked: use 2 x hardwood 50x50mm stakes and hessian webbing. See detail

TURF: 1. Install turf rolls diagonal to the fall of the land. Roll turf following installation, and water as required. Use soft leaf Buffalo sp

2. 50 - 70mm topsoil underlay to be used in ground preparation .Note check ph after construction and before laying turf, adjust as required for optimum plant growth

#### SOIL:

- Contractor is to check soil pH levels, two weeks prior to planting, and allow for reasonable adjustments, using lime or similar to ensure plant viability
- 2. Break up existing ground surface using mattock, rotary hoe or tractor tine as required
- 3. Topsoil sandy loam 50mm depth to turf areas.
- 4. Where necessary mound soil to assist in soil drainage to avoid root rot and poor plant growth
- 5. Incorporate  $\frac{1}{2}$  tonne organic soil mix into holes where trees are planted, using recycled leaf litter as mulch
- 6. Soil Quality to be Australian Native Landscape Standard
- 7. Supply and Install 'Garden Mix' to all garden beds incorporated into the top 300mm of existing site profile. Note use rotary hoe as required do not just place on top of ground

<u>MULCH:</u> Mulch to be installed to all planter beds to a depth of 75mm. Mulch type to be Recycled Leaf Litter ideally from local tree company based on more native plants than general exotics.

<u>EDGING:</u> See plan for locations. Top edge higher than lawn to allow garden beds to be aerated & mounded

DRAINAGE: fall paving to lawn area

Install Everhard drainage pit to front of house. Liaise with Rawson Homes re connection to stormwater pipes

LIGHTING: to future plans TBA

MAINTENANCE: New plants to receive regular deep irrigation for a minimum 12 weeks establishment period. Seasonal pruning, fertilising and pest and disease checks to be carried out. Advice by qualified horticulturalist recommended

IRRIGATION: Drip irrigation TBA

Landscape plan Specification 18 Clyde road Dee Why Issue: A Issue: B

**\** 

 Landscape
 DA Plan

 Drawing: AD/TT
 Checked by: AD

 Andrew Davies
 Job:r03.200205

 Date 8.2.20
 Issue: B

 Scale:NTSC



andrew davies.

L ANDSCAPE DESIGN