

PROPOSED RESIDENTIAL DEVELOPMENT 14 OCEAN ROAD PALM BEACH PRELIMINARY ISSUE

CIVIL SERVICES

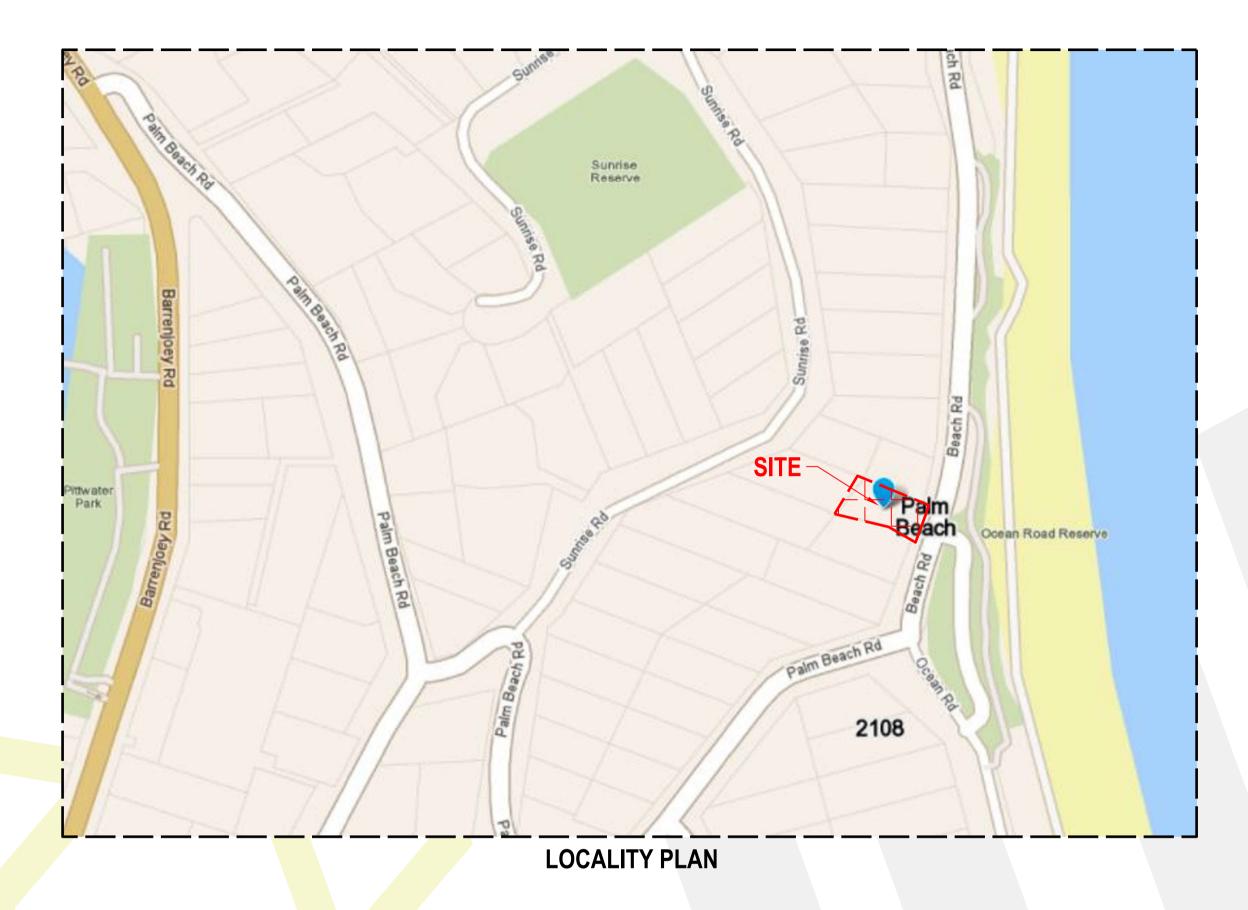

| DRAWING SCHEDULE | | | | | |
|-------------------|---|---------------|--|--|--|
| DRAWING NUMBER | DRAWING TITLE | DRAWING SCALE | | | |
| C-0000 | Cover Sheet | N.T.S | | | |
| C-0001 | General Notes And Legend | N.T.S | | | |
| | | | | | |
| C-1001 | Erosion and Sediment Control Plan | 1:100 | | | |
| C-1011 | Erosion and Sediment Control Detail and Notes | As Noted | | | |
| | | | | | |
| C-4001 | Stormwater Management Plan | 1:100 | | | |
| C-4101 | Stormwater Catchment Plan | 1:100 | | | |
| C-4301 | Stormwater Management Detail Sheet 1 of 2 | As Noted | | | |
| C-4302 | Stormwater Management Detail Sheet 2 of 2 | As Noted | | | |



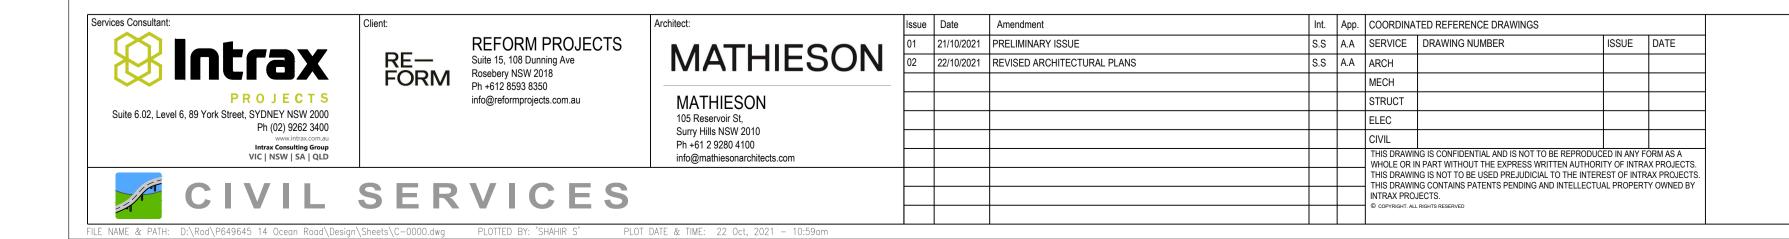

Project:
PROPOSED RESIDENTIAL DEVELOPMENT
14 OCEAN ROAD
PALM BEACH

Drawing Title:
COVER SHEET

North Point:

Job No: P649645

(A1) N.T.S

NOTE: SYMBOLS ARE DRAWN IN THE CORRECT POSITION BUT ARE NOT SHOWN TO SCALE.

NOTE: SYMBOLS ARE DRAWN IN THE CORRECT POSITION BUT ARE NOT SHOWN TO SCALE.

GENERAL NOTES

REFER TO NORTHERN BEACHES COUNCIL DEVELOPMENT GUIDELINES FOR STANDARD DETAILS AND ENGINEERING SPECIFICATION.

- ALL WORKS TO BE UNDERTAKEN IN ACCORDANCE WITH THIS CODE UNO. N1. ALL DIMENSIONS ARE IN MILLIMETRES AND ALL LEVELS IN m AHD UNO.
- N2. NO DIMENSIONS ARE TO BE OBTAINED BY SCALING FROM DRAWINGS.
- N3. THESE DRAWINGS SHALL BE READ IN CONJUNCTION WITH ALL OTHER CONSULTANT'S DRAWINGS AND SPECIFICATIONS.
- N4. IN PREPARING THESE DRAWINGS WE HAVE RELIED ON THE ACCURACY AND COMPLETENESS OF INFORMATION PROVIDED BY THE UTILITY PROVIDERS AND SURVEYORS REGARDING ONSITE LOCATION OF ASSETS. WE ACCEPT NO LIABILITY FOR ANY ERROR OR OMISSION IN THESE DRAWINGS TO THE EXTENT THE SAME RESULTS FROM ERROR OR OMISSION IN THE INFORMATION PROVIDED.
- N5. ANY DISCREPANCIES OR OMISSIONS SHALL BE BROUGHT TO THE ATTENTION OF THE SUPERINTENDENT PRIOR TO PROCEEDING WITH THE WORKS.
- N6. THE CONTRACTOR SHALL OBTAIN ALL LEVELS FROM ESTABLISHED BENCH MARKS ONLY AS SUPPLIED BY A REGISTERED
- N7. THE CONTRACTOR MUST VERIFY ALL DIMENSIONS, EXISTING LEVELS AND PROPOSED SET-OUT ON SITE PRIOR TO THE
- COMMENCEMENT OF WORKS. ANY DISCREPANCIES OR OMISSIONS ARE TO BE REPORTED TO THE SUPERINTENDENT. N8. THE SUPERINTENDENT IS TO BE GIVEN 48 HOURS NOTICE OF ANY INSPECTION REQUESTS.
- N9. ALL EXISTING STRUCTURES, SERVICES AND UTILITIES ARE TO BE LOCATED BY THE CONTRACTOR PRIOR TO COMMENCEMENT OF WORKS. THE LOCATION OF EXISTING SERVICES SHOWN ON PLANS ARE INDICATIVE ONLY AND ARE NOT GUARANTEED TO BE COMPLETE OR CORRECT. THE RESPONSIBILITY FOR LOCATING, AVOIDANCE AND WHERE NECESSARY, TEMPORARY
- PROTECTION OF THESE EXISTING SERVICES IS THAT OF THE CONTRACTOR. ANY DAMAGE TO EXISTING STRUCTURES, SERVICES AND UTILITIES IS TO BE REPORTED TO THE SUPERINTENDENT IMMEDIATELY.
- N10. ALL MATERIALS AND WORKMANSHIP SHALL BE IN ACCORDANCE WITH AUSTRALIAN STANDARDS AND CODES OF PRACTICE EXCEPT WHERE VARIED BY THE DRAWINGS. THE APPLICABLE STANDARDS SHALL BE THE REFERENCED STANDARDS CURRENT AT DATE OF DRAWING ISSUE.
- N11. WHERE NOTED ON THE DRAWINGS THAT WORKS ARE TO BE CARRIED OUT BY OTHERS, (e.g. ADJUSTMENT OF SERVICES) THE CONTRACTOR SHALL BE RESPONSIBLE FOR THE CO-ORDINATION OF ANY THIRD PARTY WORKS.
- N12. THE CONTRACTOR SHALL BE RESPONSIBLE FOR MAINTAINING THE STABILITY OF THE WORKS AND SURROUNDING AREA UNTIL
- PROJECT COMPLETION AND SHALL ENSURE THAT NO PART OF THE WORKS ARE OVERSTRESSED BY CONSTRUCTION LOADING. N13. ALL TESTING IS TO BE CARRIED OUT BY A NATA REGISTERED LABORATORY. TESTING METHODS ARE TO BE IN ACCORDANCE WITH THE APPLICABLE AUSTRALIAN STANDARD.
- N14. ON COMPLETION OF THE WORKS THE CONTRACTOR SHALL PROVIDE AN AS-CONSTRUCTED SURVEY OF THE SITE. N15. WHERE PROPRIETARY PRODUCTS ARE SPECIFIED ON THE DRAWING, THE CONTRACTOR MAY PROPOSE AN ALTERNATIVE
- PRODUCT TO THE SUPERINTENDENT FOR APPROVAL. THE CONTRACTOR SHALL PROVIDE SUFFICIENT INFORMATION TO DEMONSTRATE TO THE SUPERINTENDENT'S SATISFACTION THAT THE ALTERNATIVE PROPOSED IS OF EQUIVALENT QUALITY TO THE PRODUCT SPECIFIED.
- N16. EXISTING SERVICES SURVEY AND TOPOGRAPGY SURVEY ARE SHOWN AS PER SITE SURVEY COMPLETED BY C.M.S SURVEYORS PTY LTD (20223DETAIL DATED 15 APRIL 2021) . LOCATIONS ARE INDICATIVE ONLY AND MAY NOT BE EXHAUSTIVE. PRESENCE AND LOCATIONS OF SERVICES TO BE CONFIRMED BY CONTRACTOR PRIOR TO CONSTRUCTION.

ROADWORKS GENERAL

- G1. THE SUB-CONTRACTOR SHALL OBTAIN ALL LEVELS FROM ESTABLISHED BENCH MARKS ONLY AS SUPPLIED BY THE APPOINTED
- SURVEYOURS. G2. SERVICES SHOWN ON THESE PLANS ARE LOCATED FROM INFORMATION SUPPLIED BY THE RELEVANT AUTHORITIES AND FIELD INVESTIGATIONS AND ARE NOT GUARANTEED COMPLETE OR CORRECT. ALL SERVICE LOCATIONS ARE TO BE VERIFIED BY THE SUB-CONTRACTOR PROIR TO CONSTRUCTION.
- G3. ALL REMOVING, DIVERSION AND PROTECTION WORKS RELATED TO EXISTING SERVICES NEED TO BE VERIFIED AND APPROVED BY RELATIVE AUTHORITIES.
- G4. NO WORK TO BE CARRIED OUT ON ADJOINING PROPERTIES WITHOUT THE WRITTEN PERMISSION FROM THE OWNER.
- G5. VEHICULAR ACCESS AND ALL SERVICES ARE TO BE MAINTAINED AT ALL TIMES TO AREAS AFFECTED BY CONSTRUCTION UNLESS

PAVEMENT GENERAL

- P1. SUBGRADE, SUBBASE AND BASE COURSES ARE TO BE COMPACTED TO THE REQUIREMENTS OF THE SPECIFICATION AND SHALL BE REVIEWED BY THE GEOTECHNICAL INSPECTION AND TESTING AUTHORITY.
- P2. TRANSITION KERB FROM KO TO K&G AT KERB RETURN T.P OVER A LENGTH OF 1m.
- P3. ALL EXISTING STRUCTURES, SERVICES AND UTILITIES ARE TO BE LOCATED BY THE SUB-CONTRATOR PRIOR TO COMMENCEMENT OF WORKS. THE LOCATION OF EXISTING SERVICES SHOWN ON PLANS ARE INDICATIVE ONLY AND ARE NOT GUARENTEED TO BE COMPLETE OR CORRECT. THE RESPONSIBILITY FOR LOCATING, AVOIDANCE AND WHERE NECESSARY, TEMPORARY PROTECTION OF THESE EXISTING SERVICES IS THAT OF THE SUB-CONTRACTOR. ANY DAMAGE TO EXISTING STRUCTURES, SERVICES AND UTILITIES IS TO BE REPORTED TO THE SUPERINTENDENT IMMEDIATELY.

DRAINAGE NOTES

- D1. ALL PIPES TO BE LAID ON 75mm SAND BED WITH THE BARRELS FULLY SUPPORTED.
- D2. 100mm AND 150mm DIAMTER PIPES TO BE LAID ON MINIMUM 1% GRADE.
- D3. MINIMUM DEPTH OF COVER FOR PIPES NOT SUBJECT TO VEHICULAR LOADING TO BE 300mm. D4. ALL DRAINAGE PIPES LAID UNDER PAVEMENT SHALL BE REINFORCED CONCRETE WITH RUBBER RING JOINTS.
- D5. BACKFILL TRENCHES WITH COMPACTED SAND OR APPROVED AGGREGATE MATERIAL.
- D6. HEAVY DUTY GRATES AND COVERS ARE TO BE PROVIDED IN TRAFFICABLE AREAS.
- D7. PIT GRATE TO BE TYPE WELDOCK OR APPROVED EQUIVALENT.
- D8. ALL PITS SHALL BE PROVIDED WITH LOCKING CLIP. D9. ALL PITS SHALL BE MAINTAINED REGULARILY.
- D10. TOP OF BENCHING SHALL BE TO THE HALF OF THE OUTLET PIPE DIAMETER.
- D11. Ø100mm SUBSOIL DRAINAGE PIPE 3000mm LONG WRAPPED IN FABRIC SOCK TO BE PROVIDED ADJACENT TO INLET PIPES.
- D12. COMPRESSIVE STRENGTH fc FOR CAST INSITU CONCRETE TO BE MINIMUM OF 20MPa AT 28 DAYS.
- D13. PROVIDE CLEANING EYES TO ALL DOWNPIPES NOT DIRECTLY CONNECTED TO PITS. D14. ISOLATED JOINTS TO BE PROVIDED TO ISOLATE CONCRETE PAVEMENTS FROM PITS.
- D15. ALL TRENCH GRATES PROVIDED SHALL HAVE A MINIMUM CLEAR WIDTH OF 200mm.
- D16. STORMWATER DRAINAGE CONNECTIONS TO THE MAIN SYSTEM SHALL BE TO THE REQUIREMENTS AND THE SATISFACTION OF LOCAL COUNCIL.

DEMOLITION

- 1. ALL DEMOLITION WORK IS TO BE UNDERTKEN IN ACCORDANCE WITH REQUIREMENTS OF AUSTRALIAN STANDARDS AS2601 1991 - "THE DEMOLITION OF STRUCTURES".
- 2. HAZARDOUS MATERIALS (INCLUDING ASBESTOS) ARE TO BE HANDLED, STORED, TREATED, TRANSPORTED AND DISPOSED OF IN ACCORDANCE WITH THE REQUIRMENTS OF THE WORK HEALTH & SAFETY ACT 2011 AND ANY RELEVANT REQUIREMENTS OF THE WORK COVER AUTHORITY OF NSW.

LEGEND

EXISTING FEATURES

Int. App. COORDINATED REFERENCE DRAWINGS

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THIS DRAWING CONTAINS PATENTS PENDING AND INTELLECTUAL PROPERTY OWNED BY

ISSUE DATE

S.S A.A SERVICE DRAWING NUMBER

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STRUCT


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Amendment


22/10/2021 REVISED ARCHITECTURAL PLANS

21/10/2021 PRELIMINARY ISSUE



LEGEND

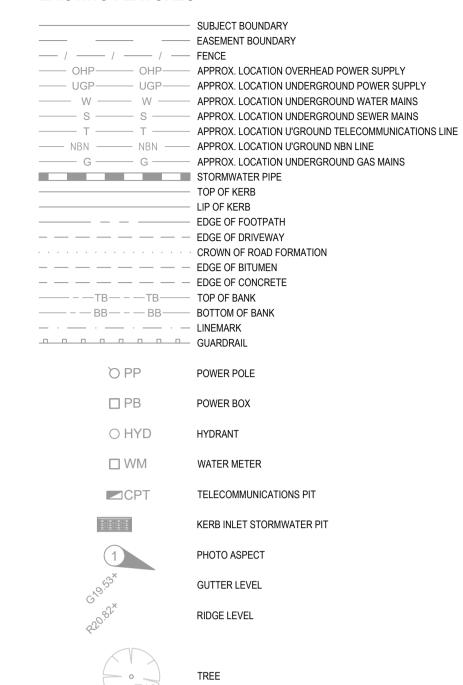PROPOSED FEATURES

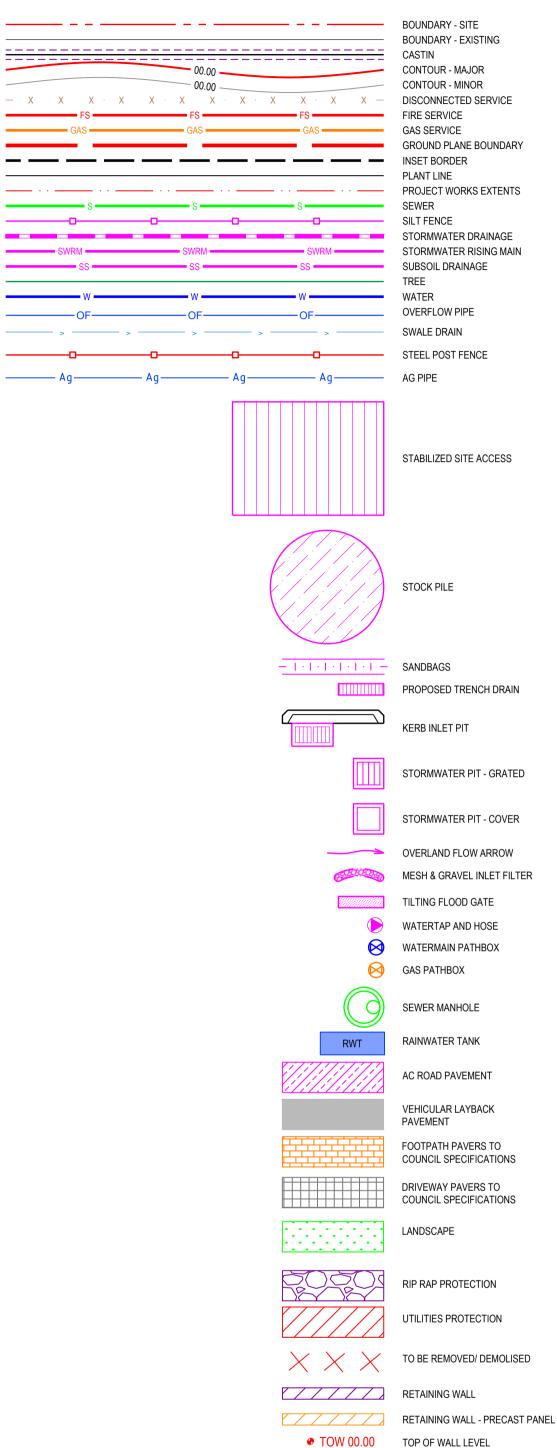

PRELIMINARY ISSUE

NOTE: THIS IS A STANDARD LEGEND. ALL SYMBOLS MAY NOT NECESSARILY BE USED IN THESE DRAWINGS.

₱ RL 00.00 PROPOSED GROUND LEVEL

SL 00.00 SURFACE LEVEL

____ CJ ... _ CONSTRUCTION JOINT ____SCJ___ SAW-CUT JOINT

OVERLAND FLOW PATH

FINISHED FLOOR LEVEL

PAVEMENT LEVEL

DOWNPIPES

ISOLATION JOINT

FFL 00.00


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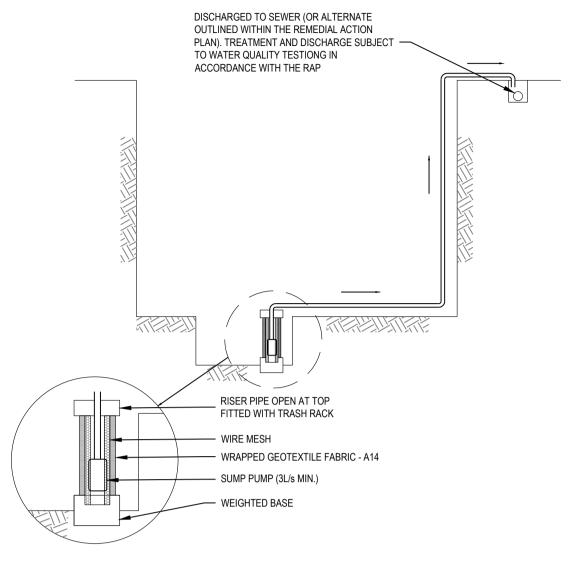
DP (i)

North Point: GENERAL NOTES & LEGEND PROPOSED RESIDENTIAL DEVELOPMENT 14 OCEAN ROAD PALM BEACH Scale: N.T.S ^{Job No:} P649645 NOTE: SYMBOLS ARE DRAWN IN THE CORRECT POSITION BUT ARE NOT C0001 SHOWN TO SCALE.




NAME & PATH: D:\Rod\P649645 14 Ocean Road\Design\Sheets\C-0001.dwg PLOTTED BY: 'SHAHIR S' PLOT DATE & TIME: 22 Oct, 2021 - 10:59am



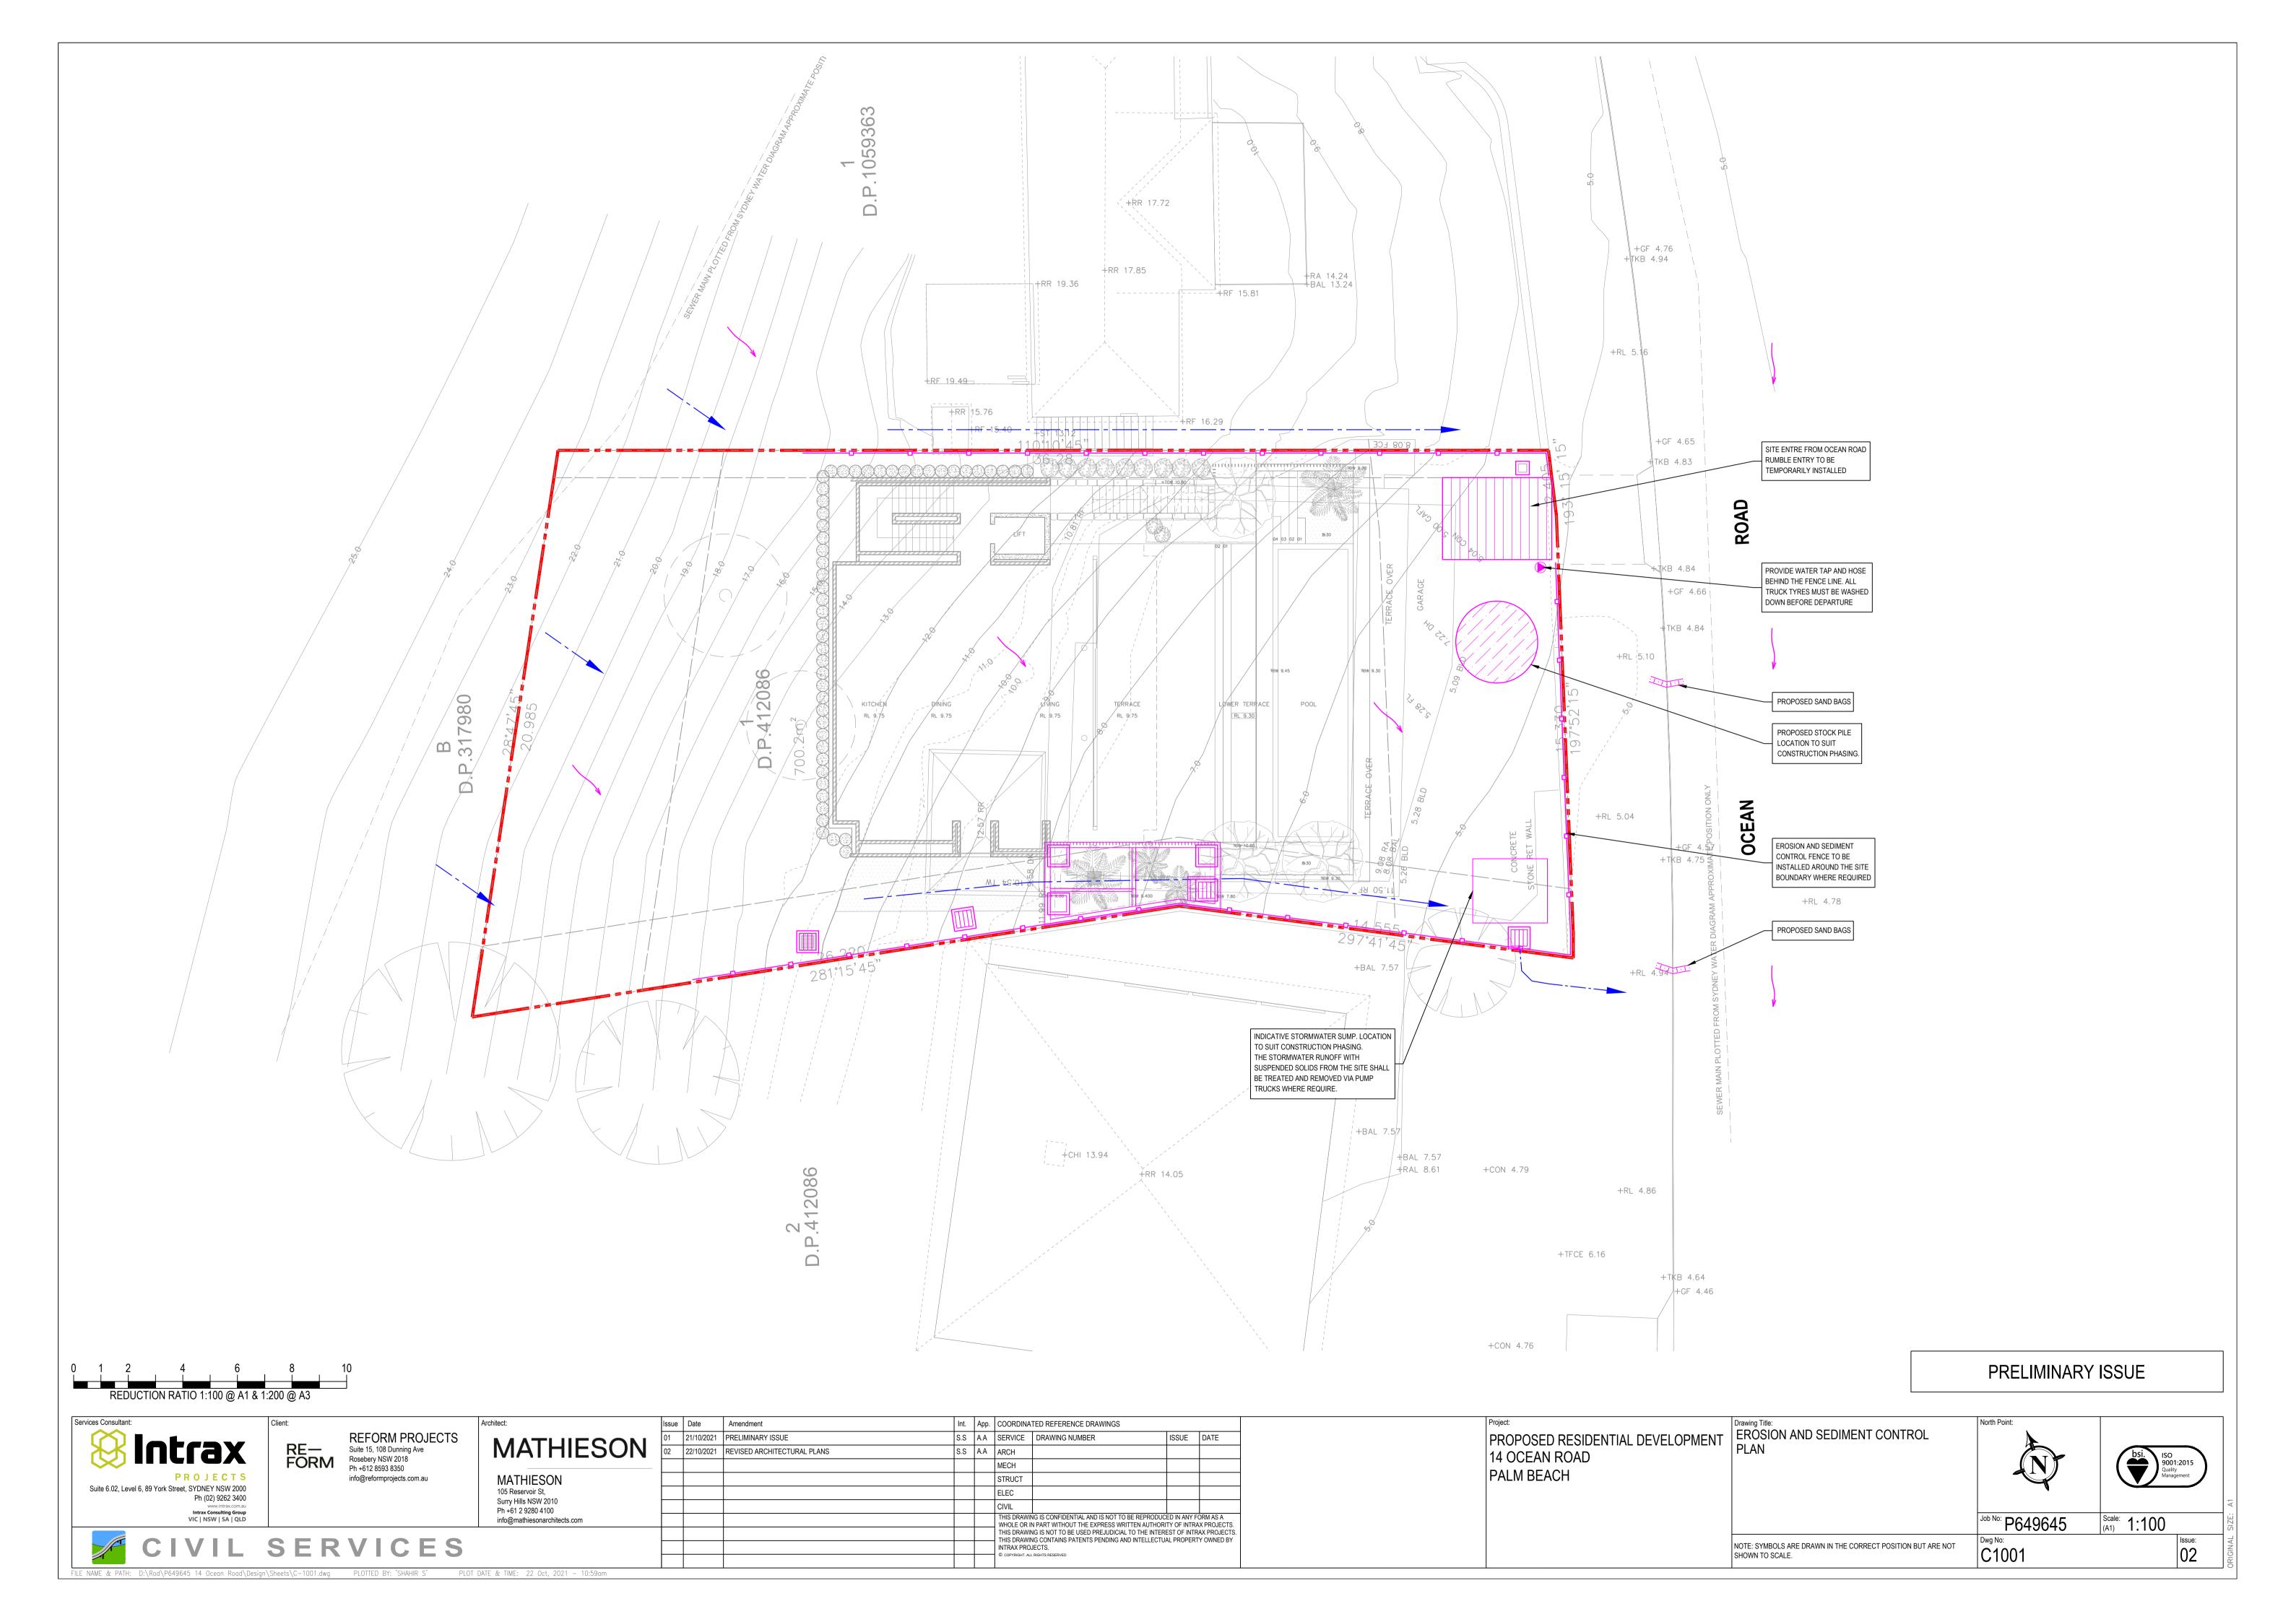



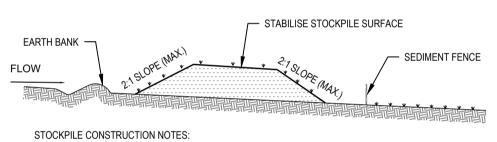


1. PLACE STOCKPILES MORE THAN 2 (PREFERABLY 5) METRES FROM EXISTING VEGETATION, CONCENTRATED WATER FLOW, ROADS AND HAZARD AREAS. 2. CONSTRUCT ON THE CONTOUR AS LOW, FLAT, ELONGATED MOUNDS. . WHERE THERE IS SUFFICIENT AREA, TOPSOIL STOCKPILES SHALL BE LESS THAN 2 METRES IN HEIGH 4. WHERE THEY ARE TO BE PLACED FOR MORE THAN 10 DAYS, STABILISE FOLLOWING THE APPROVED E.S.C.P. OR S.W.M.P. TO REDUCE THE C-FACTOR TO LESS THAN 0.10.


5. CONSTRUCT EARTH BANKS ON THE UPSLOPE SIDE TO DIVERT WATER AROUND STOCKPILES AND


SCALE N.T.S.

STOCKPILES

SEDIMENT FENCES 1 TO 2 METRES DOWNSLOPE.

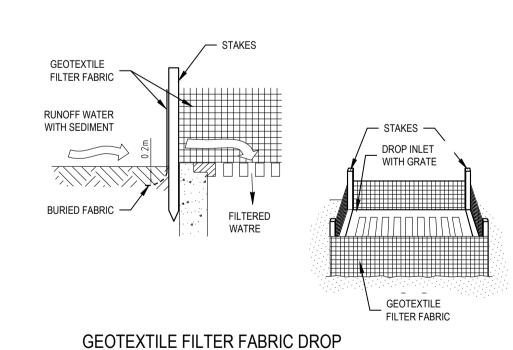

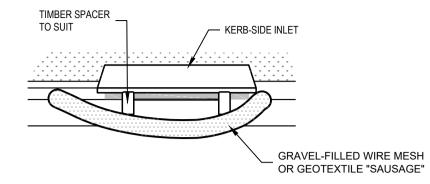

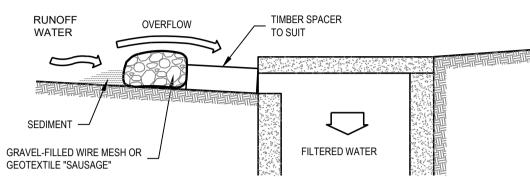


MESH & GRAVEL INLET FILTER CONSTRUCTION NOTES: FABRICATE A SLEEVE MADE FROM GEOTEXTILE OR WIRE MESH LONGER THAN THE LENGTH OF THE


- INLET PIT AND FILL IT WITH 25mm TO 50mm GRAVEL. FORM AN ELLIPTICAL CROSS-SECTION ABOUT 150mm HIGH x 400mm WIDE.
- PLACE THE FILTER AT THE OPENING LEAVING AT LEAST A 100mm SPACE BETWEEN IT AND THE KERB
- INLET. MAINTAIN THE OPENING WITH SPACER BLOCKS.
- FORM A SEAL WITH THE KERB TO PREVENT SEDIMENT BYPASSING THE FILTER. SANDBAGS FILLED WITH GRAVEL CAN SUBSTITUTE FOR THE MESH OR GEOTEXTILE PROVIDING THEY ARE PLACED SO THAT THEY CAN FIRMLY ABUT EACH OTHER AND SEDIMENT / LADEN WATERS CANNOT PASS BETWEEN.

MESH & GRAVEL INLET FILTER


SCALE N.T.S.

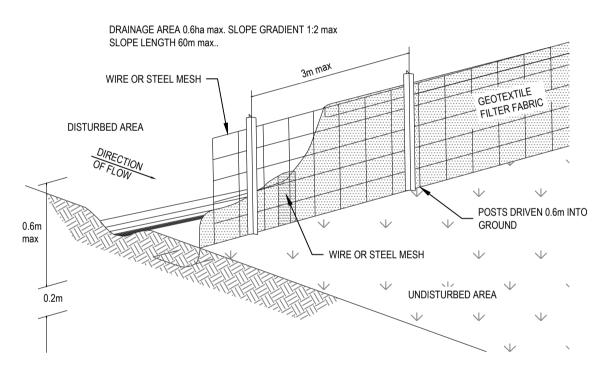

SEDIMENT FENCE SCALE N.T.S.

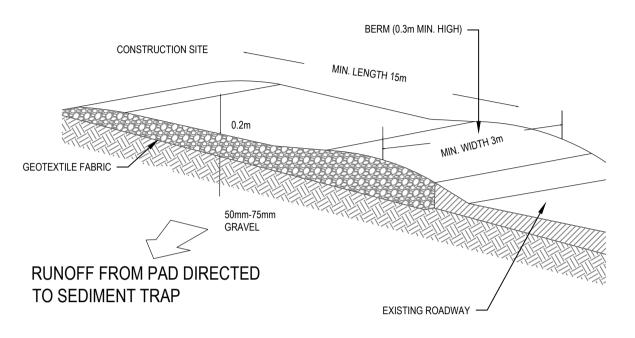

TEMPORARY CONSTRUCTION EXIT SCALE N.T.S.

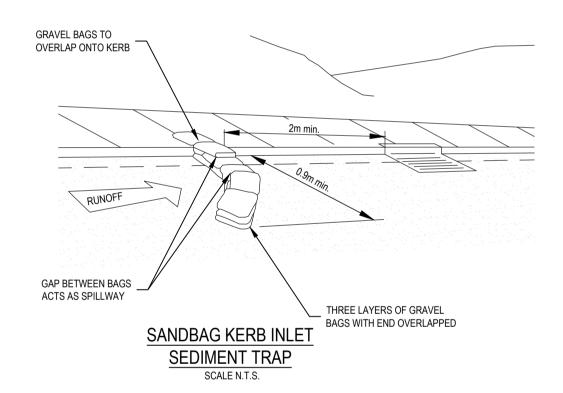

1. FOR GENERAL NOTES AND LEGEND, REFER TO DRAWING NO C-0001. 2. REFER TO DRAWING C-1001 FOR EROSION & SEDIMENT CONTROL PLAN

EROSION AND SEDIMENT CONTROL

- 1. THE EROSION AND SEDIMENT CONTROL PLAN ADDRESSES THE MANAGEMENT OF ON SITE STORMWATER RUNOFF DURING CONSTRUCTION. IT DOES NOT ADDRESS BASEMENT EXCAVATION, GROUND WATER MANAGEMENT/ DEWATERING REQUIREMENTS. IT IS TO BE READ IN CONJUNCTION WITH ALL OTHER GEOTECHNICAL, RAP, ENVIRONMENTAL AND STRUCTURAL DOCUMENTATION.
- 2. THE PLAN IS CONCEPT ONLY. SITE CONDITIONS AND PHASING OF WORKS ARE LIKELY TO INFLUENCE CONTROL MEASURES. THE CONTRACTOR SHALL BE RESPONSIBLE FOR AMENDING THE SCHEME TO SUIT CONDITIONS AT THE TIME OF WORKS AND CONSTRUCTION PROGRAM.
- 3. THE CONTRACTOR IS TO INFORM ALL BUILDERS AND SUBCONTRACTORS OF THEIR RESPONSIBILITIES IN MINIMISING THE POTENTIAL FOR SOIL EROSION AND POLLUTION TO ROADWAYS AND WATERWAYS. 4. THE CONTRACTOR IS TO IMPLEMENT AN APPROPRIATE ENVIRONMENTAL MANAGEMENT PLAN INCLUDING SPILL/ POLLUTION CONTAINMENT AND TREATMENT PROCEDURES. THE CONTRACTOR IS TO
- ENSURE THAT ANY SPILL/POLLUTION COLLECTED IN THE STORMWATER SUMP IS IMMEDIATELY 5. WATER SHALL BE PREVENTED FROM ENTERING THE PERMANENT DRAINAGE SYSTEM UNLESS IT IS
- RELATIVELY SEDIMENT FREE, i.e. THE CATCHMENT AREA HAS BEEN PERMANENTLY LANDSCAPED
- AND/OR ANY LIKELY SEDIMENT HAS BEEN FILTERED THROUGH AN APPROVED STRUCTURE. 6. ALL SOIL AND WATER CONTROL MEASURES ARE TO BE PROVIDED IN ACCORDANCE WITH THE
- GUIDELINES FOR EROSION AND SEDIMENT CONTROL ON NORTHERN BEACHES COUNCIL WATER
- MANAGEMENT FOR DEVELOPMENT POLICY, LANDCOM SOIL AND CONSTRUCTION MANUAL VOLUME 1, MARCH 2004. ('BLUE BOOK') AND THE NSW PROTECTION OF THE ENVIRONMENT OPERATIONS ACT 1997. 7. STOCKPILE LOCATIONS TO BE DEPENDENT ON THE LOAD OUT LOCATION AND THE POINT OF
- EXCAVATION. STOCKPILE LOCATIONS TO BE MARKED ON THE SITE PLAN AT THE SITE OFFICE AS THE PROJECT PROGRESSES.
- 8. SHOULD ANY MATERIAL BE WASHED FROM EQUIPMENT, SUCH AS CONCRETE SLURRIES FROM
- CONCRETE TRUCKS, A WASHING/CLEANING AREA WITH APPROPRIATE SEDIMENT CONTROL MEASURES
- IS TO BE SETUP ON A FLAT AREA OF THE SITE. 9. THE CONTRACTOR SHALL MAINTAIN A LOG BOOK DETAILING:
- RECORDS OF ALL RAINFALL (I.E. DAILY RAINFALL) • CONDITION OF SOIL AND WATER MANAGEMENT CONTROL MEASURES ANY ADDITIONAL REMEDIAL
- THE LOG BOOK SHALL BE MAINTAINED ON A WEEKLY BASIS AND BE MADE AVAILABLE TO ANY AUTHORISED PERSON UPON REQUEST. THE ORIGINAL LOG BOOK SHALL BE ISSUED TO THE PROJECT
- MANAGER AT THE COMPLETION OF THE WORKS. 10. DUST CONTROL MEASURES SHALL BE IMPLEMENTED CONTINUOUSLY DURING CONSTRUCTION WORKS
- TO THE SATISFACTION OF THE SUPERINTENDENT. 11. CONTROL MEASURES AFFECTED BY WORKS ARE TO BE RE-ESTABLISHED PRIOR TO THE COMPLETION OF EACH DAYS WORK.
- 12. ALL CONTROL MEASURES ARE TO BE CLEANED AND MAINTAINED AT LEAST WEEKLY OR AFTER EVERY RAINFALL EVENT.
- 13. FOLLOWING THE COMPLETION AND RESTORATION OF SITE, THE CONTRACTOR IS TO REMOVE ALL
- 14. PERMANENT DRAINAGE STRUCTURES INCLUDING PIPES AND PITS ARE TO BE HANDED OVER IN A CLEAN CONDITION AT THE COMPLETION OF THE CONTRACT MAINTENANCE PERIOD.
- 15. TEMPORARY STORMWATER SUMPS (LOCATIONS TO SUIT SITE PHASING).
- DISCHARGE PUMP NOM. FLOW RATE = 3 l/s
- RUNOFF COEFFICIENT = 1.00. • SIZING OF SUMPS BASED ON STORAGE REQUIRED FOR A 3 MONTH ARI STORM EVENT UP TO 12
- HOURS IN DURATION INTENSITIES FROM AUSTRALIAN BUREAU OF METEROLOGY IFD DATA SYSTEM. 16. PRIOR TO DISCHARGING COLLECTED WATER TO INCLUDING THOSE IDENTIFIED IN THE RAP, IT IS TO BE TESTED TO ENSURE COMPLIANCE WITH WATER QUALITY REQUIREMENTS. SHOULD TESTING GIVE
- RESULTS THAT DO NOT COMPLY WITH THE ABOVE, TREATMENT MEASURES (SUCH AS THE APPLICATION OF A pH NEUTRAL FLOCCULANT) AND SUBSEQUENT RETESTING ARE REQUIRED. DOCUMENTARY RESULTS OF WATER QUALITY TESTING PRIOR TO DEWATERING ARE TO BE KEPT. A FILE IS TO BE KEPT ONSITE OF ALL WATER TESTING/DEWATERING EVENTS. FOLLOWING DEWATERING THE SUMP IS TO BE
- CLEARED OF SEDIMENT AND THE GEOTEXTILE ON THE PUMP WELL IS TO BE REPLACED. 17. ALL STORMWATER PITS TO BE COVERED OR DROP INLET SEDIMENT TRAPS SHALL BE PROVIDED. KERB
- INLET TRAPS ARE TO BE INSTALLED AFTER COMPLETION OF PAVING. 18. ALL SERVICE TRENCHES MUST BE FILLED IN AND COMPACTED IMMEDIATELY AFTER SERVICES HAVE
- BEEN LAID. 19. ROADS AND FOOTPATHS AFFECTED BY THE WORKS MUST BE SWEPT CLEAN DAILY. SOILS MUST BE
- RETAINED BEHIND CONTROL DEVICES. 20. CONTRACTOR MUST ENSURE THAT ALL VEHICLES LEAVING SITE ARE HOSED DOWN (OR SIMILAR) TO
- REMOVE SEDIMENT. 21. CONTRACTOR SHALL PROVIDE SEDIMENT FENCING MATERIAL DURING CONSTRUCTION TO THE LOW SIDE OF THE WORKS, TIE SEDIMENT FENCING MATERIAL TO CYCLONE WIRE SECURITY FENCE.
- SEDIMENT CONTROL FABRIC SHALL BE AN APPROVED MATERIAL (EG. HUMES PROPEX SILT STOP) STANDING 300mm ABOVE GROUND & EXTENDING 150mm BELOW GROUND. 22. EXISTING DRAINS LOCATED WITHIN THE SITE SHALL ALSO BE ISOLATED BY SEDIMENT FENCING
- 23. NO PARKING OR STOCKPILING OF MATERIALS IS PERMITTED ON THE LOWER SIDE OF THE SEDIMENT
- FENCE. 24. GRASS VERGES SHALL BE MAINTAINED AS MUCH AS PRACTICAL TO PROVIDE A BUFFER ZONE TO THE
- CONSTRUCTION SITE. 25. CONSTRUCTION ENTRY/EXIT SHALL BE VIA THE LOCATION NOTED ON THE DRAWING. CONTRACTOR
- SHALL ENSURE ALL DROPABLE SOIL & SEDIMENT IS REMOVED PRIOR TO CONSTRUCTION TRAFFIC EXISTING SITE. CONTRACTOR SHALL ENSURE ALL CONSTRUCTION TRAFFIC ENTERING & LEAVING THE SITE DO SO IN A FORWARD DIRECTION.
- 26. WATER TO BE DISCHARGED MUST BE TESTED AND, IF REQUIRED, TREATED TO ENSURE IT MEETS THE WATER QUALITY CRITERIA AND THAT POLLUTION OF THE RECEIVING WATERS DOES NOT OCCUR. BEFORE WATER CAN BE DISCHARGED TO THE RECEIVING ENVIRONMENT, THE FOLLOWING CRITERIA MUST BE MET, UNLESS SUBJECT TO AN ENVIRONMENTAL PROTECTION LICENCE OR SITE-SPECIFIC CRITERIA. TEMPORARY DEWATERING IN AN AQUIFER REQUIRES THE APPROVAL OF THE NATURAL RESOURCES ACCESS REGULATOR.

| PARAMETER | CRITERION | METHOD | TIME PRIOR TO DISCHARGE |
|------------------------|------------|-------------------|----------------------------|
| OIL AND GREASE | NO VISIBLE | VISUAL INSPECTION | <1 HOUR |
| pН | 6.5 - 8.5 | PROBE/METER | <1 HOUR |
| TOTAL SUSPENDED SOLIDS | <50 mg/L | METER/GRAB SAMPLE | <1 HOUR |

PRELIMINARY ISSUE



REFORM PROJECTS Suite 15, 108 Dunning Ave Rosebery NSW 2018 Ph +612 8593 8350 info@reformprojects.com.au

INLET SEDIMENT TRAP

Amendment **MATHIESON** MATHIESON 105 Reservoir St, Surry Hills NSW 2010 Ph +61 2 9280 4100 info@mathiesonarchitects.com

21/10/2021 PRELIMINARY ISSUE S.S A.A SERVICE DRAWING NUMBER ISSUE DATE 22/10/2021 REVISED ARCHITECTURAL PLANS S.S A.A ARCH MECH STRUCT ELEC CIVIL THIS DRAWING IS CONFIDENTIAL AND IS NOT TO BE REPRODUCED IN ANY FORM AS A WHOLE OR IN PART WITHOUT THE EXPRESS WRITTEN AUTHORITY OF INTRAX PROJECTS.

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PROPOSED RESIDENTIAL DEVELOPMENT 14 OCEAN ROAD PALM BEACH


North Point: EROSION AND SEDIMENT CONTROL **DETAIL & NOTES**

NOTE: SYMBOLS ARE DRAWN IN THE CORRECT POSITION BUT ARE NOT


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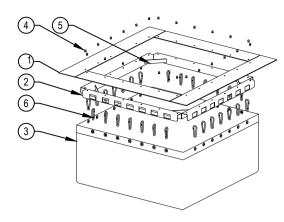
^{Job No:} P649645 Scale: AS NOTED C1011

SERVICES



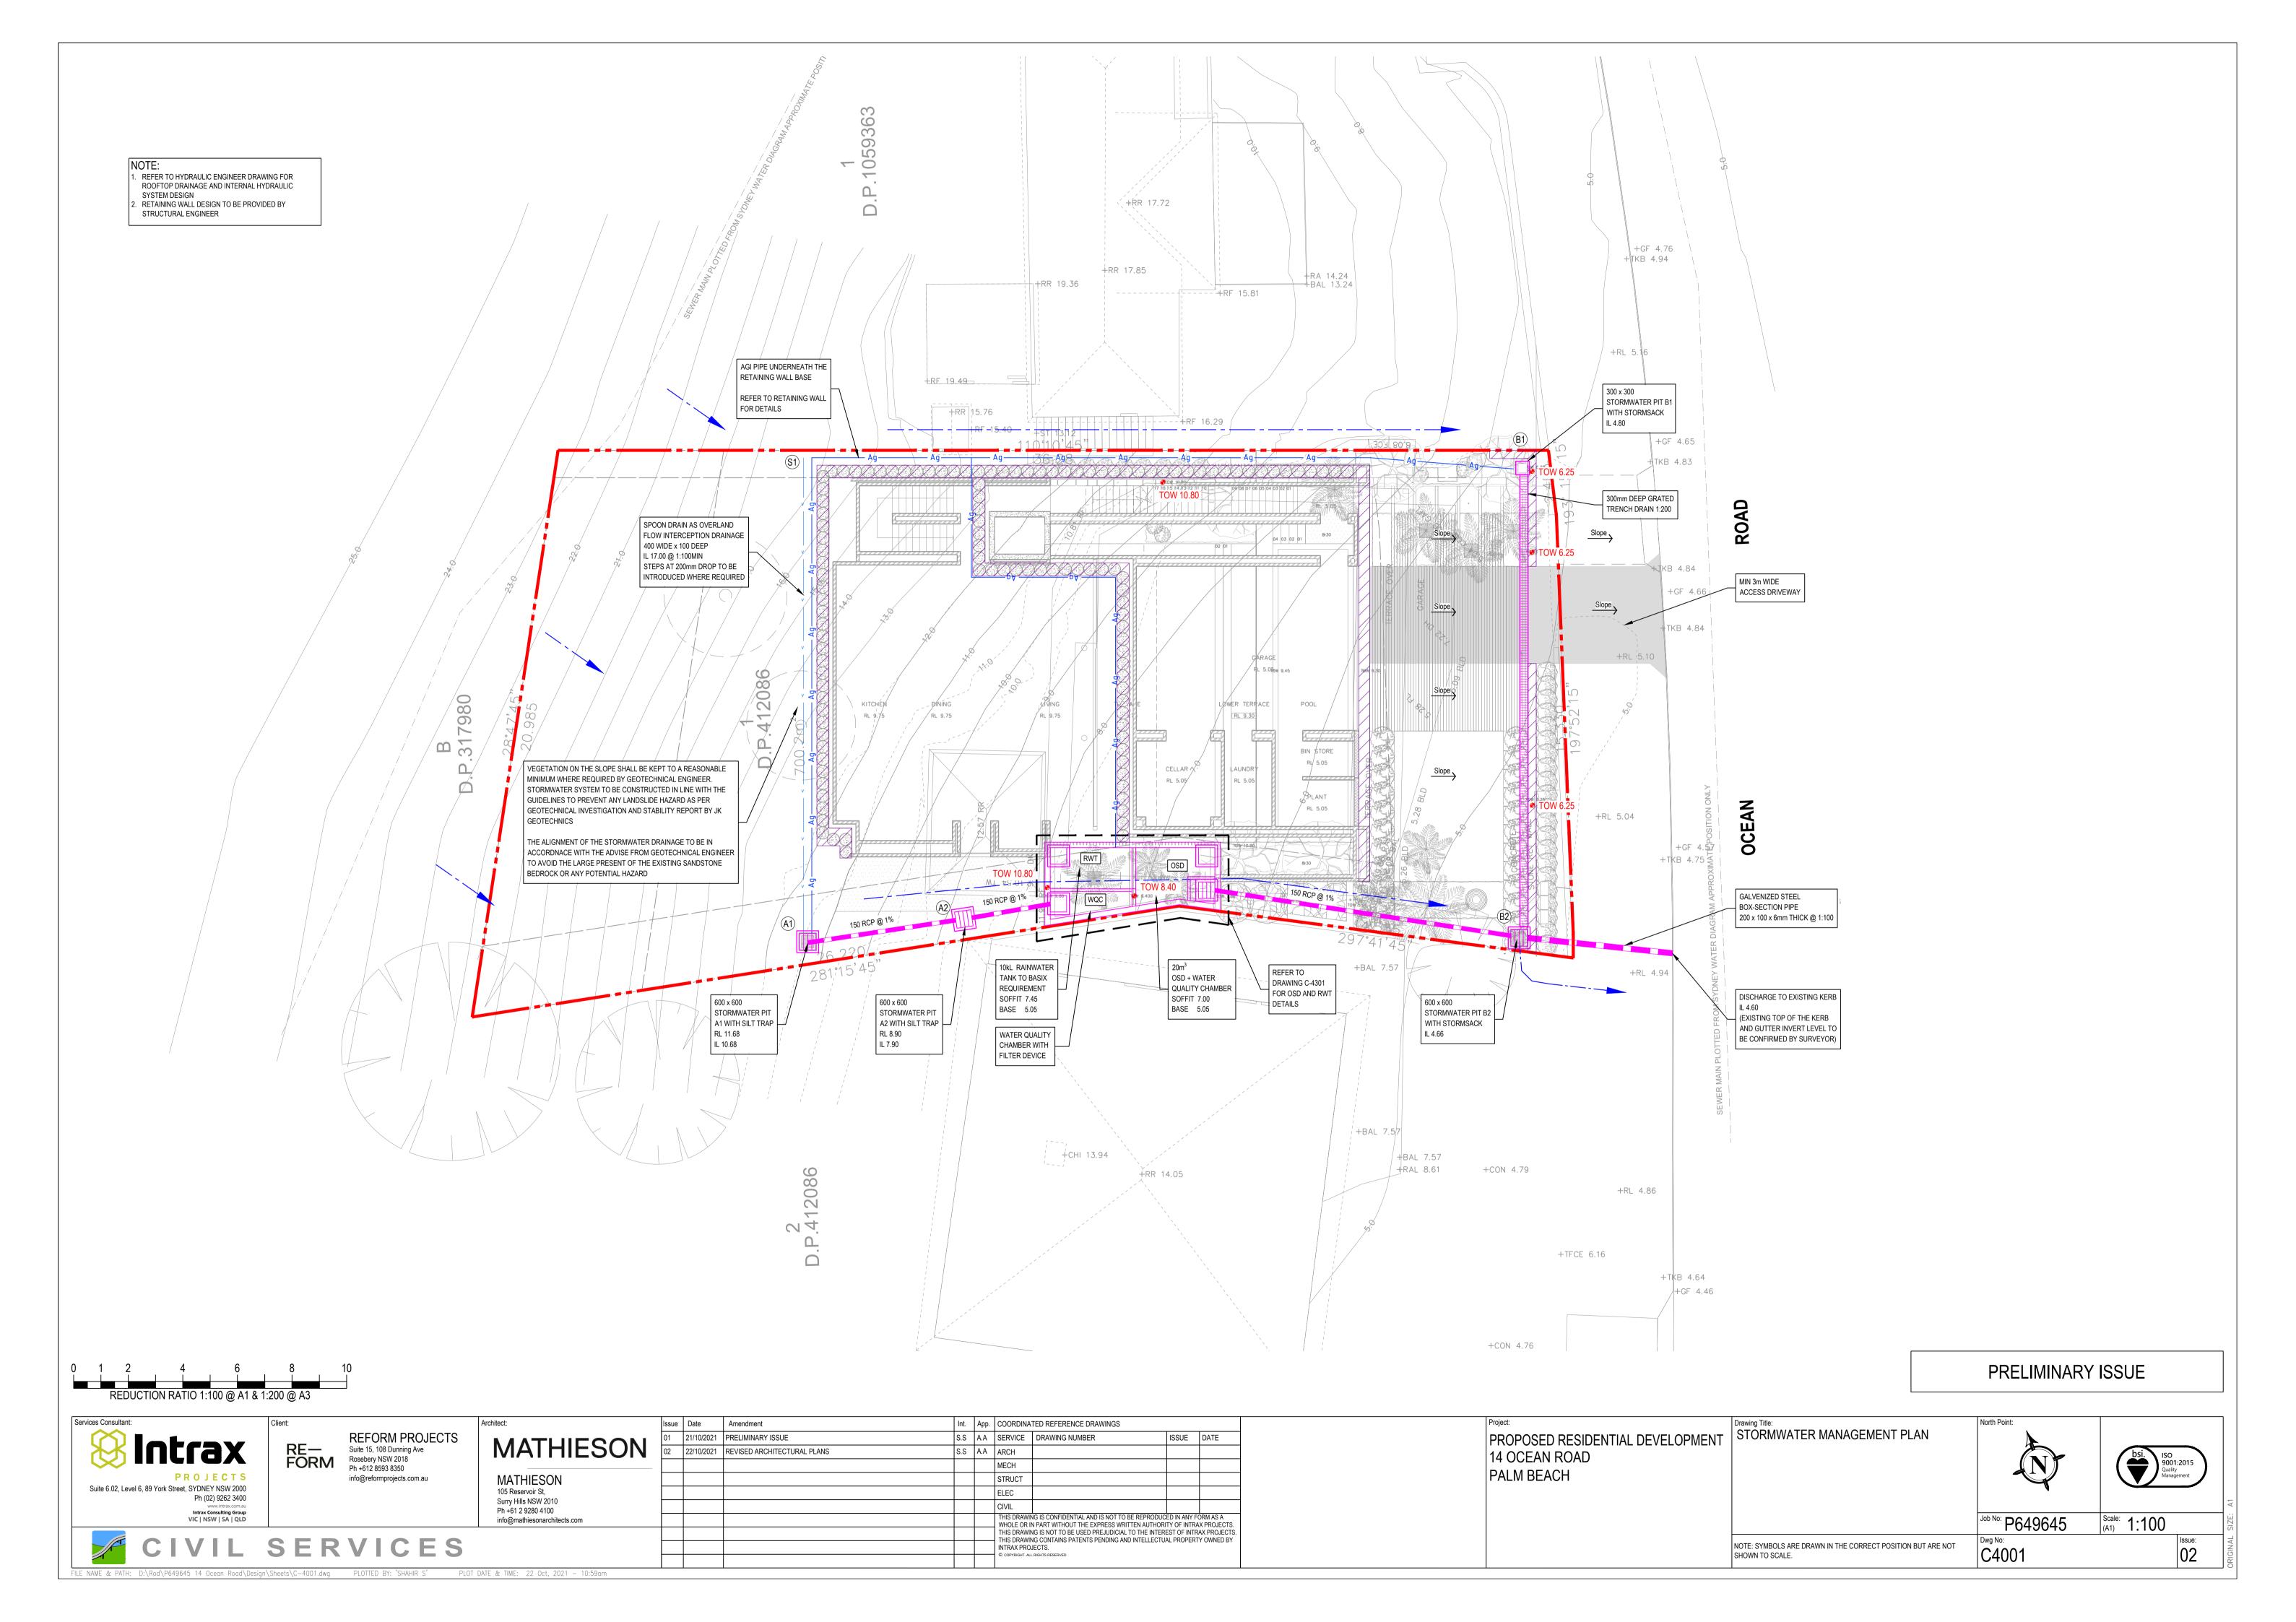



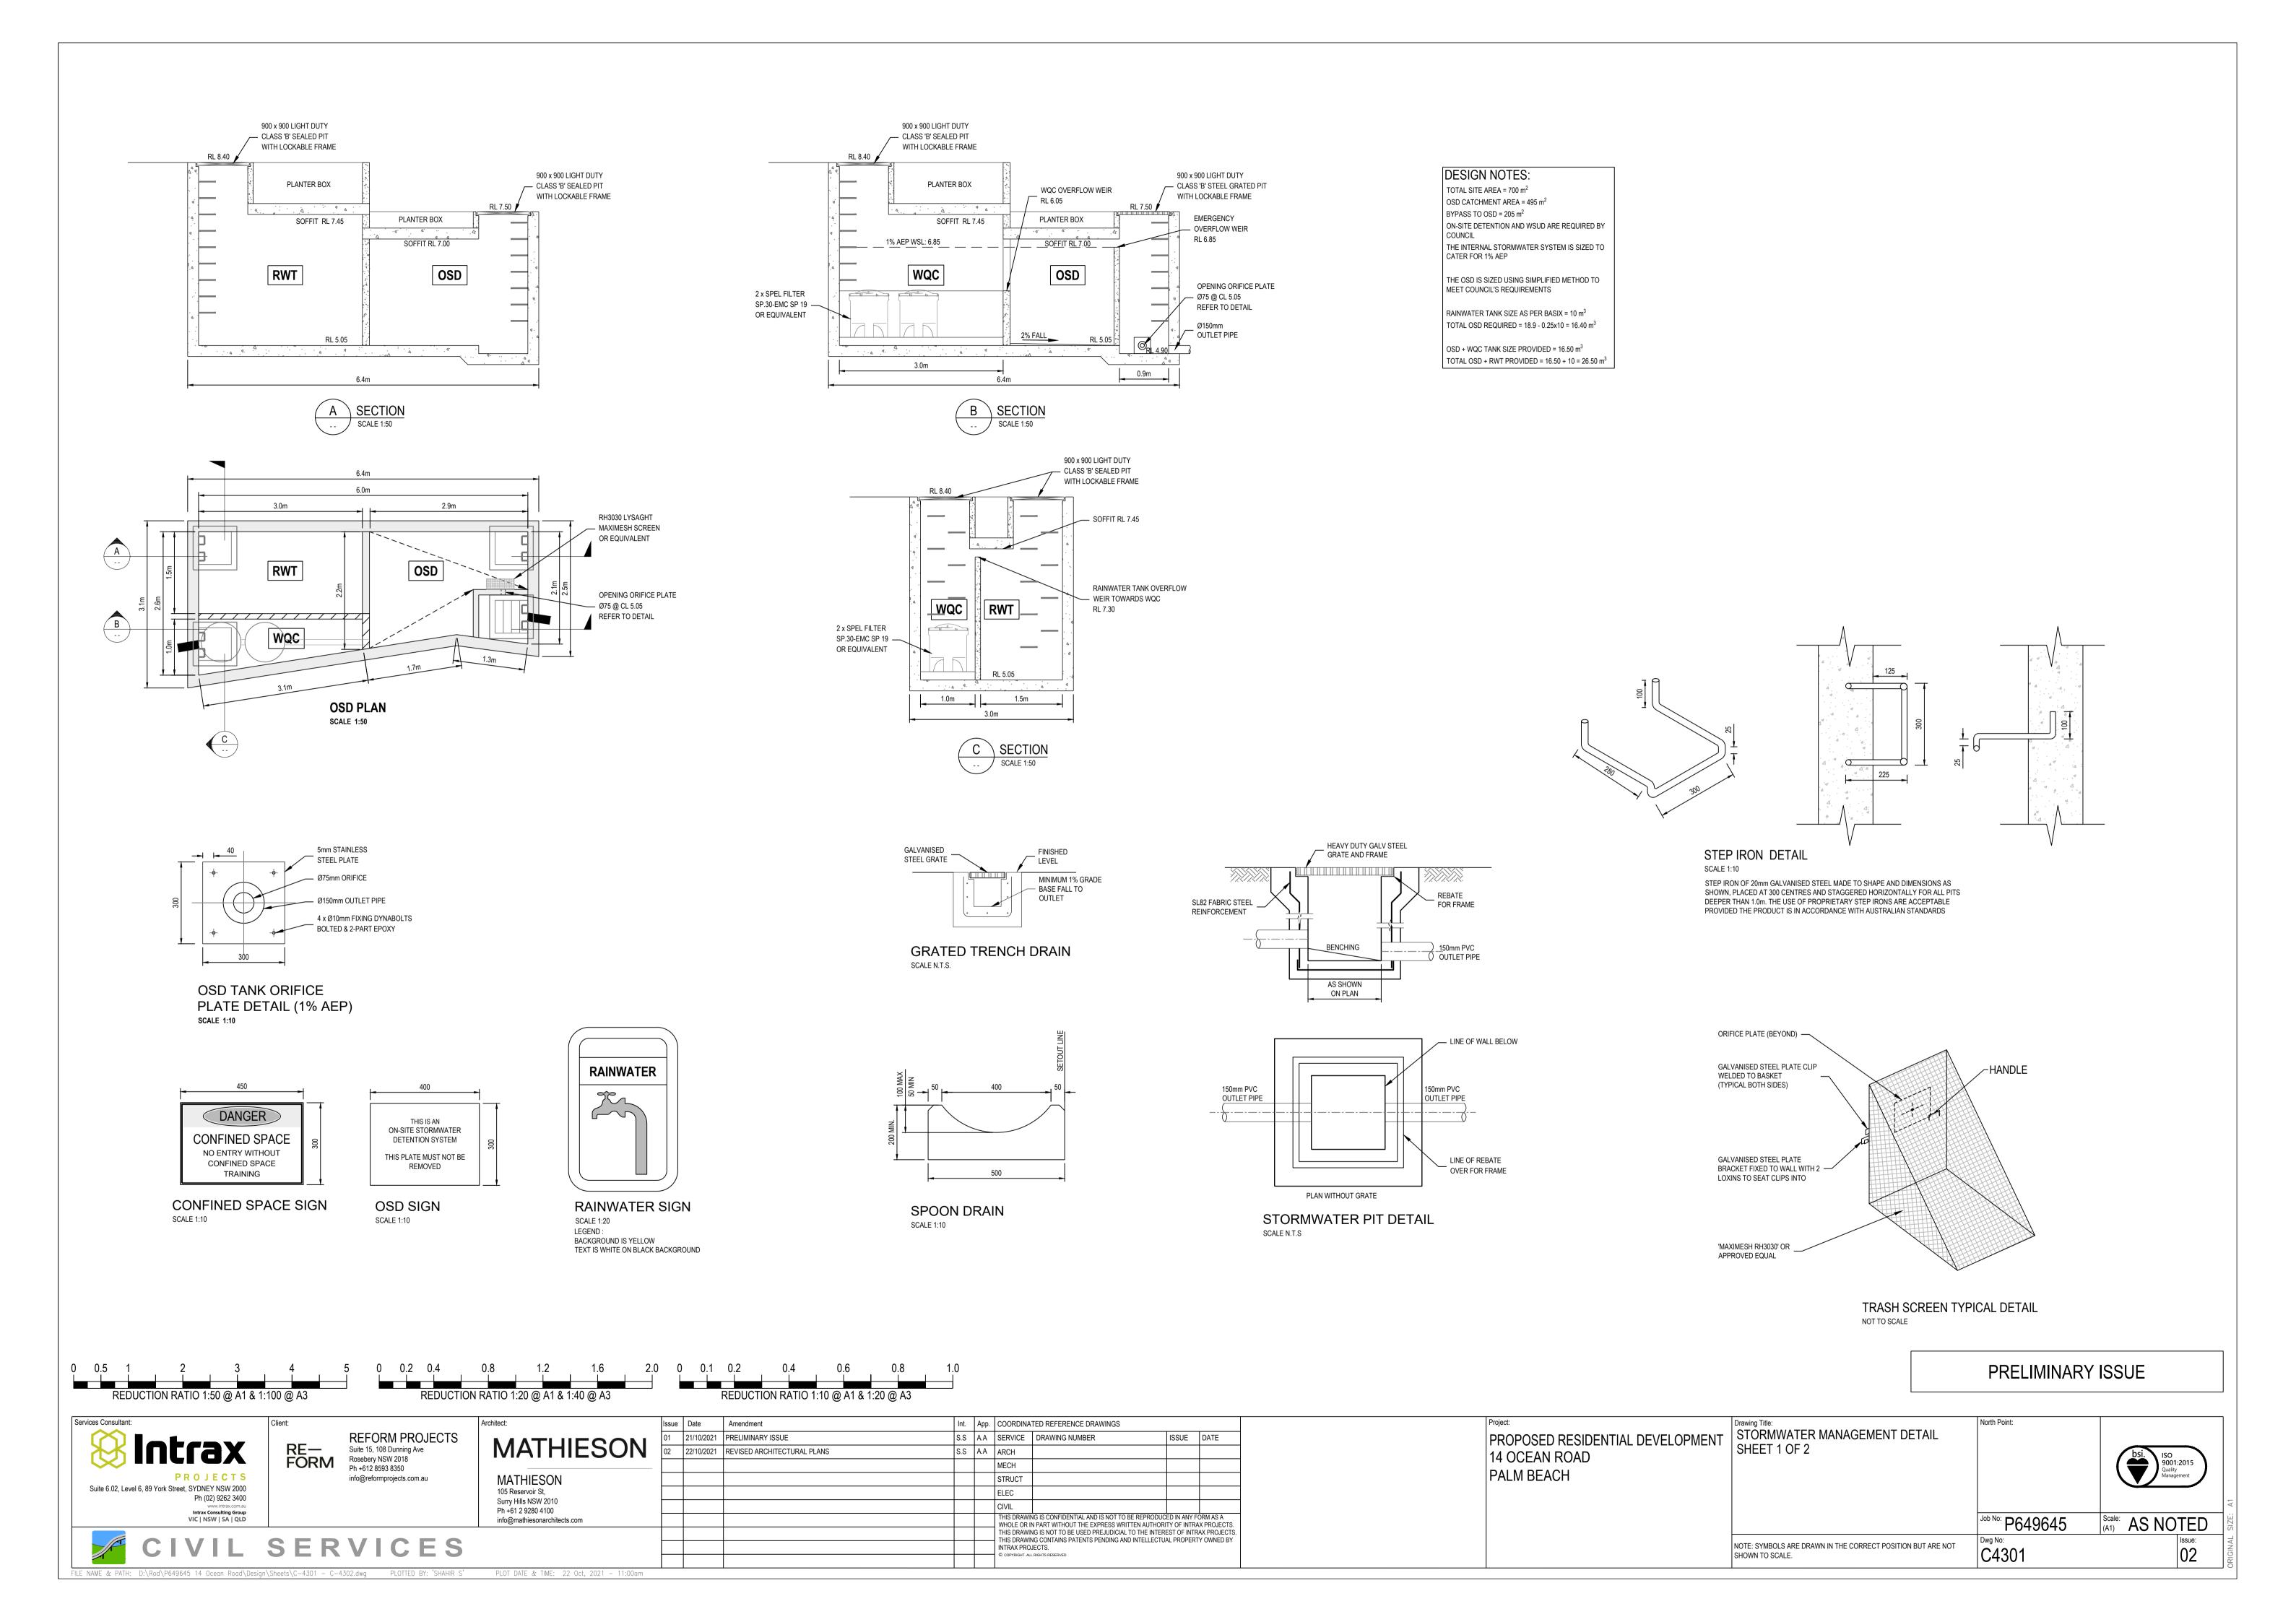

ISOMETRIC VIEW

| PARTS LIST | | | | | |
|------------|-----|---|---------------------|--|--|
| ITEM | QTY | PART NUMBER | DESCRIPTION | | |
| 1 | 1 | PLASTIC SHEETING | HDPE | | |
| 2 | 4 | SHEET METAL BINDING | STAINLESS STEEL 304 | | |
| 3 | 1 | TEXTILE FABRIC & MESH LINER | HDPE | | |
| 4 | 24 | BLIND RIVIT 7 DIA. | STAINLESS STEEL 304 | | |
| 5 | 4 | CORNER ESTIFFENER - FLAT BAR 25 x 2 -141 LG | STAINLESS STEEL 304 | | |

CARABINER CLIP 6

ALUMINIUM

SPEL STORMSACK 600 x 600 DETAIL


SCALE N.T.S.

NOTE:

THE DETAILED OSD AND WATER QUALITY DEVICE MAINTENANCE SCHEDULE TO BE PROVIDED BY THE MANUFACTURER SHOULD THE PROVIDER BE ENGAGED IN CONSTRUCTION STAGE.

REFER TO MANUFACTURER OPERATION AND MAINTENANCE MANUAL FOR THE

MAINTENANCE SCHEDULE OF STORMWATER FILTER DEVICE

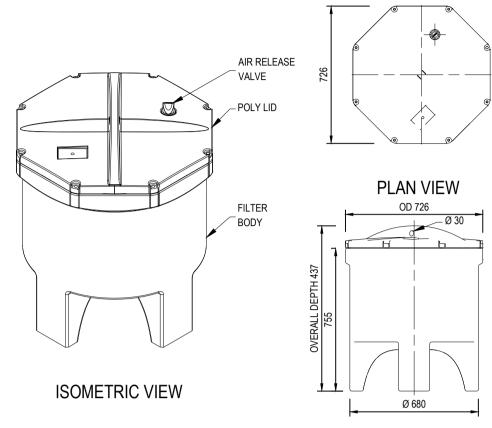

ELEVATION VIEW

SPEL FILTER DETAIL

SCALE N.T.S.


THE DETAILED OSD AND WATER QUALITY DEVICE MAINTENANCE SCHEDULE TO BE PROVIDED BY THE MANUFACTURER SHOULD THE PROVIDER BE ENGAGED IN CONSTRUCTION STAGE.

REFER TO MANUFACTURER OPERATION AND MAINTENANCE MANUAL FOR THE MAINTENANCE SCHEDULE OF STORMWATER FILTER DEVICE

| OSD SCHEDULE | | | | | | | | |
|--------------|--------------------------------------|--------------|---------------|--------------|--------|-----------|--|---|
| 000 NO | T) (DE | BASE AREA | AVG. DEPTH | MAX DEPTH | VOLUME | | NOTE | MAINITENIANIOE |
| OSD NO. | TYPE | (m2) | (m) | (m) | (m3) | FREEBOARD | NOTE | MAINTENANCE |
| 1 | UNDERGROUND CAST IN-SITU OSD TANK | 9.20 | 1.80 | 1.85 | 16.50 | 150 | "OSD TANK INCLUSIVE OF STORMWATER FILTER SYSTEM IN THE WATER QUALITY CHAMBER (WQC) | OPEN LIDS TO OVERFLOW PIT EVERY 3 MONTHS FOR VISUAL INSPECTION AND REMOVE LITTER AND SEDIMENT IF NECCCESSARY. REMOVE MESH LITTER GUARD EVERY 6 MONTHS TO CHECK IF ORIFICE IS IN FUNCTIONAL CONDITION. OPEN LIDS TO OSD STORAGE CHAMBER EVERY 24 MONTHS AND VACUUM SEDIMENTS IF NECCESSARY. STORMWATER FILTER CHAMBER AND FILTER MAINTENANCE TO MANUFACTURE'S SPECIFICATIONS. REFER TO MANUFACTURER OPERATION AND MAINTENANCE MANUAL FOR THE MAINTENANCE SCHEDULE OF STORMWATER FILTER DEVICE |

NOTE:

THE DETAILED OSD AND WATER QUALITY DEVICE MAINTENANCE SCHEDULE TO BE PROVIDED BY THE MANUFACTURER SHOULD THE PROVIDER BE ENGAGED IN CONSTRUCTION STAGE.

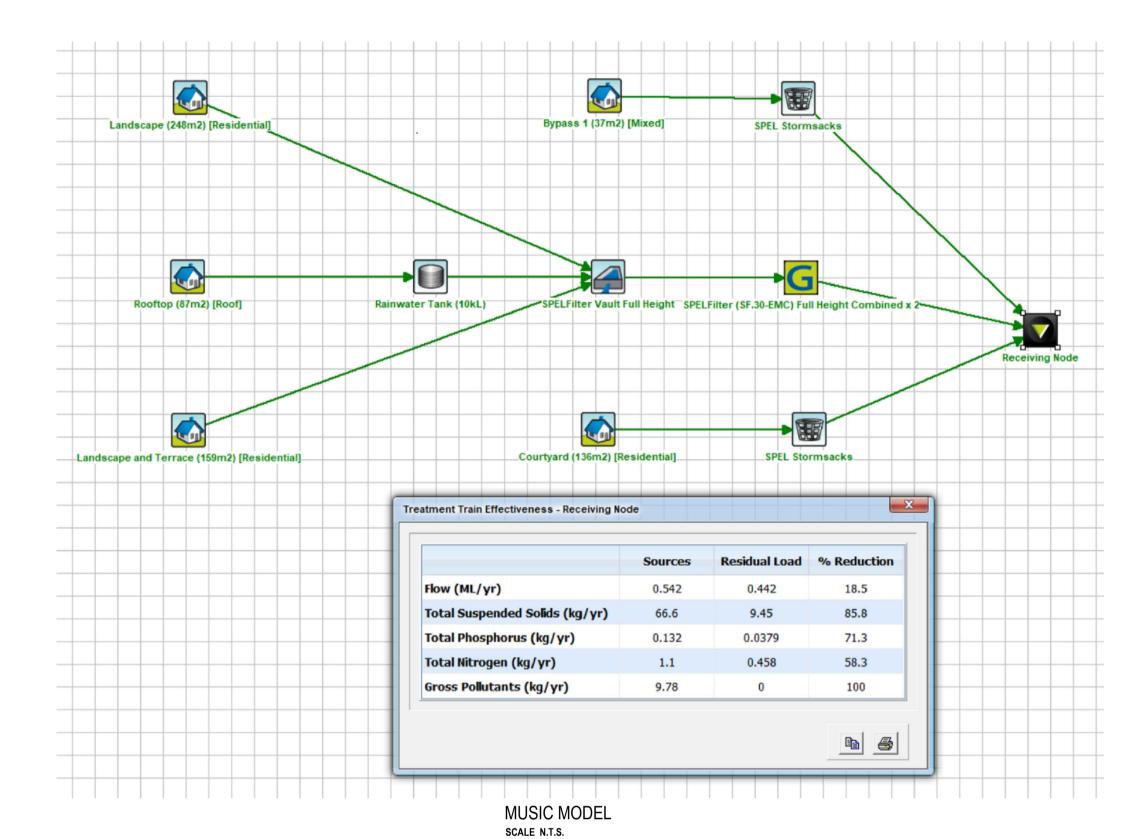

PRELIMINARY ISSUE



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Int. App. COORDINATED REFERENCE DRAWINGS Issue Date Amendment S.S A.A SERVICE DRAWING NUMBER 21/10/2021 PRELIMINARY ISSUE ISSUE DATE MATHIESON 22/10/2021 REVISED ARCHITECTURAL PLANS S.S A.A ARCH MECH STRUCT ELEC CIVIL

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PROPOSED RESIDENTIAL DEVELOPMENT 14 OCEAN ROAD PALM BEACH

Drawing Title:
STORMWATER MANAGEMENT DETAIL
SHEET 2 OF 2 North Point: Scale: AS NOTED Job No: P649645 NOTE: SYMBOLS ARE DRAWN IN THE CORRECT POSITION BUT ARE NOT SHOWN TO SCALE. 02 C4302