



a total R-value (R3.14).

- Brick veneer wall with foil + R2.5 batts in cavity to plasterboard lining, wall system reaching a total R-value (R3.02).

- Exterial walls modelled as per plans, with default medium colour finishes.

- Exterial walls "all unit walls that are not party walls to other units, or enclosed hallways & shafts.

Double glazed - Low solar gain Low-E glass, with aluminium framing:

- Type A (U-Value: 5.4, SHGC: 0.49). - Type B (U-Value: 5.4, SHGC: 0.58).

- Type A (U-Value: 5.6, SHGC: 0.41). - Type B (U-Value: 5.6, SHGC: 0.36).

S82A REVIEW



24.02.23

01.11.21

DEVELOPMENT 5 Skyline Place Frenchs Forest NSW 2086 SP 49558


LEVEL 3 FLOOR PLAN

PA STUDIO

LEVEL 2, 20 YOUNG ST. NEUTRAL BAY, NSW 2089 TEL:8968 1900 FAX:8968 1999 ACN:603 389 288

NOMINATED ARCHITECT:GEORGE REVAY-REG#3954


SCALE: AS SHOWN **DA206** SUBSET: DRAWN BY: SU/WH/SP ISSUE FILE: BIM Server: BIM21 - BIMcloud Basic for ARCHICAD 21/SKY5 (LOT1) 82A

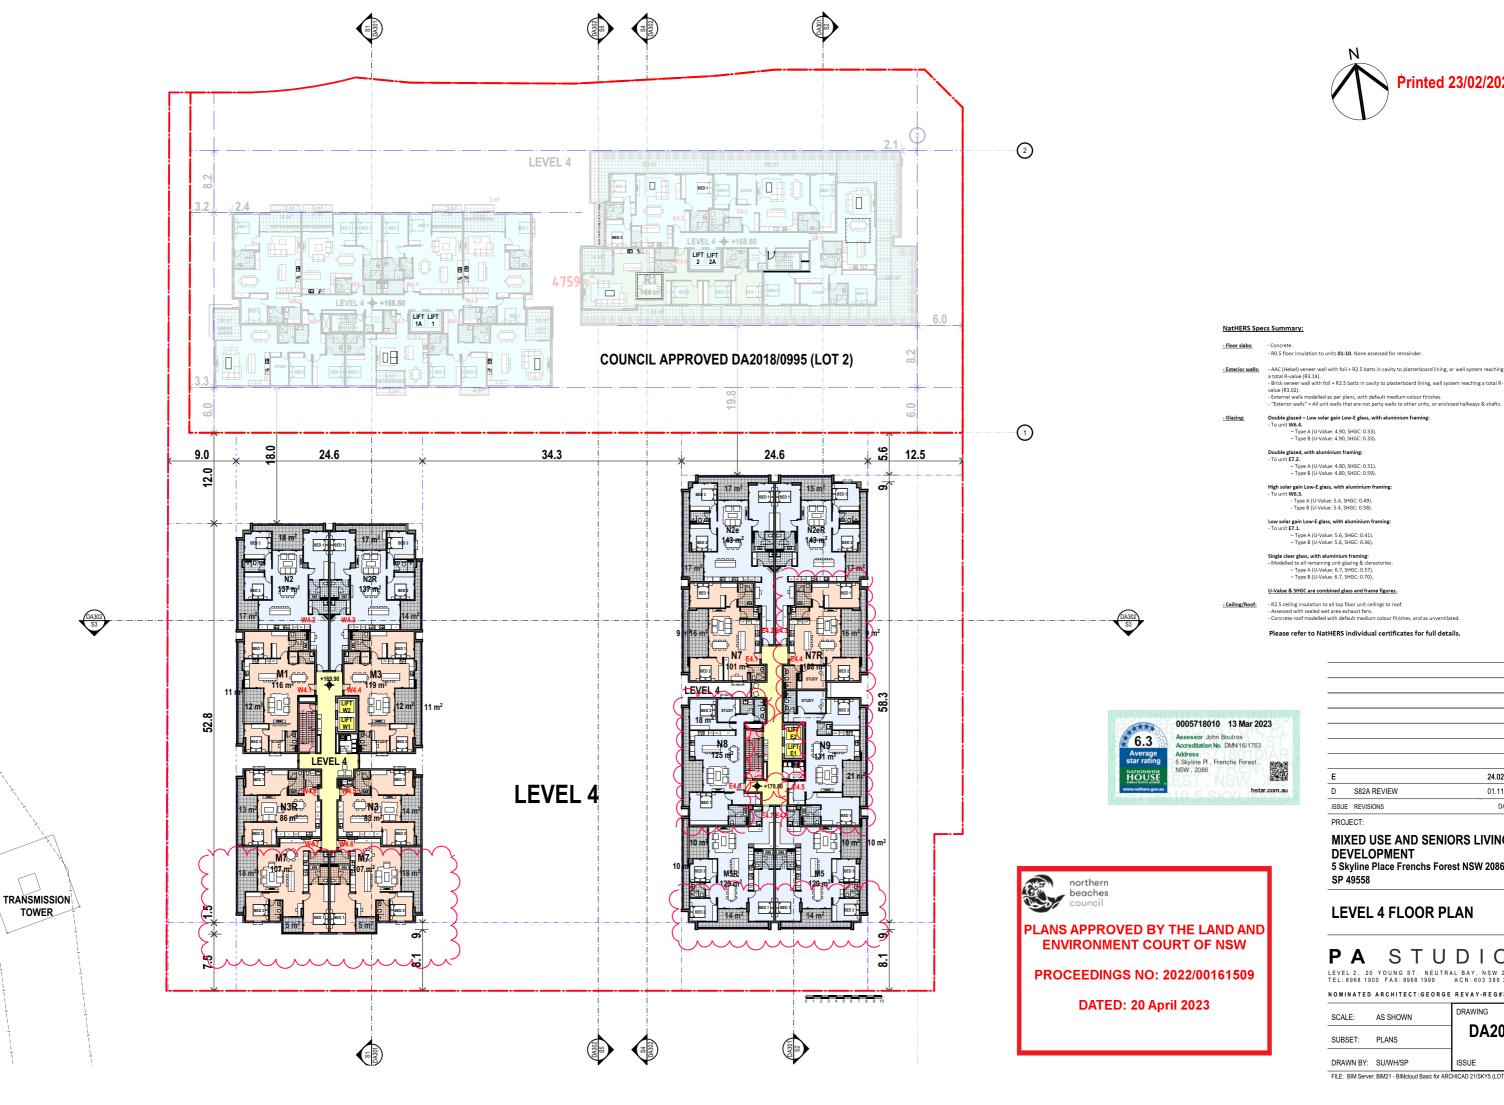



Double glazed - Low solar gain Low-E glass, with aluminium framing:

- Type A (U-Value: 5.4, SHGC: 0.49). - Type B (U-Value: 5.4, SHGC: 0.58).

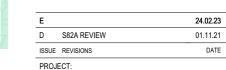

MIXED USE AND SENIORS LIVING DEVELOPMENT

5 Skyline Place Frenchs Forest NSW 2086 SP 49558


LEVEL 4 FLOOR PLAN

PA STUDIO

LEVEL 2, 20 YOUNG ST. NEUTRAL BAY, NSW 2089 TEL:8968 1900 FAX:8968 1999 ACN:603 389 288

NOMINATED ARCHITECT:GEORGE REVAY-REG#3954


SCALE:	AS SHOWN	DRAWING	
OO/ILL.	7.0 01101111	DA207	
SUBSET:	PLANS]	
DRAWN BY:	SU/WH/SP	ISSUE D	

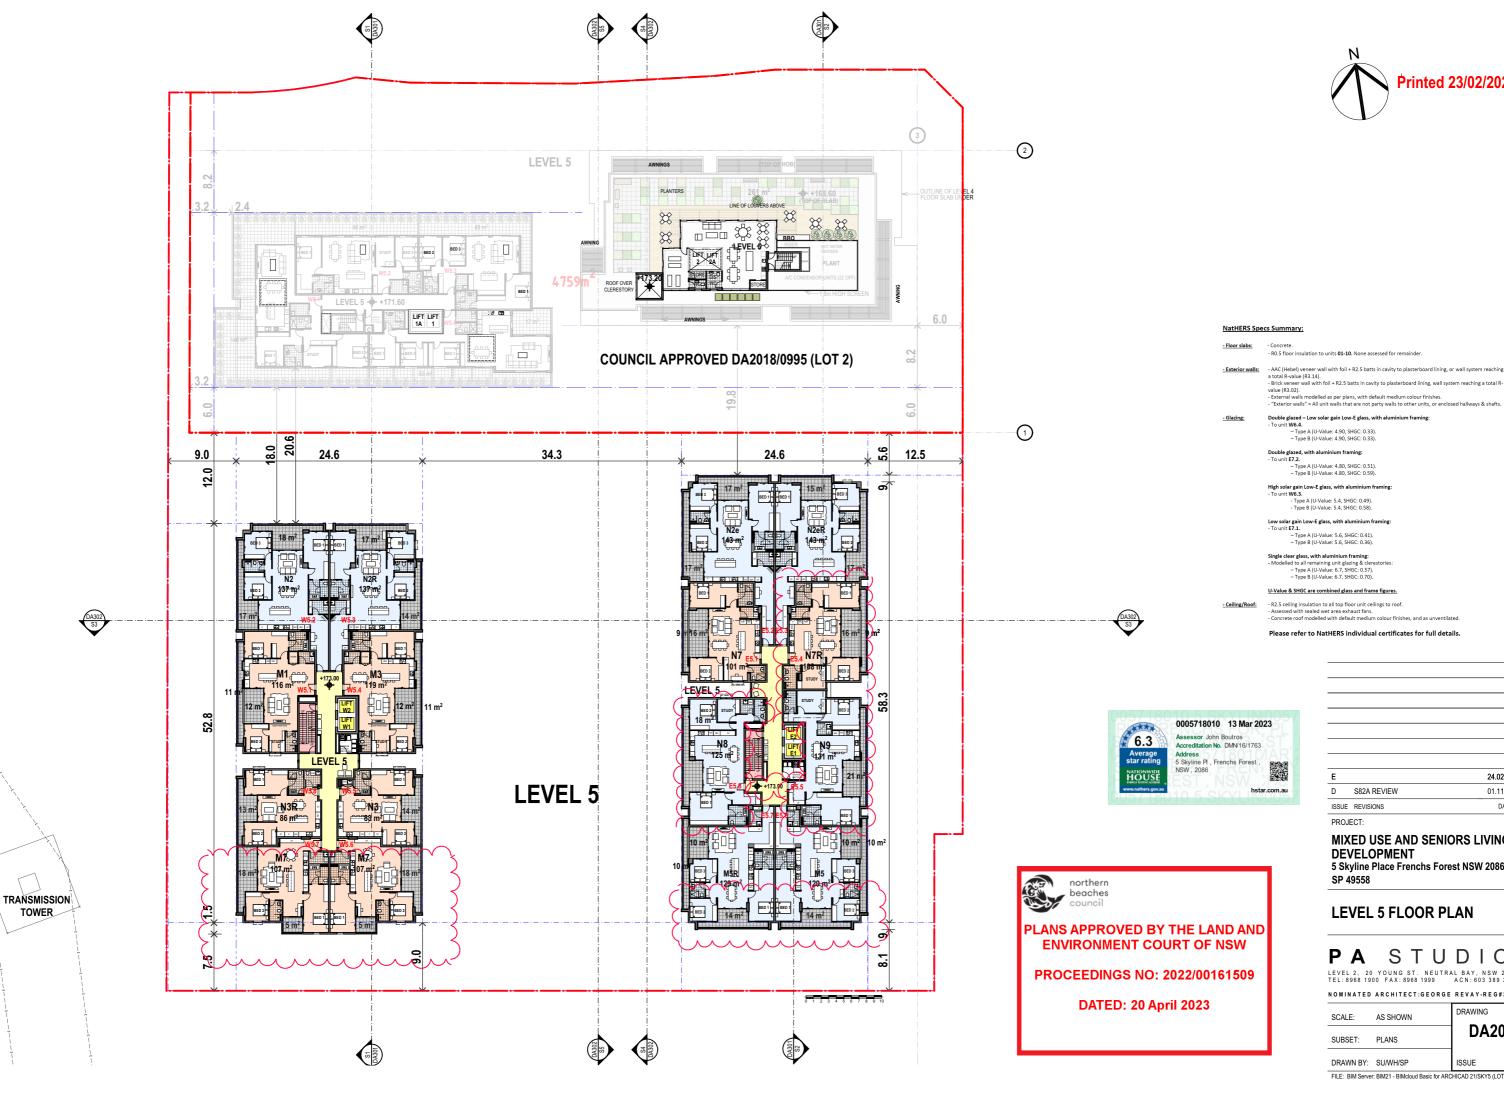



Double glazed - Low solar gain Low-E glass, with aluminium framing:

- Type A (U-Value: 5.4, SHGC: 0.49). - Type B (U-Value: 5.4, SHGC: 0.58).

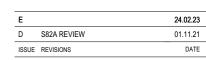

MIXED USE AND SENIORS LIVING DEVELOPMENT

5 Skyline Place Frenchs Forest NSW 2086 SP 49558


LEVEL 5 FLOOR PLAN

PA STUDIO

LEVEL 2, 20 YOUNG ST. NEUTRAL BAY, NSW 2089 TEL:8968 1900 FAX:8968 1999 ACN:603 389 288

NOMINATED ARCHITECT:GEORGE REVAY-REG#3954

SCALE:	AS SHOWN	DRAWING
SUBSET:	PLANS	DA208
DRAWN BY:	SU/WH/SP	ISSUE D

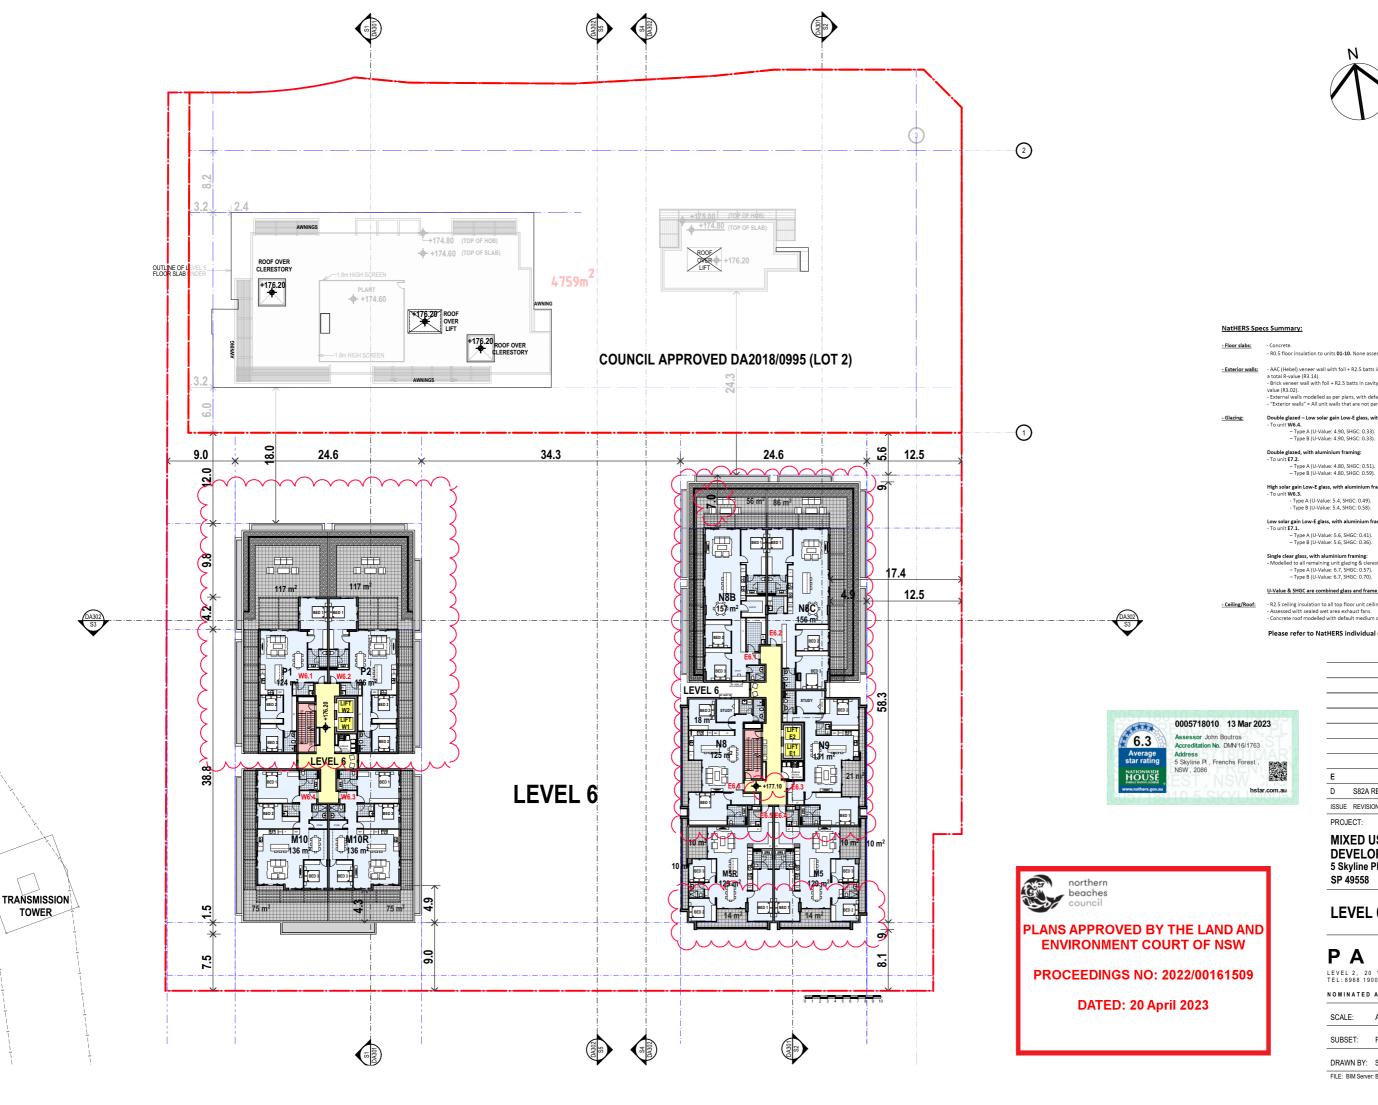



a total R-value (R3.14).

- Brick veneer wall with foil + R2.5 batts in cavity to plasterboard lining, wall system reaching a total R-value (R3.02).


- Exterial walls modelled as per plans, with default medium colour finishes.

- Exterial walls "all unit walls that are not party walls to other units, or enclosed hallways & shafts.

Double glazed - Low solar gain Low-E glass, with aluminium framing:

Type A (U-Value: 4.80, SHGC: 0.51).
 Type B (U-Value: 4.80, SHGC: 0.59).

U-Value & SHGC are combined glass and frame figures

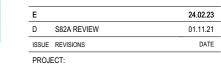

MIXED USE AND SENIORS LIVING **DEVELOPMENT**

5 Skyline Place Frenchs Forest NSW 2086 SP 49558


LEVEL 6 FLOOR PLAN

PA STUDIO

LEVEL 2, 20 YOUNG ST. NEUTRAL BAY, NSW 2089 TEL:8968 1900 FAX:8968 1999 ACN:603 389 288

NOMINATED ARCHITECT:GEORGE REVAY-REG#3954

SCALE:	AS SHOWN	DRAWING
SUBSET:	PLANS	DA209
DRAWN BY:	SU/WH/SP	ISSUE D

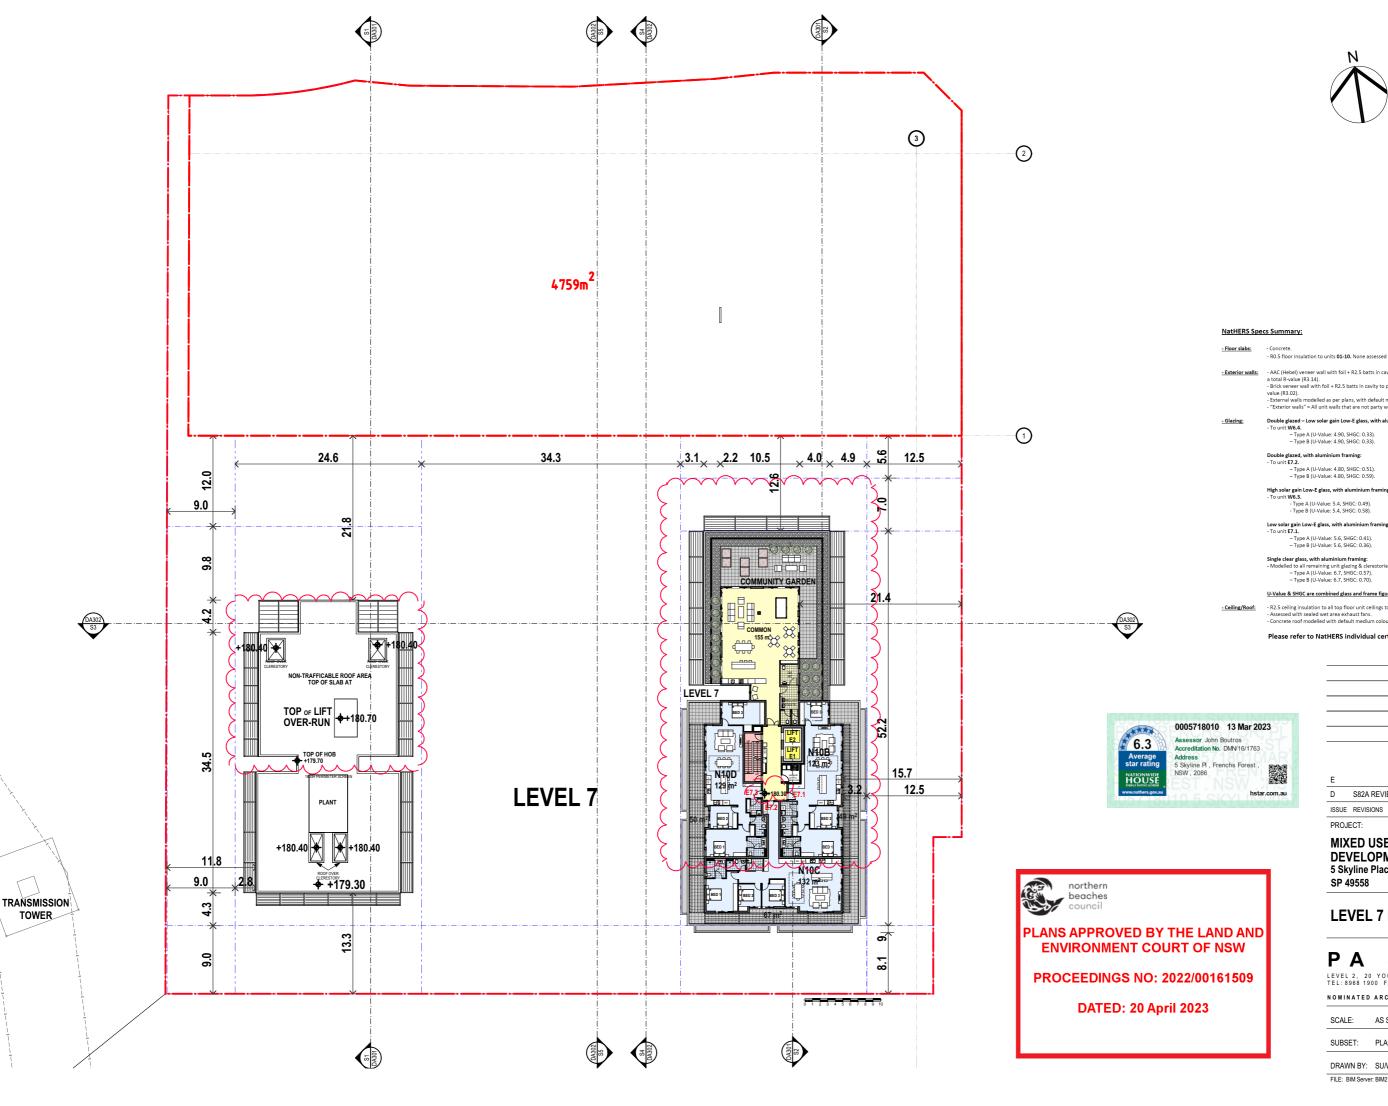



- And, (redeet) verticed wait with four And, 3 date, in Lavity on plasterboard liming, or wait system reaching a total R-value (R3.72).

- Brick veneer wall with foil + R2.5 batts in cavity to plasterboard lining, wall system reaching a total R-value (R3.02).

- External walls modelled as perl plans, with default medium colour finishes.

- "Exterior walls" = All unit walls that are not party walls to other units, or enclosed hallways & shafts.


Double glazed - Low solar gain Low-E glass, with aluminium framing:

t **E7.2.**- Type A (U-Value: 4.80, SHGC: 0.51).

- Type B (U-Value: 4.80, SHGC: 0.59).

U-Value & SHGC are combined glass and frame figures

R2.5 ceilling insulation to all top floor unit ceilings to roof.
 Assessed with sealed wet area exhaust fans.
 Concrete roof modelled with default medium colour finishes, and as ur

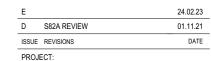

MIXED USE AND SENIORS LIVING DEVELOPMENT

5 Skyline Place Frenchs Forest NSW 2086 SP 49558


LEVEL 7 FLOOR PLAN

PA STUDIO

LEVEL 2, 20 YOUNG ST. NEUTRAL BAY, NSW 2089 TEL:8968 1900 FAX:8968 1999 ACN:603 389 288

NOMINATED ARCHITECT:GEORGE REVAY-REG#3954


SCALE:	AS SHOWN	DRAWING	l
SUBSET:	PLANS	DA210	
DRAWN BY:	SU/WH/SP	ISSUE E	
FILE: BIM Server	: BIM21 - BIMcloud Basic for ARC	HICAD 21/SKY5 (LOT1) 82A	·

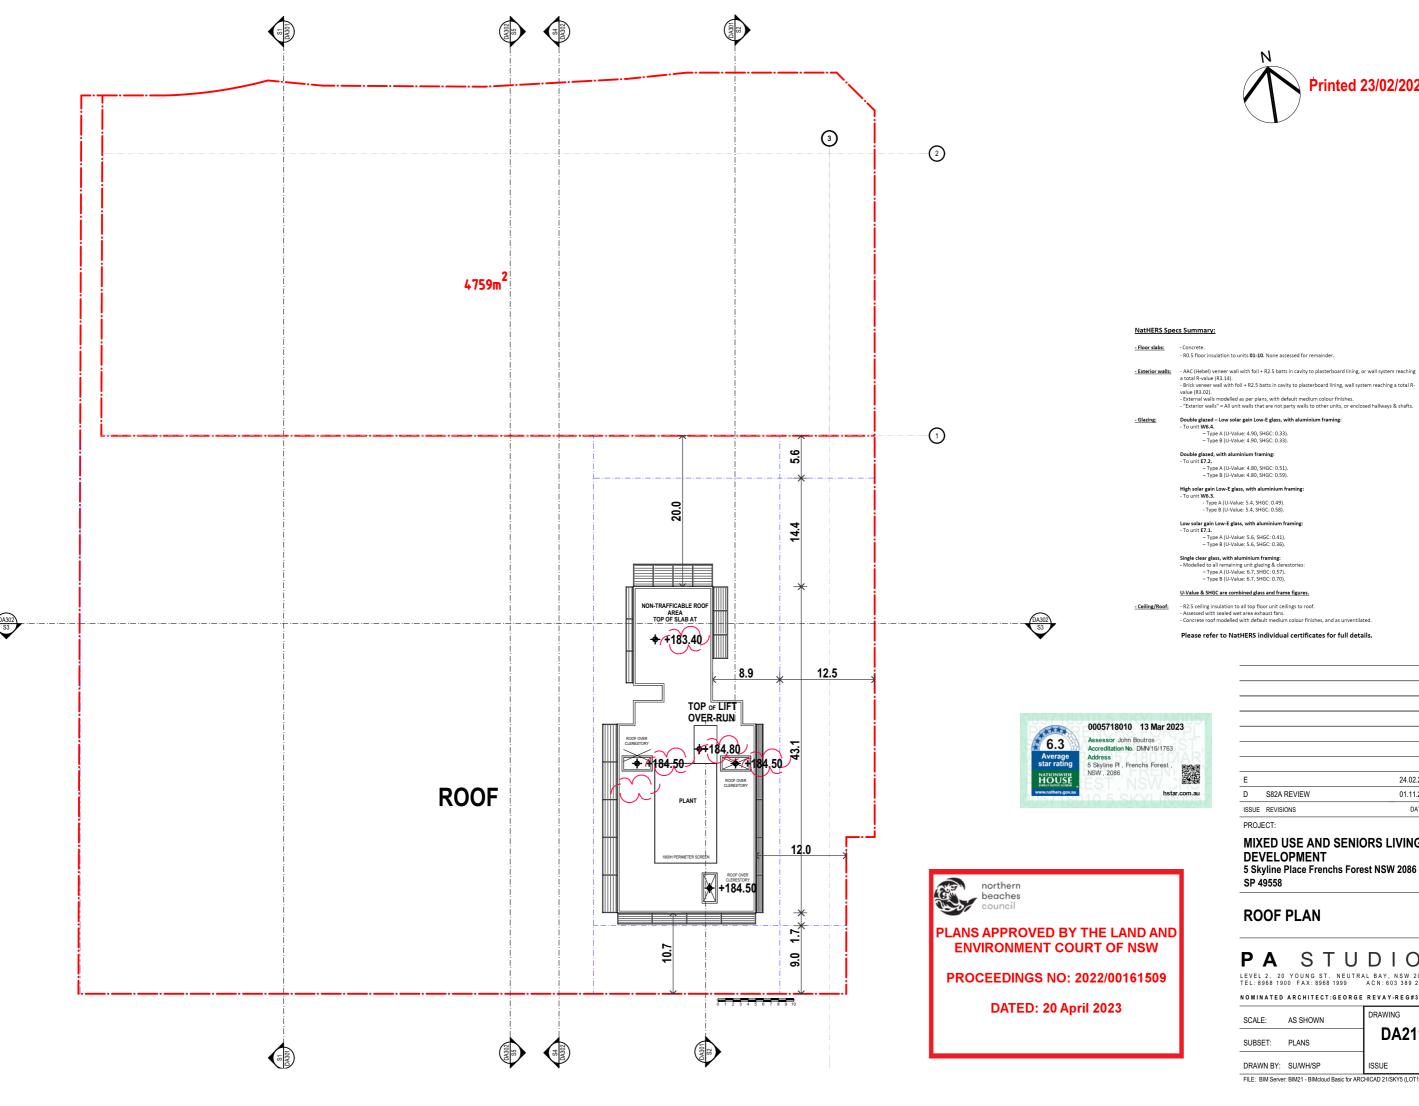



U-Value & SHGC are combined glass and frame figures.

Please refer to NatHERS individual certificates for full details.

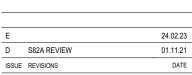

PROJECT:

MIXED USE AND SENIORS LIVING DEVELOPMENT 5 Skyline Place Frenchs Forest NSW 2086

SP 49558


ROOF PLAN


PA STUDIO


LEVEL 2, 20 YOUNG ST. NEUTRAL BAY, NSW 2089 TEL:8968 1900 FAX:8968 1999 ACN:603 389 288 NOMINATED ARCHITECT:GEORGE REVAY-REG#3954

SCALE: AS SHOWN DA211 SUBSET: PLANS DRAWN BY: SU/WH/SP ISSUE



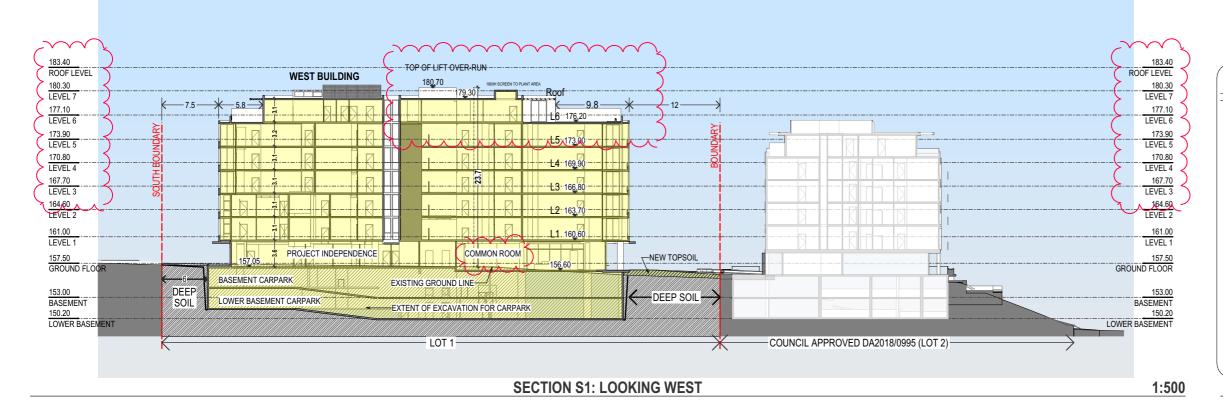

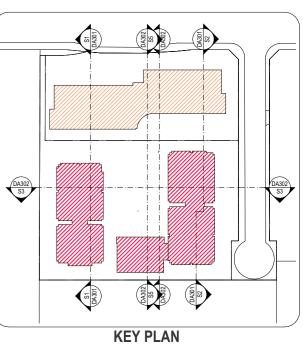

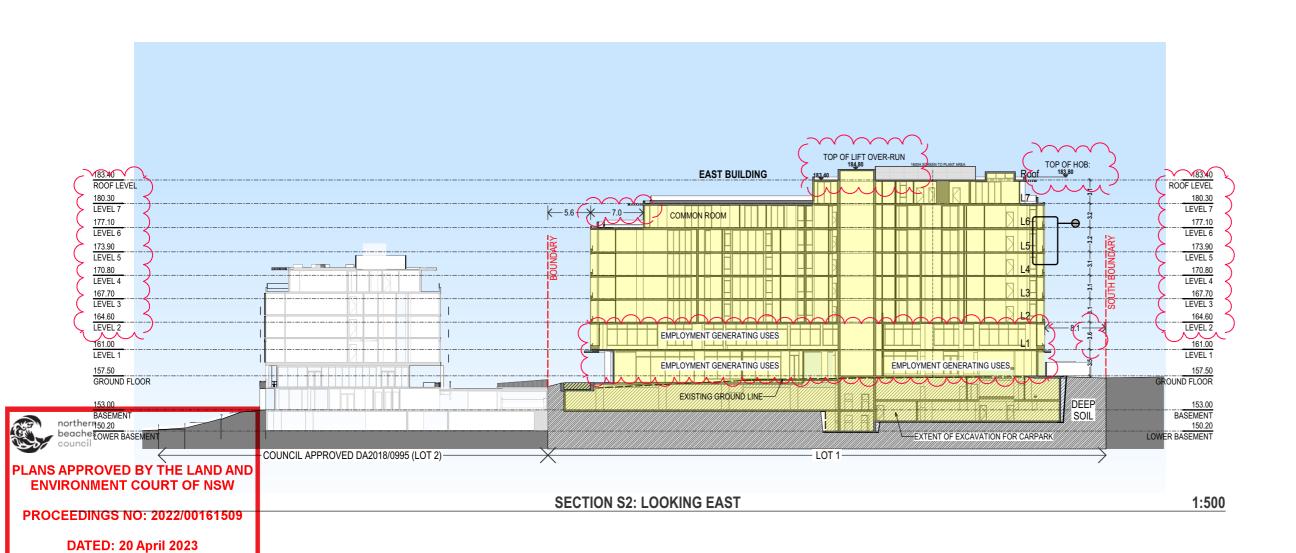



E 24.02.23

D \$82A REVIEW 01.11.21

ISSUE REVISIONS DATE

PROJECT:

MIXED USE AND SENIORS LIVING

DEVELOPMENT

SECTIONS S1 & S2

SP 49558

PA STUDIO

LEVEL 2, 20 YOUNG ST. NEUTRAL BAY, NSW 2089
TEL: 8968 1900 FAX: 8968 1999 ACN: 603 389 288

5 Skyline Place Frenchs Forest NSW 2086


SCALE: AS SHOWN
SUBSET: SECTIONS


NOMINATED ARCHITECT:GEORGE REVAY-REG#3954


DRAWING
DA301

DRAWN BY: SU/WH/SP ISSUE



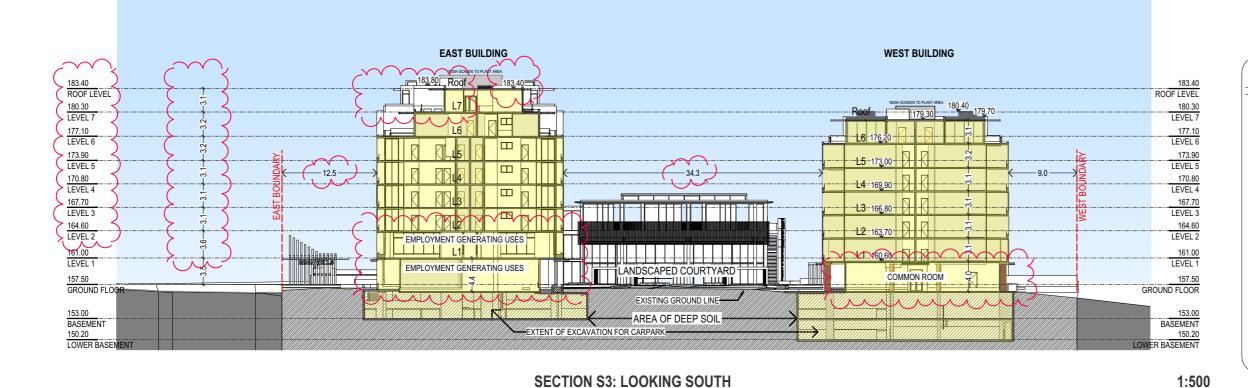

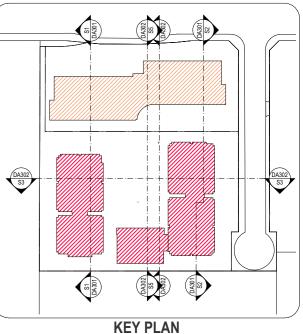

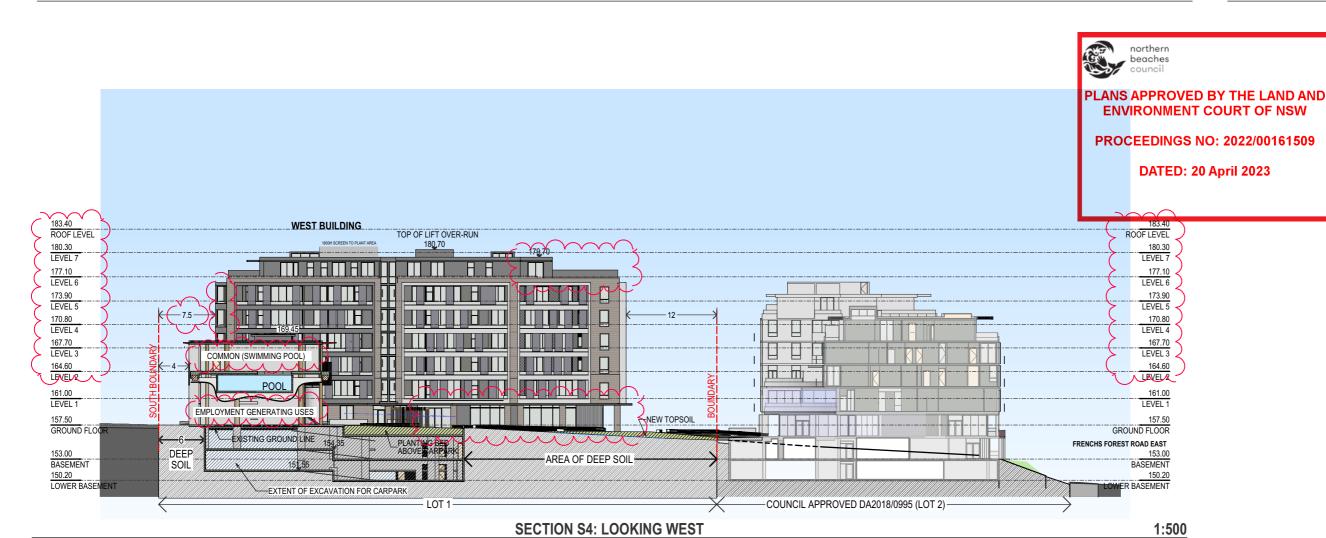



 E
 24.02.23

 D
 S82A REVIEW
 01.11.21

 ISSUE
 REVISIONS
 DATE

 PROJECT:
 The control of the contr

MIXED USE AND SENIORS LIVING DEVELOPMENT 5 Skyline Place Frenchs Forest NSW 2086

SP 49558

DRAWN BY: SU/WH/SP

SECTIONS S3 & S4

PA STUDIO

LEVEL 2, 20 YOUNG ST. NEUTRAL BAY, NSW 2089
TEL: 8968 1900 FAX: 8968 1999 ACN: 603 389 288

NOMINATED ARCHITECT:GEORGE REVAY-REG#3954

SCALE: AS SHOWN

SUBSET: SECTIONS

DRAWING

DA302

FILE: BIM Server: BIM21 - BIMcloud Basic for ARCHICAD 21/SKY5 (LOT1) 82A


ISSUE





DATED: 20 April 2023

Please refer to NatHERS individual certificates for full details.

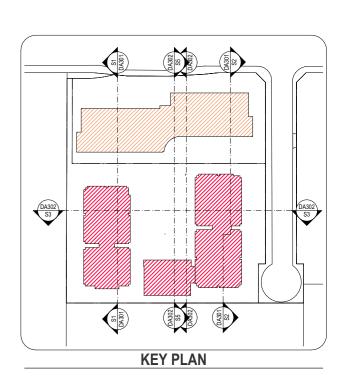





Е		24.02.23
D	S82A REVIEW	01.11.21
ISSUE	REVISIONS	DATE
PROJE	ECT:	

MIXED USE AND SENIORS LIVING DEVELOPMENT

5 Skyline Place Frenchs Forest NSW 2086 SP 49558

SECTION S5

PA STUDIO

LEVEL 2, 20 YOUNG ST. NEUTRAL BAY, NSW 2089
TEL: 8968 1900 FAX: 8968 1999 ACN: 603 389 288

NOMINATED ARCHITECT: GEORGE REVAY-REG#3954

SCALE:	AS SHOWN	DRAWING
		DA303
SUBSET:	SECTIONS	_
DRAWN BY:	SU/WH/SP	ISSUE E

northern beaches

ENVIRONMENT COURT OF NSW

DATED: 20 April 2023



EAST ELEVATION CONTEXTUAL 1:500



24.02.23 01.11.21

5 Skyline Place Frenchs Forest NSW 2086

PA STUDIO

LEVEL 2, 20 YOUNG ST. NEUTRAL BAY, NSW 2089 TEL:8968 1900 FAX:8968 1999 ACN:603 389 288 NOMINATED ARCHITECT:GEORGE REVAY-REG#3954

SCALE:	AS SHOWN	DRAWING
SCALE:	AS SHOWN	DA401
SUBSET:	ELEVATIONS	DA401
DRAWN BY:	SU/WH/SP	ISSUE E
FILE: BIM Server	: BIM21 - BIMcloud Basic for ARC	HICAD 21/SKY5 (LOT1) 82/

PA STUDDIO

LEVEL 2, 20 YOUNG ST. NEUTRAL BAY, NSW 2089
TEL: 8968 1900 FAX: 8968 1999 ACN: 603 389 288

NOMINATED ARCHITECT:GEORGE REVAY-REG#3954

FILE: BIM Server: BIM21 - BIMcloud Basic for ARCHICAD 21/SKY5 (LOT1) 82A

DA402

ISSUE


AS SHOWN

ELEVATIONS

DRAWN BY: SU/WH/SP

SCALE:

SUBSET:

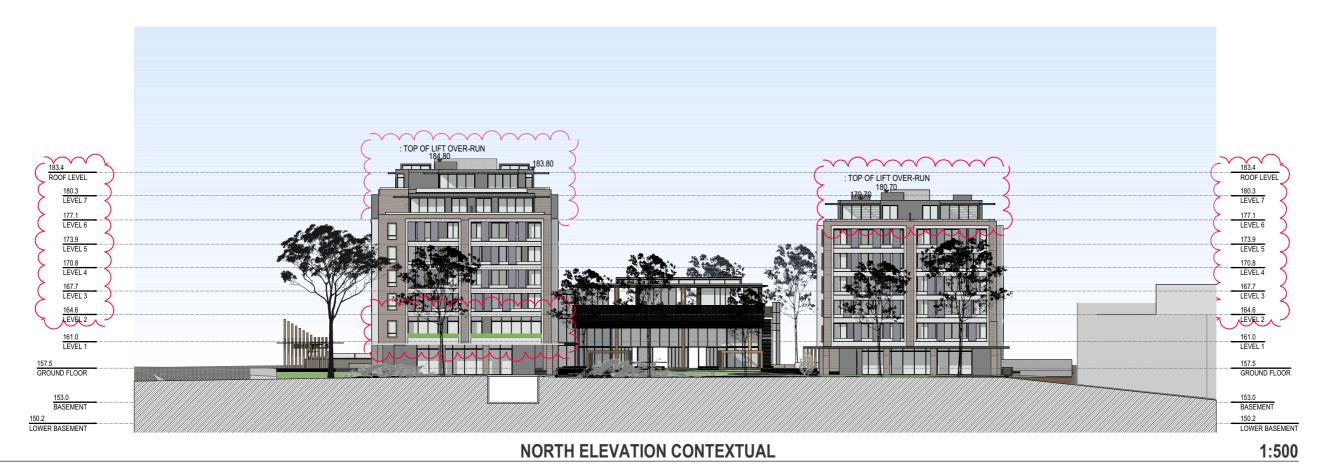



PLANS APPROVED BY THE LAND AND

ENVIRONMENT COURT OF NSW

PROCEEDINGS NO: 2022/00161509

DATED: 20 April 2023






DATED: 20 April 2023

1:500



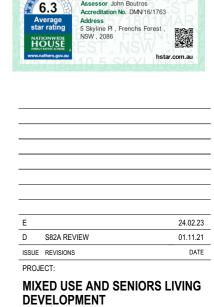

WEST ELEVATION

SP 49558



5 Skyline Place Frenchs Forest NSW 2086

SUBSET: ELEVATIONS	SCALE:	AS SHOWN	DRAWING	
DRAWN RV: SLIWH/SP ISSUE	SUBSET:	ELEVATIONS	DA	403
DIVAVII DI. GOVIII GI	DRAWN BY:	SU/WH/SP	ISSUE	Ε





0005718010 13 Mar 2023 6.3

24.02.23 D S82A REVIEW 01.11.21 ISSUE REVISIONS

MIXED USE AND SENIORS LIVING DEVELOPMENT 5 Skyline Place Frenchs Forest NSW 2086 SP 49558

SOUTH ELEVATION

PA STUDIO

LEVEL 2, 20 YOUNG ST. NEUTRAL BAY, NSW 2089 TEL:8968 1900 FAX:8968 1999 ACN:603 389 288

NOMINATED ARCHITECT:GEORGE REVAY-REG#3954

AS SHOWN SCALE: **DA404** ELEVATIONS SUBSET: DRAWN BY: SU/WH/SP ISSUE FILE: BIM Server: BIM21 - BIMcloud Basic for ARCHICAD 21/SKY5 (LOT1) 82A


SOUTH ELEVATION

PLANS APPROVED BY THE LAND AND **ENVIRONMENT COURT OF NSW**


PROCEEDINGS NO: 2022/00161509

DATED: 20 April 2023



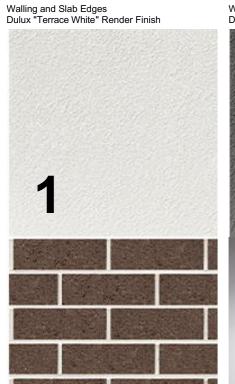

Walling and Slab Edges Dark Brick Masonry Walling and Slab Edges Dulux "Malay Grey" Render Finish

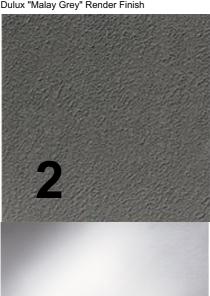


8

Balustrades White Glass Clear Anodised Aluminum Flat Bar Railing Paint Dulux Monument



Walling and Slab Edges Textured concrete RECKLI 1_148 Lanzarote Walling
Hebel PowerPattern Pre-routed pattern panels

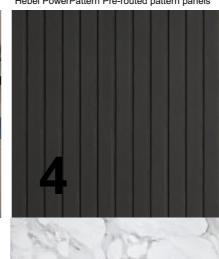

10

External Walls Entrance Area White Marble Perforated Aluminium Sunscreens Paint Dulux Marais GR 13



11

Outside Paving

Aluminium Window Frames & Joinery Powdercoat - Colour MONUMENT Aluminium




northern beaches council

PLANS APPROVED BY THE LAND AND ENVIRONMENT COURT OF NSW

PROCEEDINGS NO: 2022/00161509

DATED: 20 April 2023

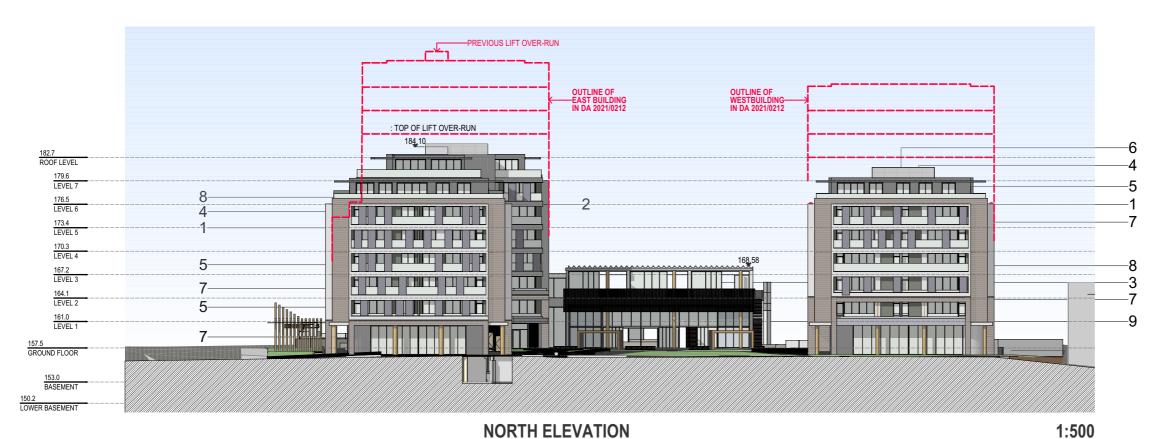

D S82A REVIEW 01.11.21
ISSUE REVISIONS DATE
PROJECT:

MIXED USE AND SENIORS LIVING
DEVELOPMENT - 82A REVIEW
5 Skyline Place Frenchs Forest NSW 2086


MATERIALS AND FINISHES

SP 49558


PASTUDDIO
LEVEL 2, 20 YOUNG ST. NEUTRAL BAY, NSW 2089
TEL: 8968 1900 FAX: 8968 1999 ACN: 603 389 288

NOMINATED ARCHITECT: GEORGE REVAY-REG#3954

SCALE:	AS SHOWN	DRAWING	
SUBSET:	MATERIALS & FINISHES	DA	501
DRAWN BY:	SU/WH/SP	ISSUE	D

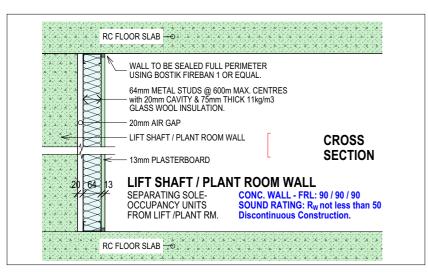


SOUND INSULATION DETAIL: LIFT/PLANT TO HABITABLE ROOM

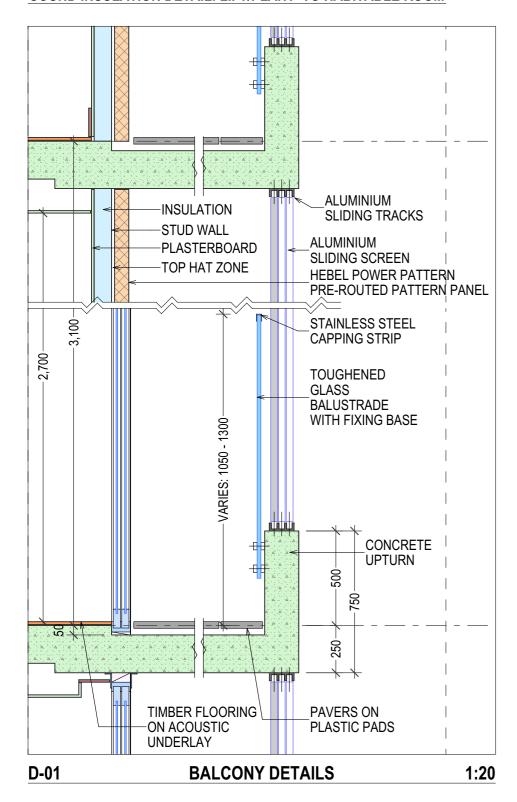





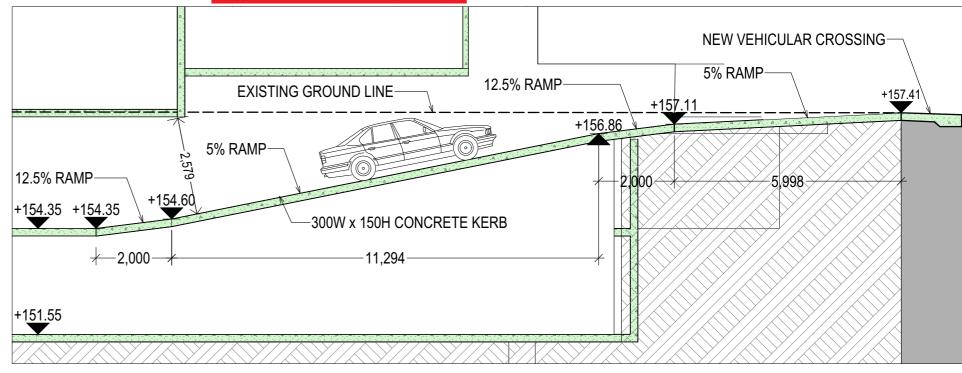

SECTION THROUGH CARPARK EXIT RAMP

Concrete Upturn

- eliminates feelings of vertigo when standing on balcony and
- hides untidy washing and pot plants from street

Balconies and Narrow Balconies to most rooms


- provide sun shading
- provide cover allowing windows and doors to be left open in light rain
- create additional impression of space by extending bedrooms
- allow for pots and landscape in front of most habitable rooms
- allow for convenient relocation and adjustment of sliding screens
- allow access for window cleaning (eliminating requirement for abseil access)

Sliding Screens

- provide shade from western and eastern sun
- will provide 60% shade factor
- when not required to provide shade, can be parked so they do not block aspect and views from within apartments
- are securely top hung to ensure they cannot fall out of tracks

Clear toughened Glass Balustrading

- will be 1.05m high above balcony floor on lower levels
- will be 1.3m high above balcony floor on upper levels (above level 6) to provide screening from wind.

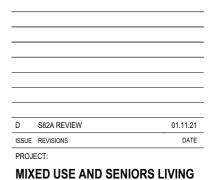

1:100

DEVELOPMENT - 82A REVIEW
5 Skyline Place Frenchs Forest NSW 2086
SP 49558


DETAILS & SECTION THROUGH EXIT RAMP





SCALE:	DE-P AHOSVAN	DRAWING	
SUBSET:	ACCESS RAMPS TO CARPARK	DA60	1
DRAWN BY:	SU/WH/SP	ISSUE	ס
FILE: BIM Server	: BIM21 - BIMcloud Basic for ARC	HICAD 21/SKY5 (LOT1)	82A





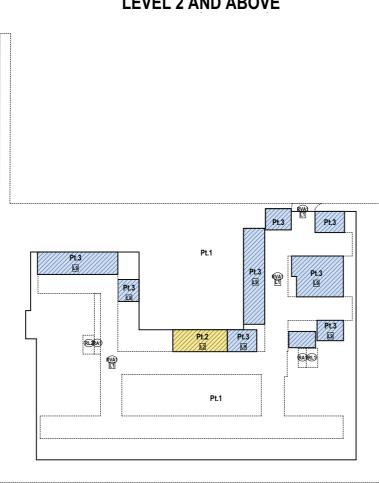

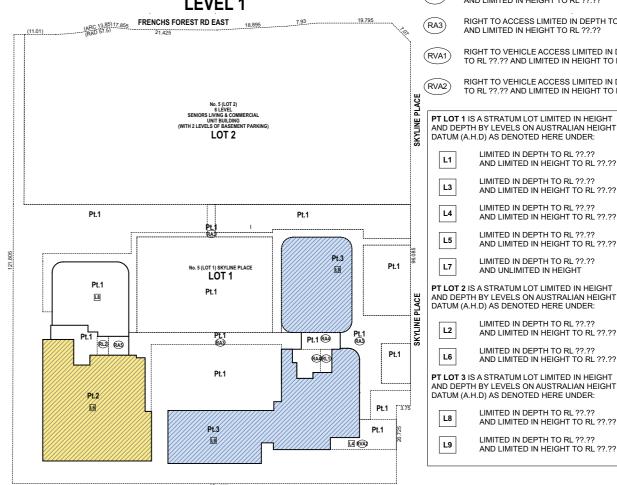

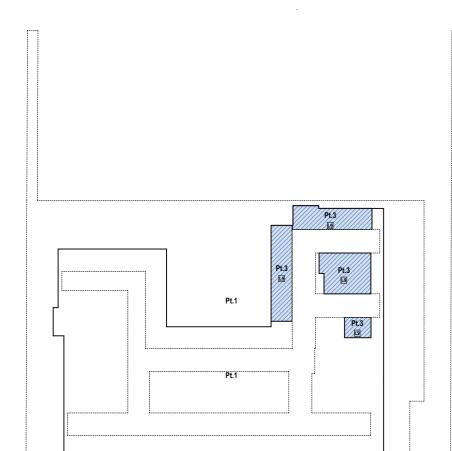

LOWER BASEMENT

BASEMENT

LOTS 1, 2 & 3 ARE STRATUM LOTS LIMITED IN HEIGHTS & DEPTH.

GROUND FLOOR

ARCHITECTS: PA STUDIO LEVEL 2, 20 YOUNG ST, NEUTRAL BAY NSW 2089 TEL: 8968 1900 FAX: 8968 1999

THE FOLLOWING NEW EASEMENTS AFFECT THE WHOLE OF LOTS: **EASEMENT FOR SHELTER AND SUPPORT** EASEMENT FOR SERVICES EASEMENT FOR EMERGENCY EGRESS

DRAFT STRATUM PLAN

Sheet No. 1 of 1

LOT 1 - SENIOR HOUSING

LOT 2 - DISABILITY AND AFFORDABLE LOT 3 - EMPLOYMENT GENERATING USES

RIGHT TO ACCESS LIMITED IN DEPTH TO RL ??.?? AND LIMITED IN HEIGHT TO RL??.??

RIGHT TO USE LIFT LIMITED IN DEPTH TO RL??.??

RIGHT TO ACCESS LIMITED IN DEPTH TO RL ??.??

RIGHT TO ACCESS LIMITED IN DEPTH TO RL ??.?? AND LIMITED IN HEIGHT TO RL ??.??

RIGHT TO ACCESS LIMITED IN DEPTH TO RL ??.??

RIGHT TO VEHICLE ACCESS LIMITED IN DEPTH TO RL \ref{RL} ??.?? AND LIMITED IN HEIGHT TO RL \ref{RL} ??.?? RIGHT TO VEHICLE ACCESS LIMITED IN DEPTH TO RL ??.?? AND LIMITED IN HEIGHT TO RL ??.??

RIGHT TO USE LIFT LIMITED IN DEPTH TO RL ??.??

RIGHT TO ACCESS LIMITED IN DEPTH TO RL \ref{loop} and limited in height to RL \ref{loop} ??.??

RIGHT TO ACCESS LIMITED IN DEPTH TO RL \ref{loop} and limited in height to RL \ref{loop} ??.??

RIGHT TO ACCESS LIMITED IN DEPTH TO RL ??.?? AND LIMITED IN HEIGHT TO RL ??.??

RIGHT TO VEHICLE ACCESS LIMITED IN DEPTH TO RL ??.?? AND LIMITED IN HEIGHT TO RL ??.??

RIGHT TO VEHICLE ACCESS LIMITED IN DEPTH TO RL ??.?? AND LIMITED IN HEIGHT TO RL ??.??

LIMITED IN DEPTH TO RL ??.?? AND LIMITED IN HEIGHT TO RL ??.?? LIMITED IN DEPTH TO RL ??.?? LIMITED IN DEPTH TO RL ??.??

LIMITED IN DEPTH TO RL ??.??
AND LIMITED IN HEIGHT TO RL ??.??

LIMITED IN DEPTH TO RL ??.?? AND UNLIMITED IN HEIGHT

LIMITED IN DEPTH TO RL ??.??

LIMITED IN DEPTH TO RL ??.?? AND LIMITED IN HEIGHT TO RL ??.??

LIMITED IN DEPTH TO RL ??.??

AND LIMITED IN HEIGHT TO RL ??.??

AND LIMITED IN HEIGHT TO RL ??.??

LIMITED IN DEPTH TO RL ??.??
AND LIMITED IN HEIGHT TO RL ??.??

PROPOSED EASEMENTS TO BENEFIT LOT 1

PROPOSED EASEMENTS TO BENEFIT LOT 2

AND LIMITED IN HEIGHT TO RL ??.??

PROPOSED EASEMENTS TO BENEFIT LOT 3

(RL1)

(RA1)

LOCATION & LOWER BASEMNT & BASEMENT & GROUND FLOOR & FIRST FLOOR PLANS

L5

DA218

01-03-23

BIM Server: BIM21 - BIMcloud Basic for ARCHICAD 21/SKY5 (LOT1) 82A NOTE: LOT LAYOUTS, DIMENSIONS, AREAS & EASEMENTS SUBJECT TO SURVEY