UNITS

JNIT	LEVEL	STUDIO 1 BED	1 BED + STUDY	2 BED	3 BED	BATH	ENS	ADPT.	UNIT AREA	BALCONY/ COURTYARD AREA	LIFT ACCESS	DIRECT SUNLIGHT	CROSS THROUGH VENTILATION	SINGLE ASPECT N	LIVING ROOM WIDTH	PARKING REQUIRED (PER UNIT	SPACES
01A	1								50.0m ²	8.0m ²					> 3.6m	1	1
)2A	1								50.5m ²	8.0m ²					3.6m	1	1
3A	1								68.6m ²	8.7/36.2m ²					> 4m	1	1
4A	1								56.3m ²	8.6/12.6m ²					3.6m	1	1
5A	11								97.7m ²	14.7/36.4m ²					> 4m	1.2	1.2
6A	11								91.4m ²	15.5m ²					4m	1.2	1.2
7A	11			_					58.6m ²	8.0m ²	_		_		> 4m	1	1
08A	1			■					84.9m ²	10.3m ²	■	_	_		4m	1.2	1.2
19A	1 .			_					90.6m ²	17.7m ²	_		_		> 4m	1.2	1.2
)1B	1		_			_=			90.7m ²	10.4/10.2m ²	■		-	_	> 4m	1.2	1.2
02B	1			_		_=	_		67.5m ²	10.6m ²	-	_			3.6m	1	1
03B	1								87.2m ²	16.1/85.5m ²					4.0m	1.2	1.2
01A - 301A	2-3								50.0m ²	8.0m ²					> 3.6 m2	1	1
2A - 302A	2-3								50.5m ²	8.0m ²			_		3.6m2	1	1
03A - 303A	2-3								67.6m ²	8.7m ²				_	> 4m2	1	1
4A - 304A	2-3			_			_		56.3m ²	9.7m ²	■	_	_		3.6m2	1	1
15A - 305A	2-3			=					101.2m ²		_		_	_	> 4m2	1.2	1.2
06A - 306A	2-3								91.4m ²	15.5m ²	=		•	=	4 m2	1.2	1.2
07A - 307A	2-3			_		_=	_		58.6m ²	8.0m ²					> 3.6m2		1.2
98A - 308A 99A - 309A	2-3			=			=		84.9m ² 90.6m ²	10.3m ² 10.0m ²		_			4m2 > 4m2	1.2	1.2
01B - 301B	2-3			=		-	-		99.8m ²	10.0m ²			=		> 4m2	1.2	1.2
02B - 302B	2-3			_			_		67.8m ²	10.4m ²		_			3.6m2	1	1
3B - 303B	2-3								87.2m ²	10.0m ²					4.0m2	1.2	1.2
11A	4								50.0m ²	12.8m ²					> 4m2	1	1
)2A	4								63.3m ²	8.0m ²					> 4m2	1	1
)3A	4								55.0m ²	9.7m ²	_	_	_		3.6m2	1	1
)4A	4								55.1m ²	8.1m ²			_		> 4m2	1	1
05A	4			■_			_		70.6m ²	21.0m ²	■				> 4m2	1.2	1.2
06A	4				_				74.0m ²	24.5m ²	_	_	_		> 4m2	1.2	1.2
07A	4			_		-			106.1m ²		-	-	-		> 4m2	1.5	1.5
01B 02B	4					_=			86.7m ² 59.0m ²	10.4m ²	=				> 4m2 > 4 m2	1.2	1.2
03B	4					-			40.9m ²	6.7m ²			=		> 4 m2	1	1
											_	_	_				
01A - 601A	5 - 6								50.1m ²	8.1m ²					> 3.6m2	1	1
2A - 602A 3A - 603A	5-6 5-6							_	60.8m ² 55.0m ²	9.0m ² 9.7m ²	-	_		_	> 4m2	1	1
						_					_	_			3.6m2		
4A - 604A 5A - 605A	5-6 5-6			_		_=			55.1m ² 70.9m ²	8.1m ² 10.4m ²				_	> 4m2 > 4m2	1.2	1.2
6A - 606A	5-6			_		-=-			52.6m ²	9.0m ²	-		-	-	3.6m	1.2	1.2
7A - 607A	5-6	_		_		-	_		83.1m ²	10.0m ²	-		=	-	> 4m2	1.2	1.2
18A - 608A	5-6								90.6m ²	10.0m ²				_	> 4m2	1.2	1.2
1B - 601B	5-6			=		=	=		77.2m ²	10.1m ²	=	=			4m2	1.2	1.2
02B - 602B	5-6			_					54.7m ²	8.4m ²		=			3.6m2	1	1
03B - 603B	5-6								40.1m ²	6.7m ²					> 3.6m2	1	1
							_										
11A	7									2 12.5m ²	_			_	> 4m2	1.5	1.5
2A	7								53.6m ²	9.7m ²	_	_	_		>3.6m2	1	1
3A	7								54.1m ²	8.1m ²			_	_	> 3.6m2	1	1
14A	7								55.0m ²		_		_		> 4m2	1	1
05A	7			_		-	_		52.6m ²	9.0m ²	=			=	>3.6m2	1	1
06A	<u> </u>						-5-		83.1m ²	10.0m ²		_			> 3.6m2	1.2	1.2
07A 01B	7 7			=					90.6m ² 73.1m ²	10.0m ² 10.1m ²		-	=		> 4m2 > 4m2	1.2	1.2
12B	7								73.1m ²	8.4m ²		-			> 4m2 3.6 m2	1.2	1.2
2B 3B	7								54.7m ²	6.7m ²	=	-			> 3.6 m2 > 3.6m2	1	1
	'								40. IIII	J.7111	_	_			> 0.0IIIZ		

RETAIL

RETAIL SPACE	AREA	STORAGE AREA	PARKING REQUIRED	PARKING PROVIDE
1	60.5m2	25.0m2		
2	73.1m2	24.4m2		
3	73.3m2	27.1m2		
4	27.7m2	9.5m2		
5	47.3m2	14.4m2		
6	44.9m2	14.2m2	1 space per	
7	43.5m2	14.4m2	16.4m2 GLFA	
8	43.5m2	14.4m2	OLITA	
9	43.5m2	14.4m2		
10	43.5m2	11.5m2		
11	51.4m2	12.9m2		
12	60.9m2	8.8m2		
TOTAL	615.1m2		37.5 (622.1/16.4) 38

Damian OToole 8.2 29 Apr 2019 NATIONWIDE HOUSE SOAKS AVE DEE WHY, NSW 24.3 MJ/m²



PARKING

REQUIRED 58 16 38 3 115 PROVIDED 77 16 38 3 134		UNITS	UNIT VISITOR	RETAIL	CARSHARE	TOTAL
PROVIDED 77 16 38 3 134	REQUIRED	58	16	38	3	115
110 00 0	PROVIDED	77	16	38	3	134

Ass	essor#	20420	Cei	rtificate#	000335	7233		Issued	: 29041	.9
			Thern	nal Perform	ance Si	ecification	s			
These are the Specifications upon which the Certified Asses specifications, these Specifications shall take precedence. It all instances of that element for the project. If alternate spec				essment is based. If only one specif	. If details in ication optio	cluded in these S _i n is detailed for a	pecification: building ele	ement, that sp	ecification m	ust apply
				nced documents						
Windows	Product i	D Gla	ss	Frame		U value	SHGC	Area M²	Detail	
Single glazed		Cle	ar	Aluminium		7.63	0.75		As per plan	S
Single glazed		Lov	е	Aluminium		5.60	0.41		Western fa	cade
Skylights	Product	D Gla	ss	Frame		U value	SHGC	Area M²	Detail	
lower, and the S	HGC value is l	ess than 10	% higher or lov	according to ANA ver, than the U and	SHGC valu	es of the product			ised if their U	value is
External wall		struction	Insulation	Colour – so		Detail				
Cavity brick/F	ramed		R2.0	Medium and	d dark	As per plans				
Internal walls	Cons	struction	Insulation	Detail						
Plasterboard			None	As per plan	s. Within u	nits				
Hebel/Plaster	ooard		None	As per plan Between ur						
Floors	Cons	struction	Insulation	Covering		Detail				
Concrete			None	Varies		As per plans	Lower lev	rel		
Framed			None	Varies		As per plans.	Upper lev	rel		
Ceilings	Cons	truction	Insulation	Detail						
Plasterboard			R2.5	As per plan	S					
Roof	Cons	struction	Insulation	Colour - so	ılar abs.	Detail				
Metal			R1.5	Dark		As per plans				
Concrete			R1.0	Dark		As per plans				
Window cove	r Inter	nal (curtaiı	is)		Extern	nal (awnings, sl	hutters, et	c)		
As plans					-					
Fixed shadin	g Eave		inc. gutters,	h't above	Locati	on				
	As plans – eaves /soffits				As pla	ns – eaves/sol	fits/louvre	s as shown		
Overshadow	ng C	vershadov	ving structur	9S	Overs	hadowing trees	3			
NA										
Orientation, I	Exposure V	entilation	and Infiltrat	ion						
Orientation of				ring area open to	o entry:	Y		entilated sk		N
Terrain catego	ory:	Suburban	Do	ors separate liv	ing areas:	N		pen fire, un eat:	flued gas	N
Roof ventilation	n:	Unventilat	ed Sta	air open to heate	ed areas:	N	V	ented down	lights:	N
Cross ventilat	on:	Standard	Se	als to windows	and doors	Y	W	all and ceil	ing vents:	N
	ross ventilation: Standard Subfloor: Conditioned									

ALL DIMENSIONS & LEVELS TO BE CHECKED ON SITE BY CONTRACTOR PRIOR TO CONSTRUCTION ALL BOUNDARIES & CONTOURS SUBJECT TO SURVEY ALL RIGHTS RESEVED. THIS DRAWING JUAY NOT BE REPRODUCED OR TRANSMITTED, IN PART OR IN WHOLE WITHOUT THE PERMISSION OF GRAWFORD ARCHITECTS FYL LTD

© CRAWFORD ARCHITECTS PTY LTD 2017 SUITE 3.01, LEVEL 3 80 MOUNT STREET NORTH SYDNEY, NSW 2060 AUSTRALIA ABN 56 120 779 106 NOMINATED ARCHITECTS: TONY GRAY 5303 & PAUL GODSELL 6726

DEVELOPMENTLINK

MIXED USE DEVELOPMENT LOTS 1,2,3,4 - D.P.9900 8 OAKS AVENUE, DEE WHY NSW 2099





Schedule of BASIX commitments

The commitments set out below regulate how the proposed development is to be carried out. It is a condition of any development consent granted, or complying development certificate issued, for the proposed development, that BASIX commitments be complied with.

1. Commitments for Residential flat buildings - RFB

(i) Water	Show on DA plans	Show on CC/CDC plans & specs	Certifier check
(a) The applicant must comply with the commitments listed below in carrying out the development of a dwelling listed in a table below.			
(b) The applicant must plant indigenous or low water use species of vegetation throughout the area of land specified for the dwelling in the "Indigenous species" column of the table below, as private landscaping for that dwelling. (This area of indigenous vegetation is to be contained within the "Area of garden and lawn" for the dwelling specified in the "Description of Project" table).	~	~	
(c) If a rating is specified in the table below for a fixture or appliance to be installed in the dwelling, the applicant must ensure that each such fixture and appliance meets the rating specified for it.		~	V
(d) The applicant must install an on demand hot water recirculation system which regulates all hot water use throughout the dwelling, where indicated for a dwelling in the "HW recirculation or diversion" column of the table below.		~	V
(e) The applicant must install:			
(aa) a hot water diversion system to all showers, kitchen sinks and all basins in the dwelling, where indicated for a dwelling in the "HW recirculation or diversion" column of the table below; and		~	v
(bb) a separate diversion tank (or tanks) connected to the hot water diversion systems of at least 100 litres. The applicant must connect the hot water diversion tank to all toilets in the dwelling.		~	V
(e) The applicant must not install a private swimming pool or spa for the dwelling, with a volume exceeding that specified for it in the table below.	~	V	
(f) If specified in the table, that pool or spa (or both) must have a pool cover or shading (or both).		~	
(g) The pool or spa must be located as specified in the table.	V	V	
(h) The applicant must install, for the dwelling, each alternative water supply system, with the specified size, listed for that dwelling in the table below. Each system must be configured to collect run-off from the areas specified (excluding any area which supplies any other alternative water supply system), and to divert overflow as specified. Each system must be connected as specified.	~	~	~

(ii) Energy	Show on DA plans	Show on CC/CDC plans & specs	Certifier check
(f) This commitment applies to each room or area of the dwelling which is referred to in a heading to the "Natural lighting" column of the table below (but only to the extent specified for that room or area). The applicant must ensure that each such room or area is fitted with a window and/or skylight.	~	~	~
(g) This commitment applies if the applicant installs a water heating system for the dwelling's pool or spa. The applicant must:			
(aa) install the system specified for the pool in the "Individual Pool" column of the table below (or alternatively must not install any system for the pool). If specified, the applicant must install a timer, to control the pool's pump; and		~	
(bb) install the system specified for the spa in the "Individual Spa" column of the table below (or alternatively must not install any system for the spa). If specified, the applicant must install a timer to control the spa's pump.		~	
(h) The applicant must install in the dwelling:			
(aa) the kitchen cook-top and oven specified for that dwelling in the "Appliances & other efficiency measures" column of the table below;		~	
(bb) each appliance for which a rating is specified for that dwelling in the "Appliances & other efficiency measures" column of the table, and ensure that the appliance has that minimum rating; and		V	
(cc) any clothes drying line specified for the dwelling in the "Appliances & other efficiency measures" column of the table.		~	
(i) If specified in the table, the applicant must carry out the development so that each refrigerator space in the dwelling is "well ventilated".		~	

	Hot water	Bathroom ver	itilation system	Kitchen ve	ntilation system	Laundry ve	entilation system
Dwelling no.	Hot water system	Each bathroom	Operation control	Each kitchen	Operation control	Each laundry	Operation control
All dwellings	gas instantaneous 5 star	individual fan, ducted to façade or roof	manual switch on/off	individual fan, not ducted	manual switch on/off	individual fan, not ducted	manual switch on/off

iii) Thermal Comfort	Show on DA plans	Show on CC/CDC plans & specs	Certifier check
(c) The details of the proposed development on the Assessor Certificate must be consistent with the details shown in this BASIX Certificate, including the details shown in the "Thermal Loads" table below.			
(d) The applicant must show on the plans accompanying the development application for the proposed development, all matters which the Thermal Comfort Protocol requires to be shown on those plans. Those plans must bear a stamp of endorsement from the Accredited Assessor, to certify that this is the case.	V		
(e) The applicant must show on the plans accompanying the application for a construction certificate (or complying development certificate, if applicable), all thermal performance specifications set out in the Assessor Certificate, and all aspects of the proposed development which were used to calculate those specifications.		~	
(f) The applicant must construct the development in accordance with all thermal performance specifications set out in the Assessor Certificate, and in accordance with those aspects of the development application or application for a complying development certificate which were used to calculate those specifications.		~	V
(g) Where there is an in-slab heating or cooling system, the applicant must:	V	V	~
(aa) Install insulation with an R-value of not less than 1.0 around the vertical edges of the perimeter of the slab; or			
(bb) On a suspended floor, install insulation with an R-value of not less than 1.0 underneath the slab and around the vertical edges of the perimeter of the slab.			
(h) The applicant must construct the floors and walls of the development in accordance with the specifications listed in the table below.	~	~	~

	Thermal loads									
Dwelling no.	Area adjusted heating load (in mJ/m²/yr)	Area adjusted cooling load (in mJ/m²/yr)								
401A	3.0	22.0								
401B	9.0	22.0								
403B	7.0	14.0								
406A	30.0	15.0								
407A	20.0	12.0								
504A	5.0	14.0								
701A	5.0	22.0								
701B	9.0	21.0								
702B	3.0	26.0								

		Thermal loads
Dwelling no.	Area adjusted heating load (in mJ/m²/yr)	Area adjusted cooling load (in mJ/m²/yr)
706A	27.0	14.0
707A	22.0	12.0
501A, 601A	3.0	21.0
501B, 601B	8.0	21.0
502A, 602A	11.0	23.0
507A, 607A	23.0	12.0
508A, 608A	5.0	19.0
101A, 201A, 301A	4.0	23.0
101B, 201B, 301B	8.0	20.0
102A, 202A, 302A	4.0	21.0
102B, 202B, 302B	24.0	24.0
108A, 208A, 308A	24.0	12.0
109A, 209A, 309A	6.0	21.0
103A, 203A, 303A, 402A	9.0	23.0
402B, 502B, 602B, 702A	22.0	24.0
107A, 207A, 307A, 506A, 606A	29.0	15.0
103B, 203B, 303B, 503B, 603B, 703B	6.0	14.0
105A, 205A, 305A, 404A, 604A, 704A	5.0	17.0
104A, 204A, 304A, 403A, 503A, 603A, 703A	3.0	20.0
All other dwellings	11.0	16.0

	Fixtures					Appli	ances	Individual pool Ind			idividual spa			
Dwelling no.	All shower- heads	All toilet flushing systems	kitchen	All bathroom taps		All clothes washers	All dish- washers	Volume (max volume)	Pool cover	Pool location	Pool shaded	Volume (max volume)	Spa cover	Spa shaded
All dwellings	3 star (> 6 but <= 7.5 L/min)	4 star	5 star	5 star	-	*	5 star	-	-	je	e,	l=	=	141

ı				Alternative water sou	ce						
		Alternative water supply systems	Size	Configuration	Landscape connection	Toilet connection (s)		Pool top-up	Spa top-up		
	None	-	9	2-2	9	-	-	5	-		

(ii) Energy	Show on DA plans	Show on CC/CDC plans & specs	Certifier check
(a) The applicant must comply with the commitments listed below in carrying out the development of a dwelling listed in a table below.			
(b) The applicant must install each hot water system specified for the dwelling in the table below, so that the dwelling's hot water is supplied by that system. If the table specifies a central hot water system for the dwelling, then the applicant must connect that central system to the dwelling, so that the dwelling's hot water is supplied by that central system.	~	V	V
(c) The applicant must install, in each bathroom, kitchen and laundry of the dwelling, the ventilation system specified for that room in the table below. Each such ventilation system must have the operation control specified for it in the table.		~	V
(d) The applicant must install the cooling and heating system's specified for the dwelling under the "Living areas" and "Bedroom areas" headings of the "Cooling" and "Heating" columns in the table below, infor at least 1 living/bedroom areas of the dwelling. If no cooling or heating system is specified in the table for "Living areas" or "Bedroom areas"; then no systems may be installed in any such areas. If the term "zoned" is specified beside an air conditioning system, then the system must provide for day/night zoning between Iving areas and bedrooms.		~	v
(e) This commitment applies to each room or area of the dwelling which is referred to in a heading to the "Artificial lighting" column of the table below (but only to the extent specified for that room or area. The applicant must ensure that the "primary type of artificial lighting" for each such room in the dwelling is fluorescent lighting or light emitting diode (LED) lighting. If the term "dedicated" is specified for a particular room or area, then the light fittings in that room or area must only be capable of being used for fluorescent lighting or light rentiting diode (LED) lighting.		•	~

	Coo	ling	Hea	ting			Artificial	lighting			Natural lig	ghting
Dwellinç no.	living areas	bedroom areas	living areas	bedroom areas	No. of bedrooms &/or study	No. of living &/or dining rooms	Each kitchen	All bathrooms/ toilets	Each laundry	All hallways	No. of bathrooms &/or toilets	Main kitcher
101A, 102A, 102B, 104A, 302B, 402B, 502B, 602B, 702B	ceiling fans + 1-phase airconditioning EER 3.0 - 3.5	-	1-phase airconditioning EER 3.0 - 3.5		1	1	yes	yes	yes	yes	0	yes
All other dwellings	1-phase airconditioning EER 3.0 - 3.5	6 5 3	1-phase airconditioning EER 3.0 - 3.5	25	1	1	yes	yes	yes	yes	0	yes

	Individual pool Individual spa			Appliances & other efficiency measures								
Dwelling no.	Pool heating system	Timer	Spa heating system	Timer	Kitchen cooktop/oven	Refrigerator	Well ventilated fridge space	Dishwasher	Clothes washer	Clothes dryer	Indoor or sheltered clothes drying line	Private outdoor or unsheltered clothes drying line
All dwellings	-	-	-	-	gas cooktop & electric oven	-	(=)	4 star	-	2 star	-	

(iii) Thermal Comfort	Show on DA plans	Show on CC/CDC plans & specs	Certifier check
(a) The applicant must attach the certificate referred to under "Assessor details" on the front page of this BASIX certificate (the "Assessor Certificate") to the development application and construction certificate application for the proposed development (or, if the applicant is applying for a complying development certificate for the proposed development, to that applicant). The applicant must also attach the Assessor Certificate to the application for a final occupation certificate for the proposed development.			
(b) The Assessor Certificate must have been issued by an Accredited Assessor in accordance with the Thermal Comfort Protocol.			

ALL DIMENSIONS & LEVELS TO BE CHECKED ON SITE BY
CONTRACTOR PRIOR TO CONSTRUCTION ALL BOUNDARIES &
SUITE 301, LEVEL 3 80 MOUNT STREET
SOUTHOURS SUBJECT TO SURVEY, LAL RICHETS RESERVED. THIS
DRAWING MAY NOT BE REPRODUCED OR TRANSMITTED, IN PART
OR IN WHOLE WITHOUT THE PERMISSION OF CRAWFORD
ARCHITECTS PYL I'LD

ON ORAN 1503 G FAUL CODSELL 5726
TONY GRAY 503 G FAUL CODSELL 5726
TONY GRAY 503 G FAUL CODSELL 5726

DEVELOPMENTLINK

MIXED USE DEVELOPMENT LOTS 1,2,3,4 - D.P.9900 8 OAKS AVENUE, DEE WHY NSW 2099



APPROVED PG DRAWN MT CHECKED - DATE NOV 2018 STATUS DA



(b) Common areas and central systems/facilities

(i) Water	Show on DA plans	Show on CC/CDC plans & specs	Certifie check
(a) If, in carrying out the development, the applicant installs a showerhead, toilet, tap or clothes washer into a common area, then that item must meet the specifications listed for it in the table.		~	V
(b) The applicant must install (or ensure that the development is serviced by) the alternative water supply system(s) specified in the "Central systems" column of the table below. In each case, the system must be sized, be configured, and be connected, as specified in the table.	~	~	-
(c) A swimming pool or spa listed in the table must not have a volume (in kLs) greater than that specified for the pool or spa in the table.	V	V	
(d) A pool or spa listed in the table must have a cover or shading if specified for the pool or spa in the table.		~	
(e) The applicant must install each fire sprinkler system listed in the table so that the system is configured as specified in the table.		~	V
(f) The applicant must ensure that the central cooling system for a cooling tower is configured as specified in the table.		V	V

Common area	Showerheads rating	Toilets rating	Taps rating	Clothes washers rating
All common areas	no common facility	4 star	4 star	no common laundry facility

ii) Energy	Show on DA plans	Show on CC/CDC plans & specs	Certifier check
(a) If, in carrying out the development, the applicant installs a ventilation system to service a common area specified in the table below, then that ventilation system must be of the type specified for that common area, and must meet the efficiency measure specified.		~	~
(b) In carrying out the development, the applicant must install, as the "primary type of artificial lighting" for each common area specified in the table below, the lighting specified for that common area. This lighting must meet the efficiency measure specified. The applicant must also install a centralised lighting control system or Building Management System (BMS) for the common area, where specified.		~	V
(c) The applicant must install the systems and fixtures specified in the "Central energy systems" column of the table below. In each case, the system or fixture must be of the type, and meet the specifications, listed for it in the table.	V	~	V

	Common area	ventilation system	Common area lighting				
Common area	Ventilation system type	Ventilation efficiency measure	Primary type of artificial lighting	Lighting efficiency measure	Lighting control system/BMS		
Car park area	ventilation (supply + exhaust)	carbon monoxide monitor + 2-speed fan	fluorescent	motion sensors	No		
Lift car (No.1)	1.	(m)	compact fluorescent	connected to lift call button	No		
Lift car (No.2)		9	compact fluorescent	connected to lift call button	No		
Garbage room	ventilation supply only	80	fluorescent	motion sensors	No		
Plant or service room	ventilation supply only	thermostatically controlled	fluorescent	manual on / manual off	No		
Storage	no mechanical ventilation	-	fluorescent	manual on / manual off	No		
Ground floor lobby type	ventilation supply only	time clock or BMS controlled	compact fluorescent	motion sensors	No		
Hallway/lobby type	ventilation supply only	time clock or BMS controlled	compact fluorescent	motion sensors	No		

Central energy systems	Туре	Specification
Lift (No. 1)	gearless traction with V V V F motor	Number of levels (including basement): 12
Lift (No. 2)	gearless traction with V V V F motor	Number of levels (including basement): 12

4. Commitments for common areas and central systems/facilities for the development (non-building specific)

(b) Common areas and central systems/facilities

(i) Water	Show on DA plans	Show on CC/CDC plans & specs	Certifier check
(a) If, in carrying out the development, the applicant installs a showerhead, toilet, tap or clothes washer into a common area, then that item must meet the specifications listed for it in the table.		V	v
(b) The applicant must install (or ensure that the development is serviced by) the alternative water supply system(s) specified in the "Central systems" column of the table below. In each case, the system must be sized, be configured, and be connected, as specified in the table.	~	~	~
(c) A swimming pool or spa listed in the table must not have a volume (in kLs) greater than that specified for the pool or spa in the table.	~	~	
(d) A pool or spa listed in the table must have a cover or shading if specified for the pool or spa in the table.		~	
(e) The applicant must install each fire sprinkler system listed in the table so that the system is configured as specified in the table.		~	V
(f) The applicant must ensure that the central cooling system for a cooling tower is configured as specified in the table.		~	-

All common no common facility 4 star 4 star no common laundry facility areas	Common area	Showerheads rating	Toilets rating	Taps rating	Clothes washers rating
	All common areas	no common facility	4 star	4 star	no common laundry facility

(ii) Energy	Show on DA plans	Show on CC/CDC plans & specs	Certifier check
(a) If, in carrying out the development, the applicant installs a ventilation system to service a common area specified in the table below, then that ventilation system must be of the type specified for that common area, and must meet the efficiency measure specified.		~	V
(b) In carrying out the development, the applicant must install, as the "primary type of artificial lighting" for each common area specified in the table below, the lighting specified for that common area. This lighting must meet the efficiency measure specified. The applicant must also install a centralised lighting control system or Building Management System (BMS) for the common area, where specified.		~	~
(c) The applicant must install the systems and fixtures specified in the "Central energy systems" column of the table below. In each case, the system or fixture must be of the type, and meet the specifications, listed for it in the table.	~	~	V

Notes

The state of the s
2. The applicant must identify each dwelling, building and common area listed in this certificate, on the plans accompanying any development application, and on the plans and specifications accompanying the application for a construction certificate / complying development certificate, for the proposed development, using the same identifying letter or reference as is given to that dwelling, building or common area in this certificate.
3. This note applies if the proposed development involves the erection of a building for both residential and non-residential purposes (or the change of use of a building for both residential and non-residential purposes). Commitments in this certificate which are specified to apply to a "common area" of a building or the development, apply only to that part of the building or development to be used for residential purposes.

- 4. If this certificate lists a central system as a commitment for a dwelling or building, and that system will also service any other dwelling or building within the development, then that system need only be installed once (even if it is separately listed as a commitment for that other dwelling or building).
- If a star or other rating is specified in a commitment, this is a minimum rating.
- 6. All alternative water systems to be installed under these commitments (if any), must be installed in accordance with the requirements of all applicable regulatory authorities. NOTE: NSW Health does not recommend that stormwater, recycled water or private dam water be used to irrigate edible plants which are consumed raw, or that rainwater be used for human consumption in areas with potable water supply.

Legend

- 1. Commitments identified with a 💓 in the "Show on DA plans" column must be shown on the plans accompanying the development application for the proposed development (if a development application is to be lodged for the proposed development).
- 2. Commitments identified with a " " in the "Show on CC/CDC plans and specs" column must be shown in the plans and specifications accompanying the application for a construction
- certificate / complying development certificate for the proposed development.

 3. Commitments identified with a "__ in the "Certifier check" column must be certified by a certifying authority as having been fulfilled. (Note: a certifying authority must not issue an occupation certificate (either interim or final) for a building listed in this certificate, or for any part of such a building, unless it is satisfied that each of the commitments whose fulfillment it is required to monitor in relation to the building or part, has been fulfilled).

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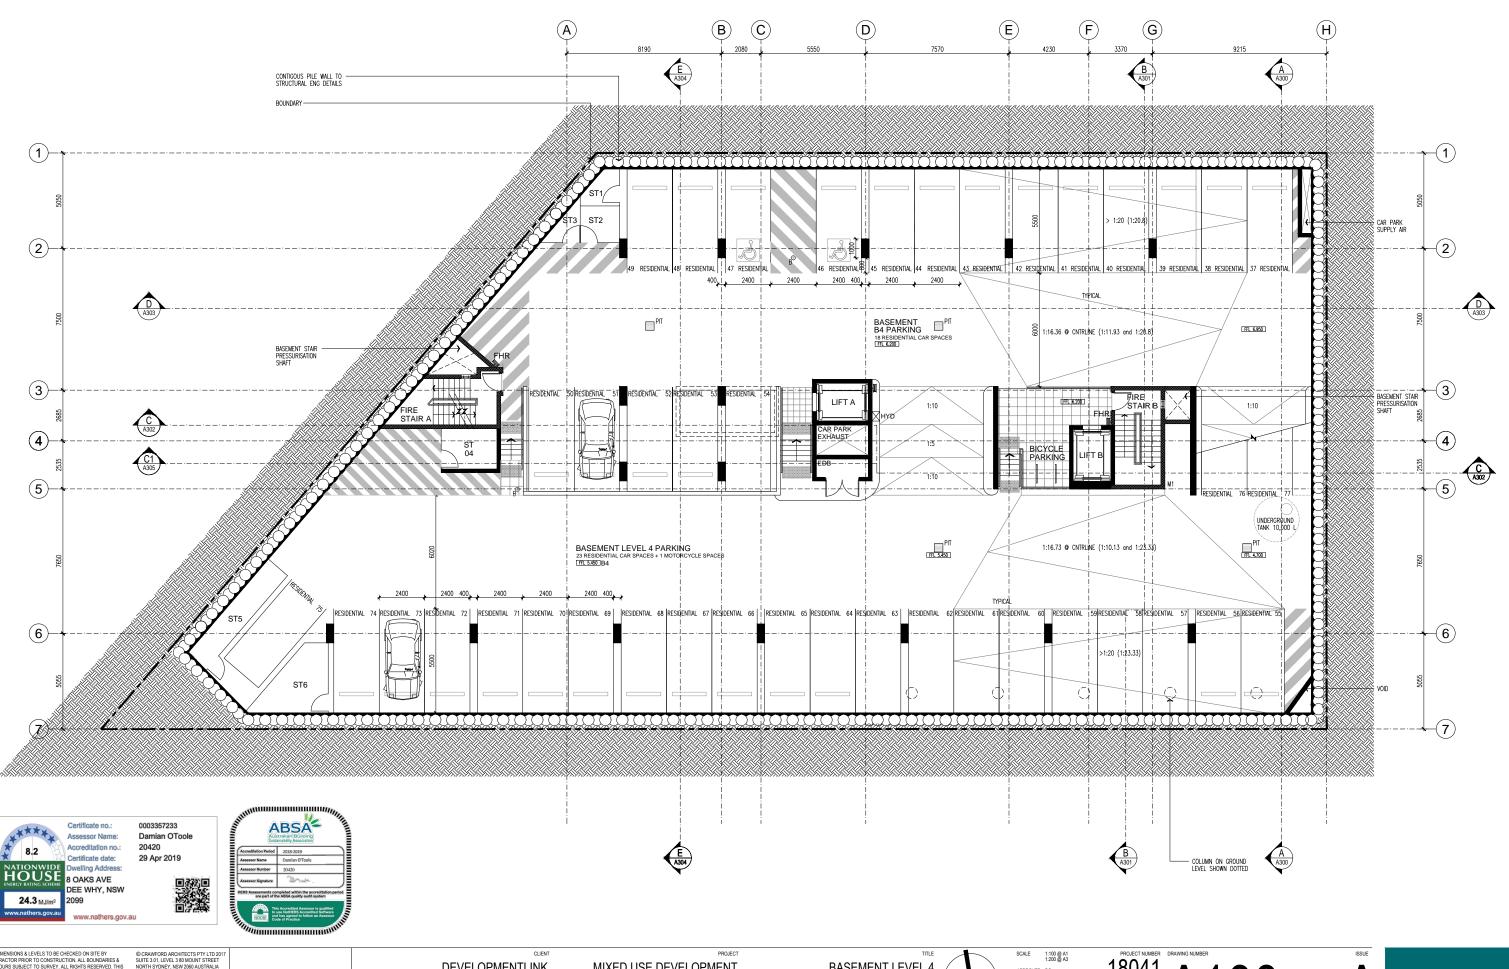
DEVELOPMENTLINK

MIXED USE DEVELOPMENT LOTS 1,2,3,4 - D.P.9900 8 OAKS AVENUE, DEE WHY NSW 2099



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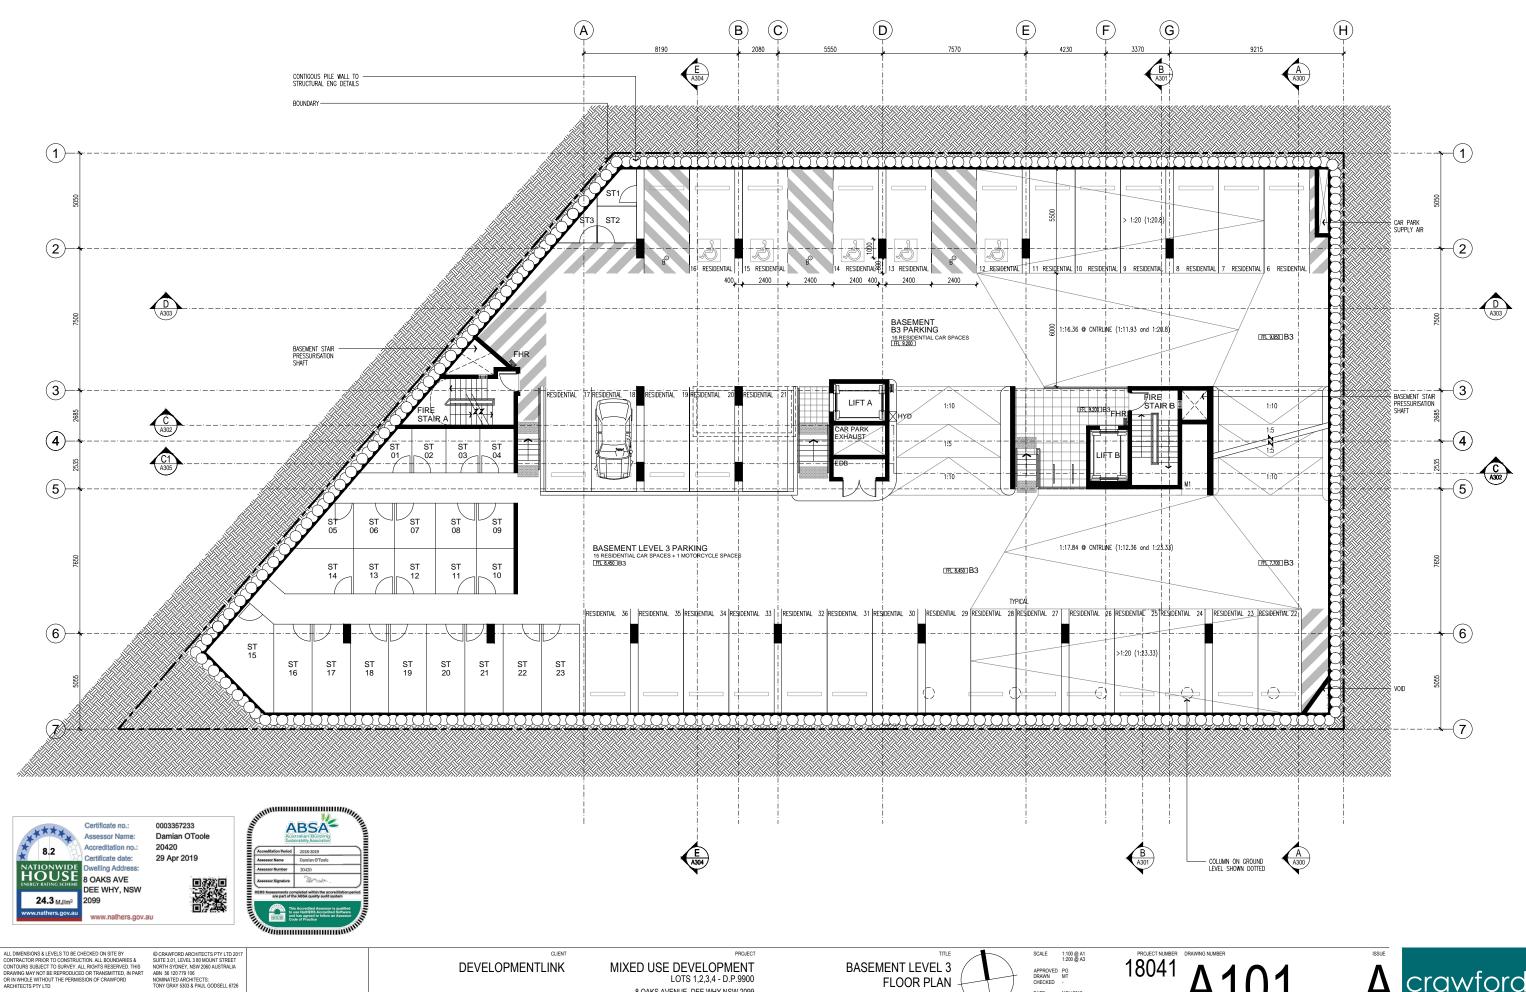
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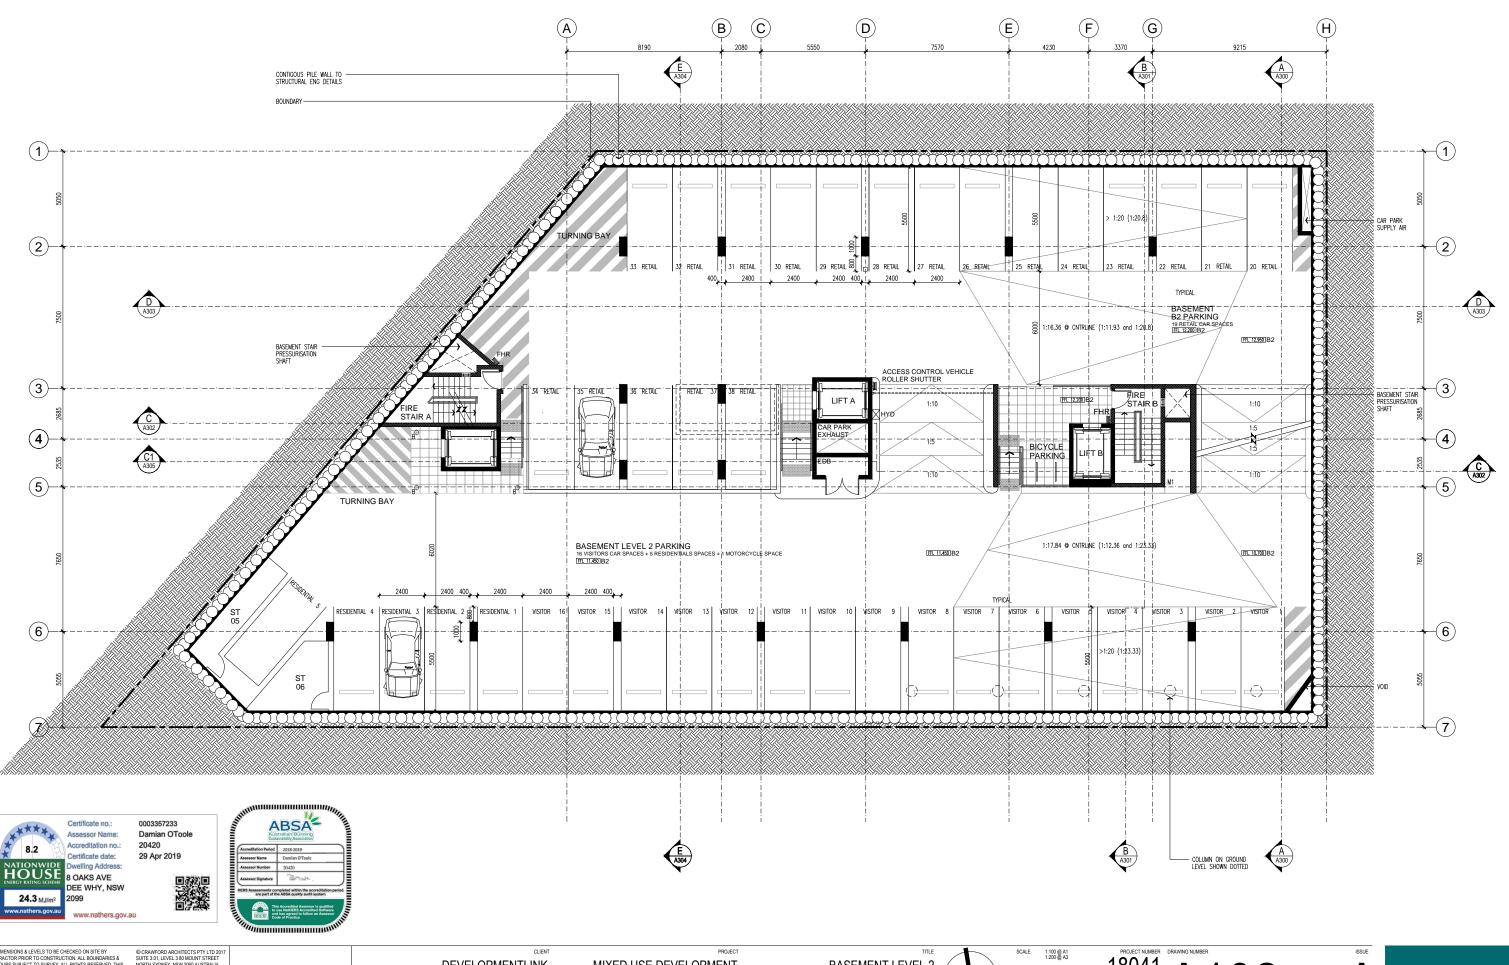
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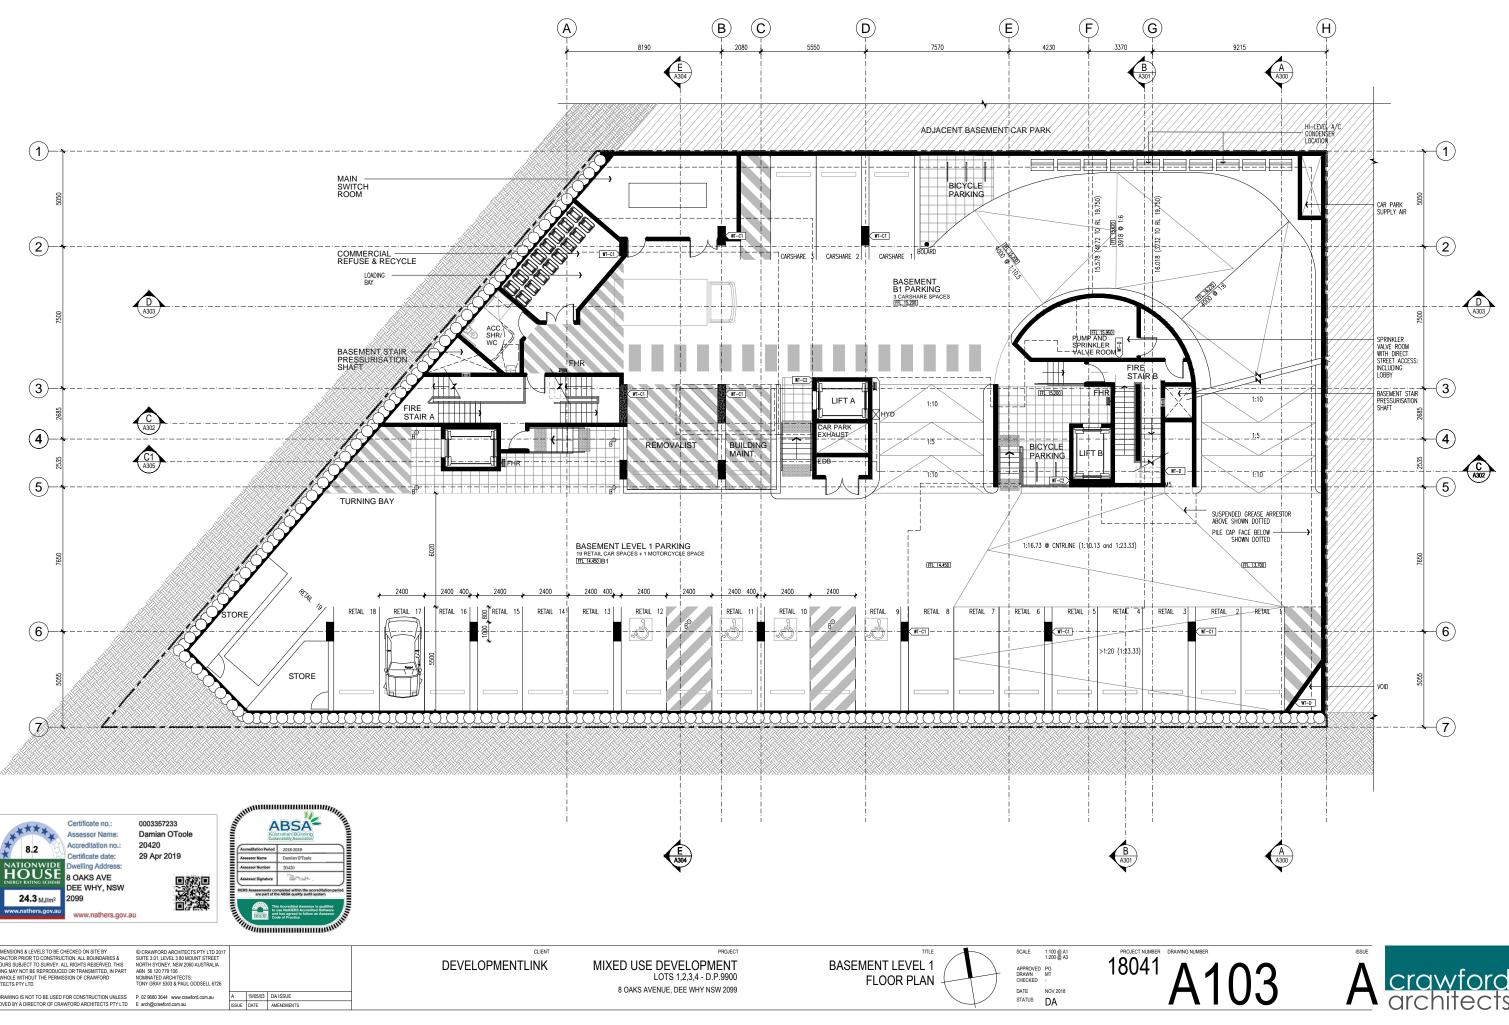
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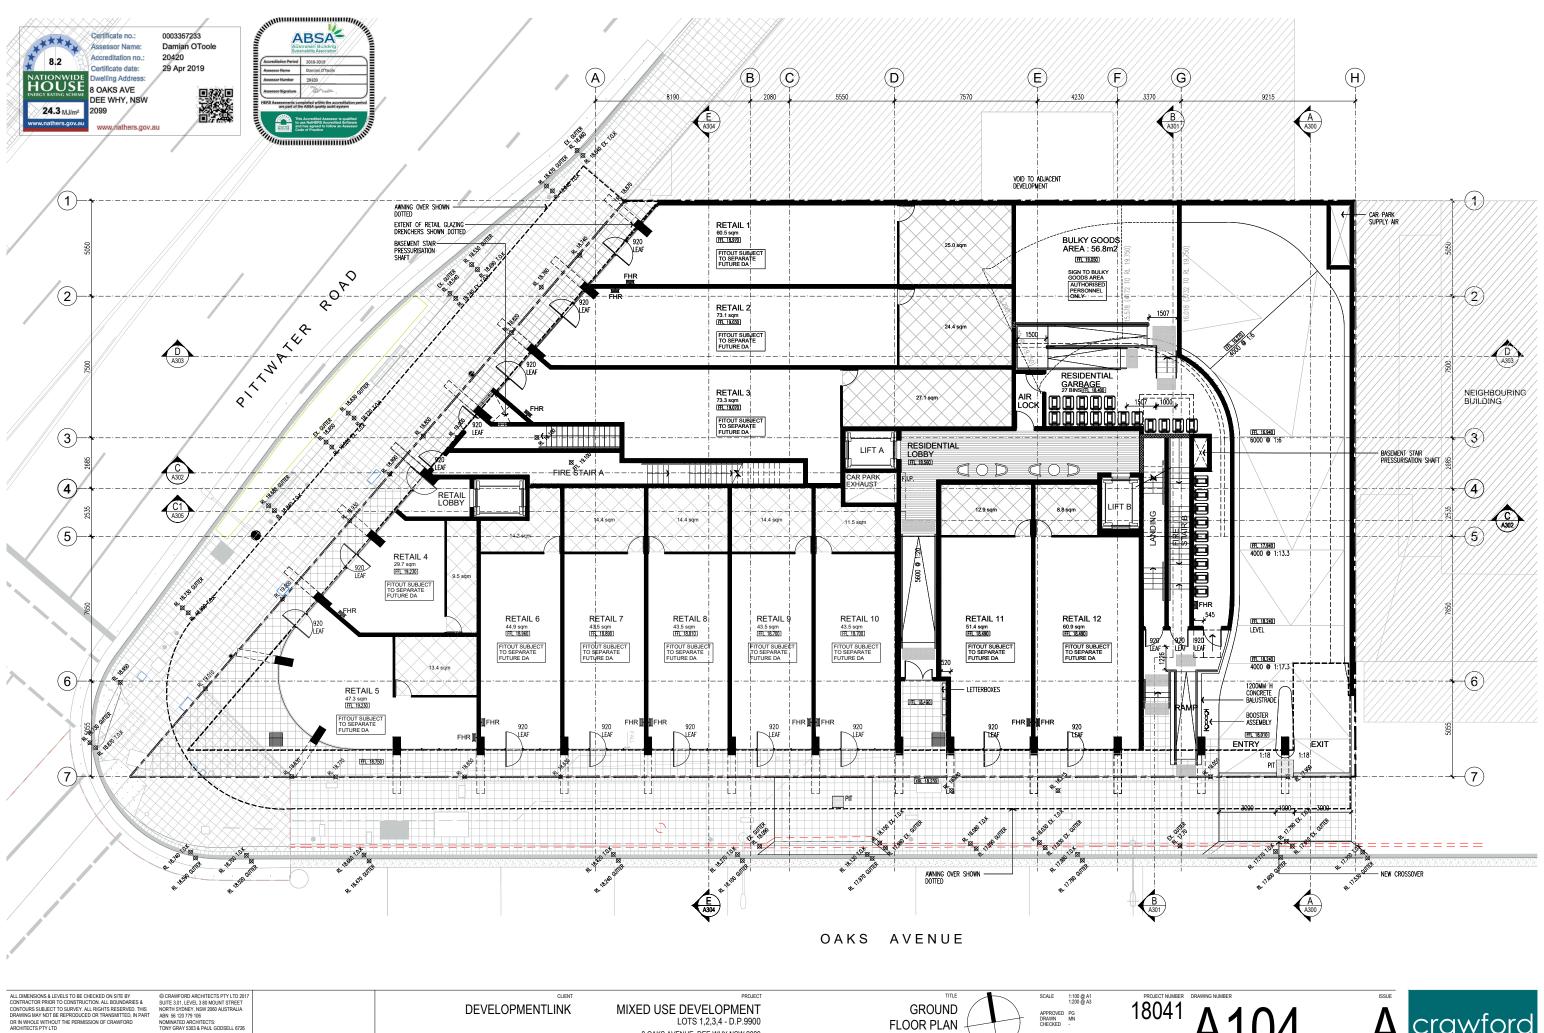
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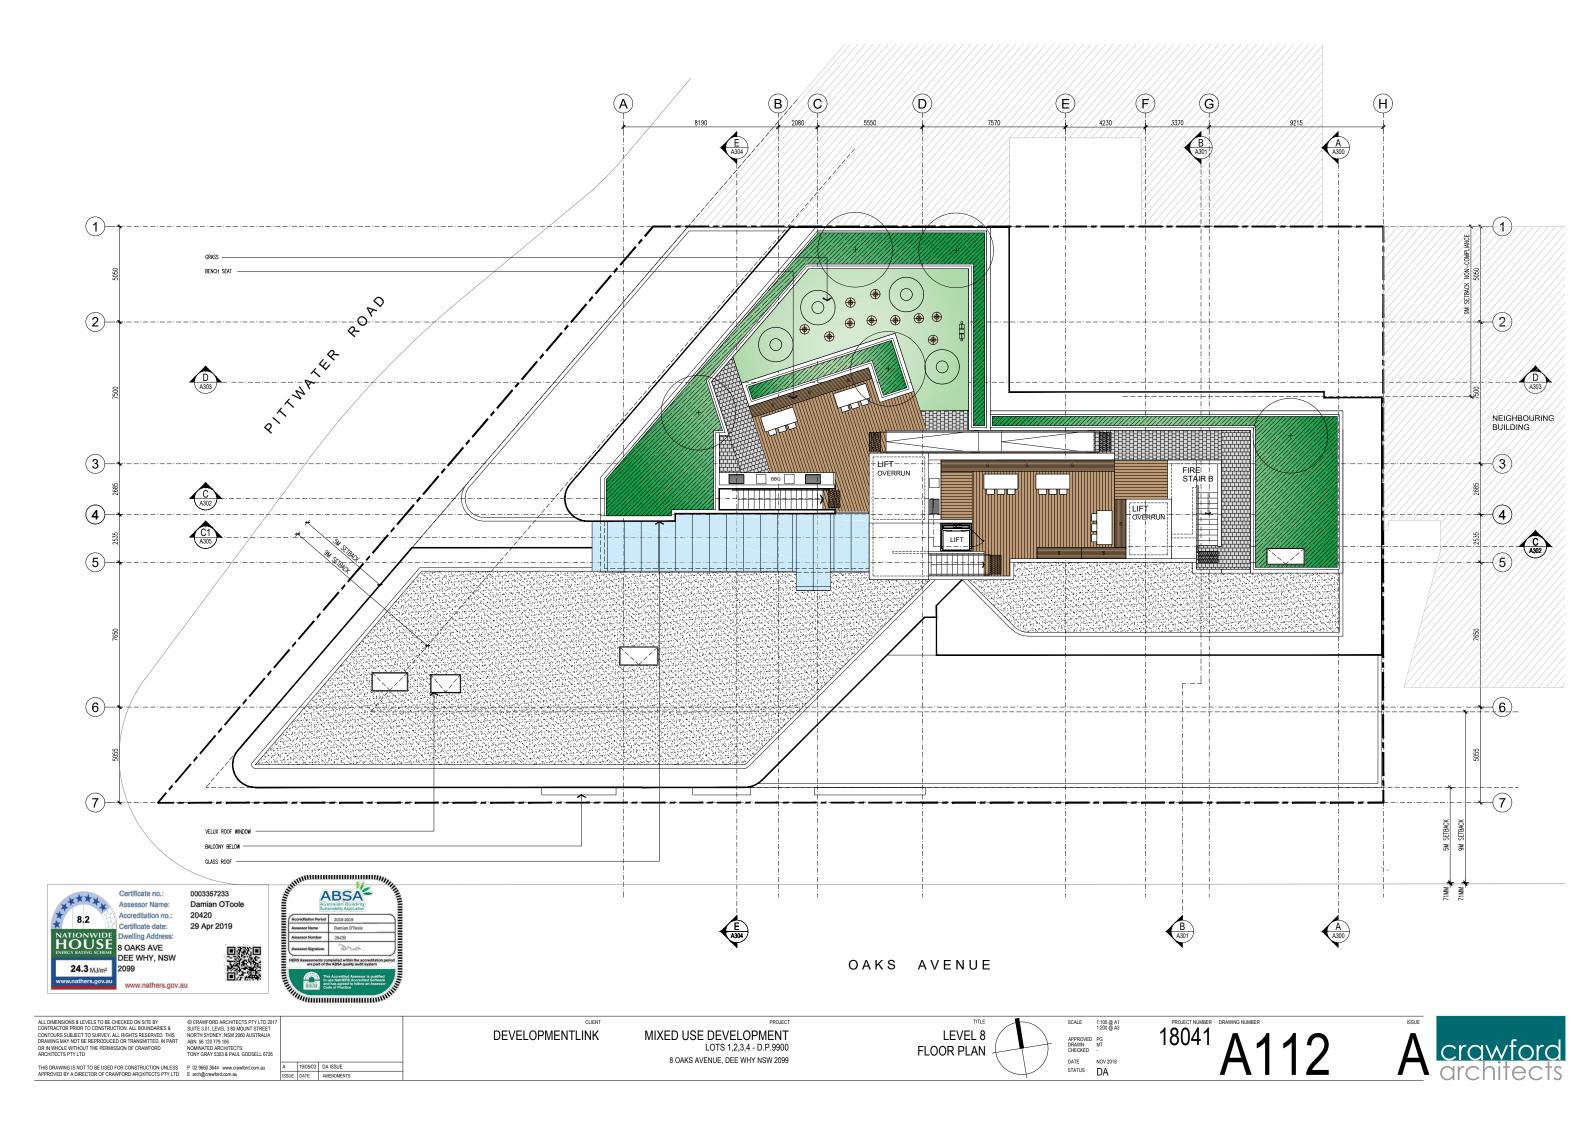


8 OAKS AVENUE, DEE WHY NSW 2099



DATE NOV 2018 STATUS DA







DEVELOPMENTLINK

LOTS 1,2,3,4 - D.P.9900 8 OAKS AVENUE, DEE WHY NSW 2099

OAKS AVENUE **SOUTH ELEVATION** APPROVED PG DRAWN MT CHECKED -









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SCALE 1:100 @ A1 1:200 @ A3 APPROVED PG DRAWN MT CHECKED -






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6726

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MIXED USE DEVELOPMENT LOTS 1,2,3,4 - D.P.9900 8 OAKS AVENUE, DEE WHY NSW 2099 EAST ELEVATION

1:200 @ A3
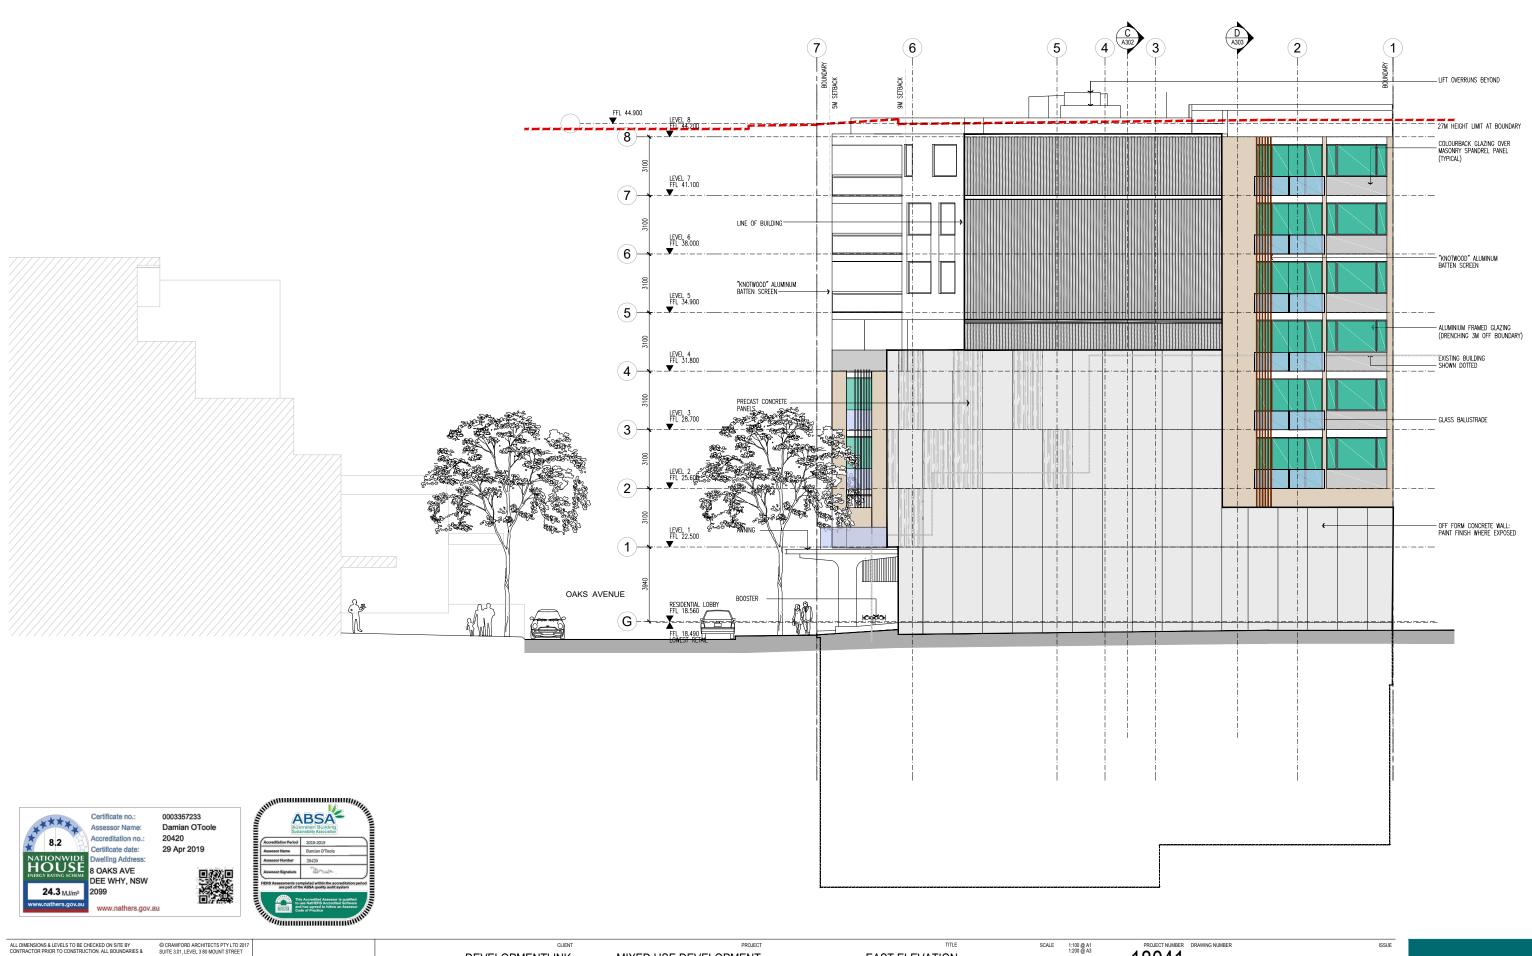
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DRAWN MT
CHECKED
DATE NOV 2018
STATUS DA








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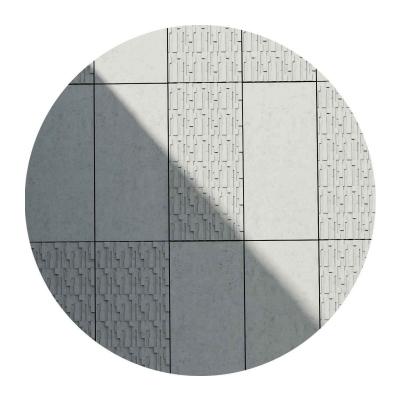
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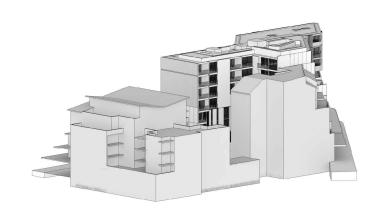









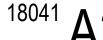







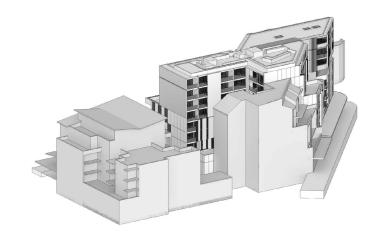



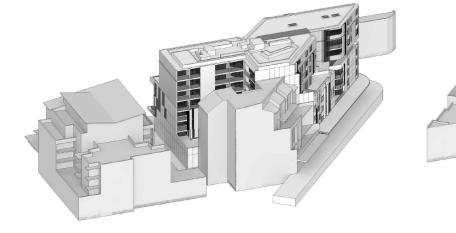


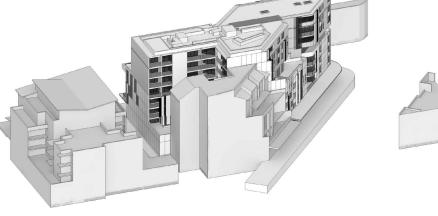









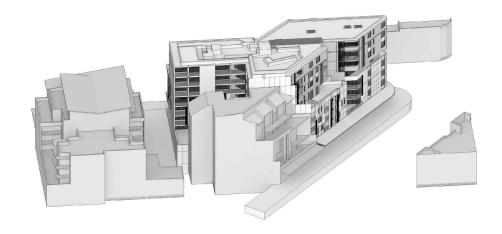

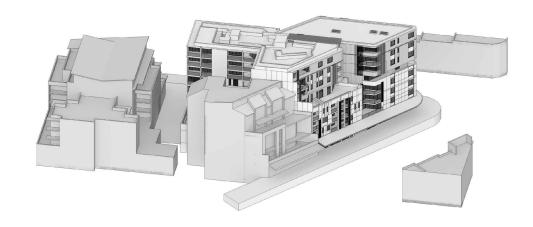


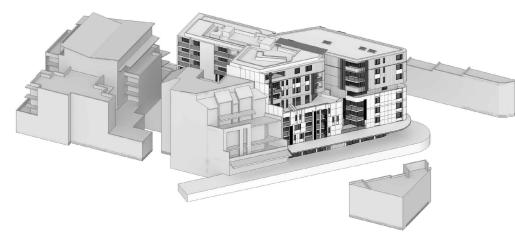

11:00am 21st JUNE

12:00pm 21st JUNE

1:00pm 21st JUNE

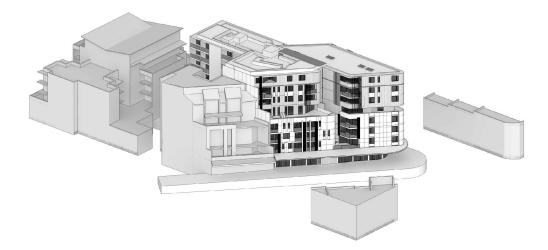





2:00pm 21st JUNE

3:00pm 21st JUNE

4:00pm 21st JUNE

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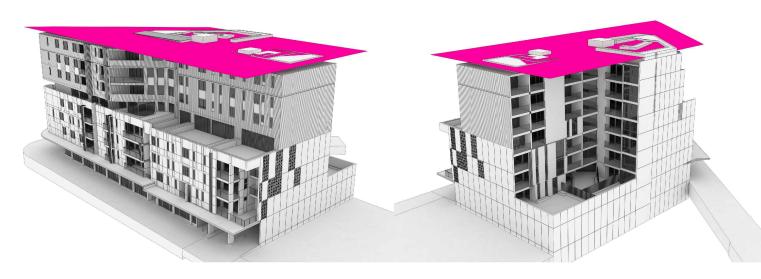
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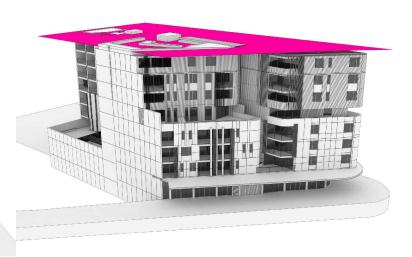
DIRECT SOLAR ANALYSIS

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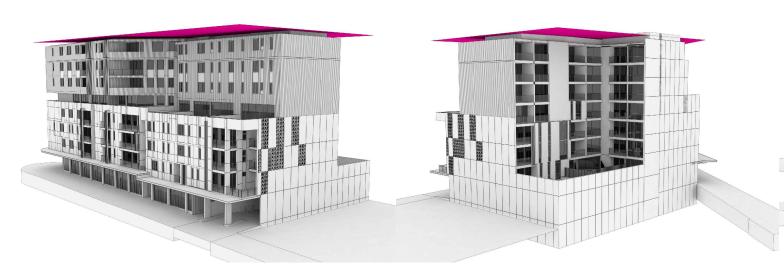

















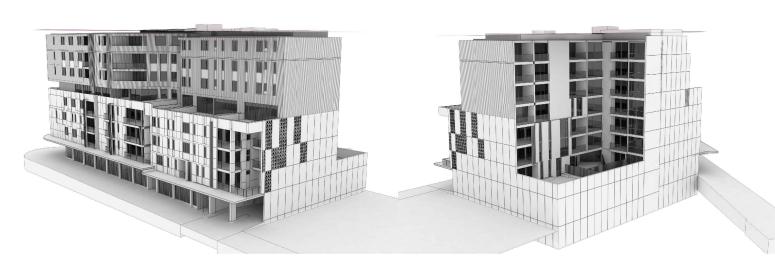



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HEIGHT BLANKET ANALYSIS

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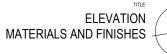




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8 OAKS AVENUE DEE WHY

Landscape Development Application

DRAWINGS

DWG NO.	DWG NO. DRAWING TITLE					
000	COVER SHEET					
101	LANDSCAPE PLAN - LEVEL 1	1:50				
102	LANDSCAPE PLAN - LEVEL 4	1:100				
103	LANDSCAPE PLAN - ROOF	1:75				
501	LANDSCAPE DETAILS	AS SHOWN				
502	LANDSCAPE DETAILS	AS SHOWN				
503	LANDSCAPE SPECIFICATION	AS SHOWN				

Symbol	Botanic Name	Common Name	Mature	Pot Size	Spacing	Quantity
- J			H x W (m)		- paramg	
			,			
Level 1	'	'	'		'	
Trees						
MLG	Magnolia 'Little Gem'	Dwarf Magnolia	4 x 3	200L	as shown	4
Shrubs &	Accents					
Ai	Alcantarea imperialis 'Rubra'	Bromeliad	0.7 x 0.7	300mm	as shown	28
Ву	Beschorneria yuccoides	Mexican Lily	1 x 1	300mm	as shown	25
RSM	Raphiolepis indica 'Snow Maiden'	Snow Maiden	0.75 x 0.5	300mm	as shown	54
Vo	Viburnum odoratissimum	Sweet Viburnum	3 x 2	300mm	as shown	88
Groundco	vers & Grasses					
Dr	Dichondra repens	Kidney Weed	0.1 x 0.1	150mm	5/m ²	135
LEG	Liriope 'Evergreen Giant'	Giant Liriope	0.6 x 0.6	150mm	5/m ²	76
LSL	Liriope 'Silver Lawn'	Silver Lawn	0.35 x 0.4	150mm	5/m ²	45
Tj	Trachelospermum jasminoides	Star Jasmine	0.2 x 1	150mm	5/m ²	89
',	Tracticiospermum jasminoides	Otal dasimile	U.2 X 1	130111111	3/111	03
Level 4						
Trees						
Pr	Plumeria rubra	Frangipani	6 x 3	100L	as shown	6
Shrubs &	Accents	3.7 5	22			
Aa	Agave attenuata	Fox tail Agave	1.2 x 1	300mm	as shown	22
RSM	Raphiolepis indica 'Snow Maiden'	Snow Maiden	0.75 x 0.5	300mm	as shown	209
Groundco	overs & Grasses					
Dr	Dichondra repens	Kidney Weed	0.1 x 0.1	150mm	5/m ²	193
LEG	Liriope 'Evergreen Giant'	Giant Liriope	0.6 x 0.6	150mm	5/m ²	155
Tj	Trachelospermum jasminoides	Star Jasmine	0.2 x 1	150mm	5/m ²	40
	Tractielospetitium jastiinioloes	Star Jasiffille	U.Z X 1	13011111	3/111	40
Roof						
Trees						
MLG	Magnolia 'Little Gem'	Dwarf Magnolia	4 x 3	200L	as shown	4
Pr	Plumeria rubra	Frangipani	6 x 3	100L	as shown	3
Shrubs &	Accents					
Aa	Agave attenuata	Fox tail Agave	1.2 x 1	300mm	as shown	12
Pt	Phormium tenax 'Bronze Baby'	Bronze Baby	0.75 x 0.75	300mm	as shown	7
RSM	Raphiolepis indica 'Snow Maiden'	Snow Maiden	0.75 x 0.5	300mm	as shown	83
SC	Syzygium Cascade	Cascade Lillipilly	2 x 2	300mm	as shown	29
	overs & Grasses	. ,				
Cg	Carpobrotus glaucescens	Pig Face	0.2 x 1	150mm	5/m ²	128
LEG	Liriope 'Evergreen Giant'	Giant Liriope	0.6 x 0.6	150mm	5/m ²	139
LSL	Liriope 'Silver Lawn'	Silver Lawn	0.35 x 0.4	150mm	5/m ²	70

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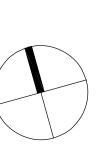
The contractor shall check and verify all work on site (including work by others) before commencing the landscape installation. Any discrepancies are to be reported to the Project Manager or Landscape Architect prior to commencing work. Do not scale this drawing. Any required dimensions not shown shall be referred to the Landscape Architect for confirmation.

D Architectural CoordinationC Architectural CoordinationB For ReviewA For Review

Issue Revision Description

JM NM 19.03.2019 JM NM 17.10.2018 JM NM 18.09.2018 JM NM 18.09.2017 Drawn Check Date

LEGEND





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Landscape Architects
evel 1, 3-5 Baptist Street
Redfern NSW 2016
Australia

Tel: (61 2) 8332 5600
Fax: (61 2) 9698 2877

Project:

8 Oaks Avenue

Dee Why

Drawing Name:

Cover Sheet

DEVELOPMENT APPLICATION

Scale:

Job Number: Drawing Number:

Job Number: Drawing Number: Issue: SS17-3607 000 D



others) before commencing the landscape installation. Any discrepancies are to be reported to the Project Manager or Landscape Architect prior to commencing work. Do not scale this drawing. Any required dimensions not shown shall be referred to the Landscape Architect for confirmation.

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The contractor shall check and verify all work on site (including work by

Architectural Coordination Architectural Coordination B For Review A For Review

Issue Revision Description

JM NM 18.09.2017 Drawn Check Date

JM NM 11.07.2018 JM NM 17.10.2018 JM NM 18.09.2018

(Refer Detail & Plant Schedule) Shrubs & Accents

(Refer Detail & Plant Schedule) Groundcover/ Grasses

(Refer Detail & Plant Schedule)

Paving Timber Decking

Synthetic Turf

(Refer Detail)

Stepping Stones S Timber Seat

Steel Edge

Landscape Architects Level 1, 3-5 Baptist Street Redfern NSW 2016 Australia Tel: (61 2) 8332 5600 Fax: (61 2) 9698 2877 www.siteimage.com.au

SITE IMAGE Client:

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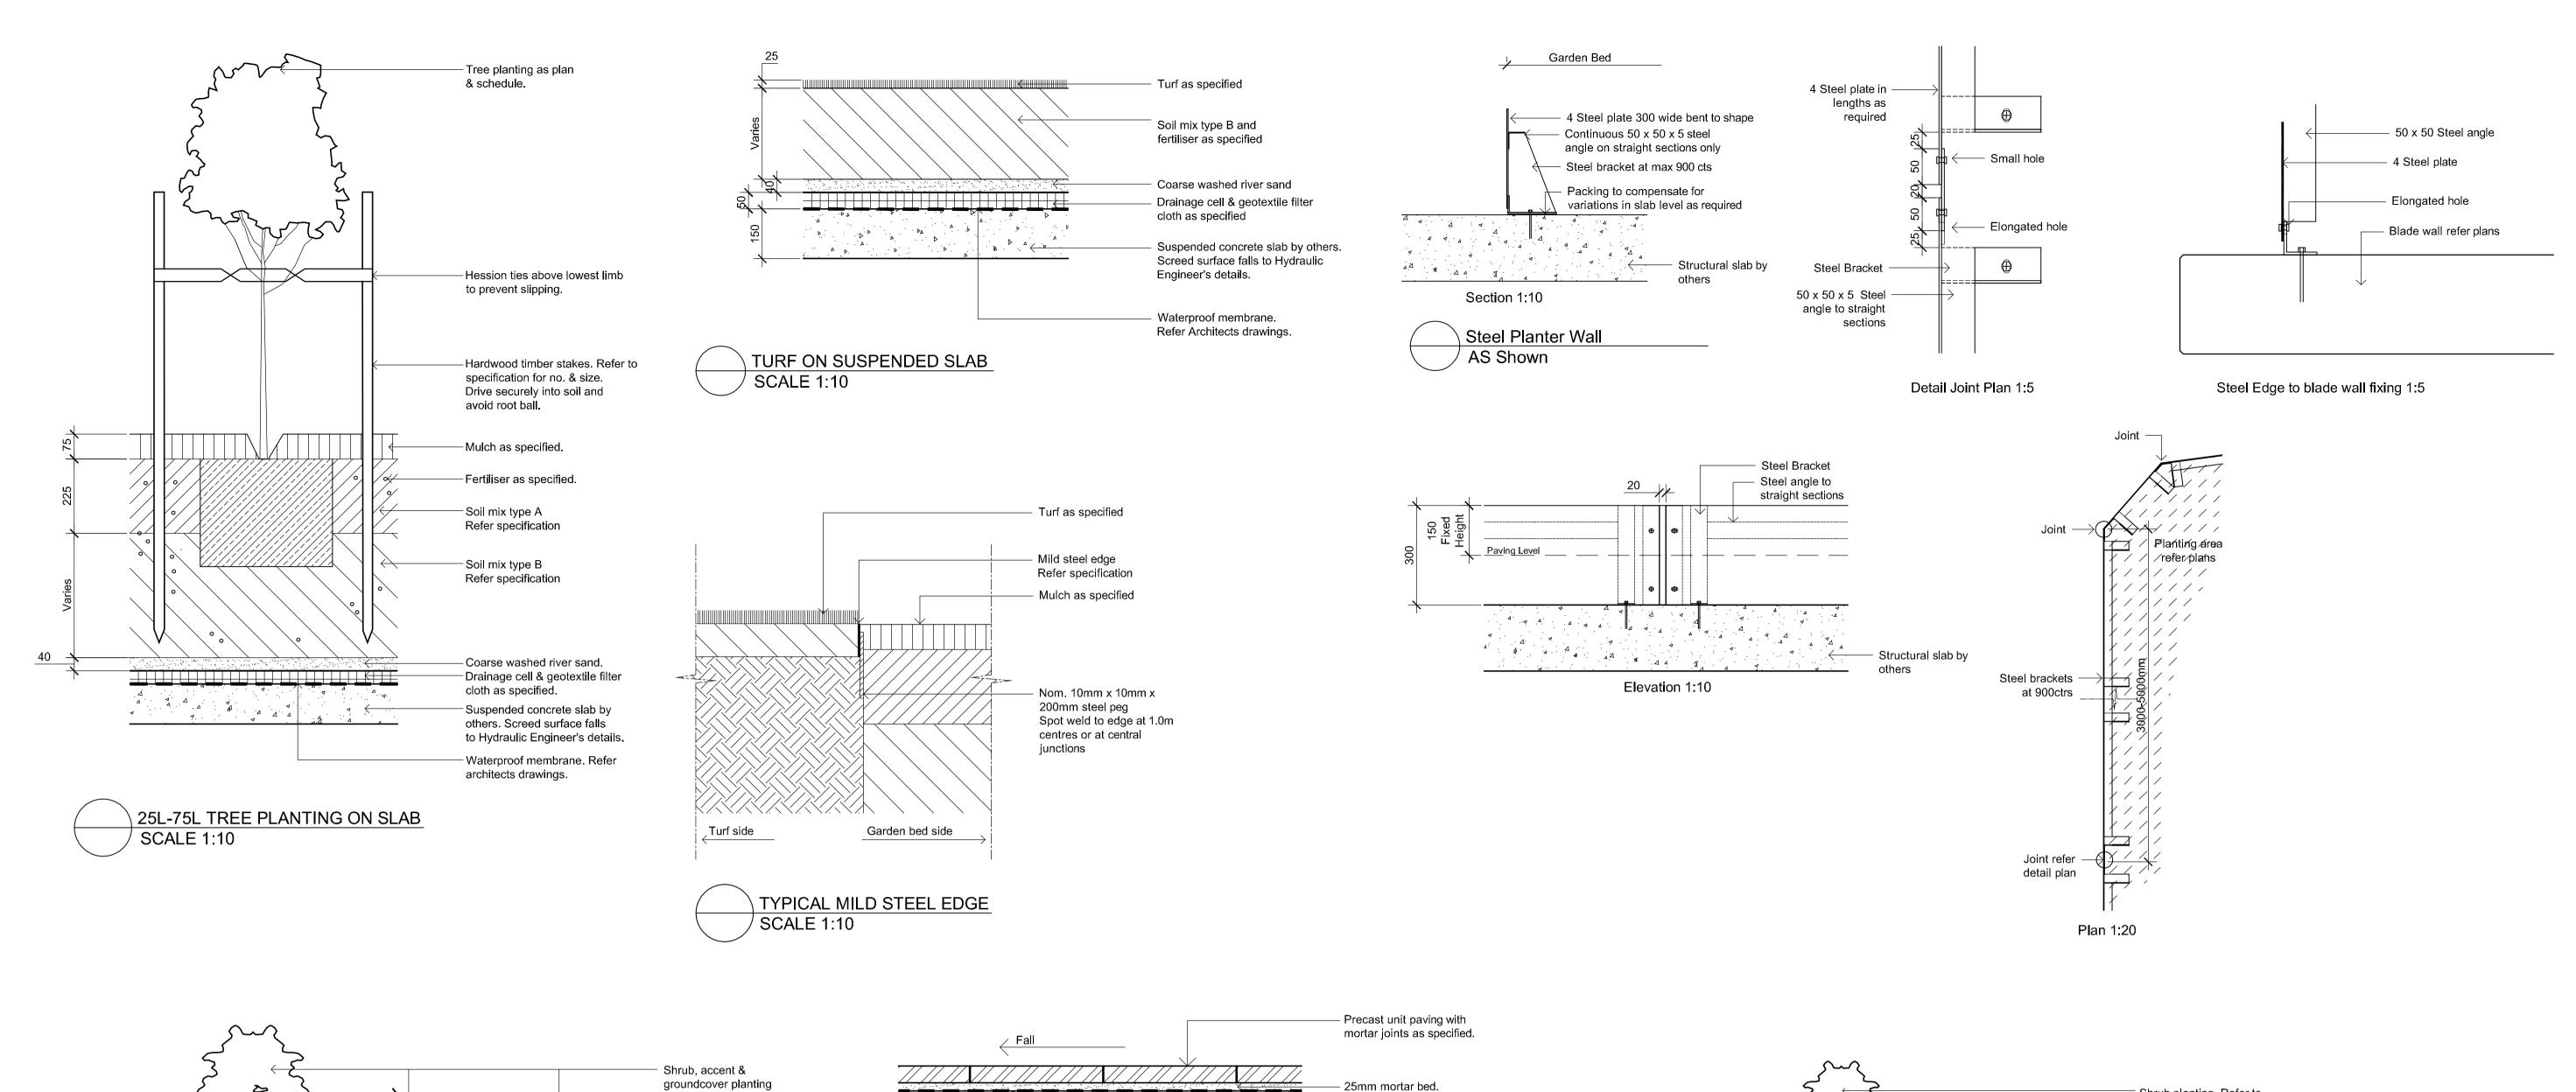
Landscape Plan Roof


DEVELOPMENT APPLICATION


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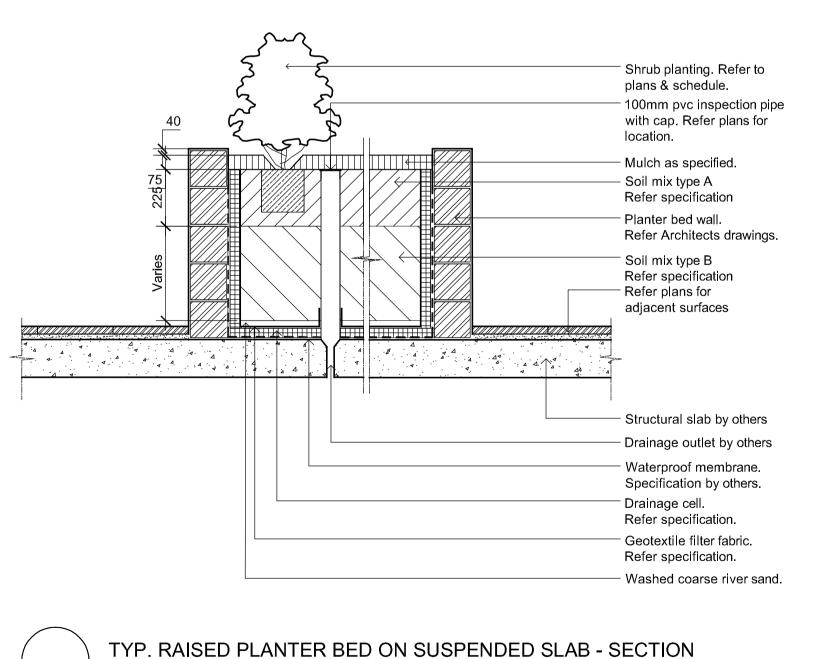
SS17-3607

Drawing Number: 103 D





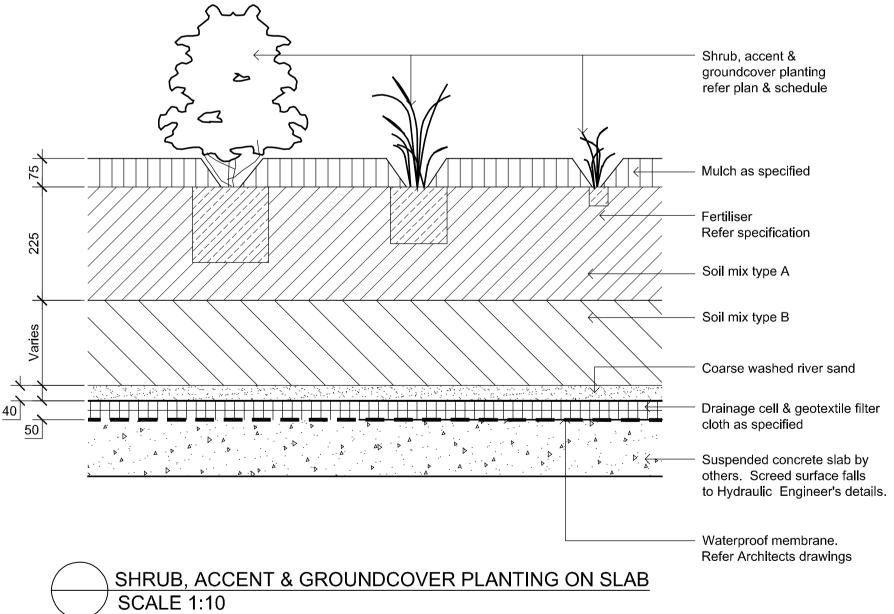

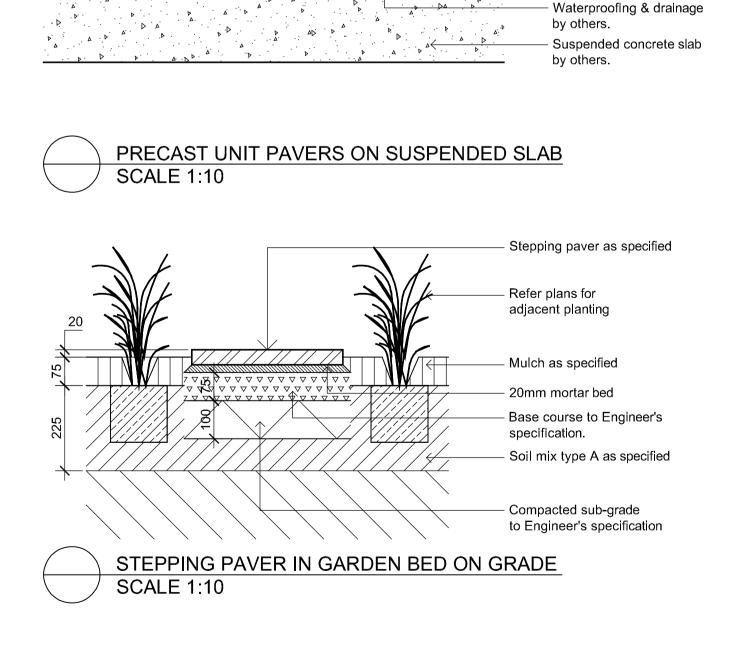

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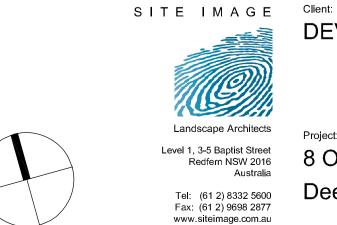
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C Architectural Coordination
B For Review
A For Review
Issue Revision Description

JM NM 17.10.2018 JM NM 18.09.2018 JM NM 18.09.2017 Drawn Check Date

LEGEND



SCALE 1:20

DEVELOPMENTLINK

Project:

8 Oaks Avenue

Oaks Avenue

Dee Why

Drawing Name:

Landscape Details

DEVELOPMENT APPLICATION


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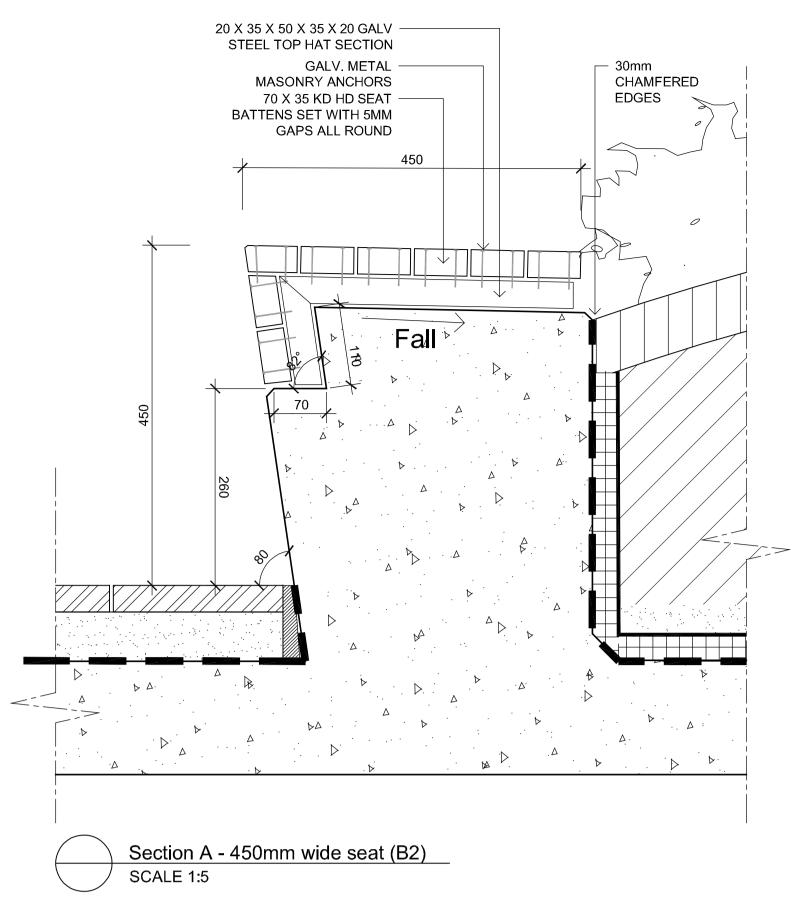
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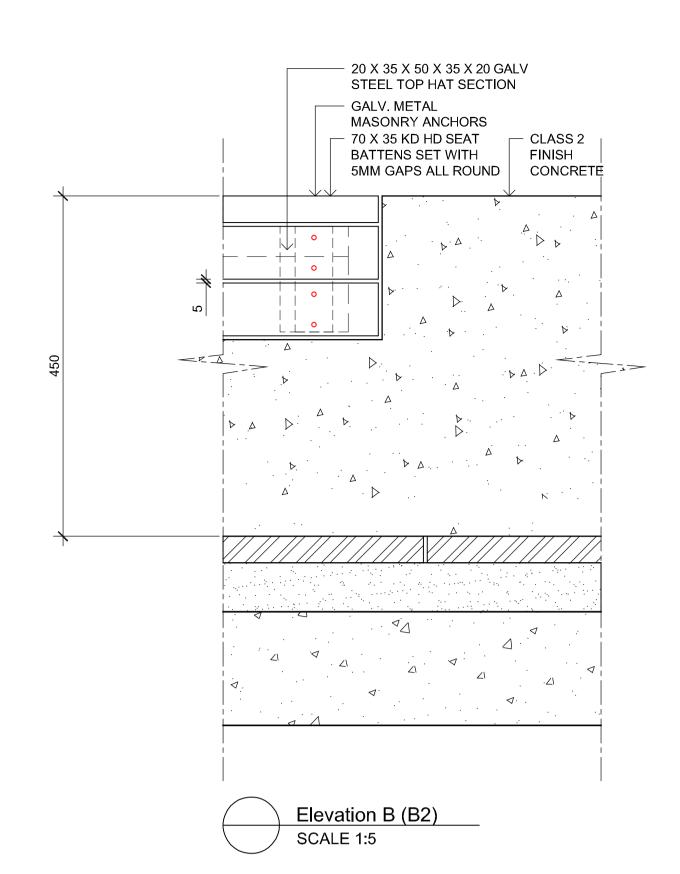
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Plan - Timber Inlay Bench Seat (B2)

SCALE 1:5

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Architectural Coordination B For Review A For Review

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LEGEND

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DEVELOPMENTLINK

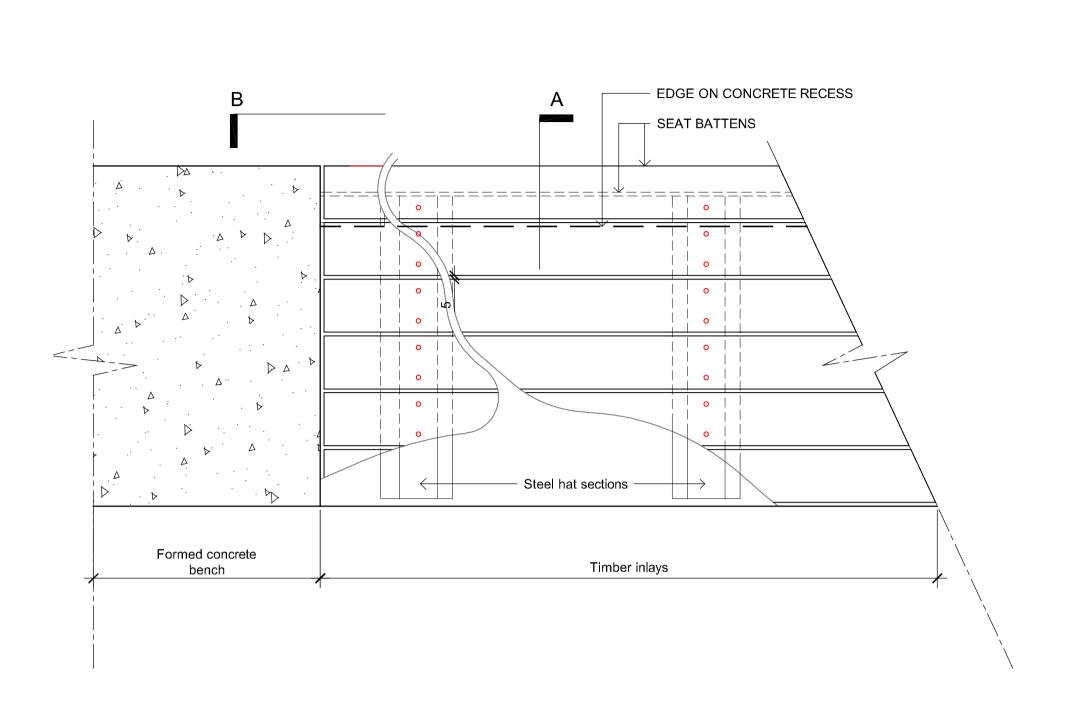8 Oaks Avenue Dee Why

Landscape Details

DEVELOPMENT APPLICATION

Scale: As Shown Job Number:

Drawing Number 502 C

SS17-3607

SPECIFICATION

GENERAL NOTES

All plans and details included in the project documents shall be read in conjunction with this specification. All structural and civil works components of the landscape design shall be referenced to engineers' details and specifications. Read this specification in conjunction with Ensure that all subgrade/subsurface works are complete prior to the plant and materials schedule on this drawing. If in doubt about any commencing paving. Confer with the engineer to ensure the structural • Grown in final containers for not less than twelve weeks; detail or if conflicts are found in the documents, seek advice.

Workmanship and Materials

The whole of the landscape works shall be carried out by a competent. trained and qualified landscape contractor who is experienced in horticultural practices, landscape construction and planting techniques. Undertake at least two (2) soil tests, in locations as advised by Project Plant Installation The landscape contractor shall hold a current Building Contractors License and/or be a financial member of LNA Landscape Association NSW & ACT or equivalent organisations in other states.

EXISTING TREES

Trees to be Retained and Protected

Identify and mark trees and shrubs to be retained using a suitable non-injurious, easily visible and removable means of identification. Protect from damage the trees and shrubs to be retained, including on a tree, give written notice immediately and obtain instructions.

Work near Trees

Keep the area of the drip-line free from construction material and debris. Do not place bulk materials and harmful materials under or near by hand. During cultivation, thoroughly mix in materials required to be accordance with manufacturer's specification, including 300 x 300 mm the contract Defects Liability Period. The Landscape Contractor shall trees. Do not place spoil from excavations against tree trunks. Prevent incorporated into the subsoil, as recommended in the soil testing wind-blown materials such as cement from harming trees and plants. results and to manufacturer's recommendations. Trim the surface to Do not remove topsoil from, or add topsoil to, the area within the drip-line of trees.

EARTHWORKS

Excavation, Trimming and Filling

Except as otherwise note in the contract, bulk excavation is excluded to achieve design levels to accommodate finish materials as detailed. Compact the finished surface as required for the finished ground

Sub-soil Drainage

Keep the excavated works drained and free of standing water. Allow to • Graded evenly to adjoining surfaces; and supply and install sub-soil drainage pipes as required for the new works to ensure that all gardens are well drained. Connect the sub-soil drainage pipes to the nearest downstream stormwater pits. Include Compost pipe filter socks.

HARDWORKS

Furniture, Handrails, Balustrades

Supply and install the scheduled items in accordance the manufacturer's recommendations, as detailed and in the locations shown on plan. Provide all footings and fixings required for the items to be stable and in accordance with applicable codes and standards. Plants

Garden Walls, Fences, Steps, TGSI and Edging

Construct garden walls as shown on plan, as detailed and of the material scheduled. Provide footings, step nosings, tactile surfaces to comply with standards and applicable legislation.

Continuous, Unit and Loose Pavement

Install the scheduled material pavement to the locations shown on plan. integrity of the installation.

SOFTWORKS

Manager, and provide results and recommendations for the improvement of plant growth and to adjust the soil to achieve appropriate planting medium (including pit levels) for successful plant

Excavate all garden beds to bring the subsoil to at least 300mm below as it was above the soil in the container. Apply fertiliser, as finished design levels. Shape the subsoil to fall to subsoil drains where recommended in the soil testing results or in accordance with the applicable. Do not excavate within the drip line of trees to be retained. manufacturer's recommendations around the plants in the soil at the Excavate all turf areas to bring the subsoil to at least 100mm below those beyond the site area, both above and below the ground. If a tree finished design levels. Shape the subsoil to fall to subsoil drains where becomes damaged during the works or it is proposed to perform work applicable. Do not excavate within the drip line of trees to be retained. Embankment Stabilisation Cultivate the subsoil to a further depth of 100mm. Remove stones exceeding 25mm, clods of earth exceeding 50mm, and weeds, rubbish embankments. As a minimum this should be on slopes ≥1:3. Stabilise or other deleterious material brought to the surface during cultivation. embankments using biodegradable fibre reinforced with heavy weight Do not disturb services or tree roots, if necessary cultivate these areas polymer mesh. Lay mesh from top to bottom of slope. Install in

Import topsoil for the garden and turf areas, unless the topsoil can be Root Barrier provided from material recovered from the site, as recommended in the Supply and install root control barriers to all new tree plantings soil testing results. Spread the topsoil on the prepared subsoil and grade evenly, compact lightly and uniformly in 150mm layers. Avoid from the landscape works. Trim and fill the excavated ground surfaces differential subsidence and excess compaction and produce a finished accordance with manufacturer's recommendations. topsoil surface which has the following characteristics: • Finished to design levels, allowing for mulch or turf, which is to finish Mulch flush with adjoining hard surfaces such as paths and edge;

Graded to drain freely, without ponding, to catchment points;

Smooth and free from stones or lumps of soil;

Ready for planting.

design levels after cultivation.

Provide proprietary fertilisers, delivered to the site in sealed bags

ratio, recommended uses and application rates.

Frequency

Supply plants in accordance with the landscape drawings and schedules, which have the following characteristics:

or damage:

- Vigorous, well established, free from disease and pests, of good form consistent with the species or variety; Hardened off, not soft or forced, and suitable for planting in the natural climatic conditions prevailing at the site, and in particular
- shade conditions.
- Trees, unless required to be multi-stemmed, shall have a single leading shoot; and
- Containers shall be free from weeds and of appropriate size in relation to their container.

Following excavation of the planting hole place and spread 15gms of wetting agent pre-mixed with one (1) litre of water. Place the plant correctly orientated to north or for best presentation. Backfill the planting holes with specified topsoil mixture. Lightly tamp and water to eliminate air pockets. Ensure the topsoil is not placed over the top of

Where necessary to prevent soil erosion or soil movement, stabilise anchor trenches at top and bottom, backfilled with soil over the mesh and compacted, and U-shaped galvanised steel pegs at 1000 mm centres and 250mm centres at edge overlaps. Plant after matting is Replacing failed plants;

adjacent to walls, paths and all trunk service trenches, where their proximity poses a threat to the stability of the infrastructure. Install in

Mulch shall be approved recycled wood fibre or pine bark mulch. Place • Weeding and rubbish removal. mulch in all garden beds to a depth of 75mm, after all specified plants are installed. Keep mulch clear of all plant stems and rake to an even Maintenance Log Book surface flush with the surrounding surfaces evenly graded between design surface levels. Over fill to allow mulch to settle to the specified

Provide, in accordance with AS 4454, well rotted vegetative material or Stakes and Ties

animal manure, free from harmful chemicals, grass and weed growth. Stakes shall be durable hardwood, straight, free of knots and twists, pointed at one end, in the following quantities and sizes for each of the Schedule the following activities to occur on a timely basis. various plant pot sizes: Plants (>25 lt): 1 off 38 x 38 x 1200mm; Semi-advanced plants (>75 lt): 2 off 50x50x 1800mm; marked to show manufacturer or vendor, weight, fertiliser type, N:P:K

Advanced (>100 lt): 3 off 50 x 50 x 2400mm.

Action

Turf shall be delivered to site as 25mm minimum thick cut rolls. Obtain turf from a specialist grower of cultivated turf. Provide turf of even

• Large healthy root systems, with no evidence of root curl, restriction thickness, free from weeds and other foreign matter. Deliver turf to the • Pruning - Prune dead wood, broken limbs, dead or infected site within 24 hours of being cut, and lay it within 24 hours of delivery. Prevent it form drying out between cutting and laying. Lay the turf in the shape and form expected of the plant type. following manner:

- In stretcher pattern, joints staggered and close butted; Parallel long sides of level areas, with contours on slopes; &
- To finish flush, after tamping, with adjacent finished surfaces of

IRRIGATION

All proposed landscape areas shall be irrigated.

The irrigation system shall be an automatic fixed drip system, with an irrigation controller self operated via a soil moisture sensor. The system recommendations. Record in the logbook all relevant details of shall be compatible to the type of plant material and rates of water required. Where appropriate adjustable and fully serviceable. The layout of the entire irrigation is to ensure that each individual plant receives the required amount of water to maintain healthy and vigorous o the rootball. Keep the plant stem at the same height above the ground growth. The irrigation system shall be such that, component theft, vandalism, over-spray and wetting of paths shall be reduced to a minimum or completely eliminated by the use of drip, pop-up sprinklers and judiciously placed fixed spray emitters. Do not use fine mist type emitters that provide a drifting mist that may wet paths and the

LANDSCAPE MAINTENANCE

The Landscape Contractor shall rectify defects during installation and that become apparent in the works under normal use for the duration of maintain the contract areas by the implementation of industry accepted • horticultural practices for 52 weeks. The landscape maintenance works plants remain correctly staked. Remove those not required at the end shall include, but not be limited to, the following:

- Pruning; Insect and pest control; Fertilising;
- Stakes and ties; Maintaining mulch;
- Mowing and top dressing: Irrigation and watering;
- Erosion control; and

Implement and keep a maintenance log book recording when and what • Erosion control - Where necessary, maintain the erosion maintenance work has been undertaken and what materials, actions and decisions have been used, implemented and concluded to keep the landscape always looking its best.

Maintenance Activities

Plant replacement - Replace plants that have failed to mature,

die or are damaged. Replacement plants shall be in a similar size and possible, time weed removal to precede flowering and seed set. quality and identical species or variety to the plant that has failed. Replacement of plants shall be at the cost of the landscape contractor unless advised otherwise. If the cause of the failure is due to a controllable situation then correct the situation prior to replacing

foliage and as needed to develop strong, healthy plants to achieve the

- Insect and pest control Avoid spraying:
- if ever possible; in wet weather or if wet weather is imminent;
- if target plants are still wet after rain; in windy weather; and
- if non-target species are too close.
- Immediately report to the Project Manager any evidence of intensive weed infestation, insect attack or disease amongst plant material. Submit all proposals to apply chemicals and obtain approval before starting this work. When approved, spray with herbicide, insecticide, fungicide as appropriate in accordance with the manufacturers'
- spraying activities including: Product brand / manufacturer's name. Chemical / product name,
- Chemical contents,
- Application quantity and rate,
- Date of application and location, Results of application, and
- Use approval authority.
- Fertilising Fertilise gardens with a proprietary slow release fertiliser applied in accordance with the manufacturer's directions and recommendations. Record in the logbook all relevant details of
- fertilisina includina: Product brand / manufacturer's name,
- Fertiliser / product name,
- Application quantity and rate, and Date of application and location.
- Stakes and ties Adjust and replace as required to ensure
- of the planting establishment period (Defects Liability Period). • Maintaining mulch - Maintain the surface in a clean, tidy and weed free condition and reinstate the mulch as necessary to ensure correct depth as specified.
- Mowing and top dressing Mow the turf to maintain a grass height of between 30-50mm. Do not remove more than one third of the grass height at any one time. Remove grass clippings from the site after each mowing. Top dress to a maximum of 10mm to fill
- depressions and hollows in the surface. • Irrigation and watering - Maintain the irrigation system to sure that each individual plant receives the required amount of water to maintain healthy and vigorous growth, adjust and rectify as required.
- Provide additional watering, if necessary. control devices in a tidy and weed free condition and reinstate as
- necessary to ensure control measures are effective where deemed
- Weeding and rubbish removal During the plant establishment period remove by hand, rubbish and weed growth that may occur or re-occur throughout all planted, mulched and paved areas. The contractor shall target weeds that are capable of producing a major infestation of unwanted plants by seed distribution. Whenever

Maintenance Program

		D	W	2W	3W	M	ЗМ	6M	
1	Logbook	+		+		+			Complete a logbook entry every day at site and at least every two weeks. All actions listed below require a logbook entry. Upon request, make the logbook available for inspection. Submit copies of new entries in the logbook to the Contract Administrator on a monthl basis. Please note that more frequent, short, occasional inspection should result in less maintenance work when problems are observed earlier than they might otherwise have been seen.
2	Plant Replacement			+		+			Inspect and replace failed plants within 2 weeks of observation of failure. Match species, size (original) and location of new with old.
3	Mulch			+		+			Inspect and replace mulch deficiencies within 2 weeks of observation. Prior to placing new mulch aerate the soil by fork turning to a depth of at least 100mm, roughly level the soil and then place mulch. Do not disturb major plant roots while aerating soil.
4	Erosion Control			+					Inspect every two weeks and repair ground, soil and mulch immediately. Maintain erosion control device as necessary.
5	Stakes and ties			+					Inspect every two weeks, adjust and/or replace as necessary but remove as plants mature and are able to support themselves.
6	Weed and Rubbish removal			+					Inspect and remove immediately upon observation. Leave no waste on site. Dispose of waste material at a designated waste disposal site
7	Pruning			+					Inspect every 2 weeks and prune as necessary to remove dead wood, improve plant shape and promote healthy vigorous new growth.
8	Spraying			+					Inspect every 2 weeks and action as necessary. Do not spray if other non-chemical methods will satisfy the need to remove insects. Spray for disease control only when absolutely necessary.
9	Urgent Works		+						Complete within 1 week (7 days) of notification. Inspect and clear drains.
10	Planting and fertilising			+			+		Inspect every 2 weeks and remove spent flowers and dead stalks as they become apparent. Fertilise gardens every 3 months or other frequency in accordance with fertiliser manufacturer's directions.
11	Watering	+		+					Water when and where necessary every day at site and at least every 2 weeks generally. Do not allow soil and plants to dehydrate. Allow for prolonged rain, windy and dry periods. Water in the early morning or late afternoon to avoid excessive evaporation during the heat of the day.
12	Mowing, top dressing and edging			+		+		+	Summer fortnightly. Winter monthly. Top-dress 6 monthly.

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LEGEND

SITE IMAGE DEVELOPMENTLINK

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Landscape Specification

DEVELOPMENT APPLICATION

Scale: As Shown

Job Number: Drawing Number: SS17-3607

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