


SCALE: 1:100



\* NEW LEVEL

\* EXISTING LEVEL

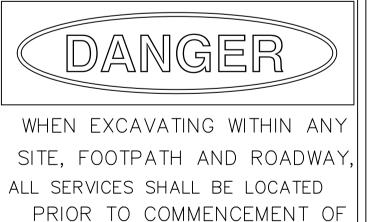


CONTACT "DIAL BEFORE YOU DIG"

ON PHONE No. 1100 OR GO TO THE

WEB SITE

THE EXCAVATION WORKS.

"www.dialbeforeyoudig.com.au"

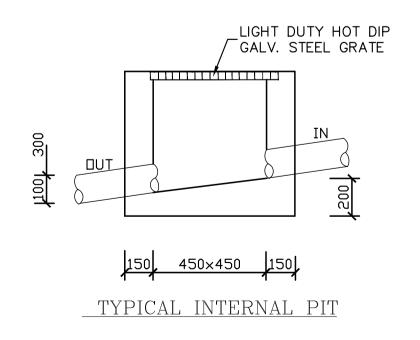


NOTE: FOR OWNER/BUILDER/PLUMBER
REGULAR 2 MONTHLY MAINTAINENCE IS REQUIRED
TO ALL PITS. OWNER/BUILDER/TENNANT TO ENSURE
ALL PITS ARE CLEANED.

NOTE: BASIX REQUIREMENTS
ENSURE MINIMUM ROOF CATCHMENT
AREA DRAINS TO ABOVE GROUND
RAINWATER TANK. REFER BASIX
REPORT AND REQUIREMENTS


NOTE: BASIX REQUIREMENTS
MINIMUM RAINWATER TANK CAPACITY = 2000L
PROVIDED RAINWATER TANK CAPACITY = 3000L
MINIMUM COLLECTED ROOF RUNOFF = 110sqm
PROVIDED COLLECTED ROOF RUNOFF = 141sqm

NOTE SERVICES

APPROXIMATE LOCATIONS OF
EXISTING SERVICES SHOWN EXACT
LOCATIONS & DEPTHS TO BE
ACCURATELY LOCATED BY BUILDER
CONTRACTOR BY CONTACTING THE
RELEVANT AUTHORTIES BEFORE
COMMENCEMENT OF ANY WORKS

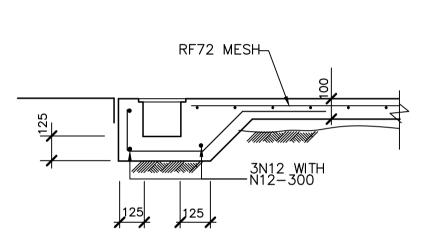

GRATED DRAIN

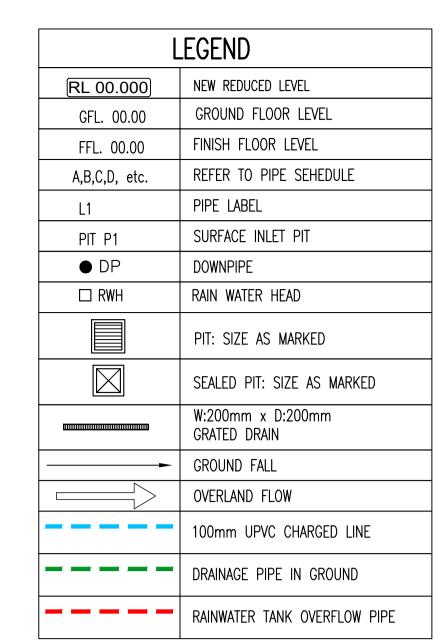

	PIPE	SCHEDU	LE			
TO ALL GUTTERS						
ΓAG	PIPE Ø	MATERIAL	Min. GRADE			
Α	100	PVC	1%			
В	100 OVERFLOW	PVC	1%			
С	100 CHARGED	PVC	_			
DP	100	PVC	-			

## NOTES

- 1. THESE DRAWINGS ARE TO BE READ IN CONJUNCTION WITH THE ARCHITECTURAL DRAWINGS, STRUCTURAL DRAWINGS AND THE SPECIFICATON.
- 2. PRIOR TO COMMENCEMENT OF WORKS THE CONTRACTOR SHALL SATISFY HIMSELF OF THE CORRECT LOCATION OF EXISTING SERVICES WHETHER INDICATED OR NOT ON THE PLANS. ANY DAMAGE TO EXISTING SERVICES SHALL BE RECTIFIED AT THE CONTRACTORS EXPENSE.

3. TRAFFIC MANAGEMENT MEASURES HAVE TO BE IMPLEMENTED

- AND MAINTAINED DURING CONSTRUCTON, ALL IN ACCORDANCE WITH COUNCIL'S REQUIREMENTS. THE CONTRACTOR SHALL MAINTAIN SAFE PEDESTRIAN ACCESS ALONG THE FOOTPATH.

  4. THE CONTRACTOR SHALL EFFECT TEMPORARY DRAINAGE MEASURES TO AVOID LOCALISED PONDING OF SURFACE RUN—OFF.

  5. REFER TO ARCHITECT'S DRAWINGS FOR ALL DETAILS (LEVELS, GRADING ETC.) OF DRIVEWAYS, CONCRETE AND PAVED AREAS, AND RETAINING WALL TYPES AND LOCATIONS.
- 6. REFER TO LANDSCAPE ARCHITECT'S DRAWINGS FOR DETAILS AND EXTENT OF ALL LANDSCAPED AREAS.
- 7. ALL SWD PIPES ARE UPVC AT 1.0% MINIMUM GRADE (UNO). 8. SWD PITS CAN BE PRE—CAST SIZED AS FOLLOWS:
- 450mm SQ. UP TO 600mm DEEP 600mm SQ. UP TO 1000mm DEEP
- 9. ALL PITS LOCATED IN TRAFFICABLE AREAS, (IE, DRIVEWAYS)
  TO HAVE MEDIUM DUTY GRATED COVERS SUITABLE FOR
  WITHSTANDING LOADS ASSOCIATED WITH SMALL TRUCKS.
  10. PROVIDE STEP IRONS TO ALL PITS GREATER THAN 1.2m DEEP.
  11. THE CONTRACTOR SHALL IMPLEMENT ALL SOIL EROSION AND
  SEDIMENT CONTROL MEASURES PRIOR TO COMMENCEMENT OF
- WORKS.

  12. TOPSOIL SHALL BE STRIPPED DN STOCKPILED OUTSIDE
  HAZARD AREAS SUCH AS DRAINAGE LINES. THIS TOPSOIL IS TO
  BE RESPREAD LATER ON AREAS TO BE REVEGETATED.

  13. THE CONTRACTOR SHALL REGULARLY MAINTAIN ALL SEDIMENT
  AND EROSION CONTROL DEVICES AND REMOVE ACCUMULATED SILT
  FROM SUCH DEVICES. ALL SILT REMOVED SHALL BE DISPOSED OF
  AS DIRECTED BY THE SUPERINTENDENT. THE PERIOD FOR
  MAINTAINING THESE DEVICES SHALL BE AT LEAST UNTIL ALL
  DISTURBED AREAS ARE REVEGETATED AND FURTHER AS MAY BE
  DIRECTED BY THE SUPERINTENDENT OR COUNCIL.

  14. THE CONTRACTOR SHALL MAINTAIN DUST CONTROL UNTIL
  FINAL COMPLETION OF WORKS.

RAINWATER TANK NOTES: RAINWATER TANK AND PIPE WORK IS TO BE PAINTED IN COLOURS MATCHING THE EXTERNAL FINISHES OF THE DWELLING AND NOTE: IS TO BE NON-REFLECTIVE FINISH. 1. TANK WATER IS NOT RECOMMENDED FOR HUMAN CONSUMPTION. 2.A SIGN STATING NOT FOR DRINKING MUST BE AFFIXED TO THE TANK AND dual feed OR TAP FIXTURE drinking water supply pipes first flush /device rainwater /top-up roof water to supply pipes hot water OVERFLOW TO SILT ARRESTOR PIT emergency mains water tap, back flow NOTE: prevention device at ANY PUMP INSTALLED water meter FOR THE RAINWATER TANKS IS TO BE NO rainwater to LOUDER THAN 5dB(A) washing machine \pressure and toilet ABOVE BACKGROUND pump bypass of 🦯 NOISE LEVELS Sydney Water supply main

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REVISION	AMENDMENT	ISSUE DATE	ISSUE	ISSUED TO	ISSUE DATE



SUITE 303 / 29-31 LEXINGTON DRIVE NORWEST BUSINESS PARK, BELLA VISTA N.S.W. 2153

ALL CORRESPONDENCE TO: P.O. BOX 6080 BAULKHAM HILLS BC BAULKHAM HILLS NSW 2153

PH. 8814 6191 FAX 8814 5301 MOB. 0425 270 333 EMAIL andrew@camconsulting.com.au

PROJECT
PROPOSED DEVELOPMENT
LOT 14, 10 FERN CREEK ROAD,
WORRIEWOOD, NSW
CLIENT
SKYCORP

ARCHITECT / PROJECT MANAGER

KAE CHAN

RAINWATER TANK EXPLANATORY DIAGRAM (not to scale)


DRAINAGE LAYOUT PLAN

 SCALES
 DESIGNED
 DRAFTED

 A1 - 1:100
 A.C.
 M.W.


 DRAWING NO.
 APPROVED
 REVISION


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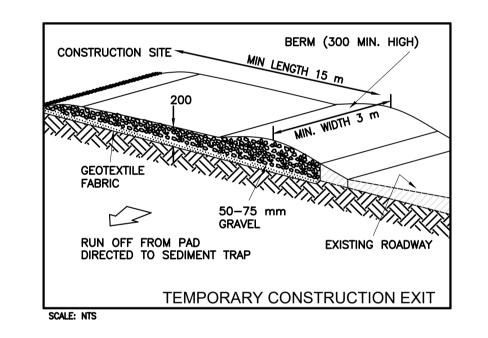


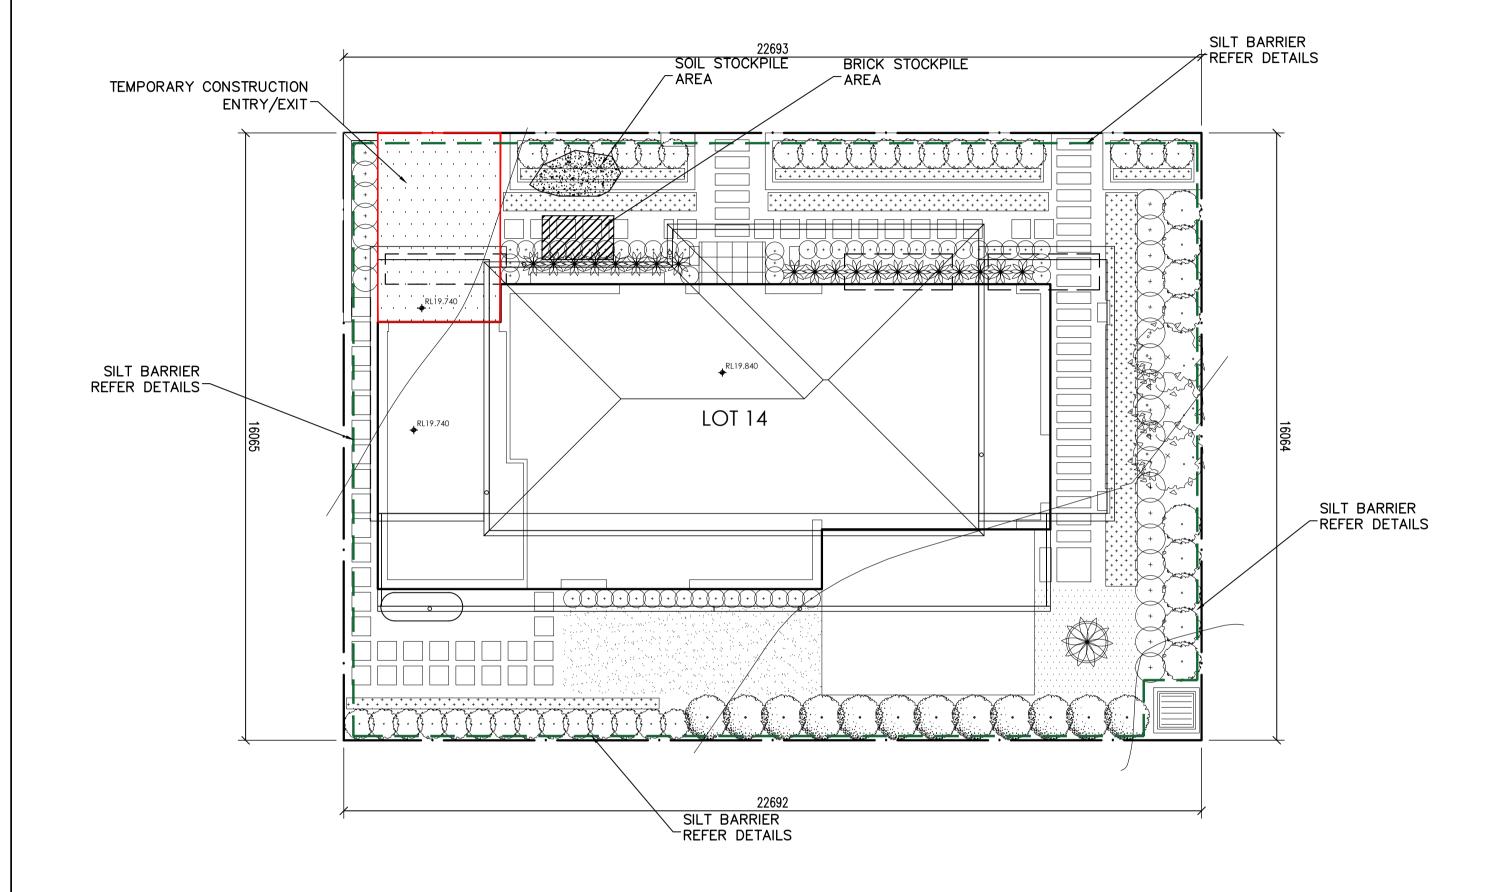






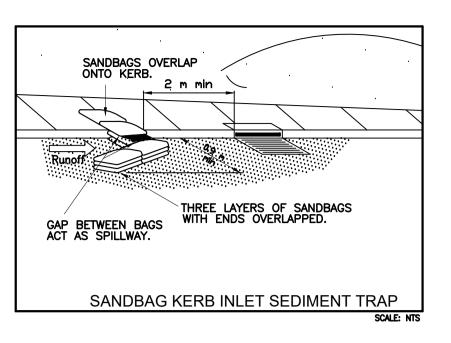

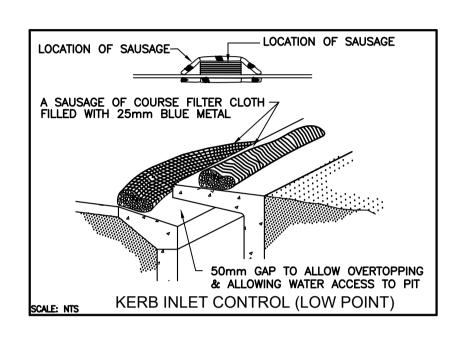

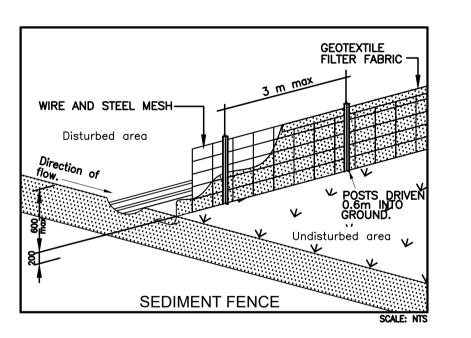


## SOIL EROSION CONTROL INSTRUCTIONS

- EARTH BATTERS WILL BE CONSTRUCTED WITH AS LOW AS A GRADIENT AS PRACTICABLE BUT NO STEEPER, UNLESS OTHERWISE NTOED, THAN:
  - -2(H):1(V) WHERE SLOPE LENGTH LESS THAN 12 METRES
    -2.5(H):1(V) WHERE SLOPE LENGTH BETWEEN 12 & 16 METRES
    -3(H):1(V) WHERE SLOPE LENGTH BETWEEN 16 & 20 METRES
    -4(H):1(V) WHERE SLOPE LENGTH GREATER THAN 20 METRES
- ALL WATERWAYS, DRAINS, SPILLWAYS AND THEIR OUTLETS WILL BE CONSTRUCTED TO BE STABLE IN AT LEAST THE 1:20 YEAR ARI, TIME OF CONCENTRATION STORM EVENT.
- WATERWAYS AND OTHER AREAS SUBJECT TO CONCENTRATED FLOWS AFTER CONSTRUCTION ARE TO HAVE A MAXIMUM GROUNDCOVER C-FACTOR OF 0.05 (70% GROUND COVER) WITHIN 10 WORKING DAYS FROM COMPLETION OFFORMATION. FLOW VELOCITIES ARE TO BE LIMITED TO THOSE SHOWN INTABLE 5-1 OF "MANAGING URBAN STORMWATER SOILS AND CONSTRUCTION DEPT OF HOUSING 1998 (BLUE BOOK). FOOT AND VEHICULAR TRAFFIC WILL BE PROHIBITED IN THESE AREAS.
- STOCKPILES AFTER CONSTRUCTION ARE TO HAVE A MAXIMUM GROUND COVER C-FATOR OF 0.1 (60% GROUND COVER) WITHIN 10 WORKING DAYS FROM COMPLETION OF FORMATION.
- ALL LANDS, INCLUDING WATERWAYS AND STOCKPILES, DURING CONSTRUCTION ARE TO HAVE A MAXIMUM GROUND COVER C-FACTOR OF 0.15 (50% GROUND COVER) WITHIN 20 WORKING DAYS FROM INACTIVITY EVEN THOUGH WORKS MAY CONTINUE LATER
- FOR AREAS OF SHEET FLOW USE THE FOLLOWING GROUND COVER PLANT SPECIES FOR TEMPORARY COVER: JAPANESE MILLET 20KG/HA AND OATS.
- PERMANENT REHABILITATION OF LANDS AFTER CONSTRUCTION
  WILL ACHIEVE A GROUND COVER C—FACTOR OF LESS THAN 0.1
  AND LESS THAN 0.05 WITHIN 60 DAYS. NEWLY PLANTED LANDS
  WILL BE WATERED REGULARLY UNTIL AN EFFECTIVE COVER IS
  ESTABLISHED AND PLANTS ARE GROWING VIGOROUSLY
  FOLLOW—UP SEED AND FERTILISER WILL BE APPLIED AS
  2016 (114)
- REVEGATATION SHOULD BE AIMED AT RE-ESTABLISHING NATURAL SPECIES. NATURAL SURFACE SOILS SHOULD BE REPLACED AND NON-PERSISTANT ANNUAL COVER SROPS SHOULS BE USED.

## **DUST CONTROL INSTRUCTIONS**

- ALL STOCKPILED MATERIAL OR SEDIMENT COLLECTION TO BE SPRAYED BY LIGHTLY WIDE ANGLED WATER
- THIS TEMPORARY MECHANICAL METHOD CONFINES AND SETTLES THE DUST FROM THE AIR BY DUST AND WATER PARTICLE ADHESION. WATER IS SPRAYED THROUGH NOZZELS OVER THE PROBLEM AREA.

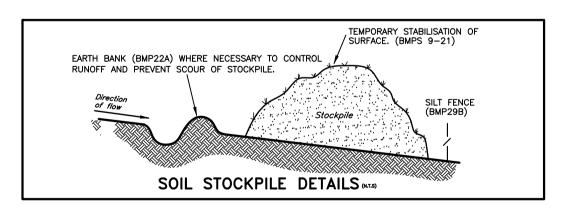

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SOIL MANAGEMENT PLAN

M.W.

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SCALES
A1 - 1:100

ARCHITECT / PROJECT MANAGER

KAE CHAN

DRAWING NO.

C21187 - SW 02

APPROVED

A.C.

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