
Development Application - Alterations and Additions 21/05/2019 04

Crescent House 10 The Crescent North Narrabeen NSW 2101 Australia LOT:11 DP:6462

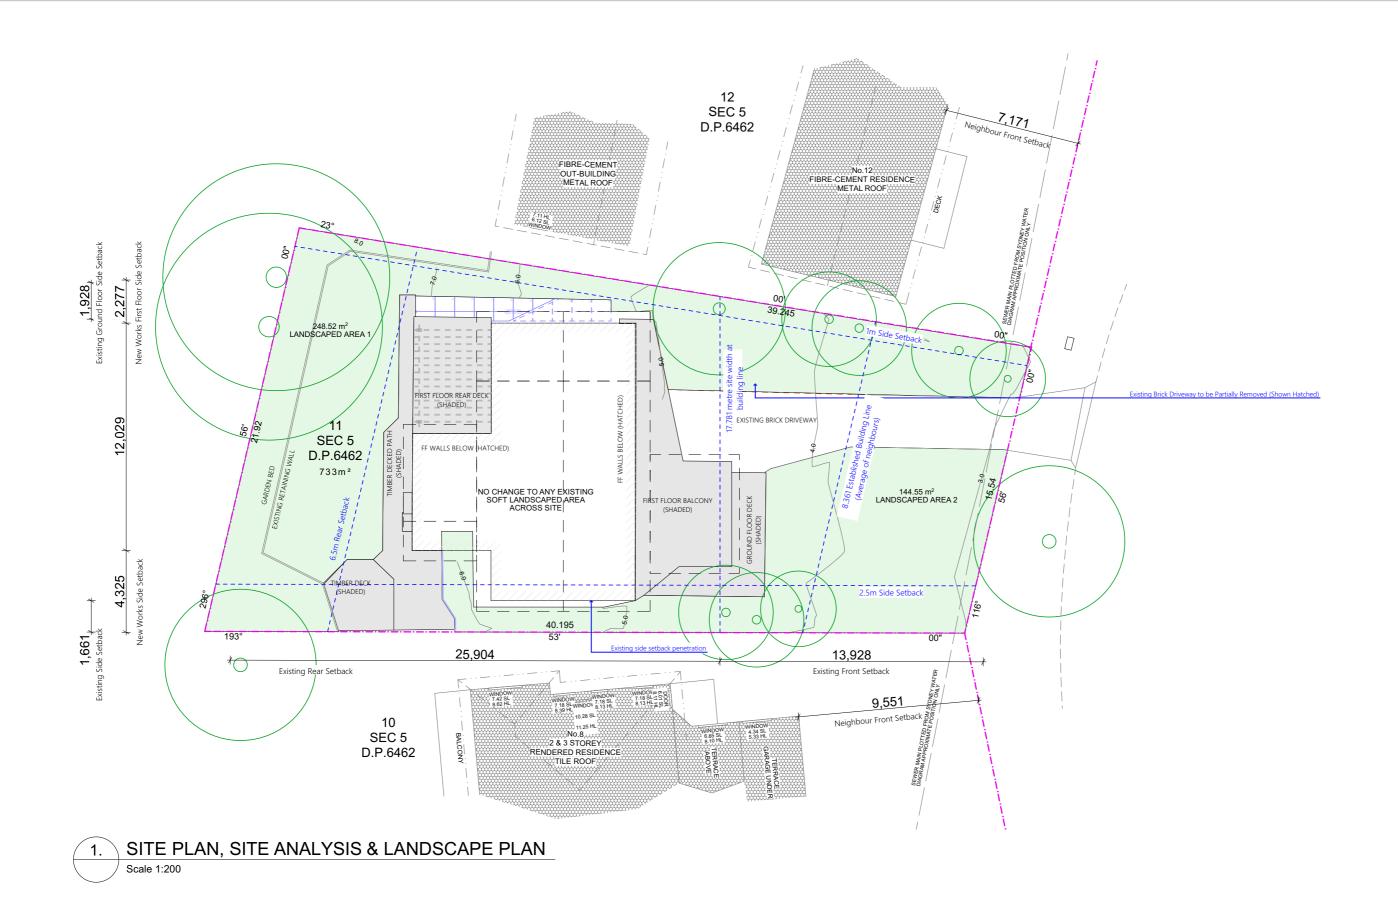

Sheet Index					
Layout ID	Layout Name	Issue ID	Issued	Published	
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A.02.1	Existing/Demolition Ground Floor Plan	04	×	×	
A.02.2	Existing/Demolition First Floor Plan	04	×	×	
A.02.3	Ground Floor Plan	04	×	<b>⊠</b>	
A.02.4	Proposed First Floor Plan	05	×		
A.02.5	Proposed Roof Plan	05	×	×	
A.03.1	North/South Elevation	05	×	×	
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A.06.1	Wall Schedule	04	×	×	
A.06.2	Window Schedule	04	×		
A.06.3	Door Schedule	04	×	×	



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	RevID	Change Name	Date
	01		17/05/2018
ر ا	03		7/11/2018
3	04		14/01/2019
Y	05	Landscape Ratios, DA Setbacks, Rear Pergola	3/04/2019
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PROJECT DETAILS

10 The Crescent

North Narrabeen, NSW 2101

LOT:11 DP: 6462

Crescent House

LODGEMENT SET



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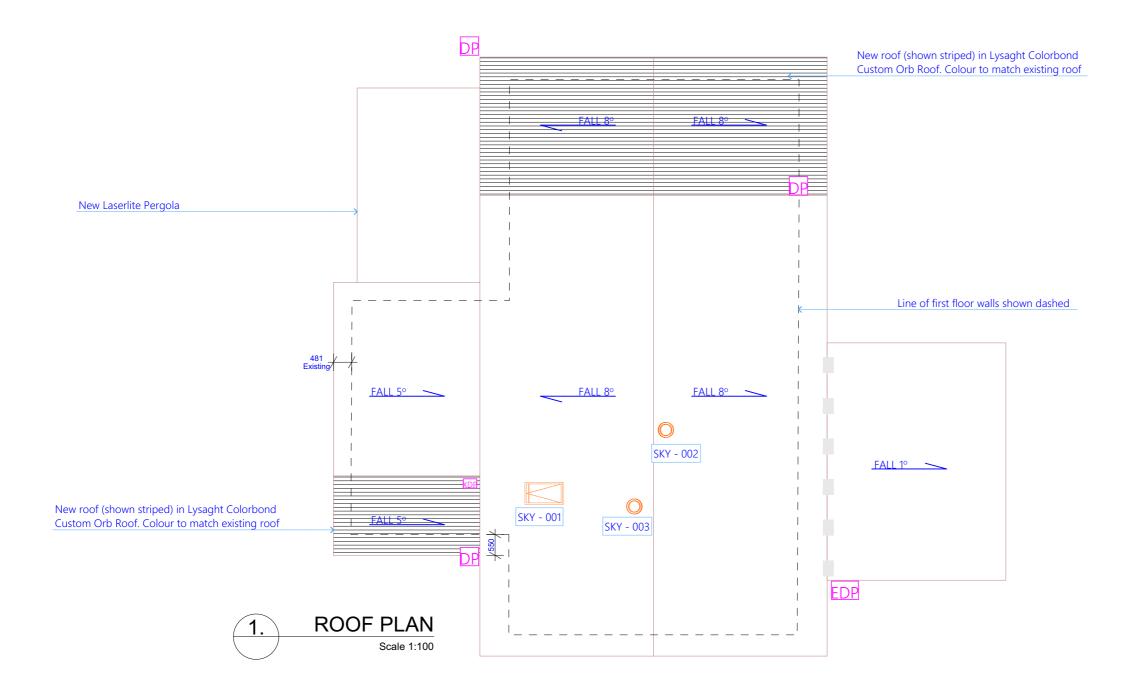
 Plot Date:
 Drawn by:
 Scale:

 21/05/2019
 KS
 1:200 @ A3

 Drawing Title:

Site Plan/Analysis/Landscape Site Plans

Job: Drawing No.: Issue: **1710CRE** A.01.1 05



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01		17/05/2018
03		7/11/2018
04		14/01/2019
05	Rear Pergola	3/04/2019


е	PROJECT DETAILS
8	10 The Crescent
9	North Narrabeen, NSW 210
9	LOT:11 DP: 6462
	Crescent House
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LODGEMENT SET




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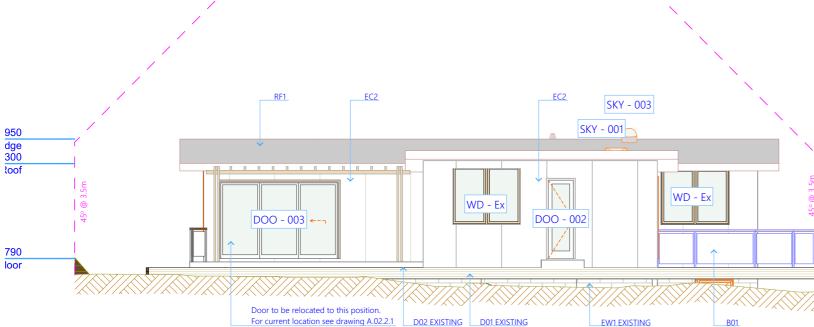
1	Plot Date: Dr	awn by:	Scale:
	21/05/2019	KS	1:100 @ A3
	Drawing Title:		
	Proposed F	Roof Plan	
	Floor Plans		
	Job:	Drawing No.:	Issue:
	1710CRE	A 02 5	05



8.5m Building height plane

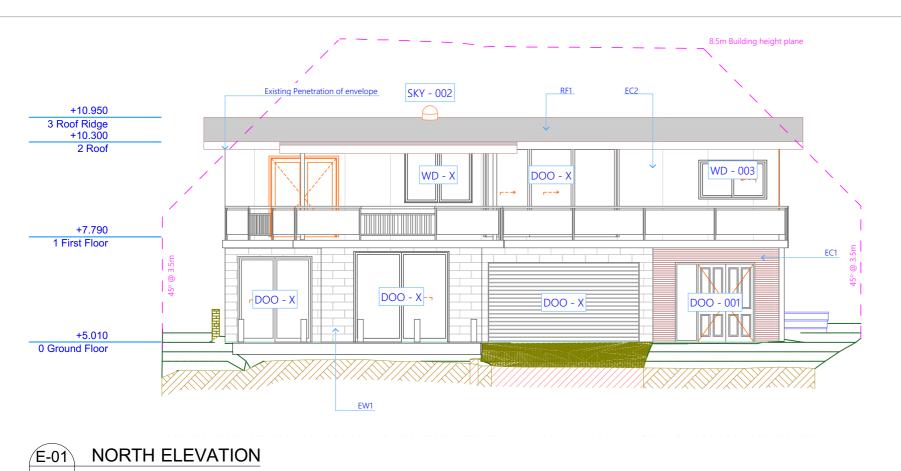

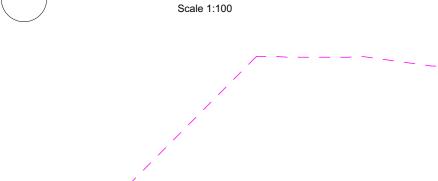NOTES



**SOUTH ELEVATION** E-03 Scale 1:100

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RevID	Change Name	Date
01		17/05/2018
03		7/11/2018
04		14/01/2019
05	Rear Pergola	3/04/2019

PROJECT DETAILS 10 The Crescent North Narrabeen, NSW 2101 LOT:11 DP: 6462 Crescent House

LODGEMENT SET ISSUED



Plot Date: Dra	awn by:	Scale:
21/05/2019	KS	1:100 @ A3
Drawing Title:		
North/Sout	h Elevation	
Elevations		
Job:	Drawing No.:	Issue:
1710CRE	A.03.1	05

LEGE	ND & NOTES
EC1	Innoclad Flat Joint 50mm vertical WC05025. See A.05.1 & A.05.4 for further details.
EC2	HardieFlex 6 x 1200mm Fibre Cement Sheets. See A.05.1 & A.05.3 for further details.
EW1	Existing AAC block wall (or similar) See A.05.1 fo further details
RF1	Lysaght Colorbond Custom Orb Roof. Colour to match existing roof (site inspection required) Sec A.05.1 for further details
B01	Marine ply timber infill (or similar) balustrade painted white with 60mm wide Western Red Cedar top rail (or similar) to match existing first floor balustrades. Min. 1000mm high to comply with BCA 3.9.2.3
B02	Glass balustrade, 1000mm high to comply with BCA 3.9.2.3. 60mm wide Western Red Cedar top rail (or similar). white powdercoated verticals, supplied as a complete approved system with toughened glass and securely fixed to floor.
B03	As per B02, however, 865mm high to comply with BCA 3.9.2.3
LP01	Capral Aluminium Extrusion Louvre profile EP13373 finished in Western Red Cedar by DecoWood. Arranged through DecoWood. Bottom seated in Western Red Cedar top rail of balustrade and top seated in custom white powdercoated track affixed to cathedral ceiling. Builder to liaise with designer and determine fixing and track detail to raked ceiling prior to ordering.
IP3	See A.05.1 Wall Schedule
D01	(Existing) Merbau (or similar) Timber Deck
D02	(Existing) Fibre-Cement Rear Deck
CFT	Ceramic Floor Tile - Client to Source


Timber Flooring - Client to Source

(Existing) Exposed Slab

Carpet with Foam Underlay - Client to Source

90mm Downpipe

**Existing Downpipe** 

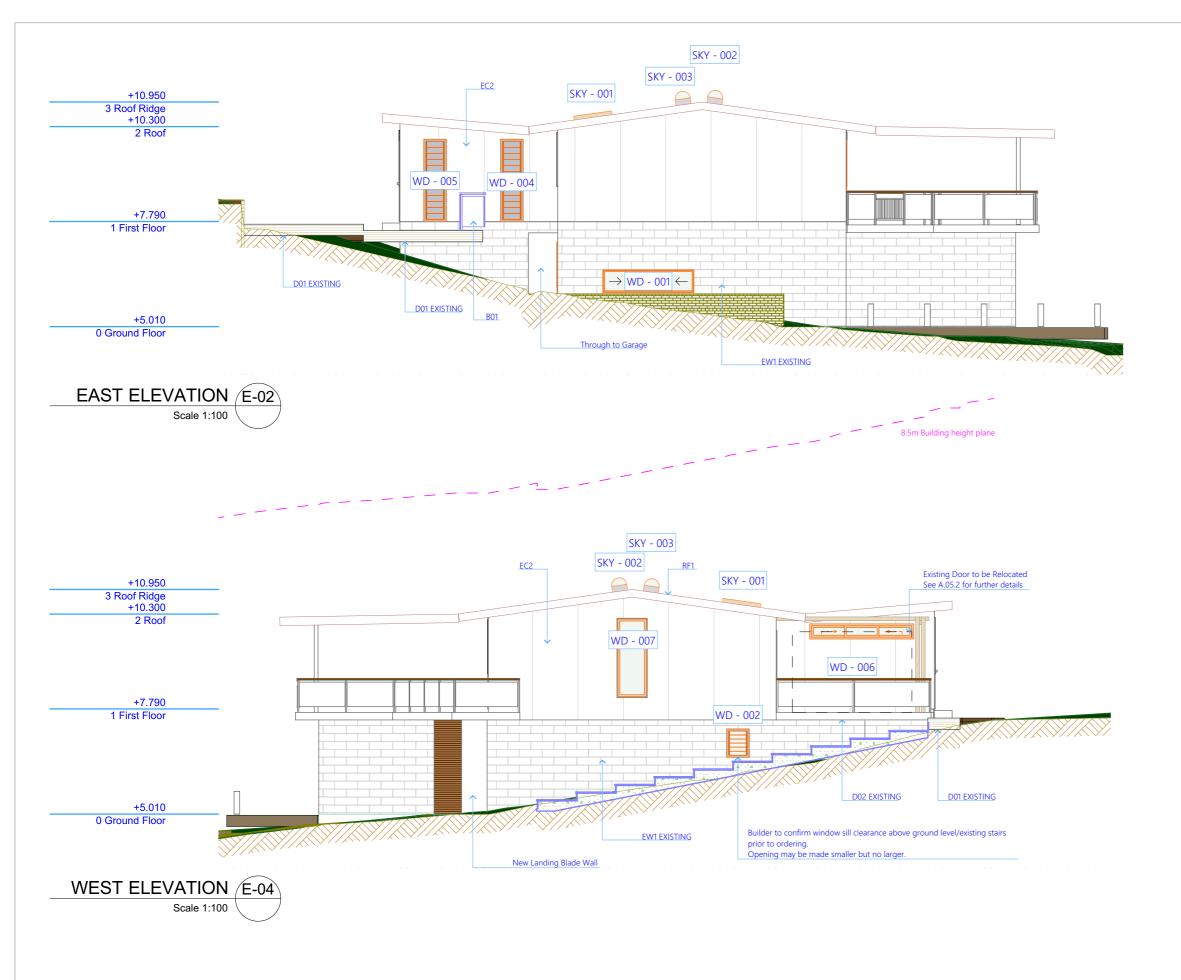

## **LEGEND & NOTES** Innoclad Flat Joint 50mm vertical WC05025. See A.05.1 & A.05.4 for further details. HardieFlex 6 x 1200mm Fibre Cement Sheets. See A.05.1 & A.05.3 for further details. Existing AAC block wall (or similar) See A.05.1 for further details Lysaght Colorbond Custom Orb Roof. Colour to match existing roof (site inspection required) See A.05.1 for further details Marine ply timber infill (or similar) balustrade painted white with 60mm wide Western Red Cedar top rail (or similar) to match existing first floor balustrades. Min. 1000mm high to comply with BCA 3.9.2.3 Glass balustrade, 1000mm high to comply with BCA 3.9.2.3. 60mm wide Western Red Cedar top rail (or similar). white powdercoated verticals, supplied as a complete approved system with toughened glass and securely fixed to floor. As per B02, however, 865mm high to comply with BCA 3.9.2.3 Capral Aluminium Extrusion Louvre profile EP13373 finished in Western Red Cedar by DecoWood. Arranged through DecoWood. Bottom seated in Western Red Cedar top rail of balustrade and top seated in custom white powdercoated track affixed to cathedral ceiling. Builder to liaise with designer and determine fixing and track detail to raked ceiling prior to ordering. See A.05.1 Wall Schedule (Existing) Merbau (or similar) Timber Deck (Existing) Fibre-Cement Rear Deck

Ceramic Floor Tile - Client to Source

Timber Flooring - Client to Source

Carpet with Foam Underlay - Client to Source

(Existing) Exposed Slab

90mm Downpipe

**Existing Downpipe** 

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DESIGNER

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	ReviD	Change Name	Date	
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	03		7/11/2018	
	04		14/01/2019	
3Y	05	Rear Pergola	3/04/2019	
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PROJECT DETAILS

10 The Crescent

North Narrabeen, NSW 2101

LOT:11 DP: 6462

Crescent House

LODGEMENT SET




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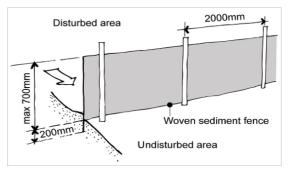
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Plot Date: Dr	awn by:	Scale:
21/05/2019	KS	1:100 @ A3
Drawing Title:		
East/West 8	Elevation	
Elevations		
Job:	Drawing No.:	Issue:
1710CRE	A 03 2	05



RevID | Change Name

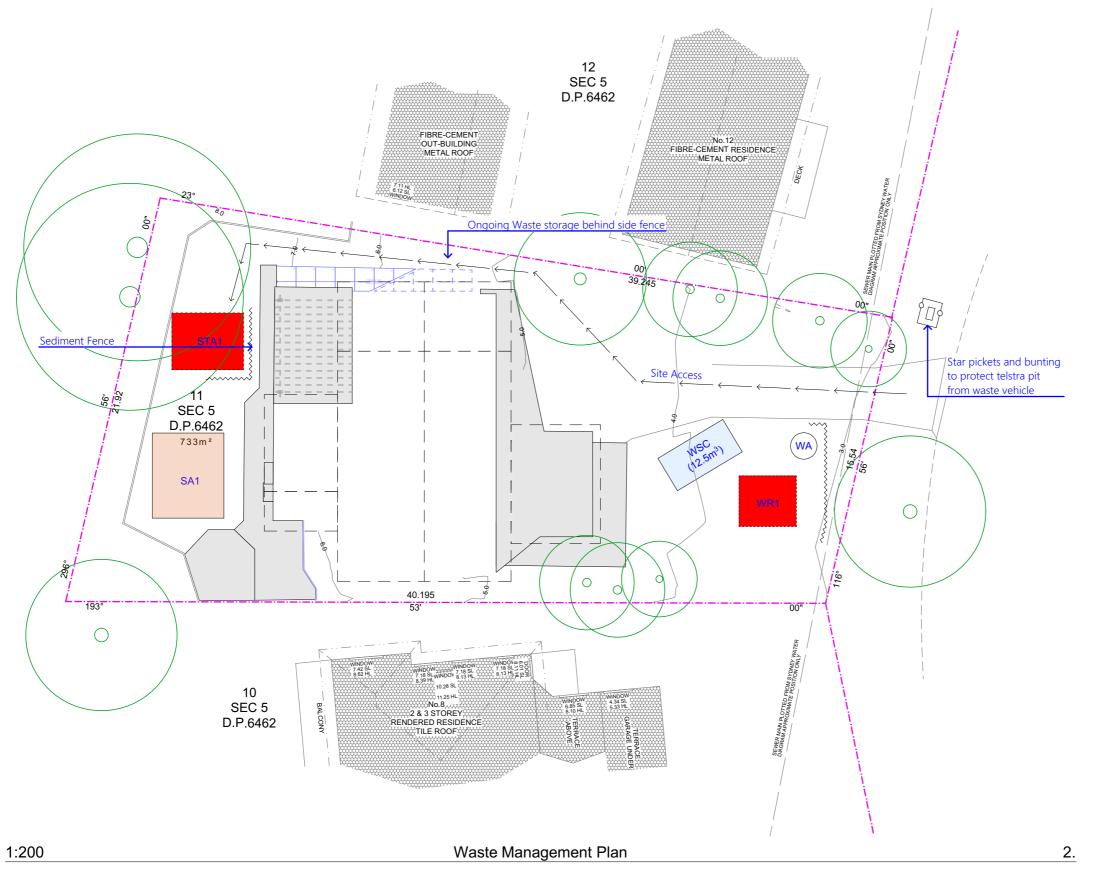

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## WAST MANAGEMENT SITE PLAN LEGEND & NOTES

SA Stockpile Area
WA Wash Area

STA Storage Area

WSC Waste Storage Container

WR Waste Recycling

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	01	Rear Pergola	17/05/2019	10 The Crescer
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PROJECT DETAILS

10 The Crescent

North Narrabeen, NSW 2101

LOT:11 DP: 6462

Crescent House



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Plot Date: Drawn by: Scale:
21/05/2019 KS 1:200 @ A3
Drawing Title:
Waste Management Plan
Other Plans

Job: Drawing No.: Issue: **1710CRE** A.05.1 06

Wall Schedule						
Full Element ID	EC2	IP1	IP3	XW1	XW2	XW3
Renovation Status	New	New	New	Existing	Existing	Existing
Position	Exterior	Interior	Interior	Interior	Exterior	Exterior
2D Plan Preview						
3D Axonometry						
Thickness [m]	140	110	140	110	250	140
Fire Resistance Rat	Undefined	Undefined	Undefined	Undefined	Undefined	25 minutes
External Finish	Paint to Match Existing - Client to Specify	N/A	Western Red Cedar	N/A	Exterior Paint	Exterior Paint
External Cladding	HardieFlex 6mm x 1200mm Fibre Cement Sheets	N/A	Innoclad Flat Joint 50mm Vertical WC05025. Direct Fix on Ply - No batten/tophat	N/A	N/A	HardieFlex 1200mm Fibre Cement Sheets
Membrane <0.5MNs	HardieWrap Weather Barrier	N/A	N/A	N/A	N/A	Undetermined
Core Insulation	Rockwool / Mineral Wool	N/A	N/A	N/A	N/A	Undetermined
Core/Structure	90mm Timber Frame	90mm Timber Frame	90mm Timber Frame	90mm Timber Frame	AAC Block Wall	90mm Timber Frame
Internal Lining	10mm Gyprock Plus	10mm Gyprock Plus	10mm Gyprock Plus	10mm Gyprock Plus	N/A	10mm Gyprock Plus
Internal Finish	Interior Paint - Client to Specify	Interior Paint - Client to Specify	Interior Paint - Client to Specify	Interior Paint	Interior Paint	Interior Paint
Notes			External cladding/finish on IP3 refers to primary interior face	Existing Wall. Wall construction and finishes are assumptions only. For further accuracy a site visit should be conducted	Existing Wall. Wall construction and finishes are assumptions only. For further accuracy a site visit should be conducted	Existing Wall. Wall construction and finishes are assumptions only. For further accuracy a site visit should be conducted

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	01		17/05/2018
	03		7/11/2018
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PROJECT DETAILS

10 The Crescent

North Narrabeen, NSW 2101

LOT:11 DP: 6462

Crescent House

LODGEMENT SET



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Plot Date: Drawn by: Scale:
21/05/2019 KS @ A3
Drawing Title:
Wall Schedule
Schedules
Job: Drawing No.: Issue:
1710CRE A.06.1 04

	IES-02 Window Schedule											
Full Element ID	SKY - 001	SKY - 002	SKY - 003	WD - 001	WD - 002	WD - 003	WD - 004	WD - 005	WD - 006	WD - 007	WD - 008	WD - X
Quantity	1	1	1	1	1	1	1	1	1	1	1	1
W x H Size				2,410×600	600×753	1,800×1,030	600×2,176	600×2,176	1,810×1,540	2,750×400	800×2,100	1,785×1,48
Model	Velux VSE 2004 C04 Electric Skylight (550 x 980)	Velux Flexible Sun Tunnel TWF 0K14	Velux Flexible Sun Tunnel TWF 0K14	Stegbar sliding aluminium window SW0624 or similar	102mm Blade Breezeway Louvre	Stegbar sliding aluminium window SW1021 or similar	152mm Blade Breezeway Louvre	152mm Blade Breezeway Louvre	Stegbar sliding aluminium window SW1518 or similar	Undefined	Custom Fixed glass window	Undefined
Sill height				900	1,500	1,000	0	0	900	1,850	300	900
Head height				1,500	2,253	2,030	2,176	2,176	2,440	2,250	2,400	2,380
2D Symbol		0	0			<u></u>			<u> </u>			
View from Side Opposite to Opening Side				$\rightarrow$ $\leftarrow$								
Fire Resistance Rating	Undefined	Undefined	Undefined	Undefined	Undefined	Undefined	Undefined	Undefined	25 minutes	Undefined	25 minutes	25 minutes
Thermal Transmittance	Undefined	Undefined	Undefined	Undefined	Undefined	Undefined	Undefined	Undefined	Undefined	Undefined	Undefined	Undefined
Sound Transmission Class	Undefined	Undefined	Undefined	Undefined	Undefined	Undefined	Undefined	Undefined	25	Undefined	25	25

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	01		17/05/2018
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PROJECT DETAILS

10 The Crescent

North Narrabeen, NSW 2101

LOT:11 DP: 6462

Crescent House

LODGEMENT SET



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Plot Date: Drawn by: Scale:
21/05/2019 KS @ A3
Drawing Title:
Window Schedule
Schedules

Job: Drawing No.: Issue:
1710CRE A.06.2 04

		IES-02 Door Schedule		
Full Element ID	DOO - 001	DOO - 002	DOO - 003	DOO - Ex
W x H Size	2,100×2,100	720×2,100	3,160×2,040	1,765×2,100
Model	Fixed Glass Sidelight / Double Timber Door	External Glazed Door	Relocated Door. See A.02.2	Undefined
2D Symbol				
View from Side Opposite to Opening Side				
Fire Resistance Rating	Undefined	Undefined	Undefined	25 minutes
Thermal Transmittance	Undefined	Undefined	Undefined	Undefined
Sound Transmission Class	Undefined	Undefined	Undefined	25



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	RevID	Change Name	Date	PROJECT DETAILS
	01		14/01/2019	10 The Crescer
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				Stage:
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Date PROJECT DETAILS 10 The Crescent North Narrabeen, NSW 2101 LOT:11 DP: 6462 Crescent House



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21/05/2019 KS @ A3 Drawing Title: Door Schedule Schedules **1710CRE** A.06.3 04