SCOTT AND JESS SHEPHERD

PROPOSED NEW DWELLING, INCLUDING NEW POOL AND LANDSCAPING

67 WOOLGOOLGA STREET NORTH BALGOWLAH SYDNEY NSW

DA DOCUMENTATION SCHEDULE

DWG NO.	SUBSET	TITLE	SCALE	REV.	DATE	STATUS
DA-000	COVER & SITE INFORMATION	COVER PAGE & DRAWING SCHEDULES		01	01/03/23	DEVELOPMENT APPLICATION
DA-001	COVER & SITE INFORMATION	SITE PLAN	1:200	01	01/03/23	DEVELOPMENT APPLICATION
DA-100	GENERAL ARRANGEMENT PLANS	LOWER GROUND FLOOR	1:100	01	01/03/23	DEVELOPMENT APPLICATION
DA-101	GENERAL ARRANGEMENT PLANS	GROUND FLOOR	1:100	01	01/03/23	DEVELOPMENT APPLICATION
DA-102	GENERAL ARRANGEMENT PLANS	FIRST FLOOR	1:100	01	01/03/23	DEVELOPMENT APPLICATION
DA-300	ELEVATIONS	SHEET 01	1:100	01	01/03/23	DEVELOPMENT APPLICATION
DA-301	ELEVATIONS	SHEET 02	1:100	01	01/03/23	DEVELOPMENT APPLICATION
DA-400	SECTIONS	SHEET 01	1:100	01	01/03/23	DEVELOPMENT APPLICATION
DA-500	SITE STRATEGY PLANS	LANDSCAPE CONCEPT PLANS	1:200	01	01/03/23	DEVELOPMENT APPLICATION
DA-501	SITE STRATEGY PLANS	SITE ANALYSIS PLANS	1:200	01	01/03/23	DEVELOPMENT APPLICATION
DA-502	SITE STRATEGY PLANS	WASTE MANAGEMENT, EROSION & SEDIMENT CONTROL PLAN	1:200	01	01/03/23	DEVELOPMENT APPLICATION
DA-503	SITE STRATEGY PLANS	PROPOSED HARD & SOFT LANDSCAPING AREAS	1:200	01	01/03/23	DEVELOPMENT APPLICATION
DA-800	POOL DETAILS	POOL DETAILS	1:100	01	01/03/23	DEVELOPMENT APPLICATION
DA-900	SHADOW DIAGRAMS	SHADOW DIAGRAM 9am	1:200	01	01/03/23	DEVELOPMENT APPLICATION
DA-901	SHADOW DIAGRAMS	SHADOW DIAGRAM 12pm	1:200	01	01/03/23	DEVELOPMENT APPLICATION
DA-902	SHADOW DIAGRAMS	SHADOW DIAGRAM 3pm	1:200	01	01/03/23	DEVELOPMENT APPLICATION

EXTERNAL FINISHES



2. External Cladding- Neutral Grey/Green Tone



3. Windows & Doors - Light Steel Doors



4. Hardwood Timber Pergola and Battens



5. Native Gardens & Landscaping

6. External Hard Surface - Recycled Brick/Cotto Paving



8. Roofing - Pale Eucalypt Sheeting

- recommend that rainwater be used for human consumption in areas with potable water supply.) a tap that is located within 10 metres of the swimming pool in the development.

Swimming Pool The swimming pool must not have a volume greater than 38.83 kilolitres. The swimming pool must have a pool cover. The swimming pool must be outdoors.

THERMAL COMFORT COMMITMENTS

- 1. Waffle pod slab (lower & ground floor)
- 2. Minimum R2.0 insulation to all lightweight external walls
- 3. R2.0 insulation rumpus external walls & walls adjacent to earth
- 4. R5.0 insulation to ceilings (excluding garage)
- 5. R2.0 insulation to walls between house & garage 6 B2 0 insulation to ceiling/floor between house & garage
- 7. R2.0 insulation to ceiling/floor between ground & first floor 8. Weatherseals to all external doors including internal access to garage
- 9. Foil + R1.0 insulation blanket underside of roof
- 10. Light/Medium walls & medium roof colours
- 11. Default floor coverings used in NatHERS rating
- 12. Insulation must be installed in accordance with NCC and relevant Australian Standards.
- 13. Recessed downlights have been included in the NatHERS rating(to be sealed
- LED downlights & covered by insulation) 14. All windows & glazed doors to be single glazed clear with aluminium
- frame(Less than or = to U 6.70, within 10% of SHGC 0.70/0.57) 15. Skylight to be double glazed clear

Floor and Wall Construction

Floor Areas		system.
Conditioned floor area Unconditioned floor area Garage floor area Mezzanine area	403 m2 9 m2 28 m2 0 m2	Other The app the dwe The app
Construction Concrete slab on ground Suspended open subfloor Suspended floor above garage	179 m2 0 m2 22 m2	so that i applicar develop The app part of t
Loads Heating Load Cooling Load	39.7 18.1	

KEY:		PROJECT: PROPOSED NEW DWELLING, INCLUDING NEW NEW LANDSCAPING AND POOL	PROJECT STAGE: DEVELOPMENT APPLICATION
	DENOTES AREA OF SOFT LANDSCAPING		
	DENOTES AREA OF SWIMMING POOL	CLIENT: SCOTT AND JESS SHEPHERD	DRAWING TITLE: COVER & SITE INFORMATION: COVER PAGE
[]]]	DENOTES EXISTING STRUCTURE TO BE DEMOLISHED	SCOTT AND JESS SHEPHEND	& DRAWING SCHEDULES
	DENOTES PROPOSED NEW STRUCTURE	LOCATION: 67 WOOLGOOLGA STREET, NORTH BALGOWLAH, SYDNEY, NSW	SCALE: @ A3

NOTE: THESE DRAWINGS ARE NOT FOR CONSTRUCTION. FOR DA APPROVAL ONLY NOTE: DO NOT SCALE OFF THIS DRAWING NOTE: ALL WORKS TO BE IN ACCORDANCE WITH THE N.C.C. 2019 NOTE: ALL WORKS TO BE IN ACCORDANCE WITH THE RELEVANT AUSTRALIAN STANDARDS NOTE: ALL WORKS TO BE IN ACCORDANCE WITH THE BASIX REQUIREMENTS

SCHEDULE OF BASIX COMMITMENTS

WATER COMMITMENTS

Landscape The applicant must plant indigenous or low water use species of vegetation throughout 440 square metres of the site.

Fixtures The applicant must install showerheads with a minimum rating of 4 star (> 4.5 but <= 6 L/min plus spray force and/or coverage tests) in all showers in the development.

The applicant must install a toilet flushing system with a minimum rating of 6 star in each toilet in the development.

The applicant must install taps with a minimum rating of 6 star in the kitchen in the development.

The applicant must install basin taps with a minimum rating of 6 star in each bathroom in the development.

Rainwater Tank

The applicant must install a rainwater tank of at least 2500 litres on the site. This rainwater tank must meet, and be installed in accordance with, the requirements of all applicable regulatory authorities. The applicant must configure the rainwater tank to collect rain runoff from at least 220 square metres of the roof area of the development (excluding the area of the

roof which drains to any stormwater tank or private dam). The applicant must connect the rainwater tank to:

- at least one outdoor tap in the development (Note: NSW Health does not

Artificial Lighting The applicant must ensure that the "primary type of artificial lighting" is fluorescent or light emitting diode (LED) lighting in each of the following rooms, and where the word "dedicated" appears, the fittings for those lights must only be capable of accepting fluorescent or light emitting diode (LED)

- All bathrooms/toilets; dedicated The laundry: dedicated
- All hallways; dedicated

Natural Lighting

Swimming Pool The development must not incorporate any heating system for the swimming pool.

The applicant must install a timer for the swimming pool pump in the development.

Alternative Energy The applicant must install a photovoltaic system with the capacity to generate at least 1 peak kilowatts of electricity as part of the development. The applicant must connect this system to the developments electrical

oplicant must install a gas cooktop & electric oven in the kitchen of /elling. plicant must construct each refrigerator space in the development it is "well ventilated", as defined in the BASIX definitions. The ant must install a fixed outdoor clothes drying line as part of the oment pplicant must install a fixed indoor or sheltered clothes drying line as . the development.







7. Fine Metal Baulstrade Light Paint Finish

ENERGY COMMITMENTS

Hot Water

Cooling System

entilation

development:

The applicant must install the following hot water system in the development, or a system with a higher energy rating: gas instantaneous with a performance of 6 stars.

The applicant must install the following cooling system, or a system with a higher energy rating, in at least 1 living area: - 1-phase air-conditioning; Energy rating: 6 Star (old label)

The applicant must install the following cooling system, or a system with a higher energy rating, in at least 1 bedroom:

1-phase air-conditioning; Energy rating: 6 Star (old label)

 $\frac{\text{Heating System}}{\text{The applicant must install the following heating system, or a system with a}$ higher energy rating, in at least 1 living area: - gas fixed flued heater; Energy rating: 5 star

The applicant must install the following heating system, or a system with a higher energy rating, in at least 1 living area: 1-phase air-conditioning; Energy rating: 6 Star (old label)

The applicant must install the following exhaust systems in the

At least 1 Bathroom: individual fan, ducted to façade or roof; Operation control: manual on / timer off Kitchen: no mechanical ventilation (ie. natural) Laundry: natural ventilation only, or no laundry; Operation control: n/a

lamps: - At least 6 of the bedrooms / study; dedicated - At least 3 of the living / dining rooms; dedicated - The kitchen; dedicated

The applicant must install a window and/or skylight in the kitchen of the dwelling for natural lighting.

The applicant must install a window and/or skylight in 2 bathroom(s)/ toilet(s) in the development for natural lighting.





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REVISION 01







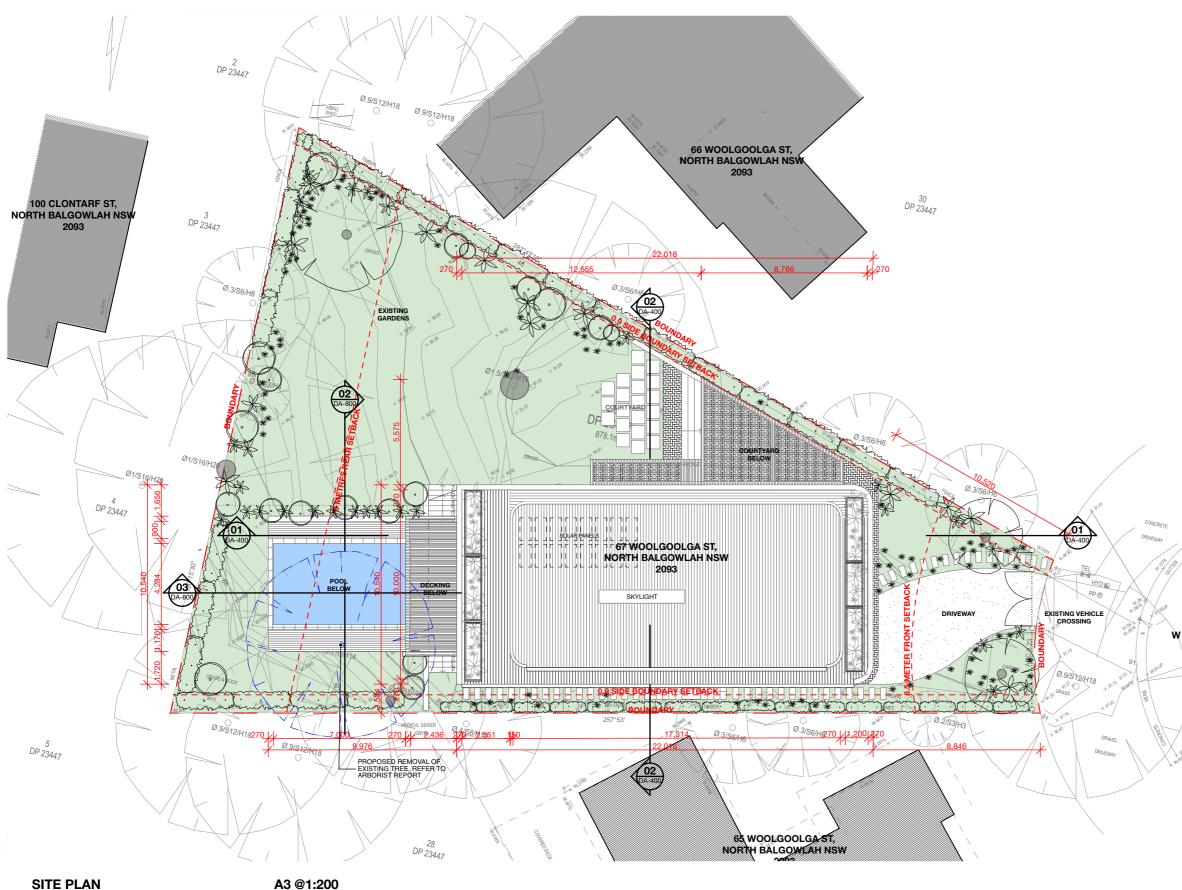

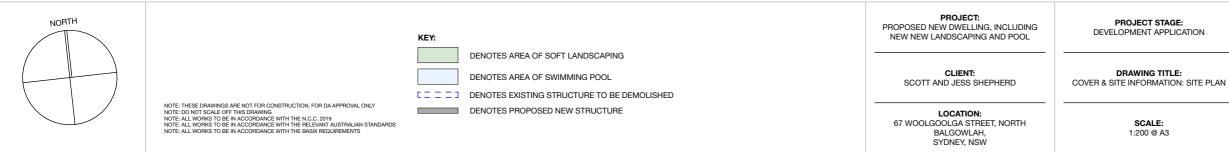WOOLGOOLGA STREET

SITE CALCULATIONS	
TOTAL SITE ABEA	878m ²
PROPOSED	010111
LOWER GROUND FLOOR - GROSS FLOOR AREA	77.2m ²
GROUND FLOOR - GROSS FLOOR AREA	167.95 m ²
FIRST FLOOR - GROSS FLOOR AREA	142.3 m ²
TOTAL - GROSS FLOOR AREA	387.45 m ²
GARAGE AND STORAGE - AREA	26.1 m ²
ROOF - AREA	264.1m ²
HARD SURFACE CALCULATION - AREA	302.29m²/34.49
SOFT LANDSCAPING CALCULATION - AREA	461.35m²/52.5%
POOL - VOLUME	38.83m ³

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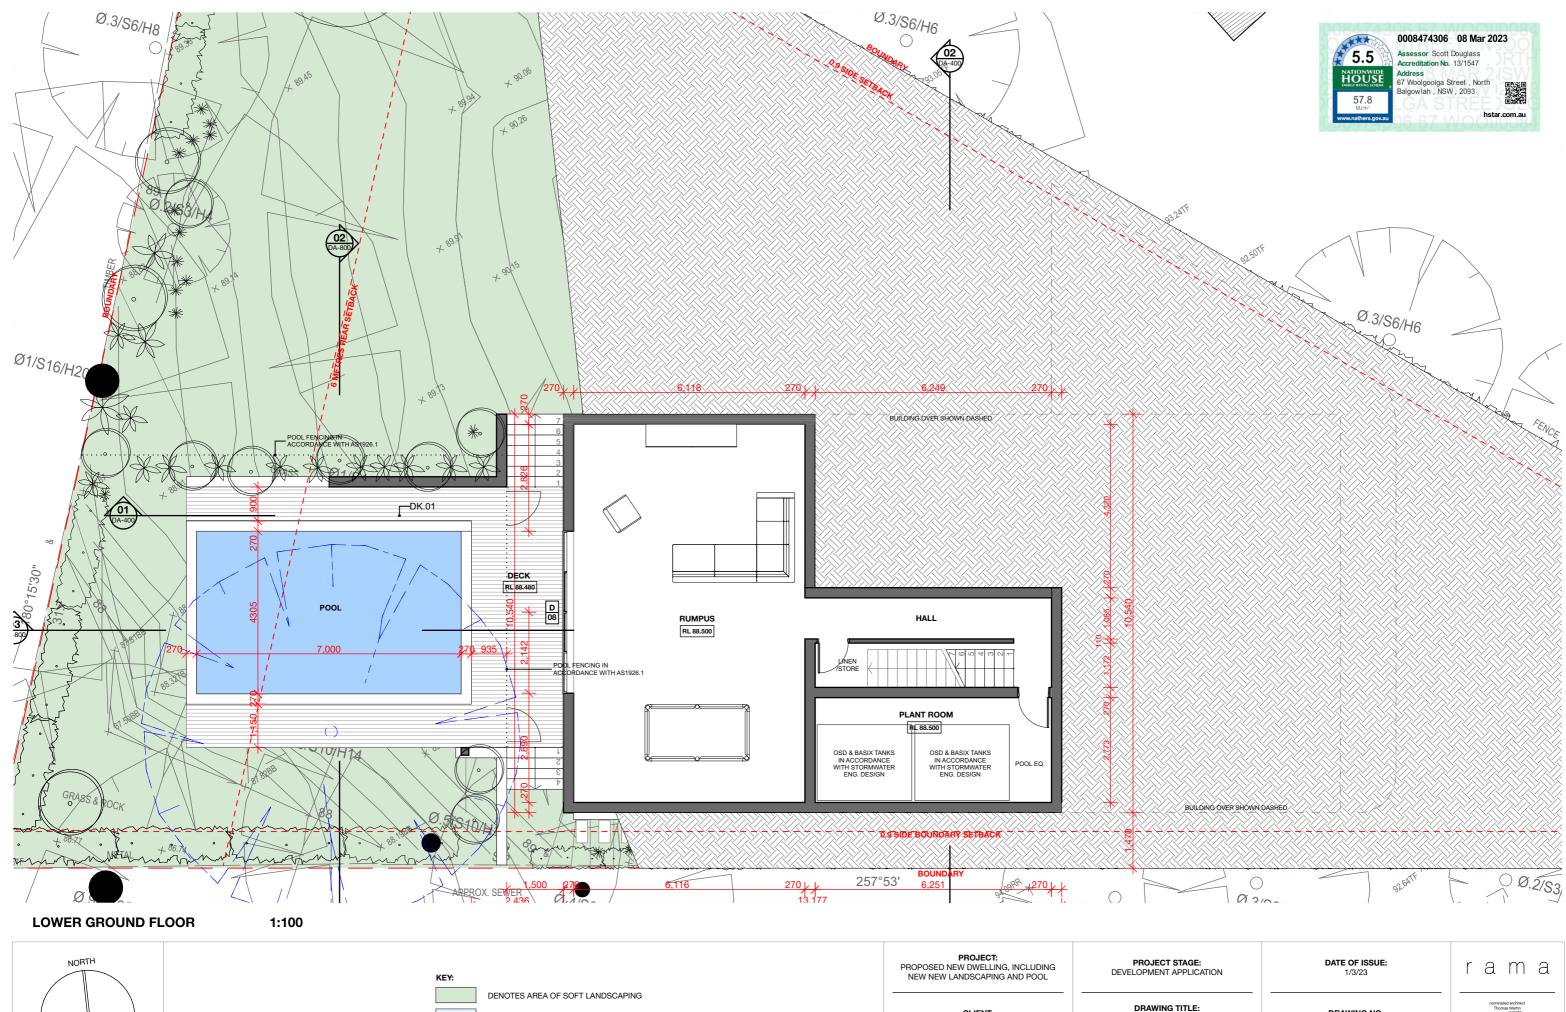
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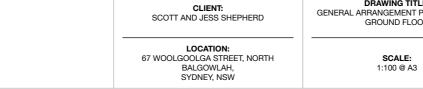
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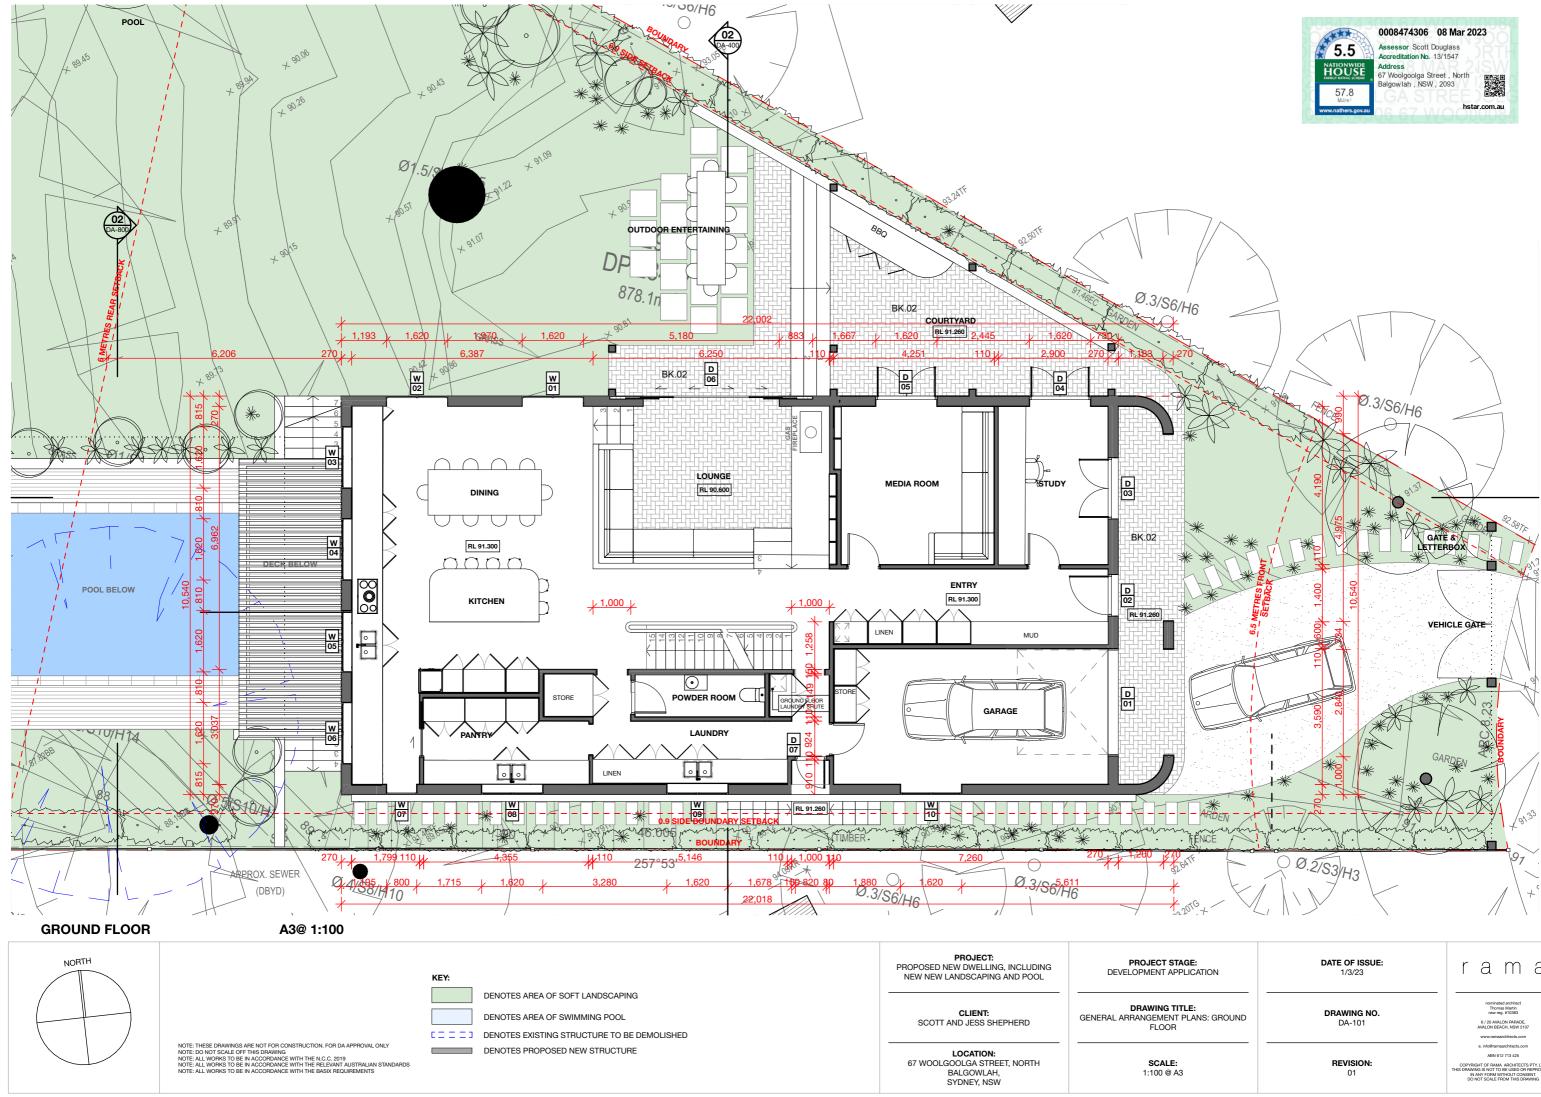







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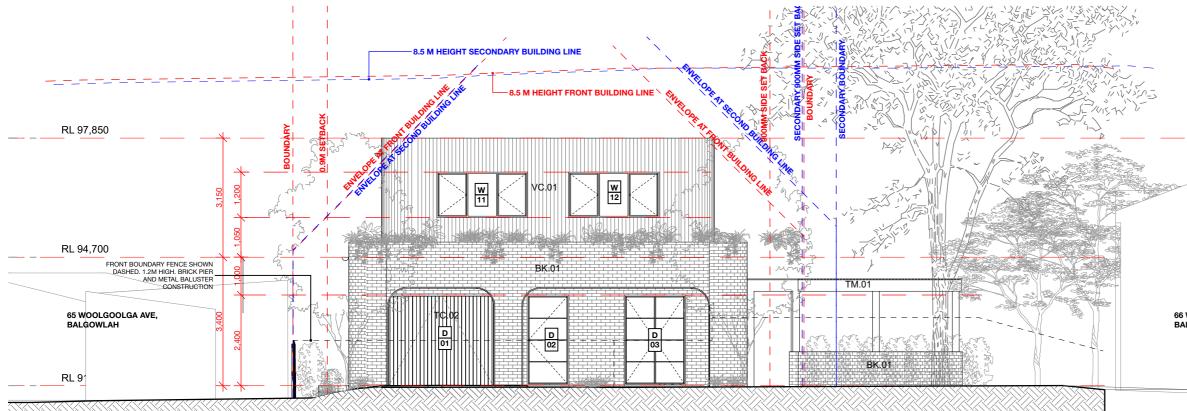
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DENOTES AREA OF SWIMMING POOL

DENOTES PROPOSED NEW STRUCTURE

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CLIENT: DRAWING TITLE: SCOTT AND JESS SHEPHERD ELEVATIONS: SHEET 01

LOCATION: 67 WOOLGOOLGA STREET, NORTH BALGOWLAH, SYDNEY, NSW

SCALE: 1:100 @ A3

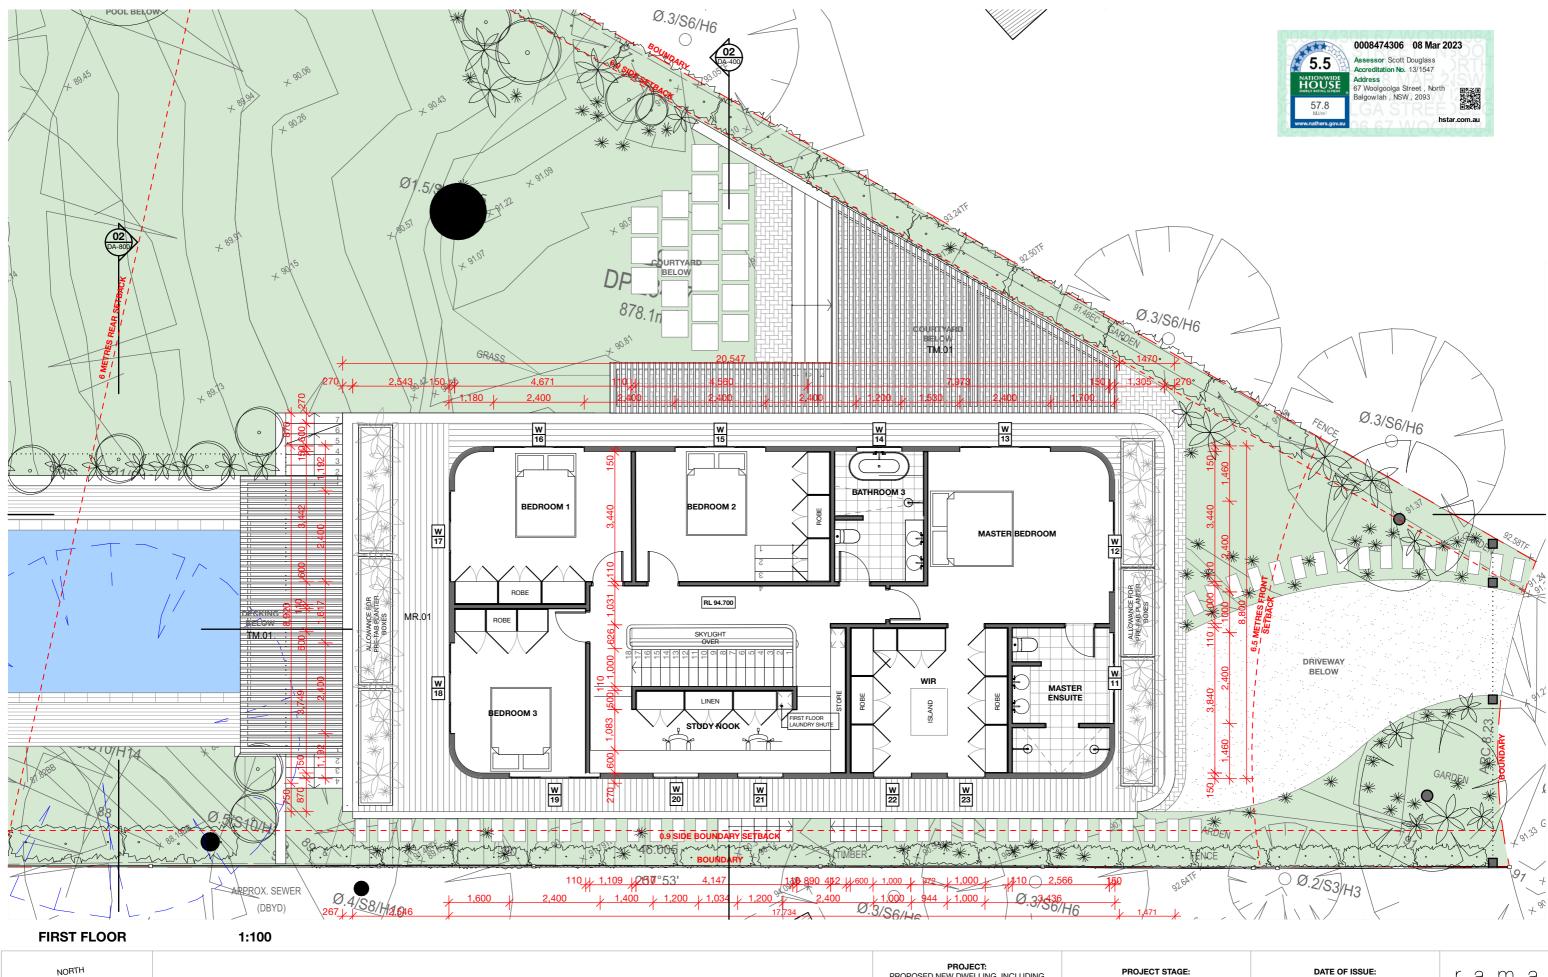MATERIALS SCHEDULE				
ID DESCRIPTION				
D	STEEL FRAMED DOOR - WHITE POWDER COAT FINISH			
W STEEL FRAMED WINDOW - WHITE POWDER COAT FINIS BK-01 BAGGED BRICKWORK - LIGHT PAINT FINISH				
		BK-02	RECYCLED BRICK PAVING	
VC-01	VERTICAL TIMBER CLADDING MID TONE FINISH			
MB.01 VERTICAL METAL BALUSTRADE - WHITE PAINT FINISH MR.01 METAL ROOF SHEETING				
		TM 01		




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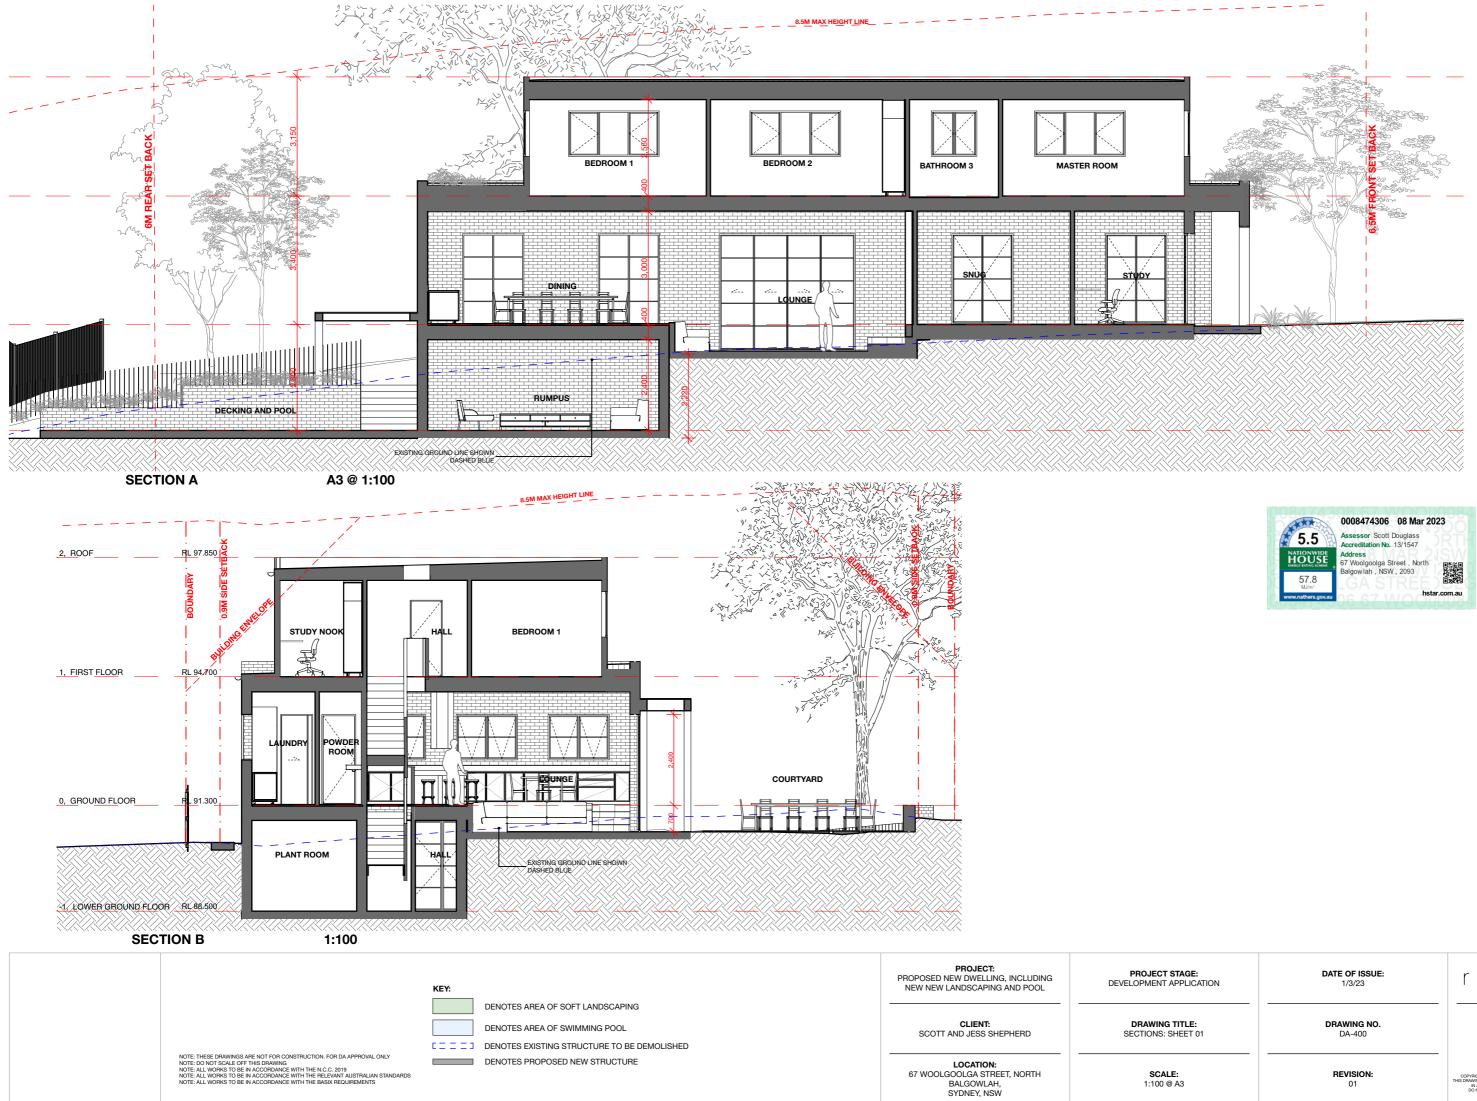
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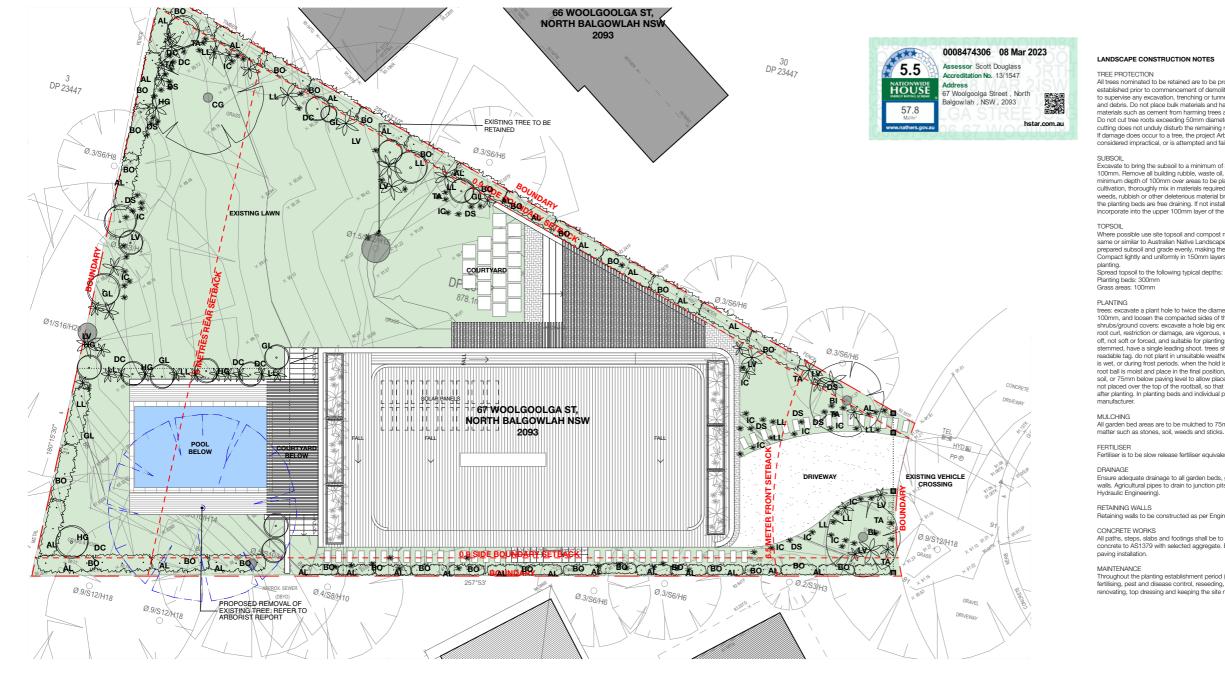
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LANDSCAPE PLAN

TOTAL SITE AREA	878m ²	TOTAL SITE AREA	878m ²
EXISTING		PROPOSED	
LOWER GROUND FLOOR - GROSS FLOOR AREA	N/A	LOWER GROUND FLOOR - GROSS FLOOR AREA	77.2m ²
GROUND FLOOR - GROSS FLOOR AREA	N/A	GROUND FLOOR - GROSS FLOOR AREA	167.95 m ²
FIRST FLOOR - GROSS FLOOR AREA	N/A	FIRST FLOOR - GROSS FLOOR AREA	142.3 m ²
TOTAL - GROSS FLOOR AREA	N/A	TOTAL - GROSS FLOOR AREA	387.45 m ²
GARAGE AND STORAGE - AREA	N/A	GARAGE AND STORAGE - AREA	26.1 m ²
ROOF - AREA	N/A	ROOF - AREA	2246.7m ²
HARD SURFACE - AREA	N/A	HARD SURFACE CALCULATION - AREA	302.29m ² /34.4%
SOFT LANDSCAPE - AREA	N/A	SOFT LANDSCAPING CALCULATION - AREA	461.35m²/52.5%
POOL - VOLUME	N/A	POOL - VOLUME	38.83m ³

1:200

PLANT	PLANT SCHEDULE			
ID	QUANTITY	BOTANICAL NAME	COMMON NAME	SIZE
TREES				
CG	1	CORYMBIA GUMMIFERA	RED BLOODWOOD	100L
BI	2	BANKSIA INTERGRIFOLIA	COAST BANKSIA	100L
SCREEM	NING PLANTS			
AL	36	ACACIA LINIFOLIA	FLAX LEAVED WATTLE	300MM
BO	47	BANKSIA OBLONGIFOLIA	FERN LEAFED BANKSIA	300MM
SHRUB	S/ACCENTS			
LV	30	LEPIDOSPERMA VISCIDUM	STICKY SWORD-SEDGE	300MM
GL	4	GRAVILLIEA LINIARIFLORA	WHITE SPIDER FLOWER	300MM
LL	16	LEPTOSPURNAM LAEVIGITUM	COASTAL TEA TREE	200M
HG	16	HAKEA GIBBOSA	NEEDLE BRUSH HAKEA	500MM
GRASS	ES/GROUND COV	ERS		
DC	28	DANIELLA CAERULLA	BLUE FLAX LILY	150MM
TA	10	THEMEDA AUSTRALIS	KANGAROO GRASS	150MM
DS	18	DICHELACHNE SP.	PLUME GRASS	150MM
IC	38	IMPYRADA CYLINDRICA	BLADY GRASS	140MM
LL	24	LOMANDRA LONGIFOLIA	SPINY HEADED MAT-RUSH	140MM

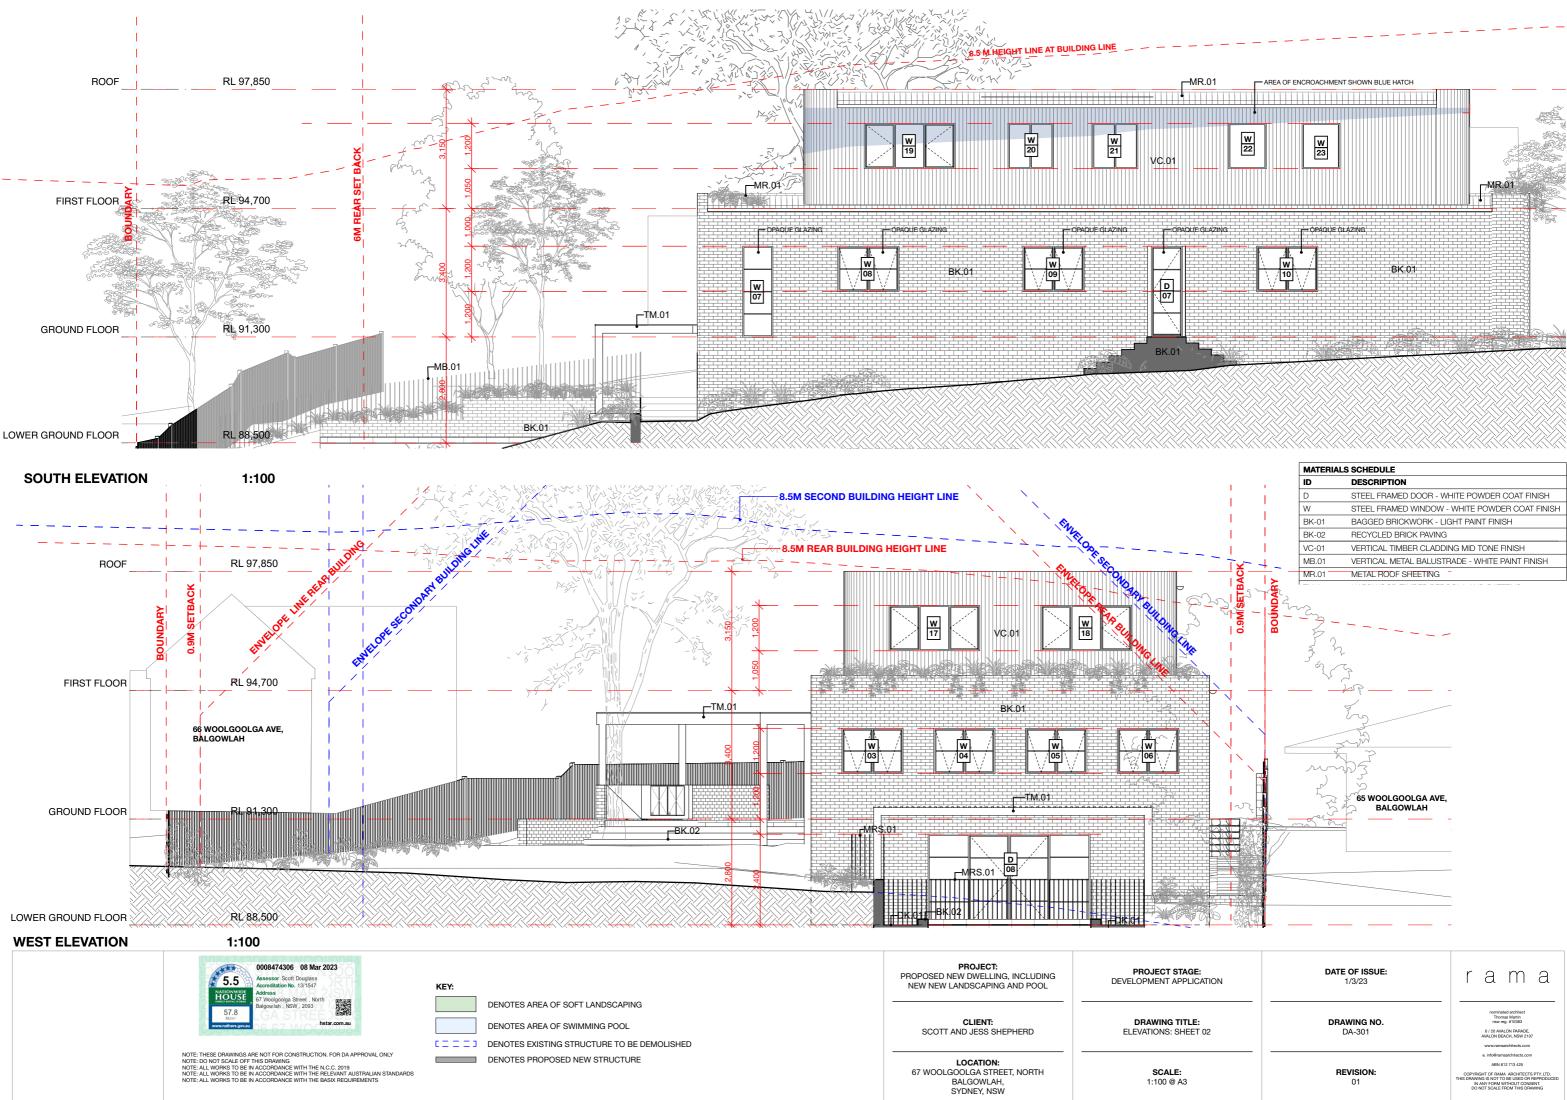

LANDSCAPE CONSTRUCTION NOTES

THEE PROTECTION All trees norminated to be retained are to be protected throughout the duration of the demolition and construction periods. All tree protection enclosures must be established prior to commencement of demolition works and shall comprise a fence enclosure around the TPZ of the tree. The project Arborist must be present to supervise any excavation, trenching or turneling within the PZ of any retained trees if required. Keep the area within the enclosure free of construction material and debris. Do not place bulk materials and harmful materials under or near trees. Do not place spall from excavations against the trunks. Prevent wind blown materials such as cament from harmful materials under or near trees. Do not place spall from excavations against the trunks. Prevent wind blown materials such as cament from harmful materials under or near trees. Do not place spall from excavations against the trunks. Prevent wind blown materials such as cament from harmful materials under or near trees. Do not place spall from excavations against the trunks. Prevent wind blown materials such as cament from harmful materials under or near trees. Do not place based in the roots exceeding 50m diameter. Where it is necessary to cut tree roots, use handsaw, cut cleanly, do not rip with machinery and such that the cutting does not unduly disturb the remaining root system. If damage does occur to a tree, the project Arborist is to attend prior to repairing damage and during repair work. If a tree is damaged and repair work is considered impractical, or is attempted and fails, give notice and obtain instructions.

SUBSOIL Excavate to bring the subsoil to a minimum of 300mm below finished design levels, to allow for infilling with topsoil mix. Break up the soil to a further depth of 100mm. Remove all building rubble, waste oil, cement and other material harmful to plant growth from planting beds prior to placement of topsoil. Cultivate to a minimum depth of 100mm over areas to be planted or grassed. Do not disturb services or tree roots; if necessary, cultivate these areas by hand. During cultivation, thoroughly mix in materials required to be incorporated into the subsoil. Remove stones exceeding 25mm, clods of earth exceeding 50mm, and weeds, rubbish or other deleterious material brought to the surface during cultivation. Tim the surface to the required design levels after cultivation. Confirm that the planting beds are free draining. If not install sub-soil drainage lines and connect to stormwater system. Apply additives after ripping or cultivation and percention the surger of the subsoil. incorporate into the upper 100mm layer of the subsoil.

Where possible use site topsoil and compost mixed at a rate of 4 soil : 1 compost, thoroughly mixed before placement. If imported soil is required soil shall be same or similar to Australian Native Landscapes Premium garden mix or similar for garden bed areas or Turt Underlay mix for turf areas. Spread topsoil on the prepared subsoil and grade evenly, making the necessary allowances so that required finished levels and contours are achieved after light compaction. Compact lightly and uniformly in 150mm layers. Avoid differential subsidence and excess compaction and produce a finished topsoil surface which is ready for

PLANTING PLANTING trees: excavate a plant hole to twice the diameter of the root ball and at least 100mm deeper than the root ball. break up the base of the hole to a further depth of 100mm, and loosen the compacted sides of the hole. shrubs/ground covers: excavate a hole big enough for the plant plus 100mm all round, provide plants which have large healthy root systems, with no evidence of root curl, restriction or damage, are vigorous, well established, free from disease and pests, of good form consistent with the species or variety; and are hardened off, not soft or forced, and suitable for planting in the natural climatic conditions prevailing at the site. Trees: provide trees which, unless required to be multi-stemmed, have a single leading shoot. trees should be staked as specified. Label at leads noe plant of each species or variety in a bacth using a durable, readable tag, do not plant in unsuitable weather conditions such as extreme heat, cold, wind or rini, no ther than sandy solis, suspend excavation when the soil is wet, or during frost periods, when the hold is of the correct size, remove the plant from the container with minimum disturbance to the root ball. ensure that the root ball is moist and place in the final position, in the hole and plumb, with the tops oil level of the plant root ball evel with the finished surface of the surrounding soli, or 75mm below paving level to allow placement of much, backfill with topsoil mixture. lightly tamp and water to eliminate air pockets, ensure that topsoil is not placed over the top of the rootball, so that the plant stem is the same height as in the container. Thoroughy water plants before planting and immediately after planting. In planting beds and individual plantings, place slow release fertiliser pellets around plants at the time of planting at the rate recommended by the manufacturer.

All garden bed areas are to be mulched to 75mm depth with same or similar to Forest Blend. Provide mulch/gravel which is free of deleterious and extraneous matter such as stones, soil, weeds and sticks. Place mulch/gravel clear of plant stems, and rake to an even surface flush with the surrounding finished levels.

Fertiliser is to be slow release fertiliser equivalent to "Osmocote" and is to be applied at manufacturer's specified rates


Ensure adequate drainage to all garden beds, gravel and lawn areas. Install 100mm agricultural pipe with sock as required in garden beds and behind all retaining. valls. Agricultural pipes to drain to junction pits and connect to stormwater system. Ensure paved areas are free draining. Install pits if required. (Refer to

Retaining walls to be constructed as per Engineer's details.

CONVENTE 1E WIUHIKS All paths, steps, slabs and footings shall be to Engineer's specification. Materials and construction to AS3600 and AS3610. Supply and install ready mixed concrete to AS1379 with selected aggregate. Ensure all appropriate PVC conduits for garden lighting and irrigation systems are placed before concrete an paving installation. ete and


MAINI ENANCE Throughout the planting establishment period (minimum 12 weeks), carry out maintenance work including watering, mowing, weeding, rubbish removal, fertilising, pest and disease control, reseeding, returfing, staking and tying, replanting, cultivating, pruning, hedges clipping, aerating, reinstatement of mulch, renovating, top dressing and keeping the site neat and tidy. Continue to replace failed, damaged or stolen plants.

LAND	SCAPE LEGEND			
ID		DESCRIPTION		
\square		PROPOSED FEATURE TREE		
5	in promis	PROPOSED SCREENING PLANT	S	
	\bigcirc	PROPOSED SHRUBS & ACCENT	S	
	×	PROPOSED ACCENTS		
	**	PROPOSED GRASSES AND GRO	OUNDS COVERS	
		PROPOSED LANDSCAPED AREA	A	
		PROPOSED POOL AREA		
10N		DATE OF ISSUE: 1/3/2023	r a m	а
OSCAPE		DRAWING NO. DA-500	nominated architect Thomas Martin nsw reg. #10383 6 / 20 AWALON PARAE AWALON BEACH, NSW : www.ramaarchitects.c	DE, 2107
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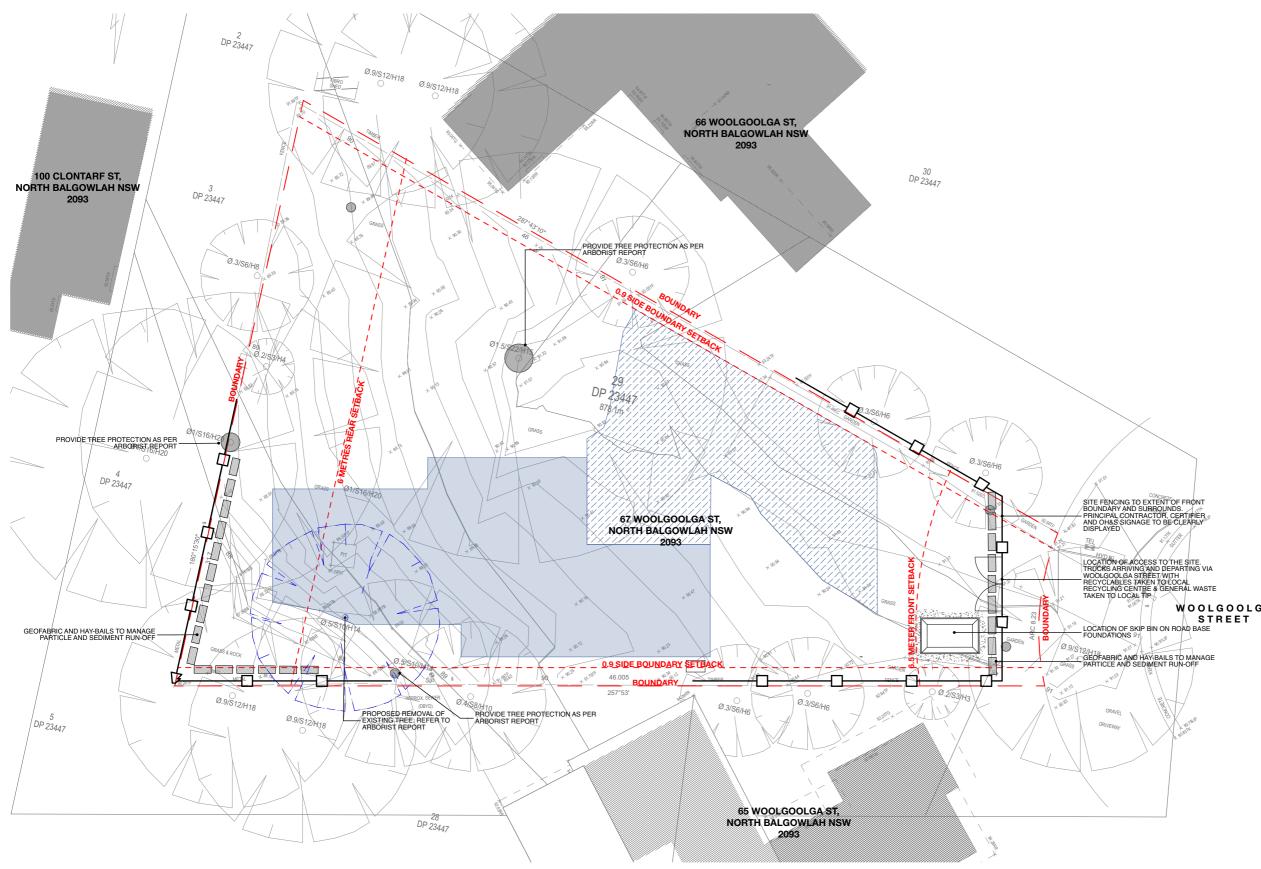


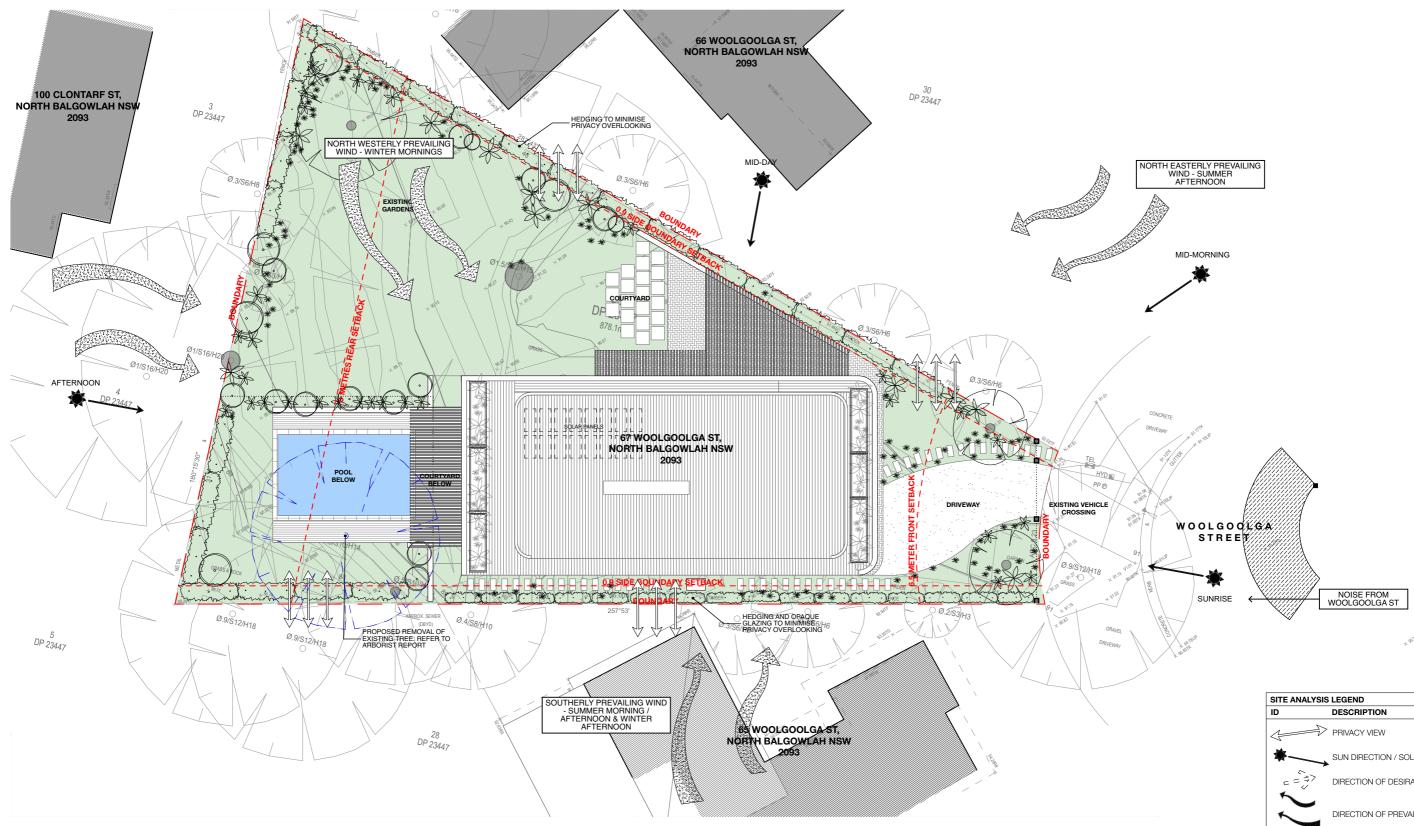

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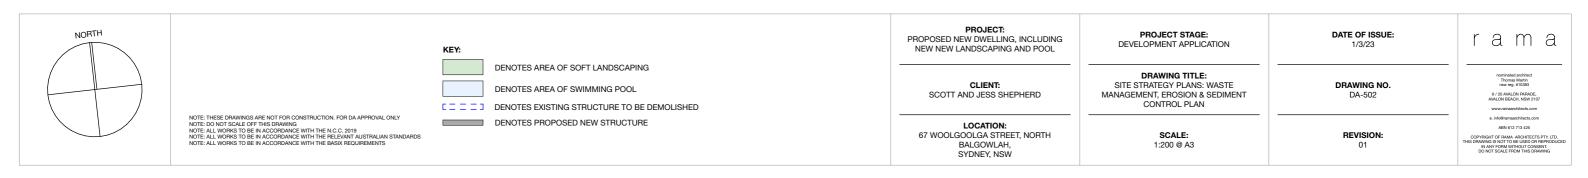


SITE ANALYSIS LEGEND		
ID	DESCRIPTION	
4	PRIVACY VIEW	
*	SUN DIRECTION / SOLAR ACCESS	
====>	DIRECTION OF DESIRABLE VIEWS	
	DIRECTION OF PREVAILING WINDS	
	NOISE SOURCE	

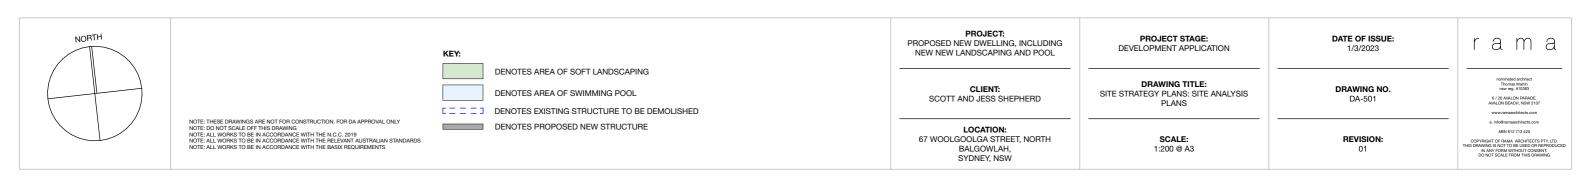


SEDIMENT CONTROL & EROSION PLAN

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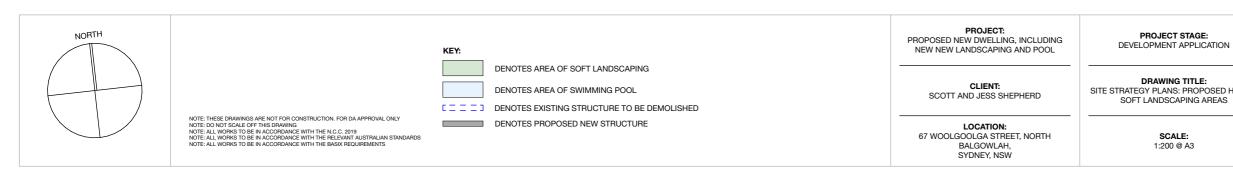


WOOLGOOLGA

SEDIMENT EROSION CONTROL LEGEND		
ID	DESCRIPTION	
	HAY BAIL AND GEOFABRIC	
	SKIP BIN ON ROAD BASE FOUNDATIONS	
-00-	SECURE SITE FENCING	
	LOWER GROUND & POOL EXCAVATION	
	GROUND FLOOR EXCAVATION	

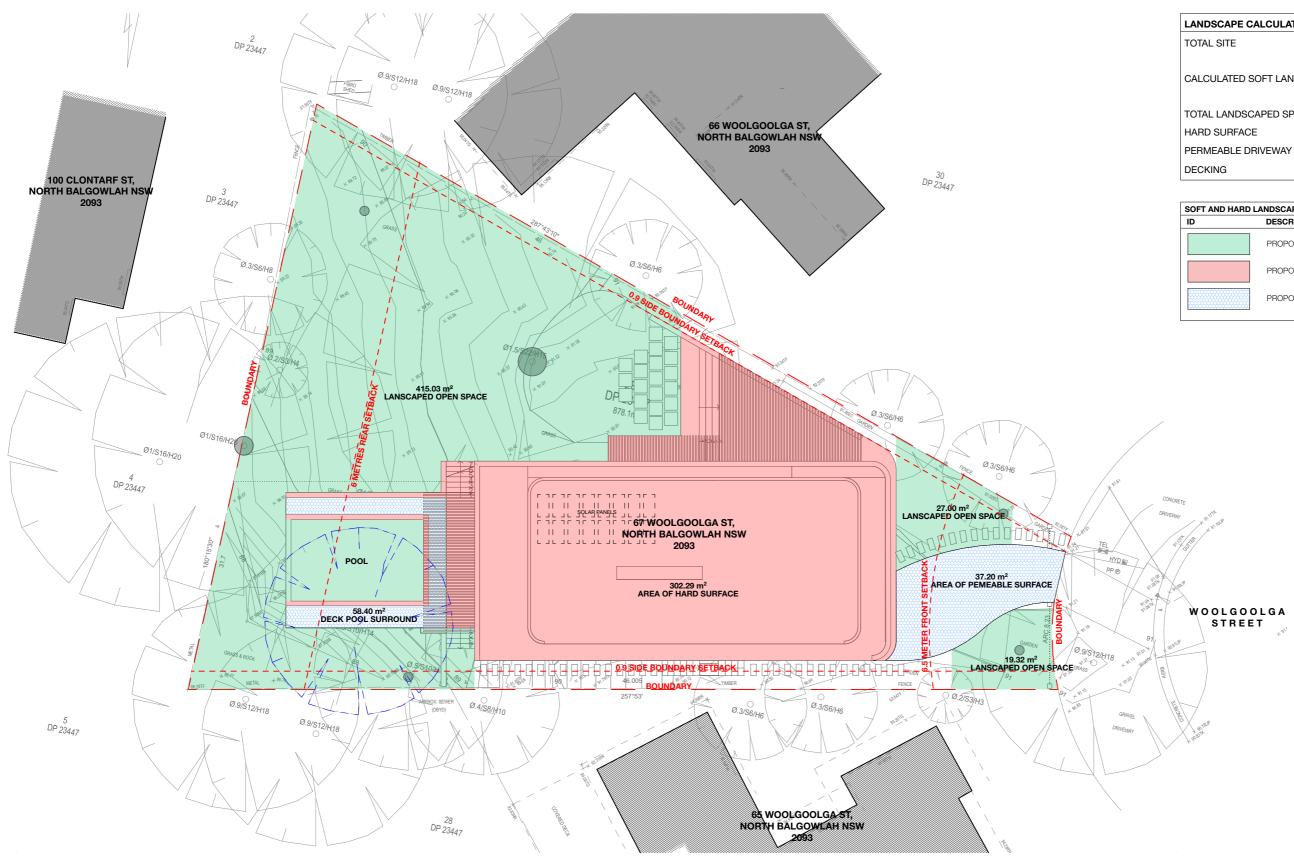


PROPOSED HARD & SOFT LANDSCAPING 1:200




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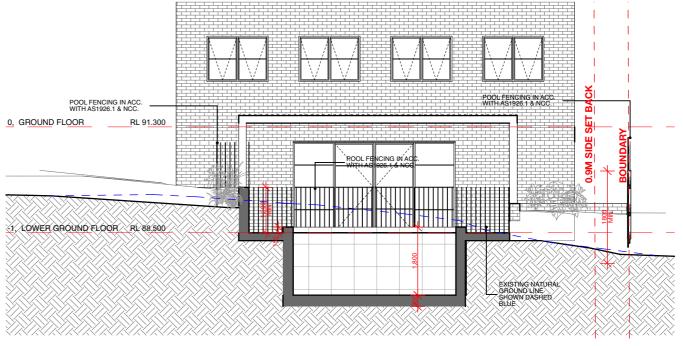
SOFT AND HARD LANDSCAPE LEGEND			
ID	DESCRIPTION		
	PROPOSED SOFT LANDSCAPED AREA		
	PROPOSED HARD SURFACE AREA		
	PROPOSED PERMEABLE AREA		

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HARD &	DRAWING NO. DA-503	noministed architect Thomas Martin revires, # 10383 6 / 20 AWLON SPRADE, AWALON BEACH, NSW 2107 www.amasarchitects.com
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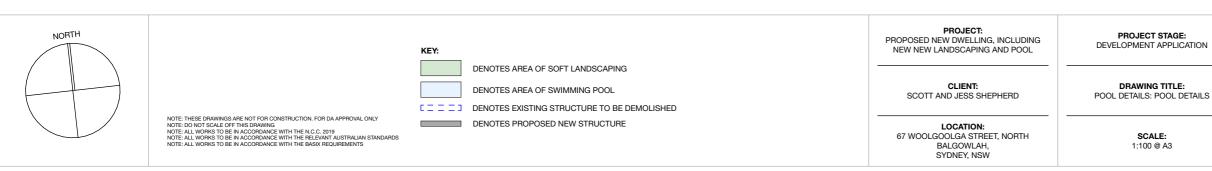


POOL SECTION

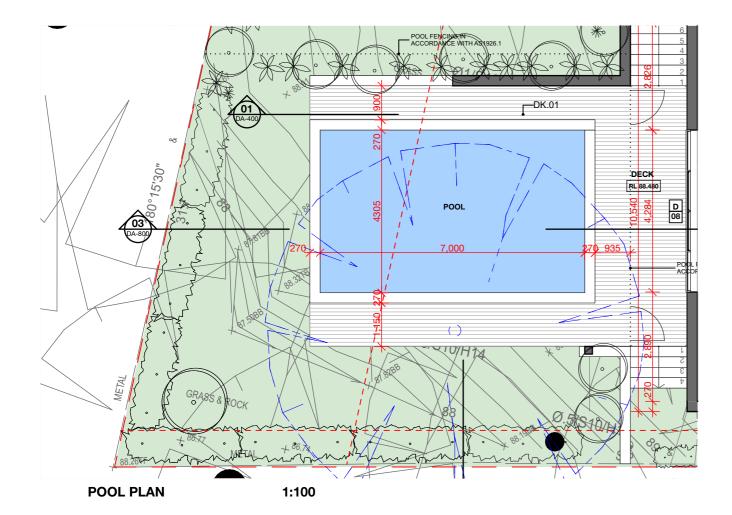

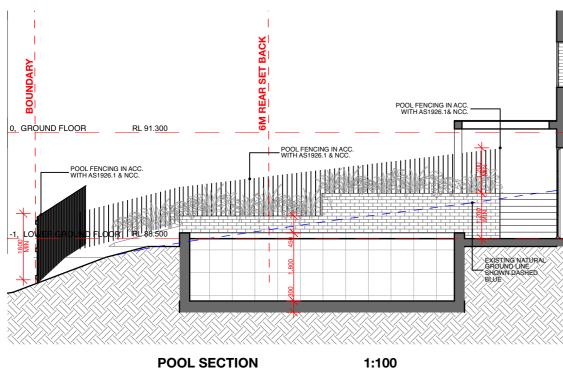
POOL SECTION

1:100






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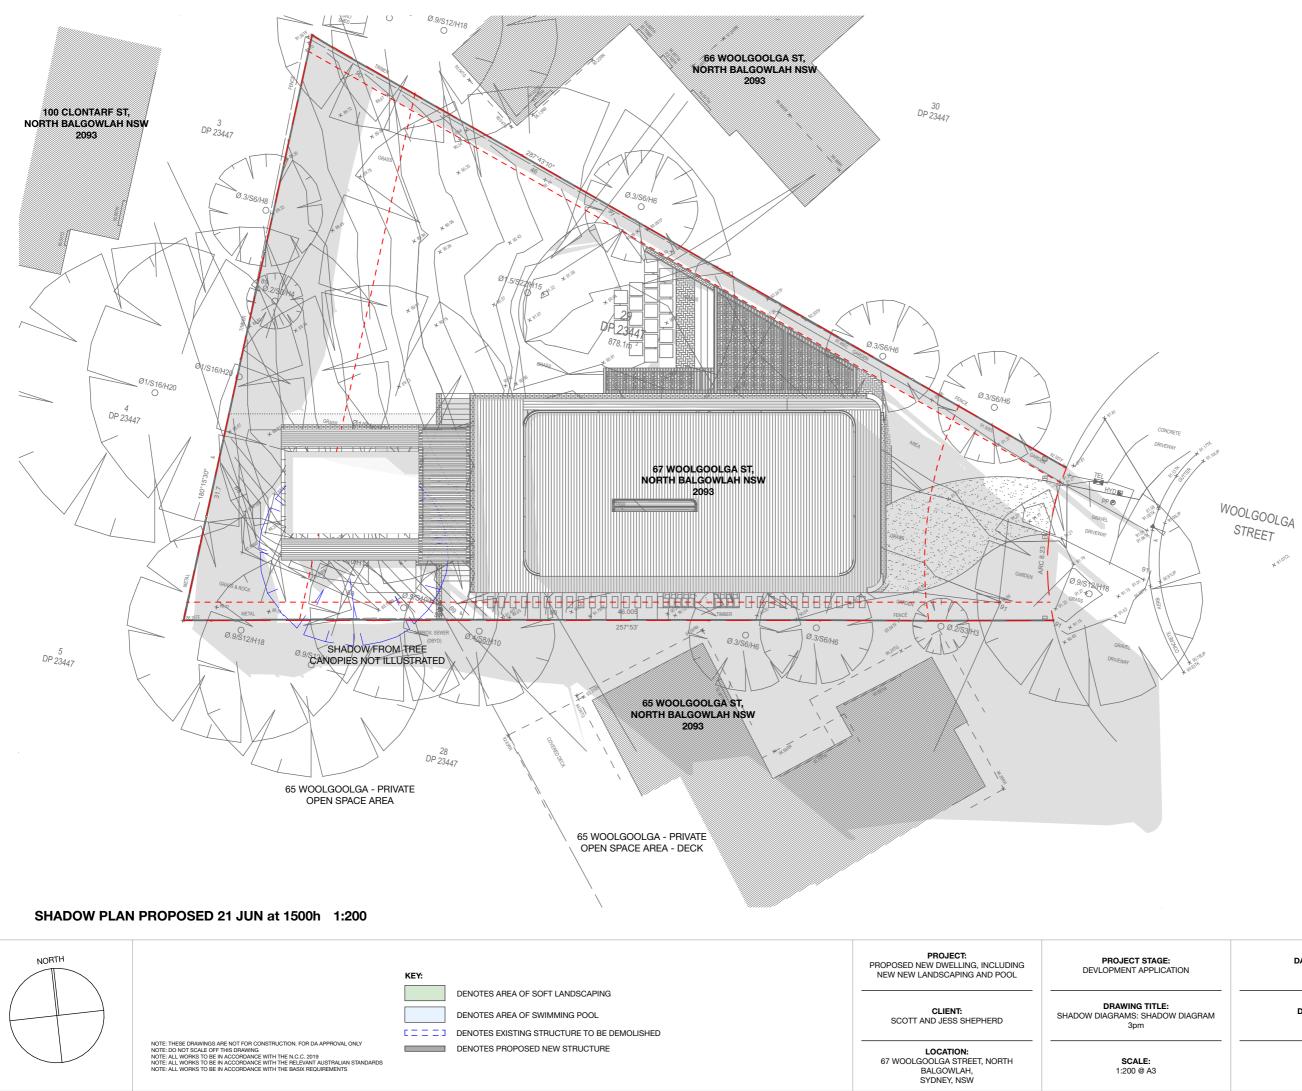

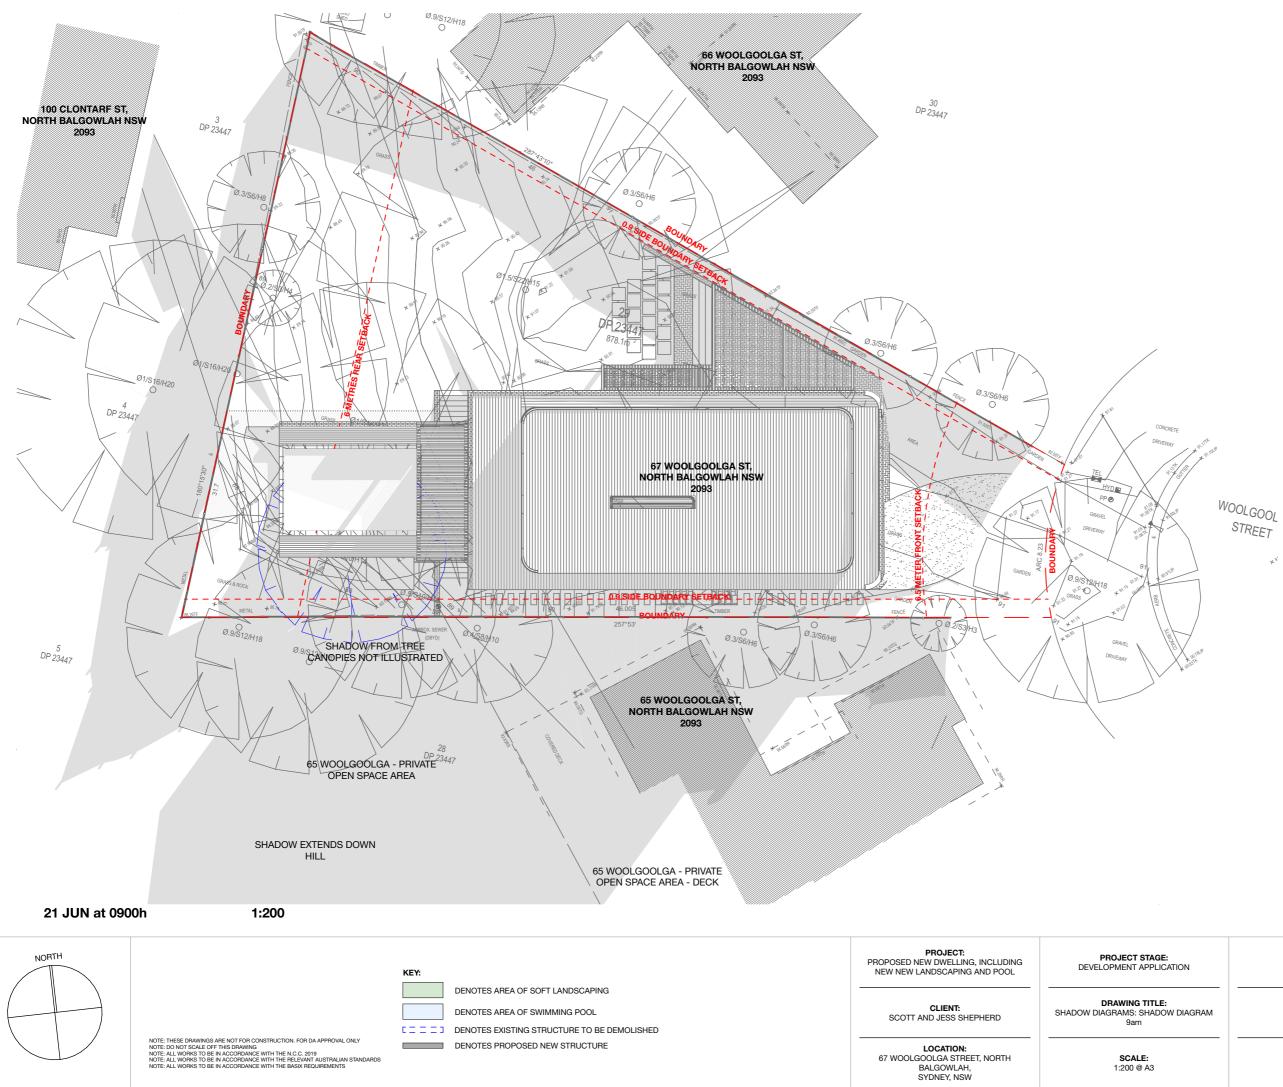
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External Montage

Proposed New Residential Dwelling Including Swimming Pool & Associated Landscaping 67 Woolgoolga Street, Balgowlah

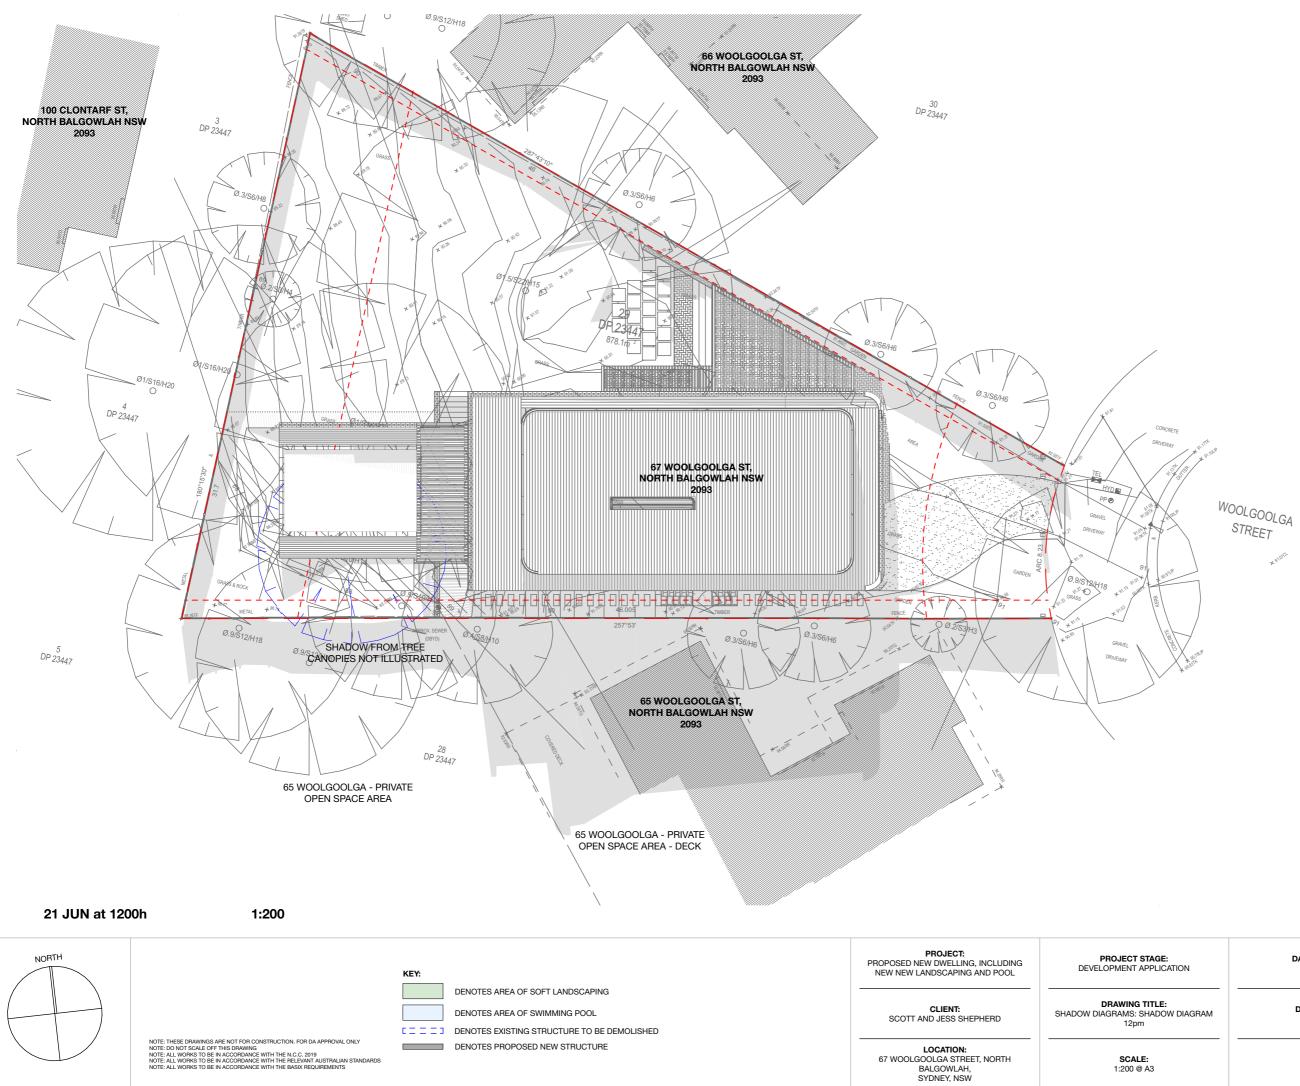r a m a



1. External Wall - Light Bagged Brick



2. External Cladding- Neutral Grey/Green Tone



3. Windows & Doors - Light Steel Doors



4. Hardwood Timber Pergola and Battens



5. Native Gardens & Landscaping



6. External Hard Surface - Recycled Brick/Cotto Paving



7. Fine Metal Baulstrade Light Paint Finish



8. Roofing - Pale Eucalypt Sheeting

External Finishes Proposed New Residential Dwelling Including Swimming Pool & Associated Landscaping

67 Woolgoolga, Balgowlah

