
DRAWING LIST

NUMBER.	NAME.	REV.
A000 GENERAL		
DA 000	COVER SHEET	G
DA 001	BASIX	В
A100 SITE		
DA 100	SITE PLAN ANALYSIS	В

NUMBER.	NAME.	REV.
A200 GENERAL	ARRANGEMENT DRAWINGS	
DA 200	EXISTING GROUND FLOOR	В
DA 201	EXISTING ROOF	В
DA 202	EXISTING LONG & CROSS SECTIONS	В
DA 210	DEMOLITION GROUND FLOOR	В
DA 211	DEMOLITION ROOF	В
DA 220	PROPOSED GROUND FLOOR	Н
DA 221	PROPOSED FIRST FLOOR	Н
DA 222	PROPOSED ROOF	D

		28	BANGARO	O STREET, NORTH BAL	GOWLAH
NUMBER.	NAME.	REV.	NUMBER.	NAME.	REV.
A300 ELEVATIONS			A500 PALETTE		
DA 300	PROPOSED NORTH & SOUTH ELEVATIONS	Н	DA 500	MATERIAL PALETTE	С
DA 301	PROPOSED EAST & WEST ELEVATIONS	G			
			A600 DIAGRAMS		
A400 SECTIONS			DA 600	SHADOW DIAGRAMS - PLAN	В
DA 400	PROPOSED LONG SECTION & CROSS SECTION	NS F			
			A700 AREA		
			DA 700	AREA SCHEDULE	F


DRAWING SYMBOLS

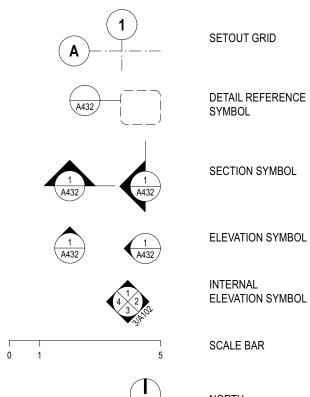

NORTH



		0007950690 11 A Assessor Luke William Accreditation No. 10070 Address	This drawing should be read in conjunction with all relevant contracts, specifications, reports and drawings. Do not scale drawings. dimensions govern. Verify all dimensions on site before construction. Copyright of this drawing is vested in Breakspear Architects pty Itd.	ARCHITECT BREAKSPEAR ARCHITECTS ABN 81 601 670 991 ACN 601 670 991 2/4 Belgrave Street, Manly NSW 2095 P: 0421 661 146 E: studio@trkspr.com	PROJECT 28 BAN	GAROO				
E 10/8/22 D 10/8/22 C 29/7/22 B 26/7/22 A 6/7/22	DA DRAFT FOR CONSULTANTS DRAFT FOR CONSULTANTS DA DRAFT FOR CONSULTANTS		28 Bangaroo Street, N Balgowlah, NSW, 209	NOT FOR CONSTRUCTION	CLIENT John Cimino & Hayden Zuffo 28 Bangaroo Street, North Balgowlah, NSW, 2093	PROJECT NUMBER		CHECKED TB	SHEET SCALE	SHEE
REV DATE	DESCRIPTION	007900							113	

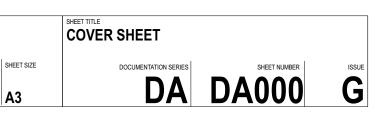

BASIX Summary of Requirements

Performance (Total System)	Description	Comment
≤U4.8, SHGC 0.59 +/- 10%	Single Glazed, Low-e, Clear	Primary Dwelling
≤U4.8, SHGC 0.59 +/- 10%	Single Glazed, Low-e, Clear	Secondary Dwelling
Minimum Insulation Performanc	e Requirements	
Construction Element	Thermal	Requirements
Ceilings with Roof Above (Medium Colour Roof)	d lightweight roofs/exposed ceilings)	
Insulation between Roof and Framing System (Medium Colour Roof)	cking <u>(lightweight roof only)</u>	
Exposed External Floors	No insul	ation Required
Ground Floors		R1.00 to slab edge (1m) g: R1.00 to slab edge (1m)
External Walls	Primary	Dwelling: R2.50
(Medium Colour Walls)	Secondary	/ Dwelling: R1.50
Walls to Garage	Primary	Dwelling: R1.00
Walls to Commercial	Secondary	Dwelling: R1.00
Floor Coverings	Concrete throug	nout Tile to Wet Rooms
Ceilings	Pla	asterboard
Other Modelling Assumptions		

living/kitchen, 1 x 1,200 ceiling fan in each bedroom | Secondary Dwelling: 1 x 1,200 ceiling fan in living, 1 x 1,200 ceiling fan in each bedroom.

Summary	of Requirements: Dwellings	
Category	<u>ltem</u>	Comment
	Fixtures (Both Dwellings)	3 star showers (>6 but ≤7.5 L/min) 4 star toilets 4 star taps
	Hot Water (Both Dwellings)	Gas Instantaneous 5 Star
	Pool: Primary Dwelling	27kL pool Requires cover
	Landscape: Primary Dwelling	224.5m ² garden/lawn area 0m ² Area dedicated to low water use species 3kL RW Tank served by 250m ² roof area, supplying landscape, 27kL pool & WC's
	Landscape: Secondary Dwelling	5.6m ² garden/lawn area 0m ² Area dedicated to low water use species
	Hot Water (Both Dwellings)	Gas instantaneous 5 Star
	Pool Heating	Gas Pool pump on timer
	Lighting	LED lighting throughout
	Exhaust Fans (Both Dwellings)	Kitchen, Laundry & bathroom fans individually ducted to façade or roof
Energy	HVAC (Both Dwellings)	Individual split units to Living Spaces & Bedrooms EER 3.5-4.0 Ceiling fans to Living Rooms & Bedrooms
	Lighting (Both Dwellings)	Sealed LED lighting throughout
	Appliances (Both Dwellings)	Gas cooktop & electric oven
	Solar PV: Primary Dwelling	2kW PV system required





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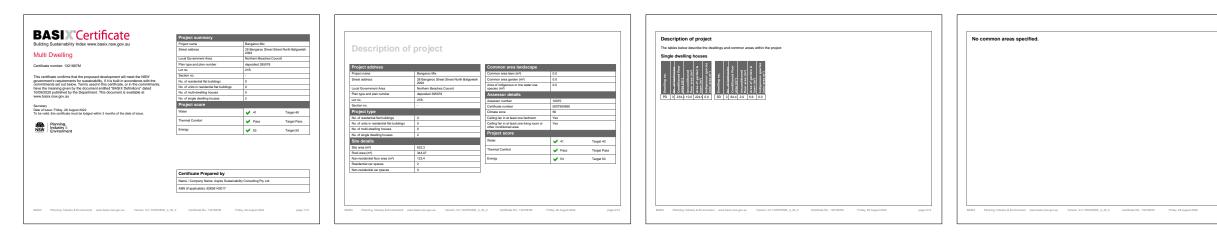
ARCHITECTS ACN 601 670 991 nly NSW 2095 studio@brkspr.com	PROJECT	GAROO S	TREET	
Zuffo	PROJECT NUMBER	DRAWN	CHECKED	SHEET SCALE
2093	2113	LH	тв	NTS





SHEET SIZE

A3





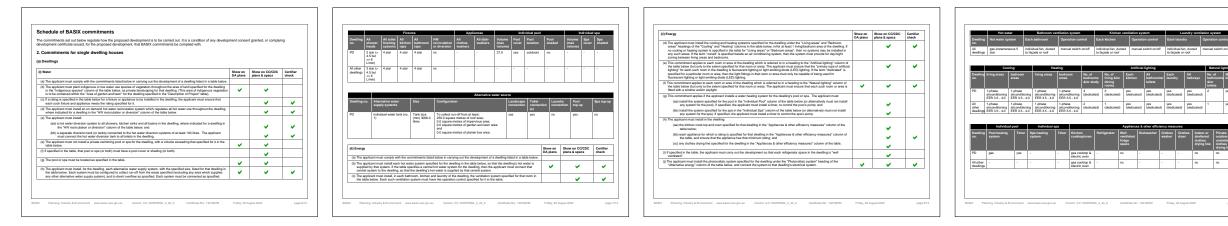

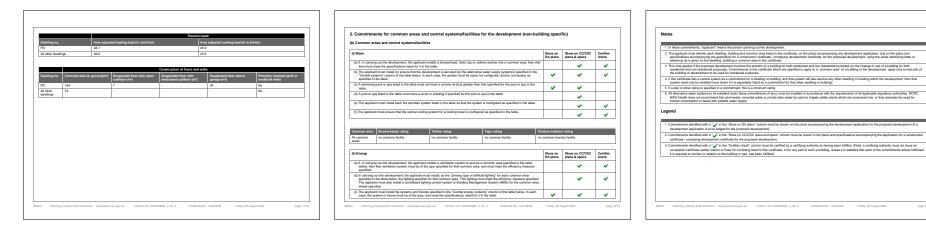


		ARCHITECT	PROJECT			-	
	This drawing should be read in conjunction with all relevant contracts, specifications, reports and drawings. Do not scale drawings. dimensions govern. Verify all dimensions on site before construction. Copyright of thi drawing is vested in Breakspear Architects pty Itd.	BREAKSPEAR ARCHITECTS ABN 81 601 670 991 ACN 601 670 991 2/4 Belgrave Street, Maniy NSW 2095 P: 0421 661 146 E: studio@brkspr.com	28 BAN	GAROO S	STREET		
DEVELOPMENT APPLICATION DRAFT DA FOR COORDINATION DESCRIPTION	NOT FOR CONSTRUCTION	CLIENT John Cimino & Hayden Zuffo 28 Bangaroo Street, North Balgowlah, NSW, 2093	PROJECT NUMBER	DRAWN	снескер	SHEET SCALE	SHE





Dwelling no.	Photovoltaic system (min rated electrical output in peak kW)			
PD All other dwellings	20			
Al other cirelings				
(iii) Thermal Comfort		Show on DA plans	Show on CC/CDC plans & specs	Certifier check
(a) The applicant must attach the certificate referred to under "Assee "Asseesor Certificate") to the development application and consi the applicant is applying for a complying development certificate must also attach the Assessor Certificate to the application for a must also attach the Assessor Certificate to the application for a set of the application of the application for a set of the application for a set of the application of the application for a set of the application for a set of the appli	ruction certificate application for the proposed development (or, if for the proposed development, to that application). The applicant			
(b) The Assessor Certificate must have been issued by an Accredit	ad Assessor in accordance with the Thermal Comfort Protocol.			
(c) The details of the proposed development on the Assessor Certificate, including the details shown in the "Thermal Loads" to	cate must be consistent with the details shown in this BASIX ble below.			
(d) The applicant must show on the plans accompanying the develo which the Thermal Comfort Protocol requires to be shown on the the Accredited Assessor, to certify that this is the case.	pment application for the proposed development, all matters see plans. Those plans must bear a stamp of endorsement from	•		
(e) The applicant must show on the plans accompanying the application certificate, if applicable), all thermal performance specifications development which were used to calculate those specifications.	ation for a construction certificate (or complying development set out in the Assessor Certificate, and all aspects of the proposed		~	
(f) The applicant must construct the development in accordance will Certificate, and in accordance with those aspects of the develop certificate which were used to calculate those specifications.	h all thermal performance specifications set out in the Assessor ment application or application for a complying development		~	~
(g) Where there is an in-slab heating or cooling system, the application $\left(g\right) =0$	nt musit	~	~	~
(aa) Install insulation with an R-value of not less than 1.0 are	und the vertical edges of the perimeter of the slab; or			1 1
(bb) On a suspended floor, install insulation with an R-value edges of the perimeter of the slab.	of not less than 1.0 underneath the slab and around the vertical			
(h) The applicant must construct the floors and walls of the develop below.		~	~	~
(i) The applicant must show on the plana accompanying the develop ceiling fans set out in the Assessor Certificate.	ement application for the proposed development, the locations of	~		
(i) The applicant must show on the plans accompanying the applica certificate, if applicable), the locations of ceiling fans set out in the certificate.	tion for a construction certificate (or complying development		~	



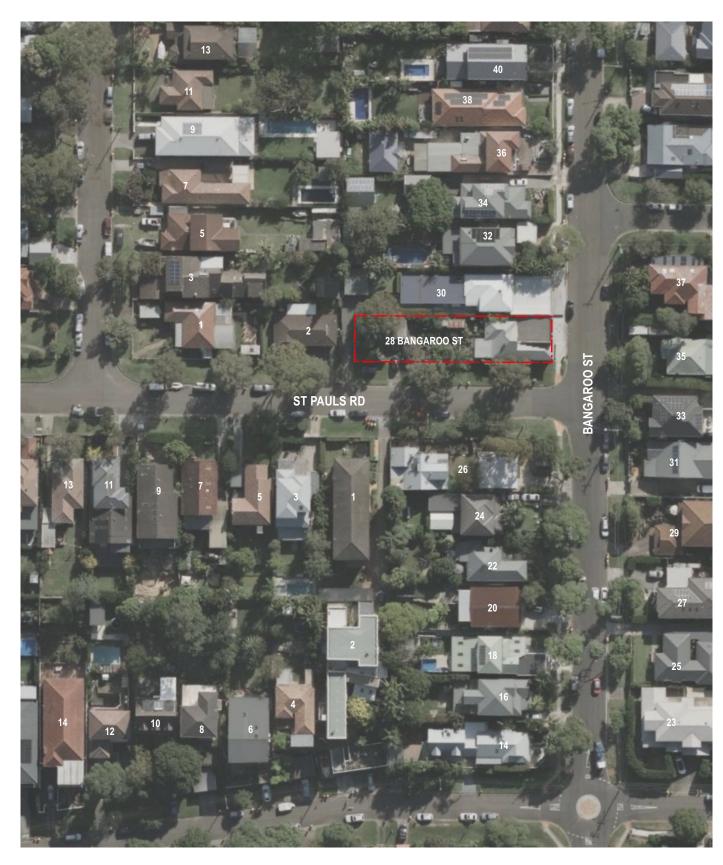











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A 6/7/22	DEVELOPMENT APPLICATION DA DRAFT FOR CONSULTANTS DESCRIPTION							PROJECT NUMBER	drawn	CHECKED TB	SHEET SCALE	SH

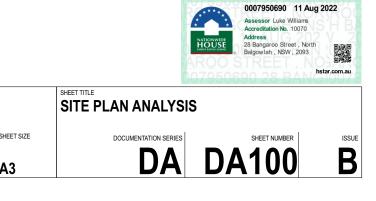


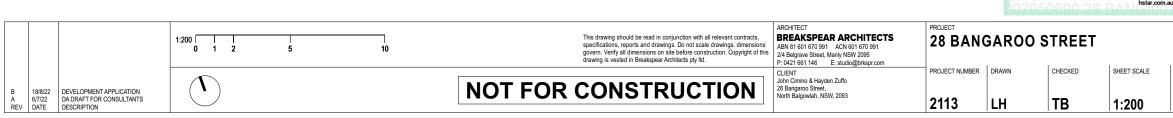

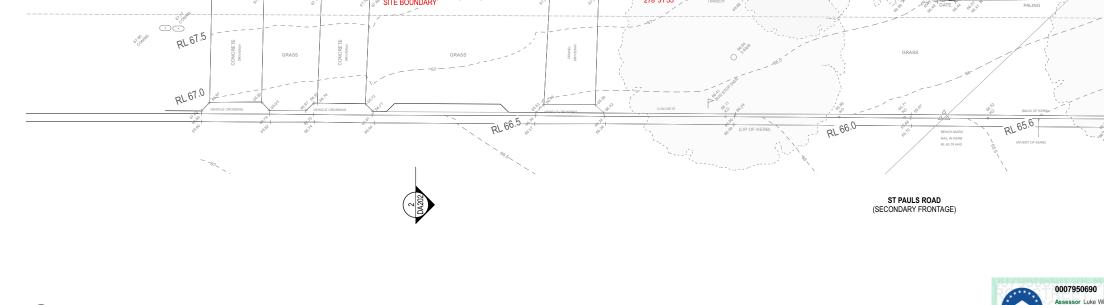

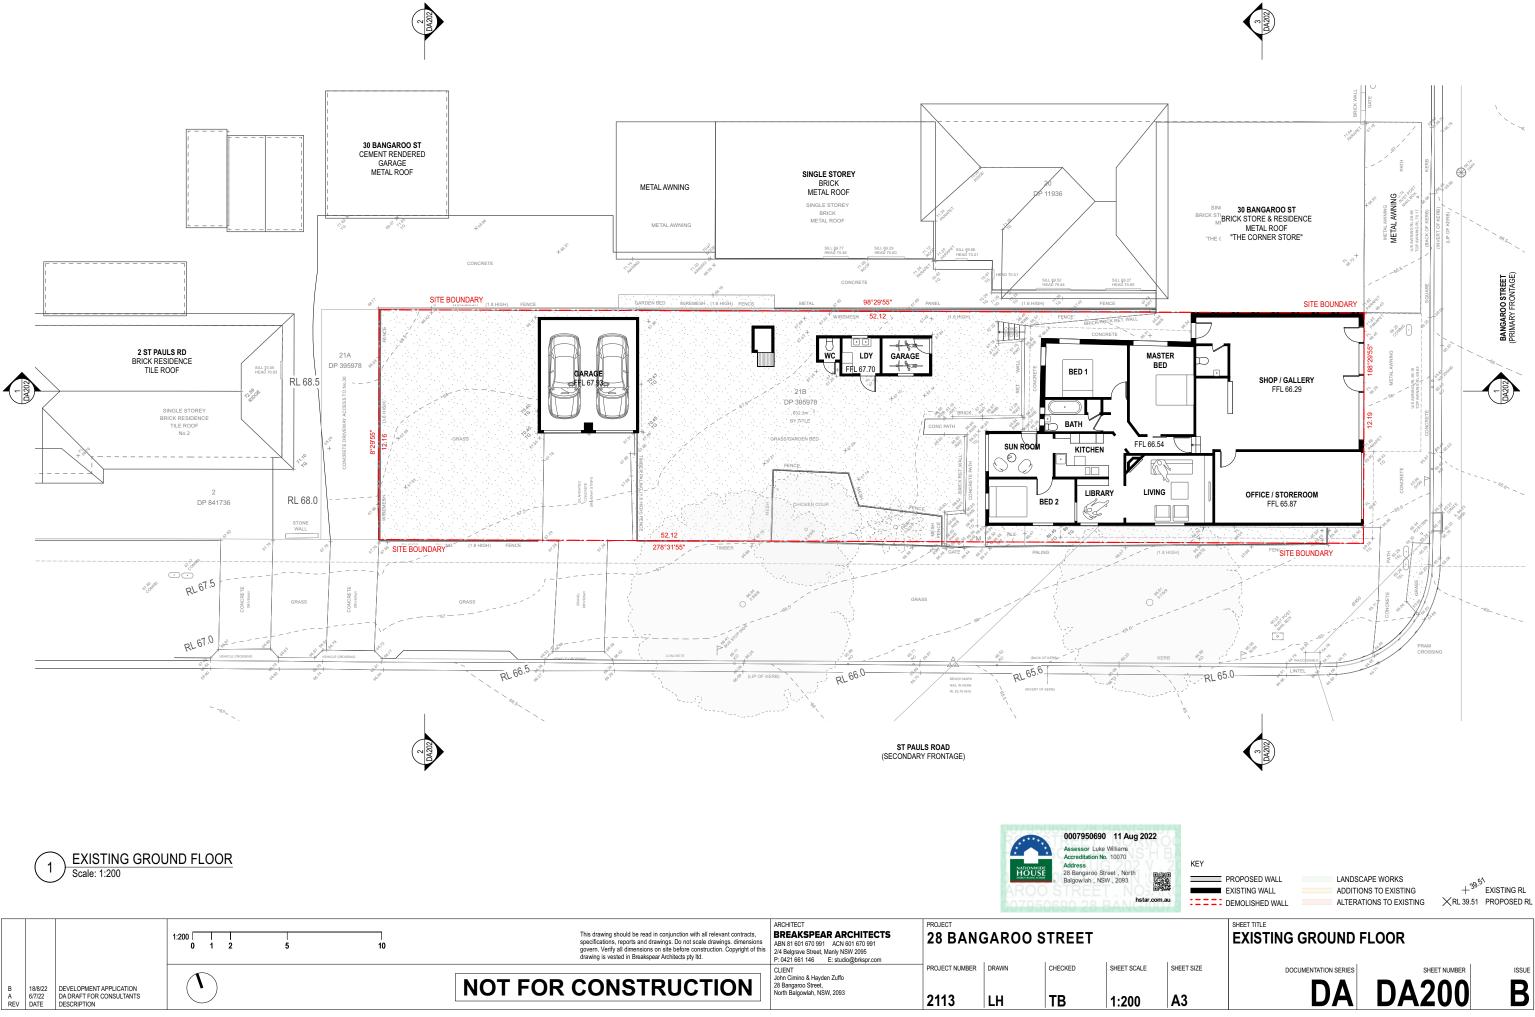



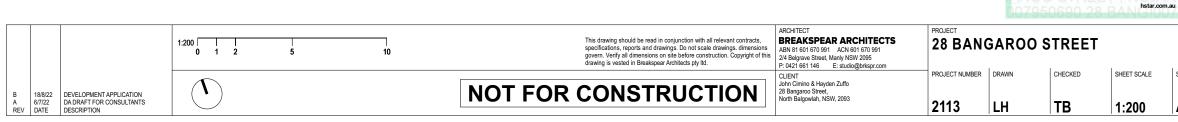



SINGLE STOREY BRICK METAL ROOF

SINGLE STOREY BRICK METAL ROOF

SILL 69.77 HEAD 70.46

98°29'55

52.12

1936

SILL 69.52

SILL 69.27

0007950690 11 Aug 2022 ssor Luke William

28 Bangaroo Street, North Balgowlah, NSW, 2093

Address

HOUSE

METAL AWNING

METAL AWNIN

11 PANHING +



30 BANGAROO ST CEMENT RENDERED GARAGE METAL ROOF

69.01 17.0

EXISTING GROUND FLOOR


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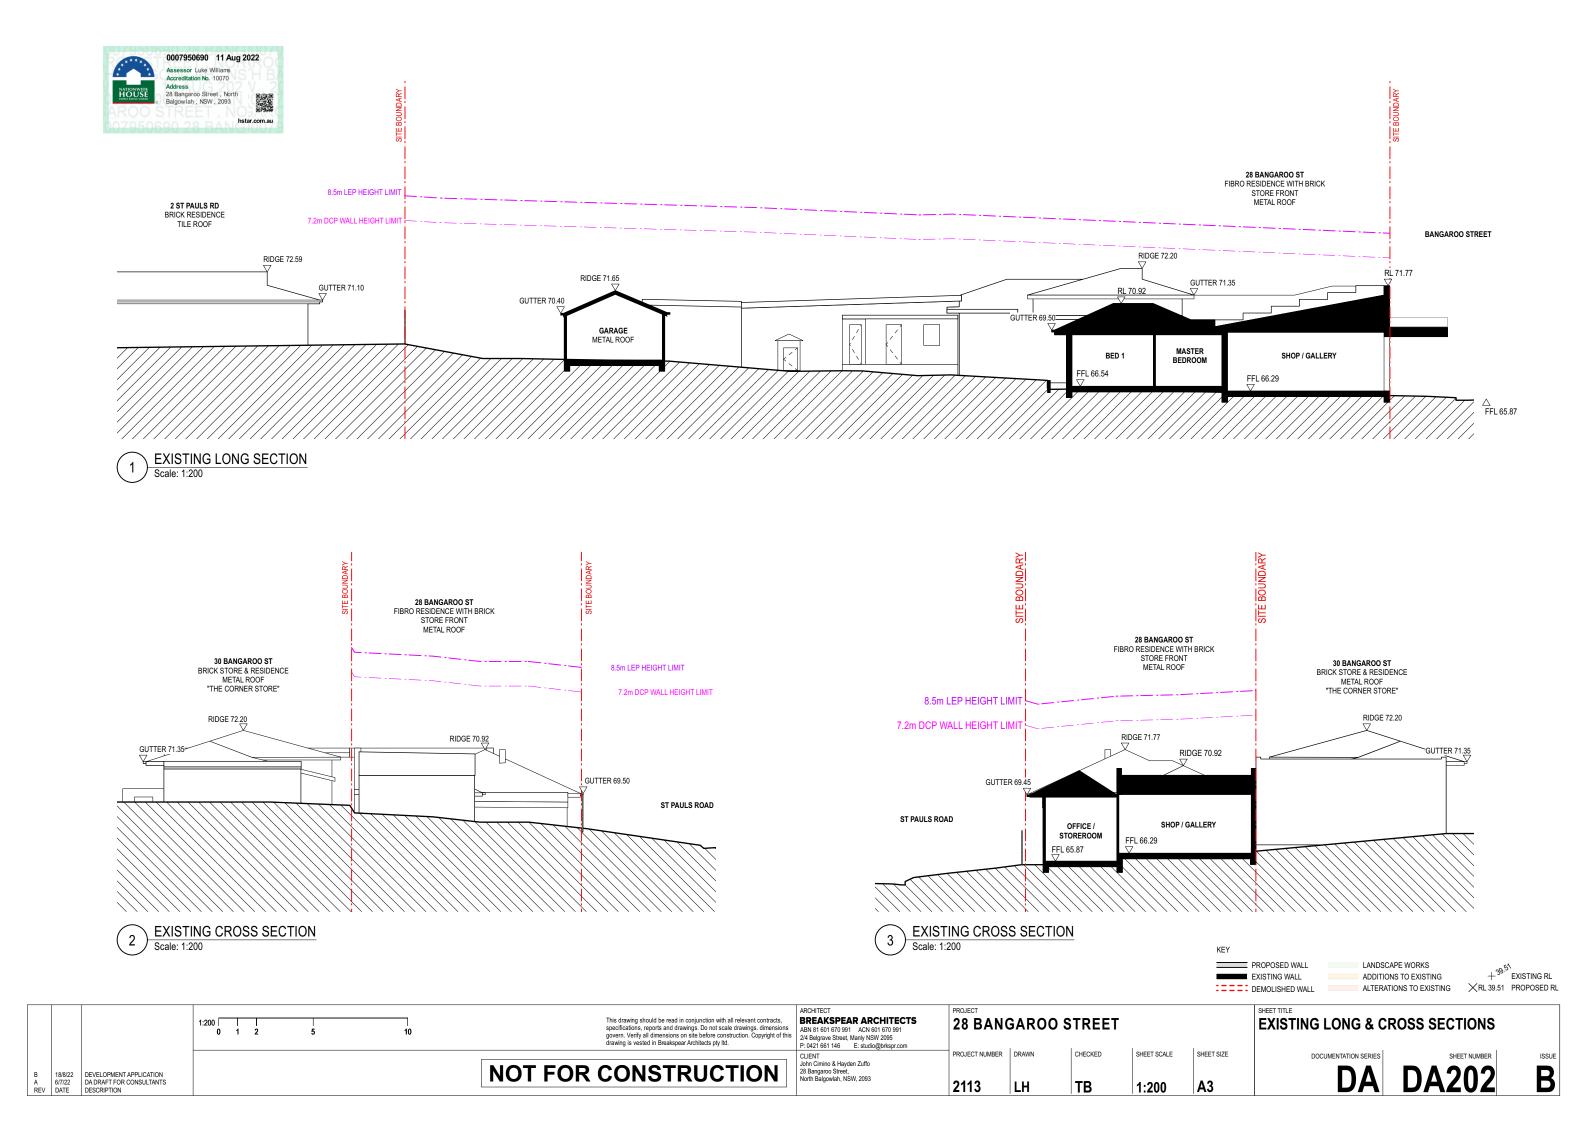
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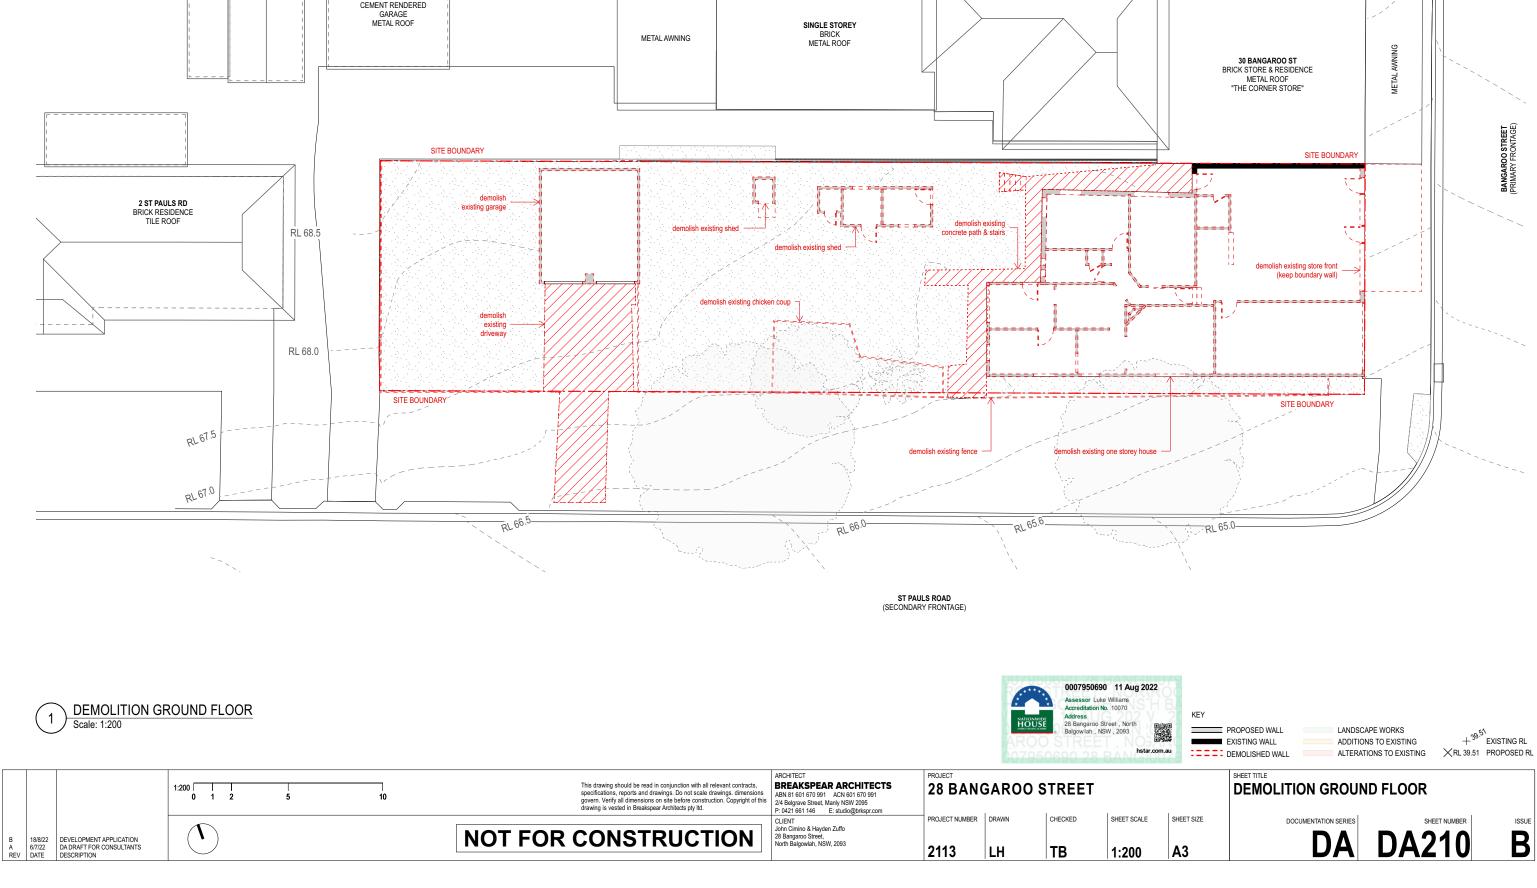



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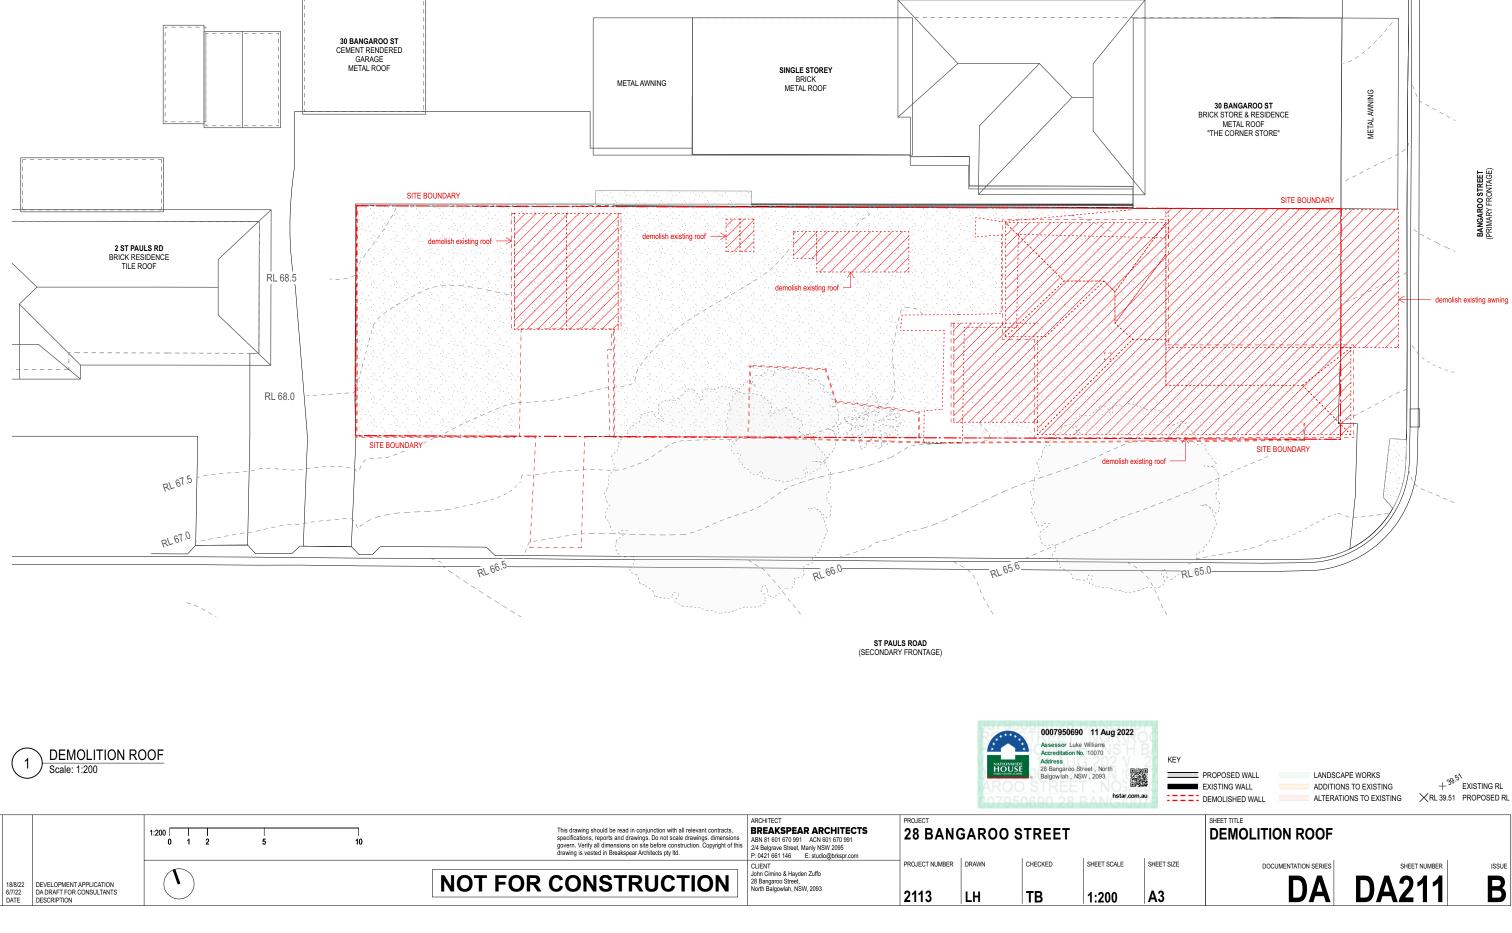
SITE BOUNDARY









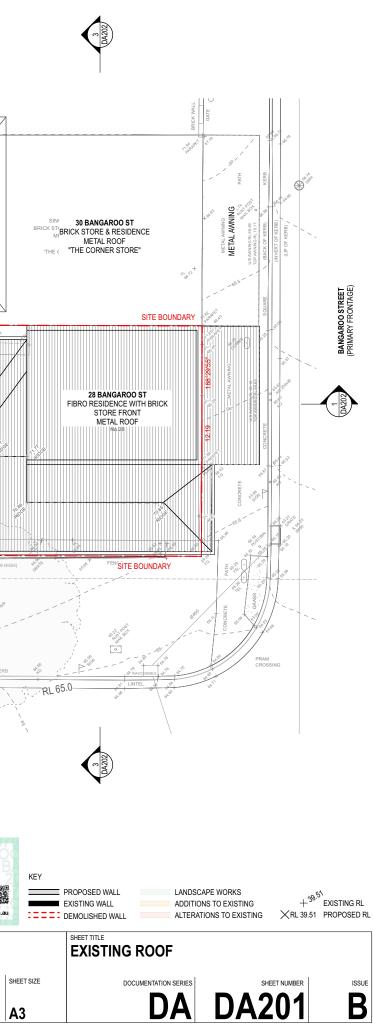

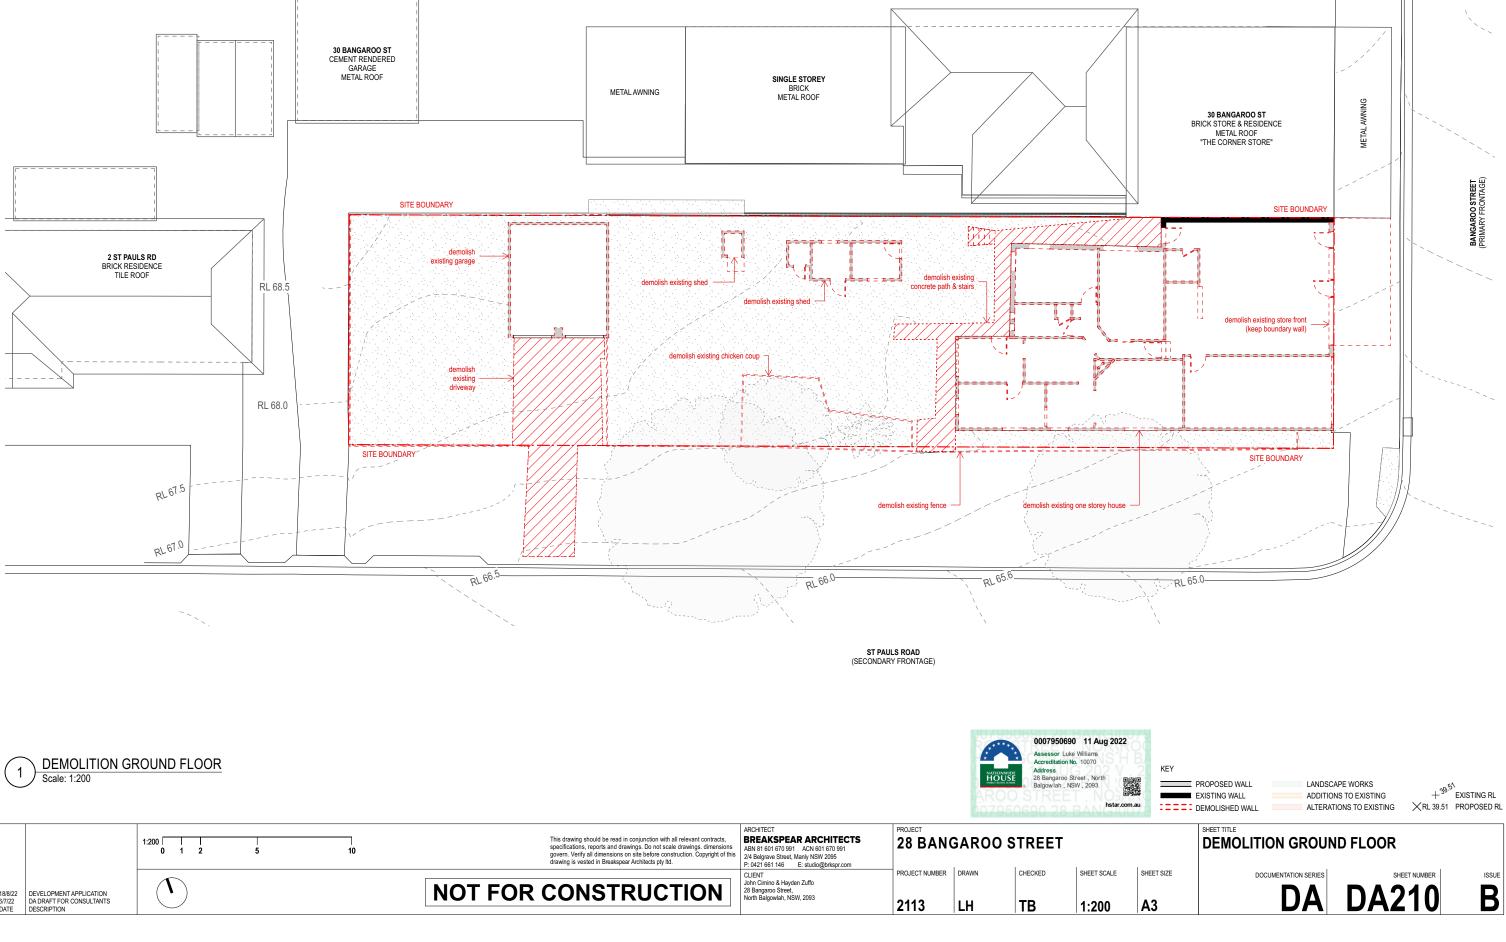


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							CLIENT John Cimino & Havden Zuffo	PROJECT NUMBER	DRAWN	CHECKED	SHEET SCALE	
B A REV	18/8/22 6/7/22 DATE	DEVELOPMENT APPLICATION DA DRAFT FOR CONSULTANTS DESCRIPTION				NOT FOR CONSTRUCTION	28 Bangaroo Street, North Balgowlah, NSW, 2093	2113	LH	тв	1:200	

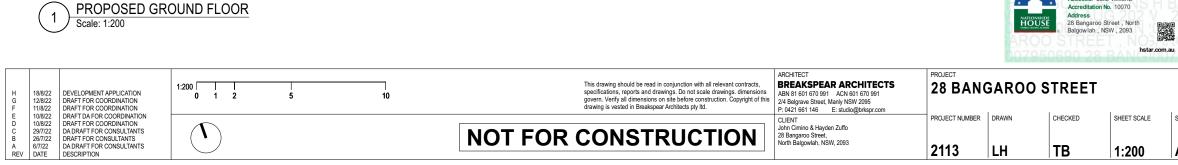


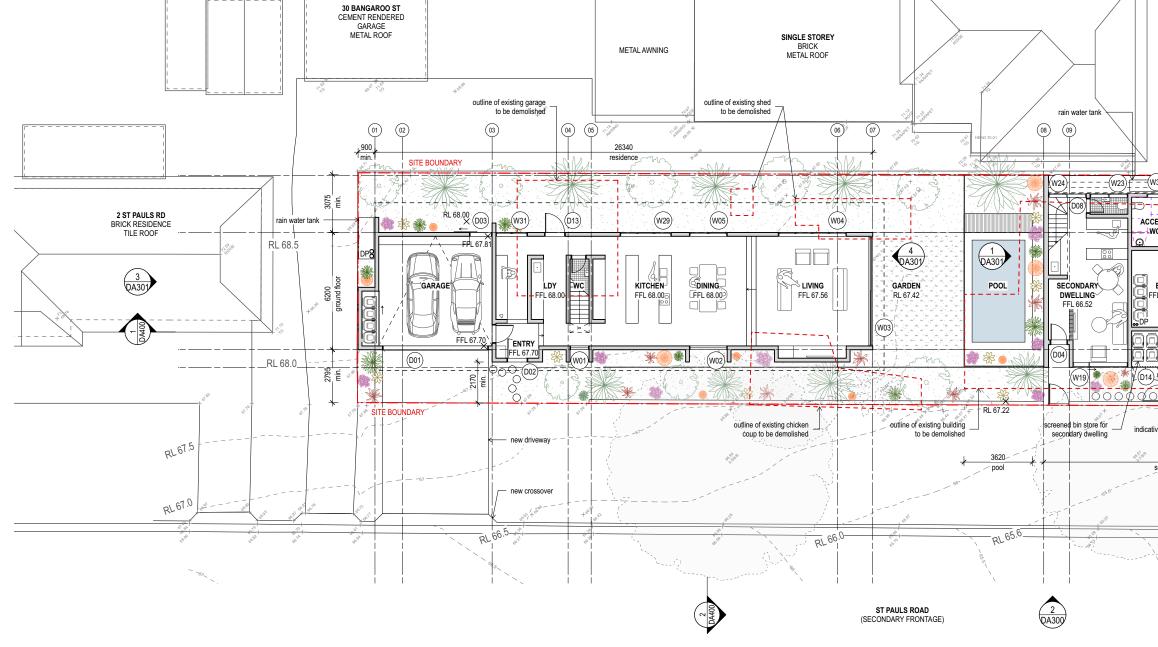





0007950690 11 Aug 2022
Assessor Luke Williams

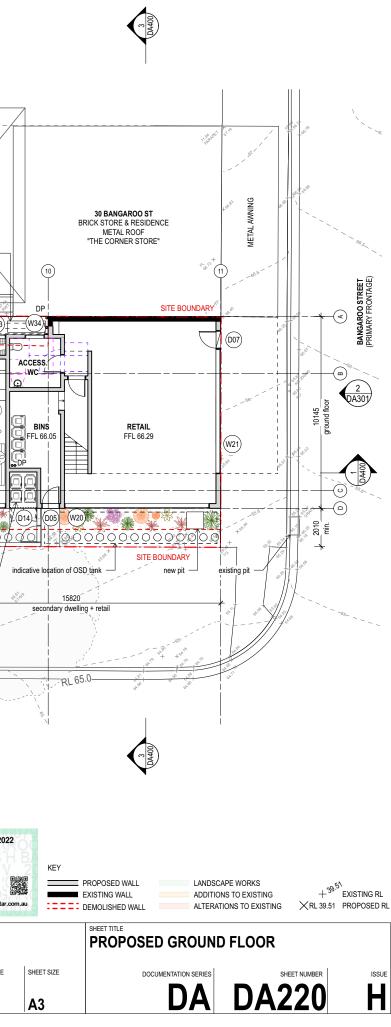


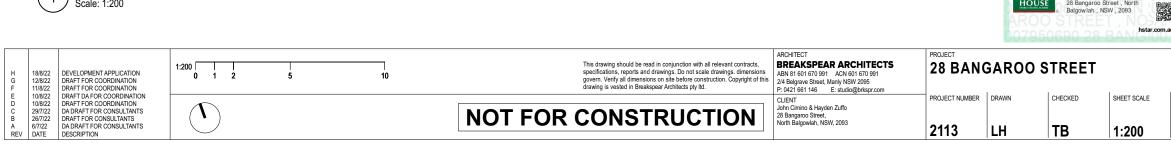

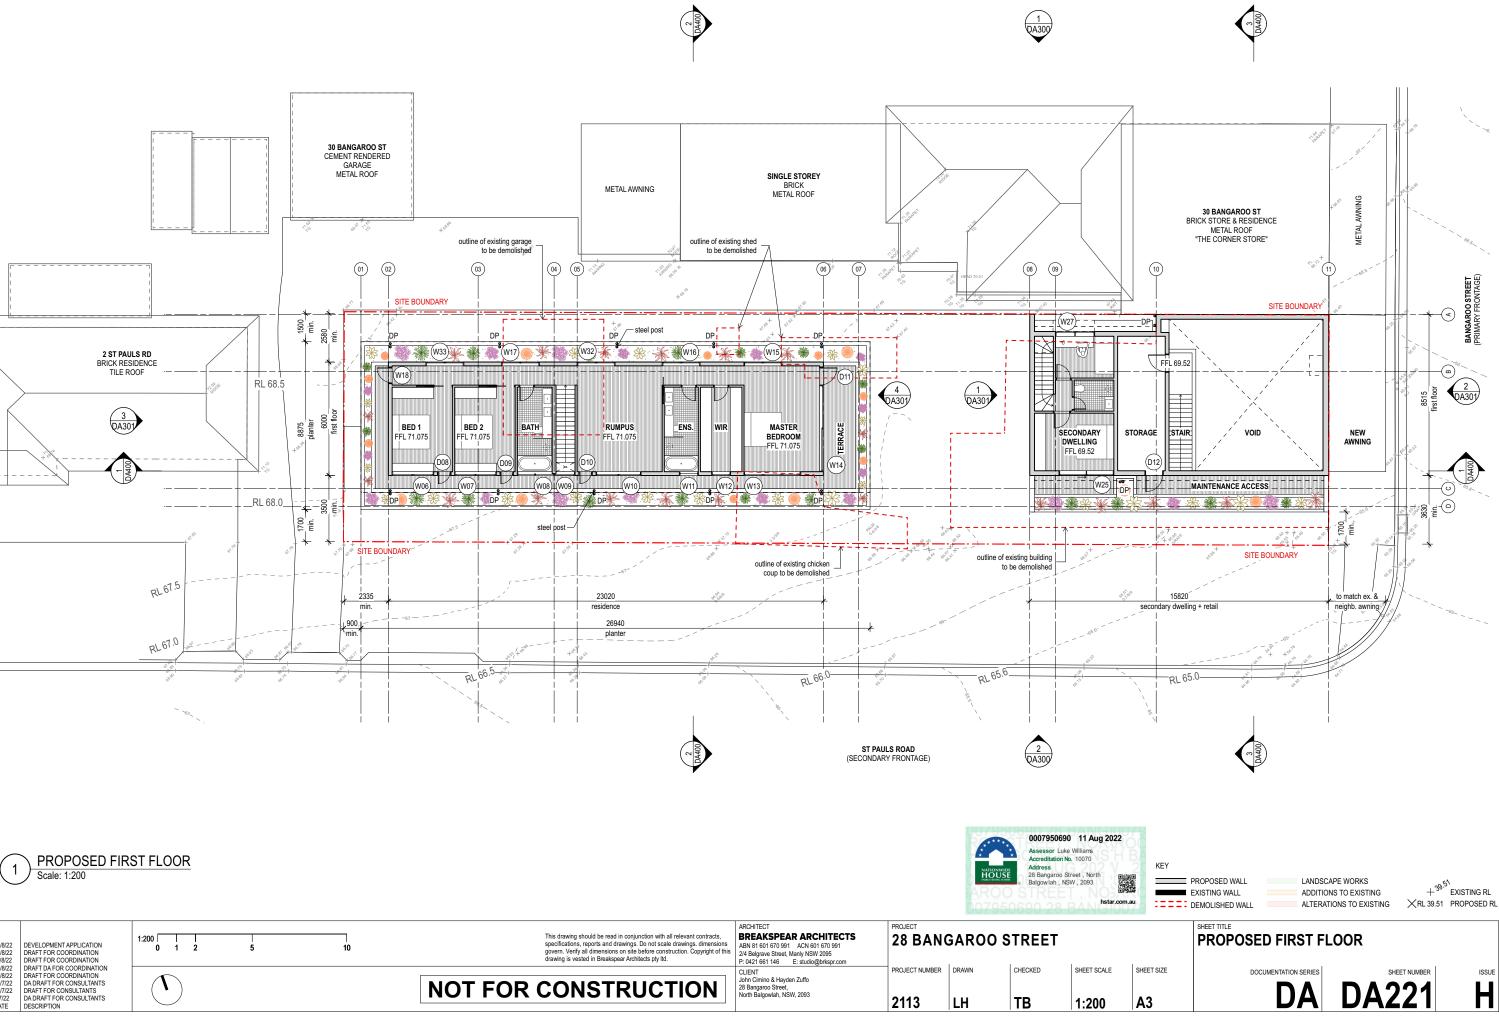




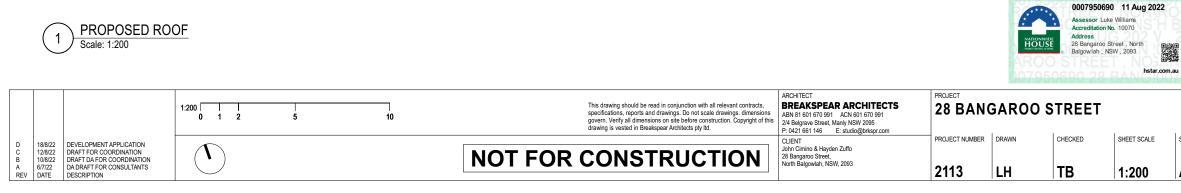


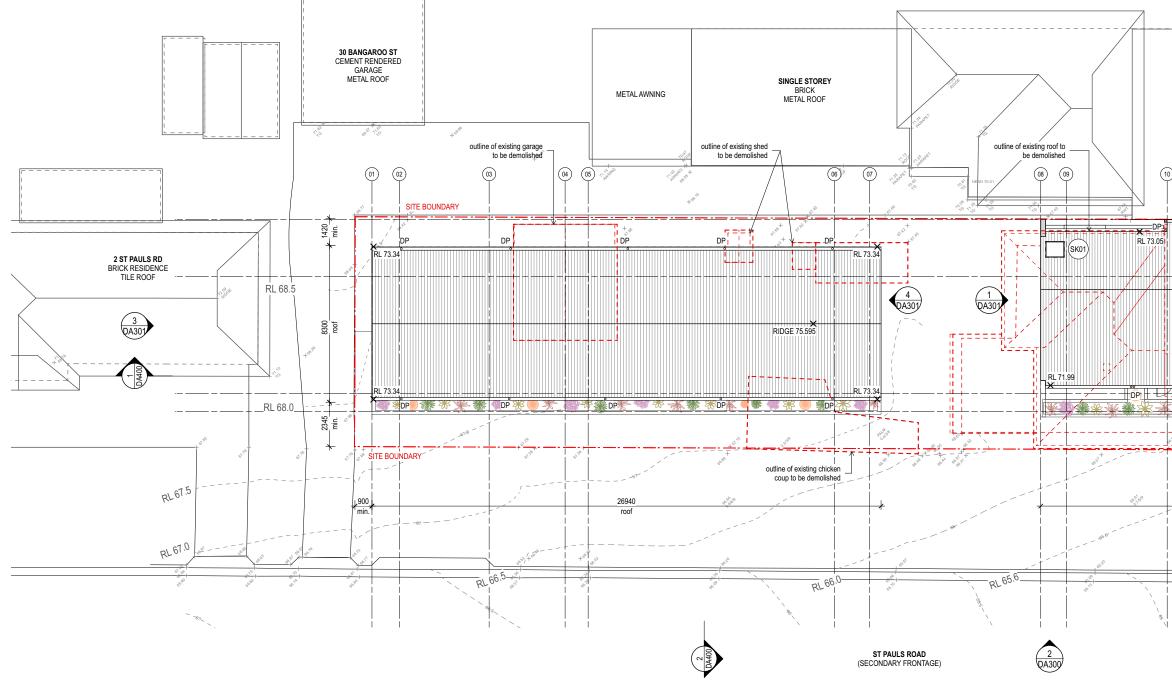






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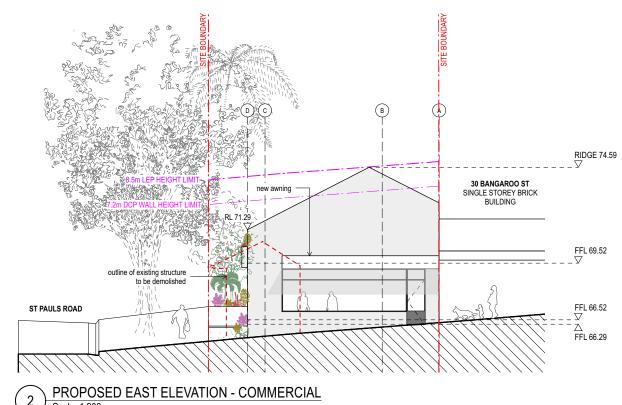


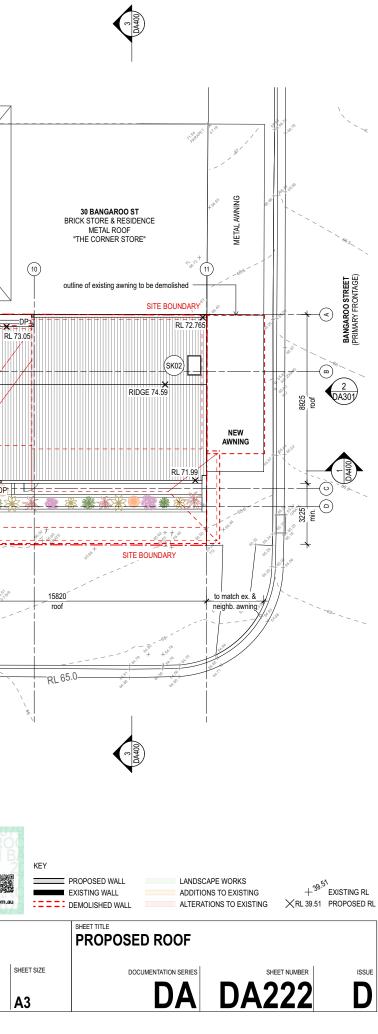

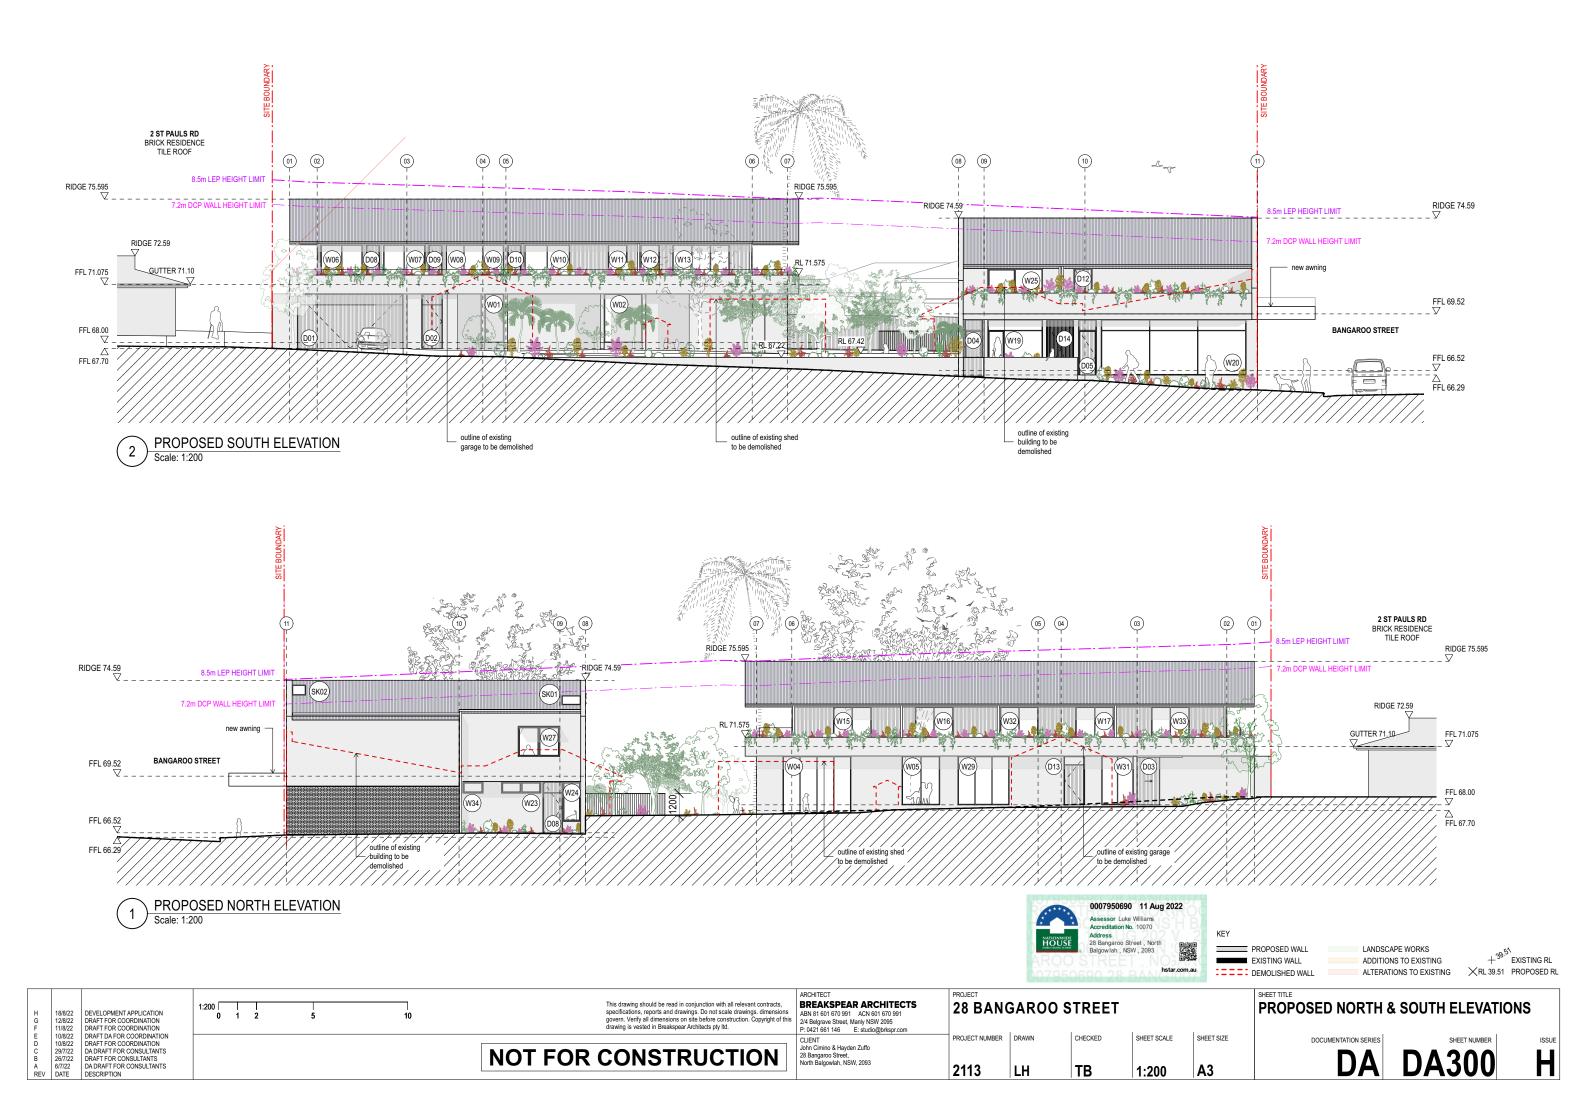


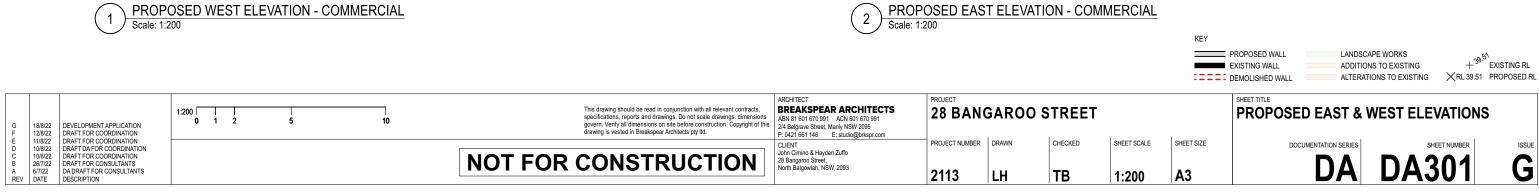


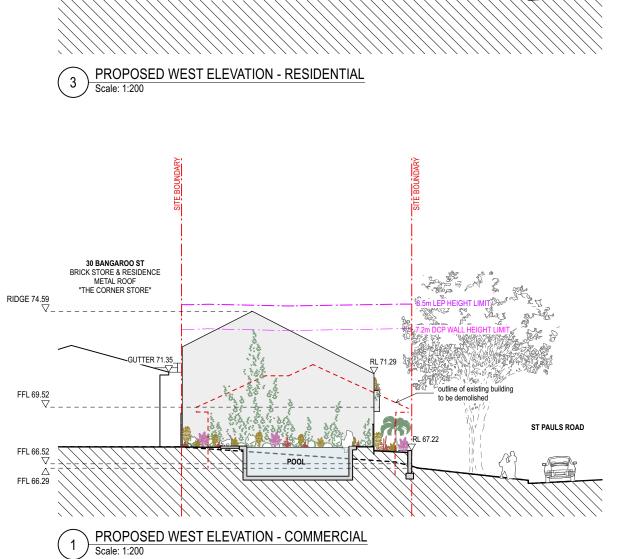

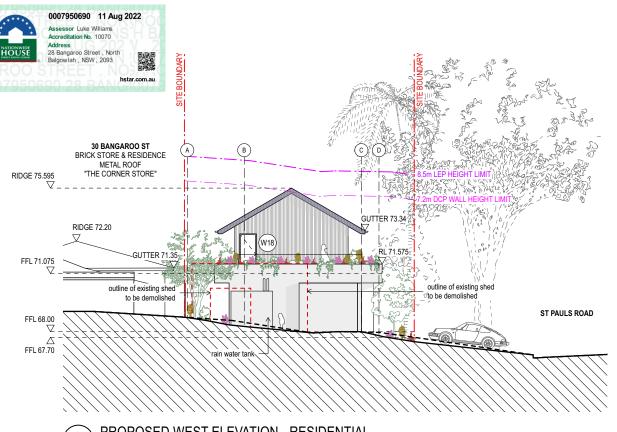



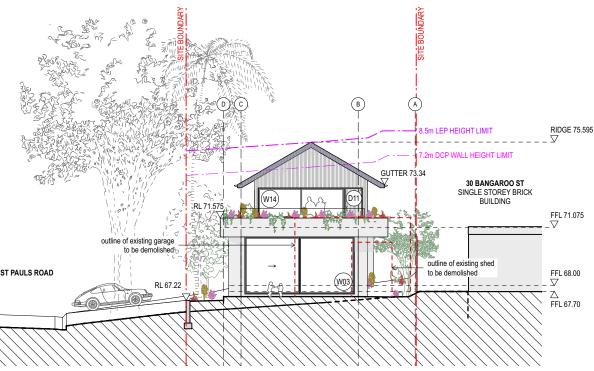

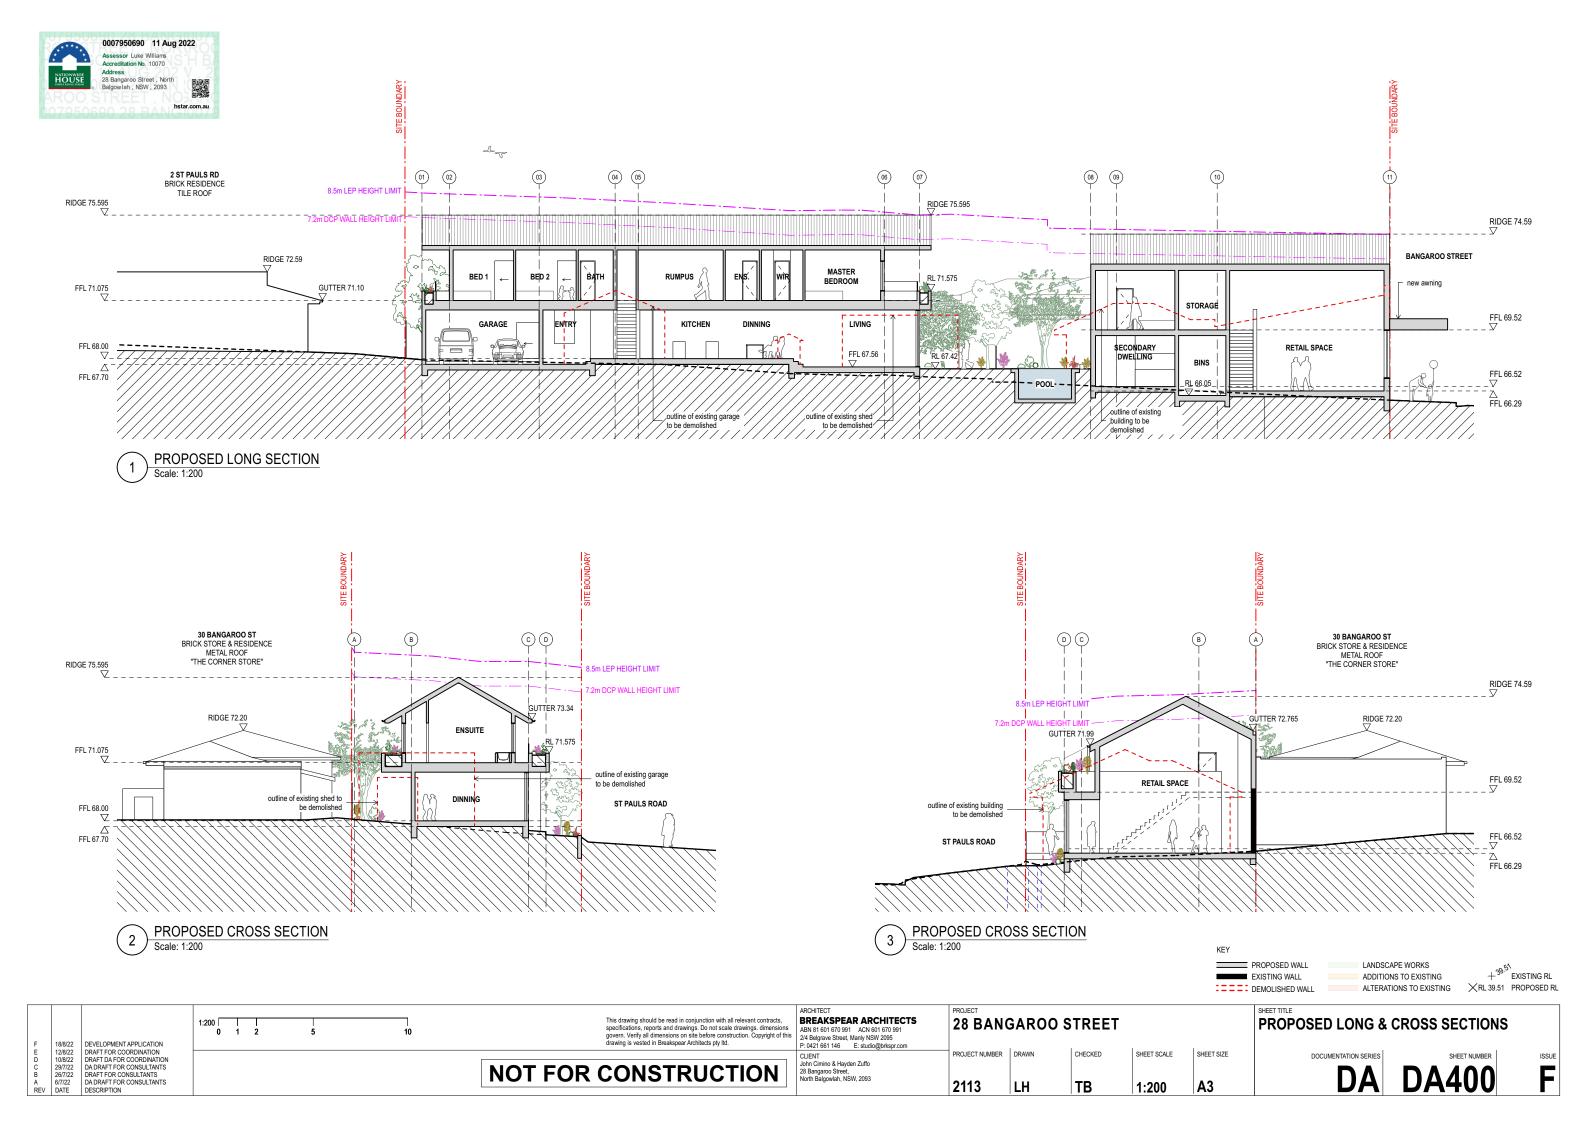





MT-01 GREY METAL ROOF

WD-01 ALUMINIUM FRAMED GLASS WINDOWS & DOORS

CN-01 OFF-FORM CONCRETE





TB-01 FACADE TIMBER CLADDING

TB-02 TIMBER CLAD DOORS



TIMBER GATE




FN-02 METAL POOL FENCE



CN-02 CONCRETE RETAINING WALL WITH NATIVE BUSH & VEGETATION




AW-01 METAL AWNING (TO MATCH EXISTING & NEIGHBOURING AWNINGS)

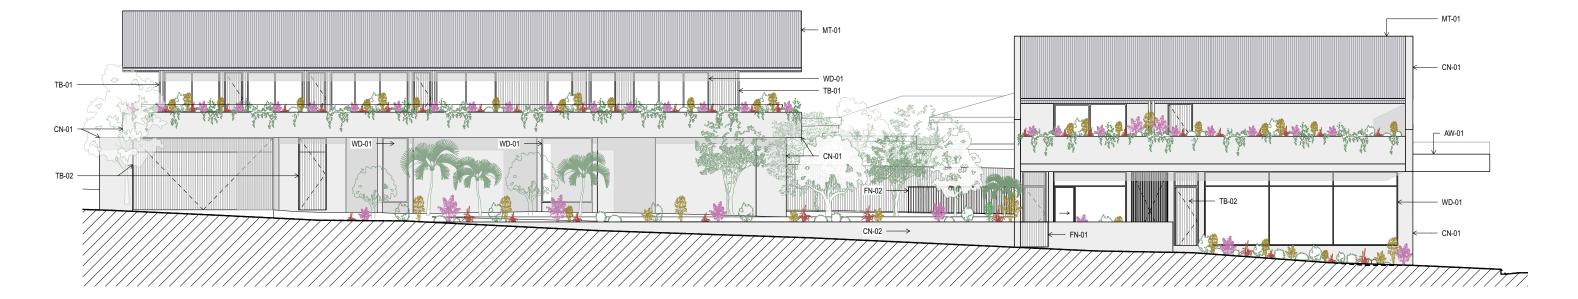

			1:150 1 0 1	0 1 2 5 10			This drawing should be read in conjunction with all relevant contracts, specifications, reports and drawings. Do not scale drawings. dimensions govern. Verify all dimensions on site before construction. Copyright of this device it do to Receive the history of the second s	ARCHITECT BREAKSPEAR ARCHITECTS ABN 81 601 670 991 ACN 601 670 991 2/4 Belgrave Street, Manly NSW 2095 P. 0421 661 146 E: studio@brkspr.com	28 BANGAROO STREET					
							[OLIEN	PROJECT NUMBER	DRAWN	CHECKED	SHEET SCALE	1
C 18/8 B 16/8 A 15/8 REV DAT	8/22 8/22	DEVELOPMENT APPLICATION DA DRAFT FOR CLIENT REVIEW DRAFT DA FOR COORDINATION DESCRIPTION					NOT F		John Cimino & Hayden Zuffo 28 Bangaroo Street, North Balgowlah, NSW, 2093	2113	LH	тв	1:150	



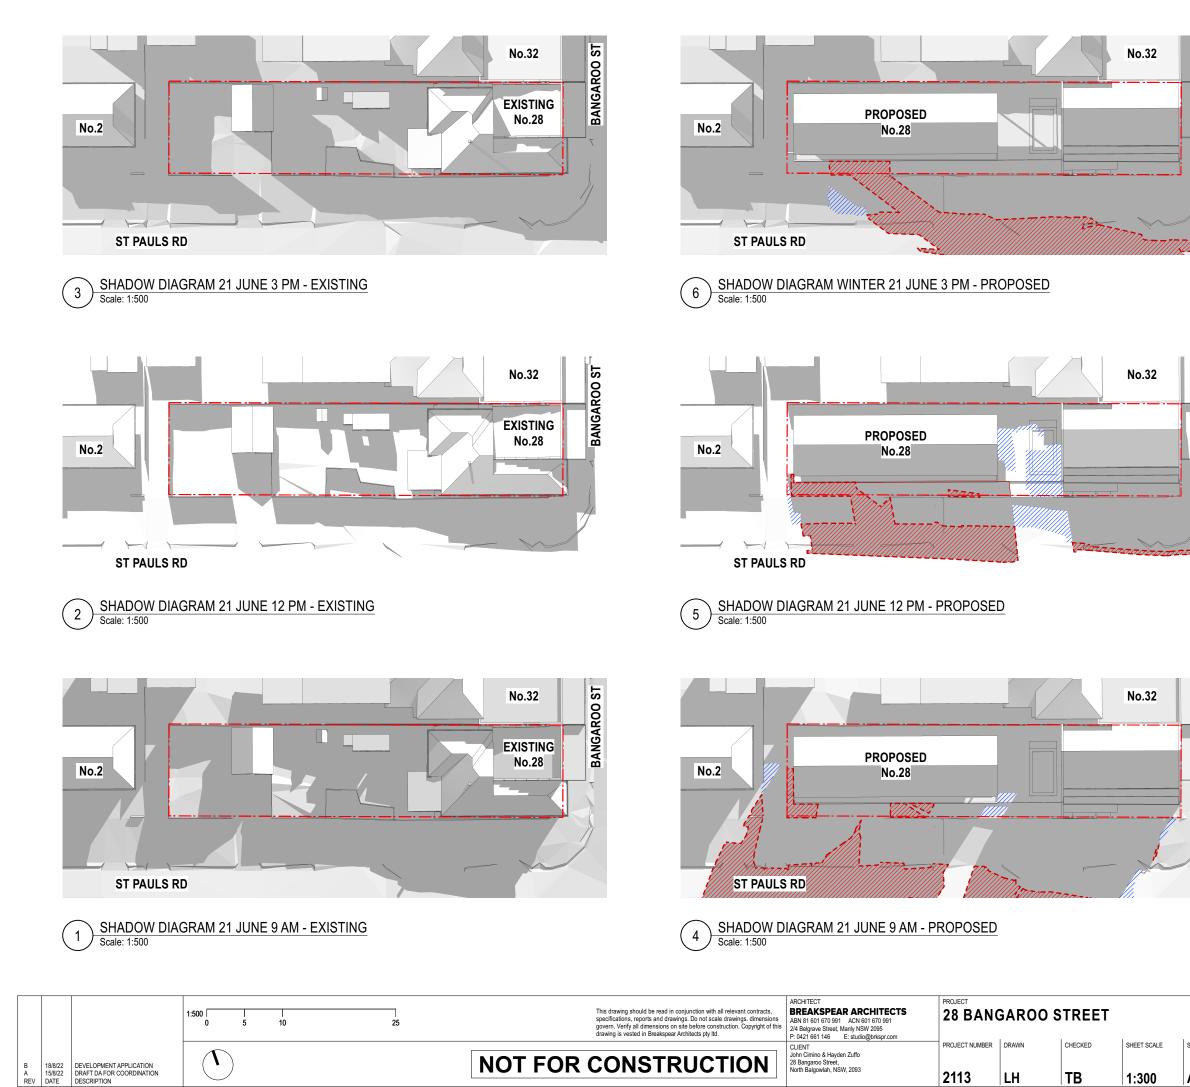






BANGAROO ST





Reduced shadow by proposed development of No.28 Bangaroo Street

Additional shadow cast by proposed development of No.28 Bangaroo Street

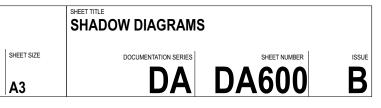


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LH


TB



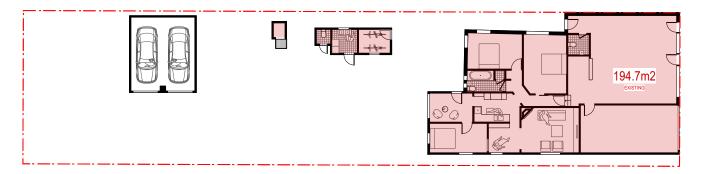


EXISTING GROUND FLOOR: 194.7m2


EXISTING LANDSCAPE: 278m2

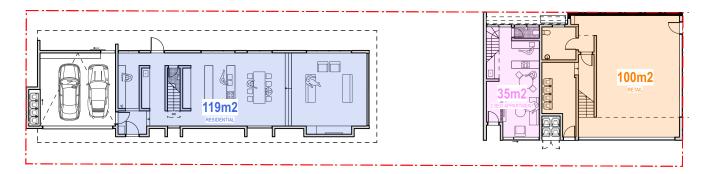



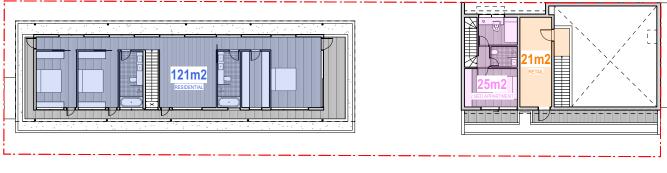



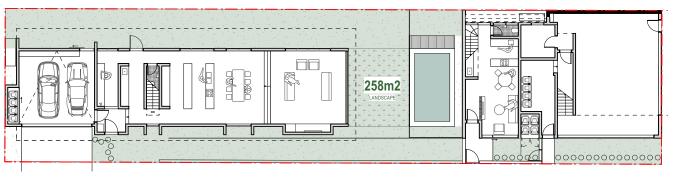






EXISTING LANDSCAPE 1 Scale: 1:300

F 18/8/22 E 16/8/22 D 15/8/22 C 29/7/22 B 26/7/22 A 6/7/22 REV DATE

SITE AREA: EXISTING LANDSCAPE	632.3m2 44% 278m2	DCP CONTROLS DCP MIN LANDSCAPE AREA: PROPOSED LANDSCAPE AREA	40% 258m2 41%
EXISTING GFA			
EXISTING GROUND FLOOR:	194.7m2	PROPOSED RESIDENTIAL GFA:	240m2
		PROPOSED RETAIL GFA:	121m2
EXISTING FSR:	0.3:1	PROPOSED SECONDARY DWELLING GFA:	60m2
TOTAL EXISTING GFA:	194.7m2		
		PROPOSED TOTAL GFA:	425m2
			0 67.1

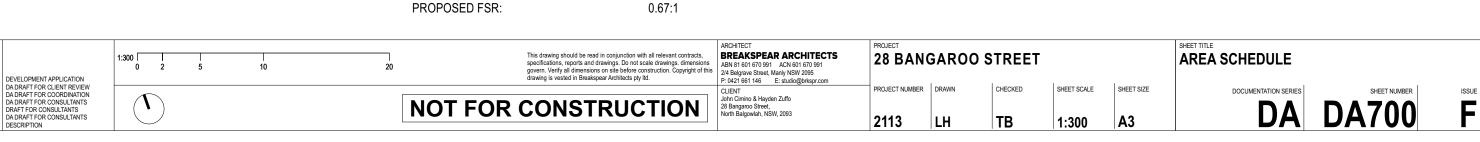



PROPOSED GROUND FLOOR: 254m2

PROPOSED FIRST FLOOR: 168m2

PROPOSED LANDSCAPE: 258m2

