

DRAWING LIST			
SHEET NUMBER	SHEET NAME	SCALE	
DA-000	Cover Sheet	nts	
DA-001 DA-002 DA-003	Site Plan Ground Plan Site Elevation	1:250 1:100 1:200	
DA-100 DA-101	Design Intent Design Intent	1:25 1:25	
DA-200	Perspective	nts	

GFA TOTAL Existing $GFA = 55,089m^2$ Proposed GFA = 34m² Total GFA = 55123m²

DEE WHY TOWN CENTRE: ADDITIONAL KIOSKS DEE WHY NSW 2022 **DEVELOPMENT APPLICATION**



Date	Scale	Sheet Size
10/04/19	NTS	@ A1
Drawn	Chk.	
VT	NWO	
Job No.	Drawing No.	Revision
	DA000	1



Drawing Name COVERSHEET

Project DEE WHY TOWN CENTRE KIOSK



DEVELOPMENT APPLICATION

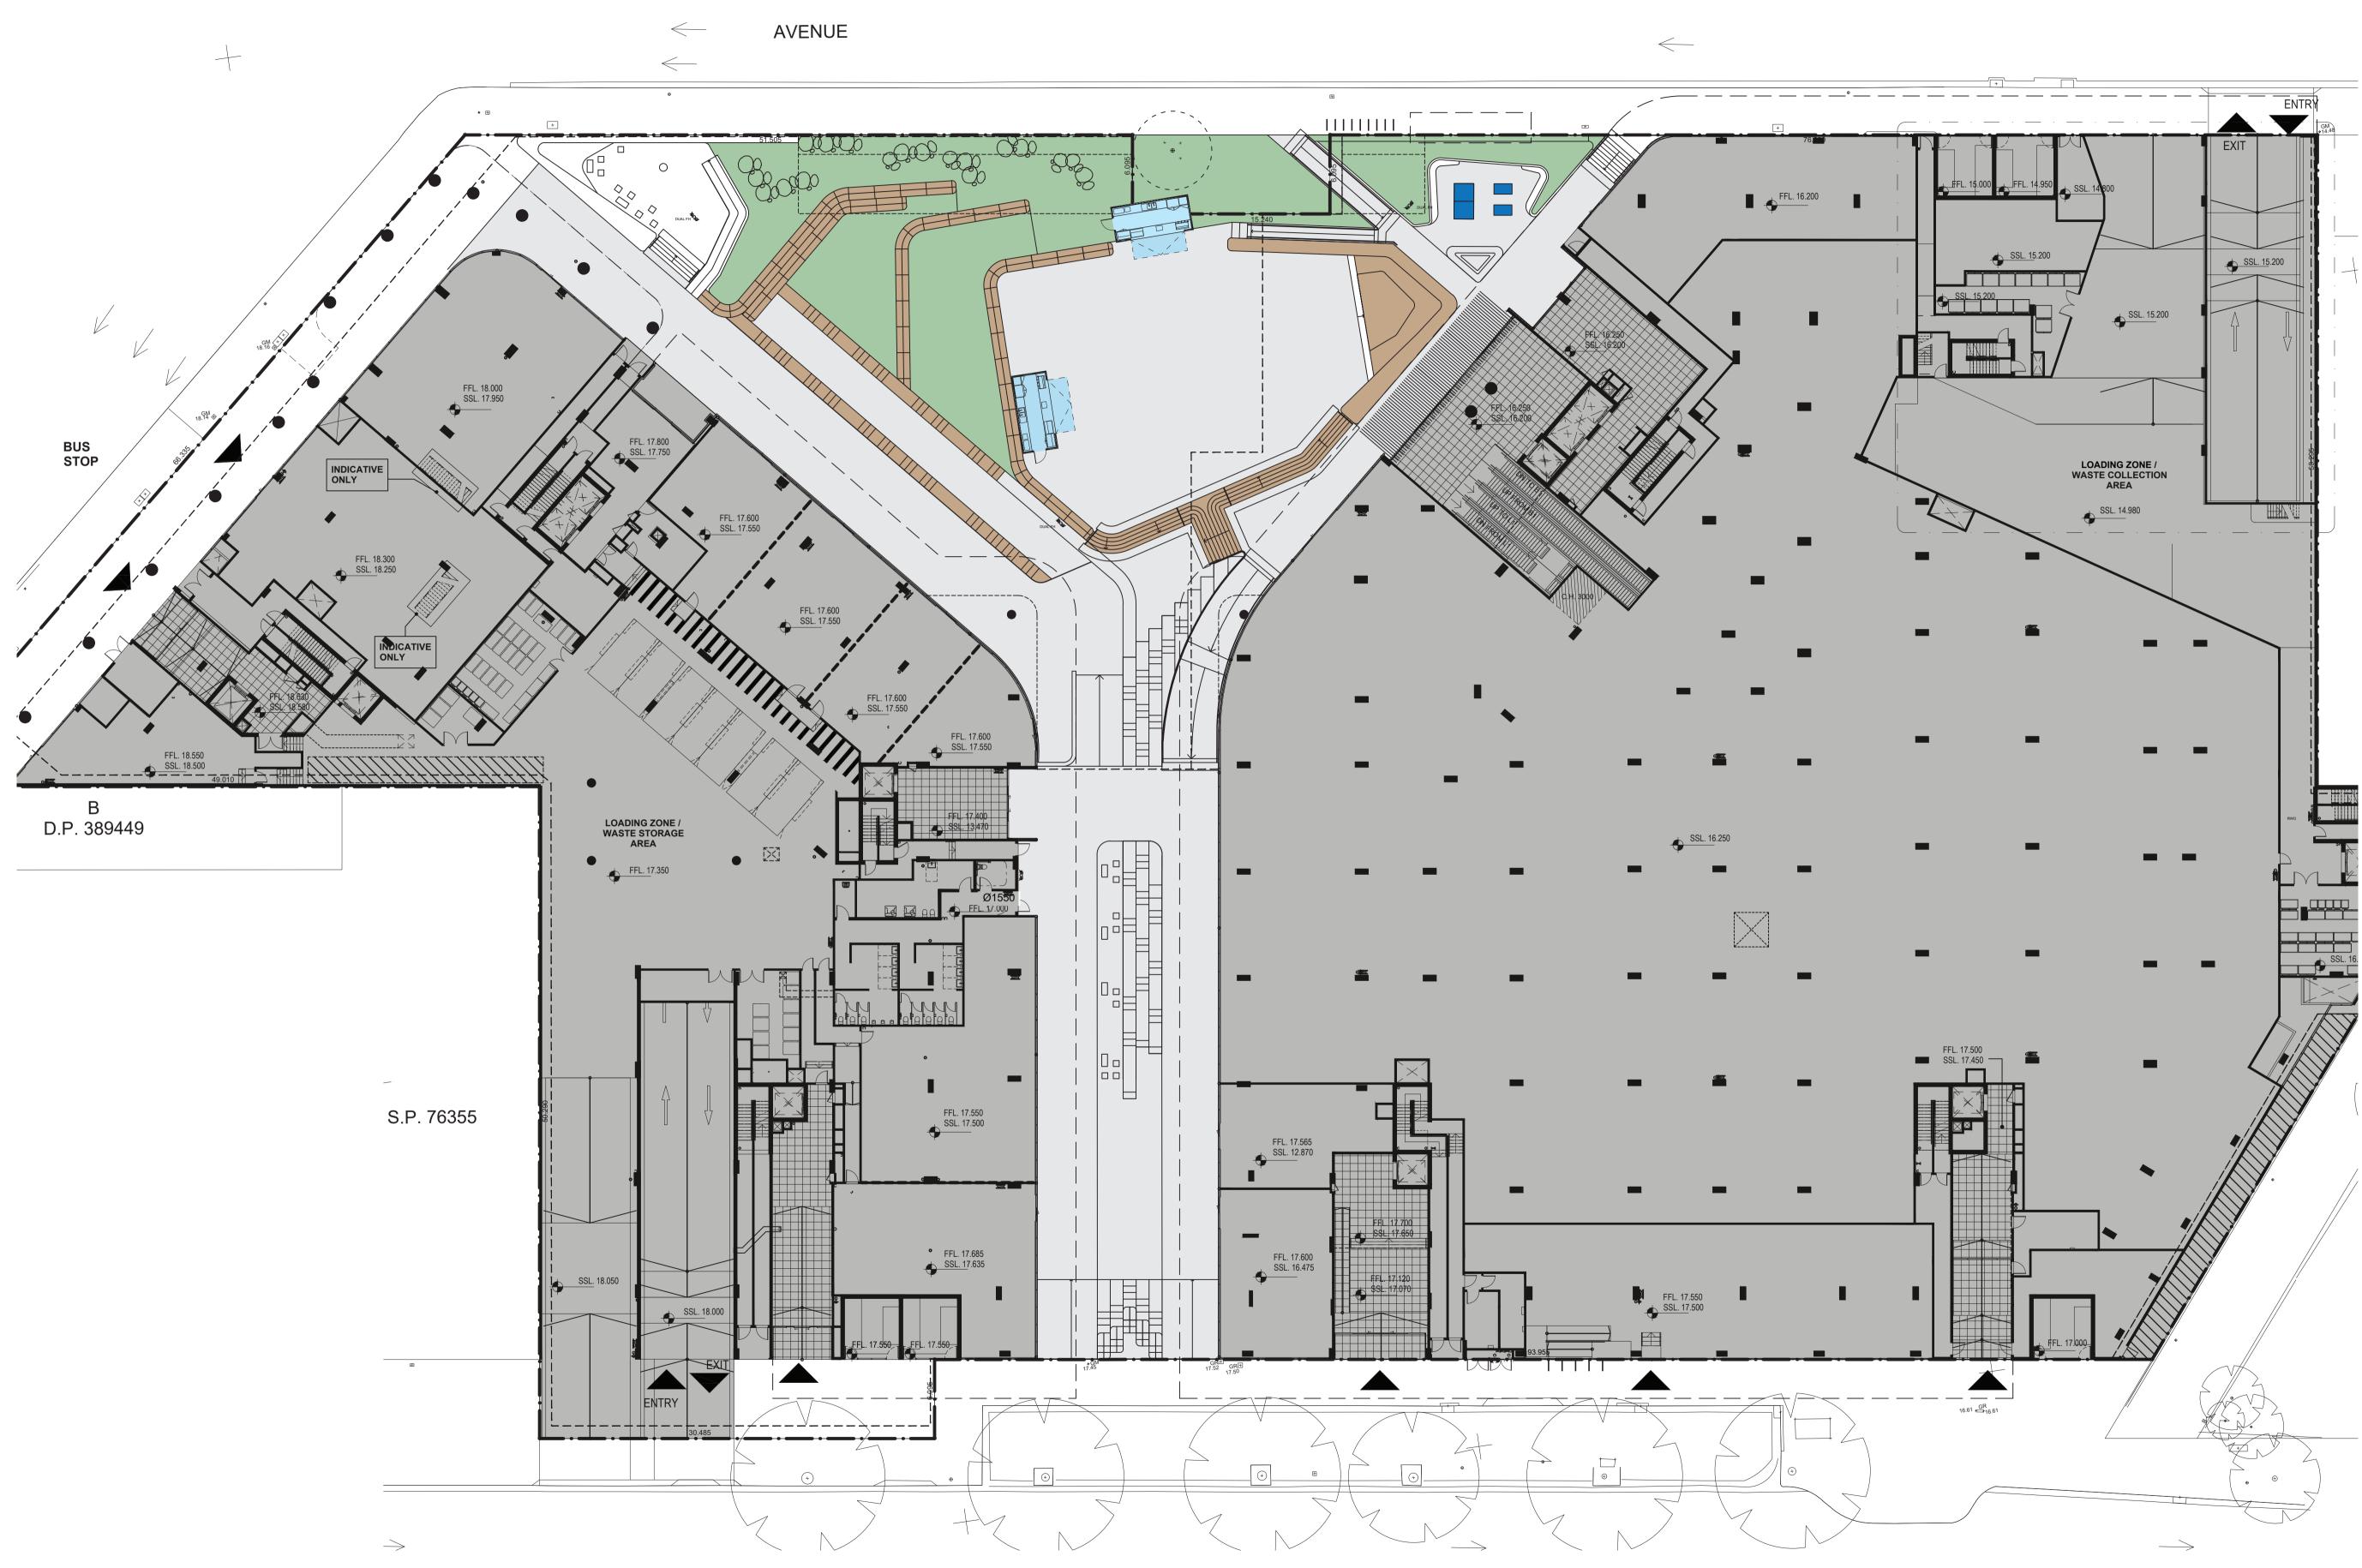
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DA issue

April 2019

By Chk. VT NWO

Nominated Architects: Neil Warner-O`Connell. Reg. 10405



Level 11, Meriton Tower 528 Kent St, Sydney 2000 T: +612 9287 2888 F: +612 9287 2777



	DA001	1
Job No.	Drawing No.	Revision
VT	NWO	
Drawn	Chk.	
10/04/19	1:250	@ A1
Date	Scale	Sheet Size



Drawing Name

DEE WHY TOWN CENTRE KIOSK



Proposed Kiosks

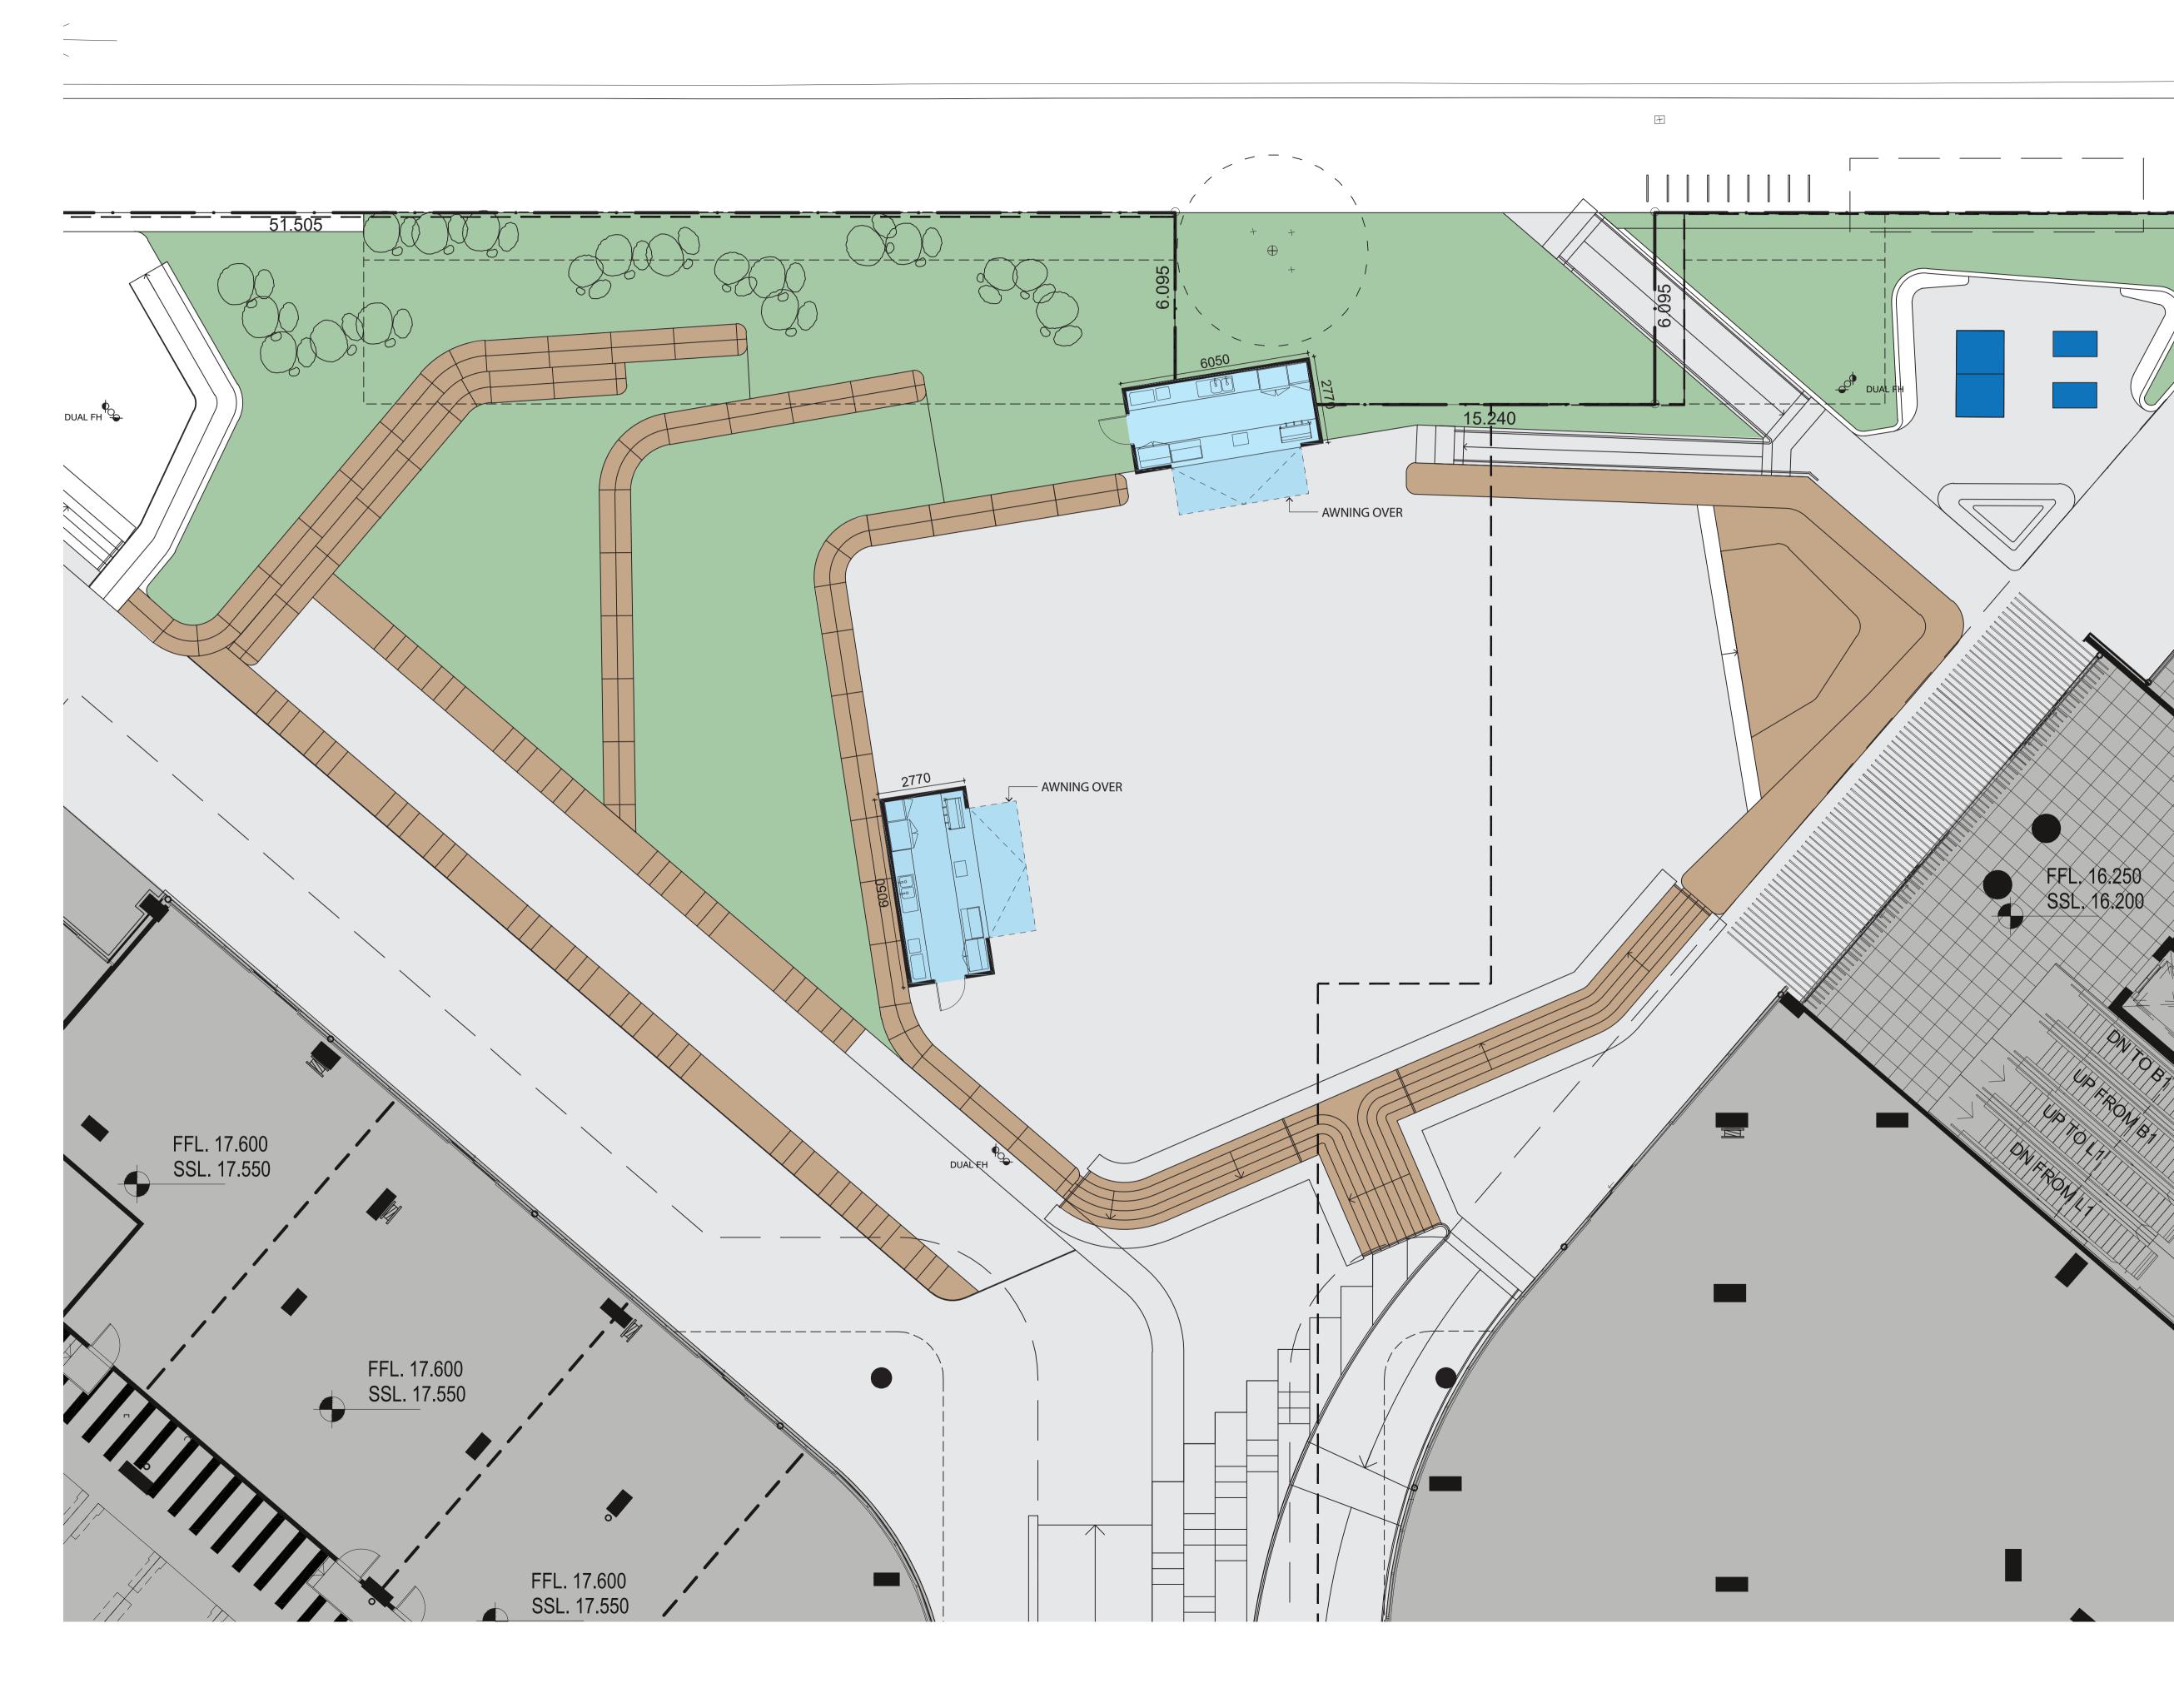
Existing Site

Legend

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I	April 2019	DA issue	VT	NWO

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VT	NWO	
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	DA002	1



Drawing Name GROUND PLAN





Proposed Kiosks

Existing Site

Legend

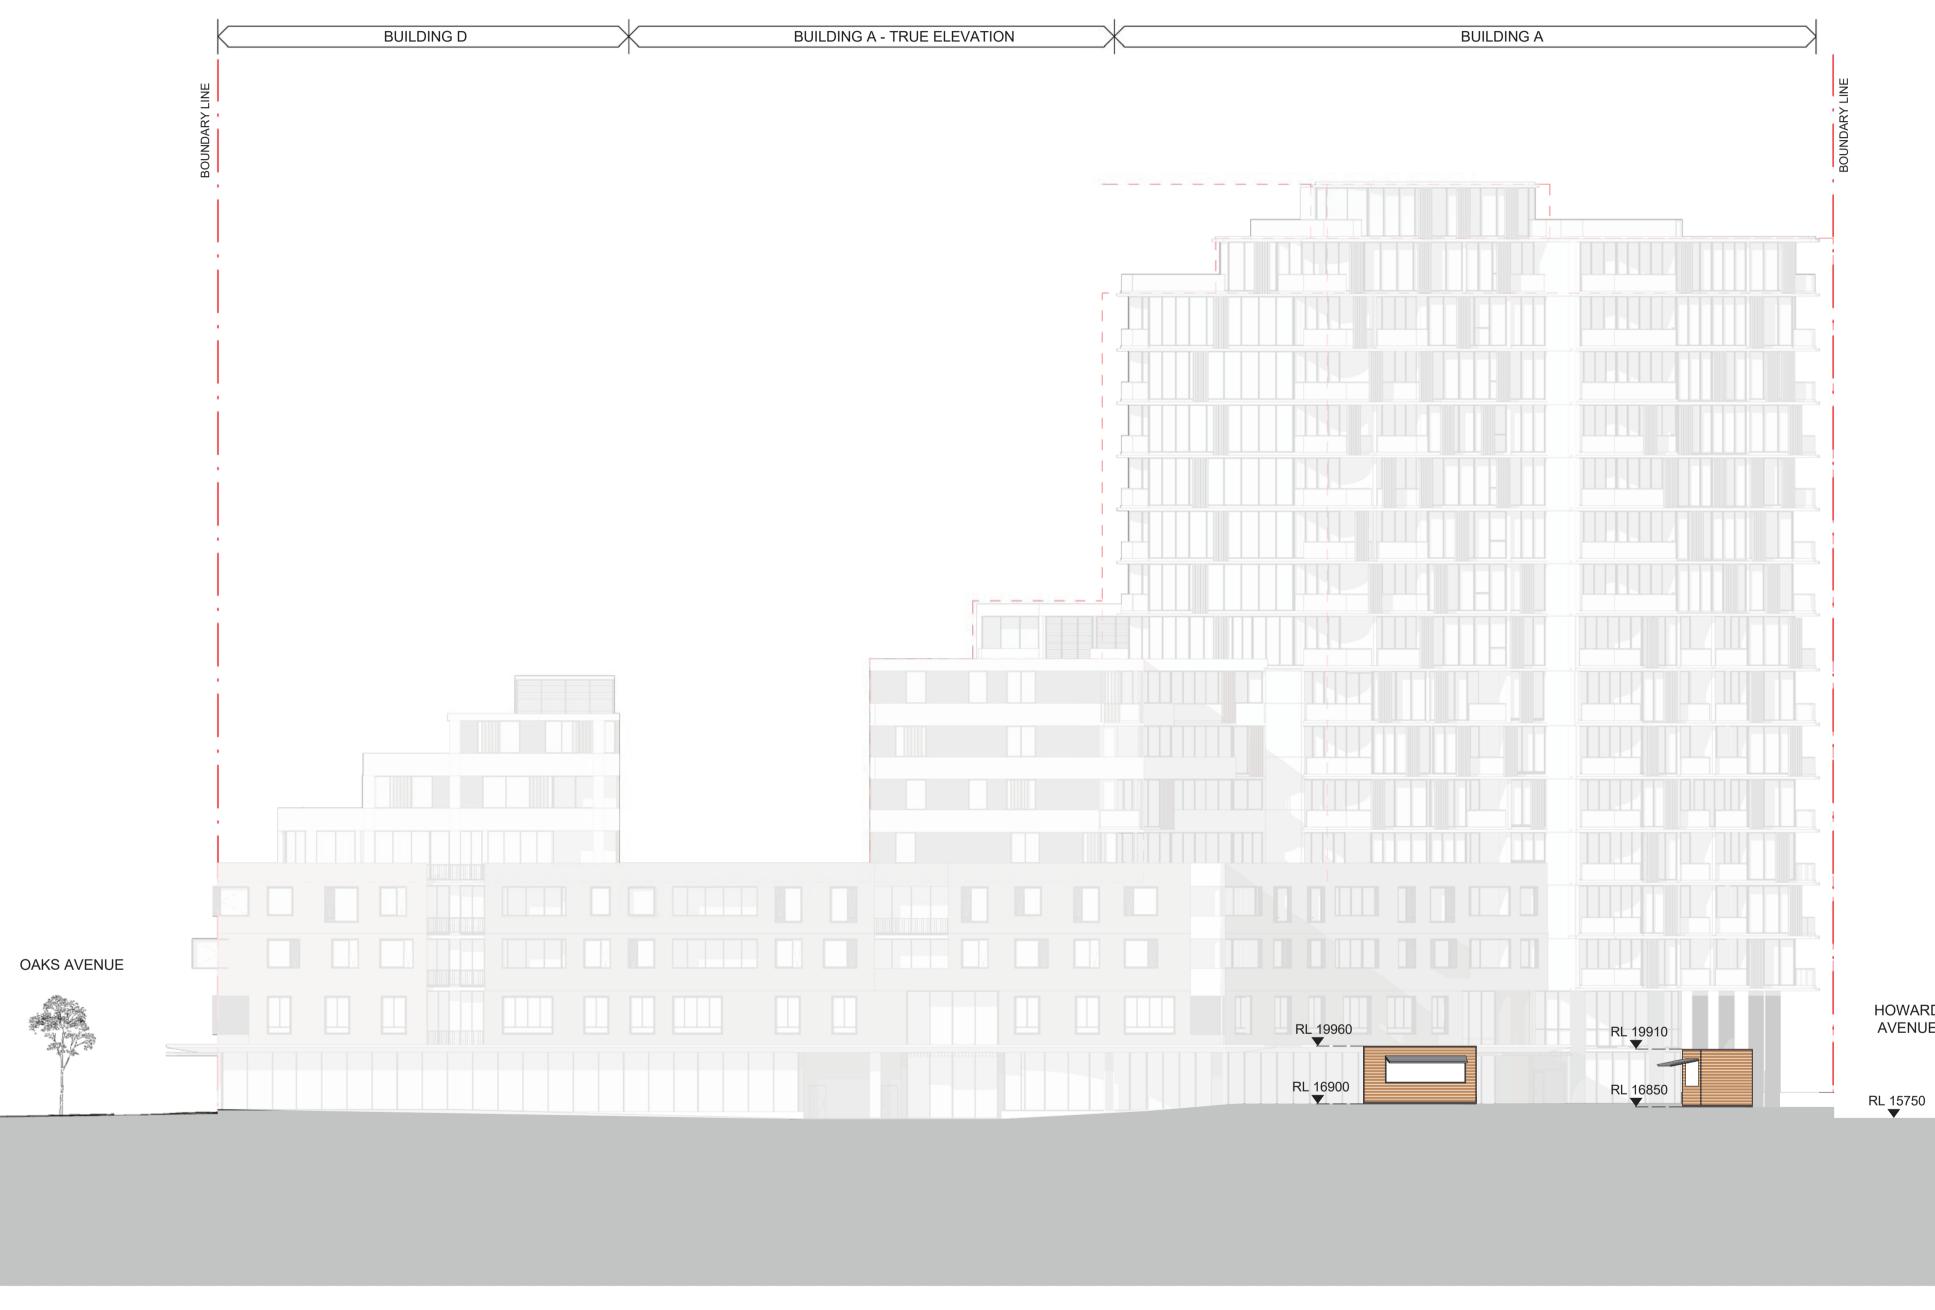




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1	April 2019	DA issue	VT	NWO





THROUGH LANE - EAST ELEVATION SCALE 1 : 250

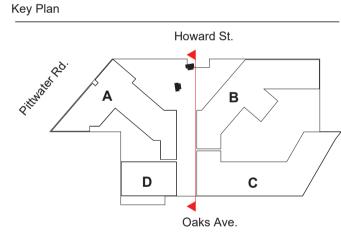
HOWARD AVENUE

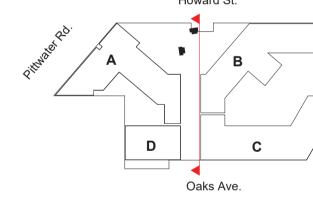


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DEE WHY TOWN

CENTRE KIOSK

OVERALL ELEVATION

Scale

Chk.

NWO

Drawing No.

DA003

MERITON

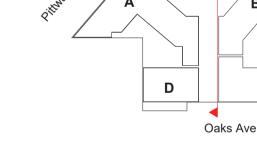
1:200

Sheet Size

@ A1

Revision

1



Drawing Name

Date

Drawn

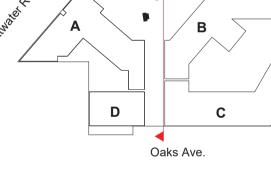
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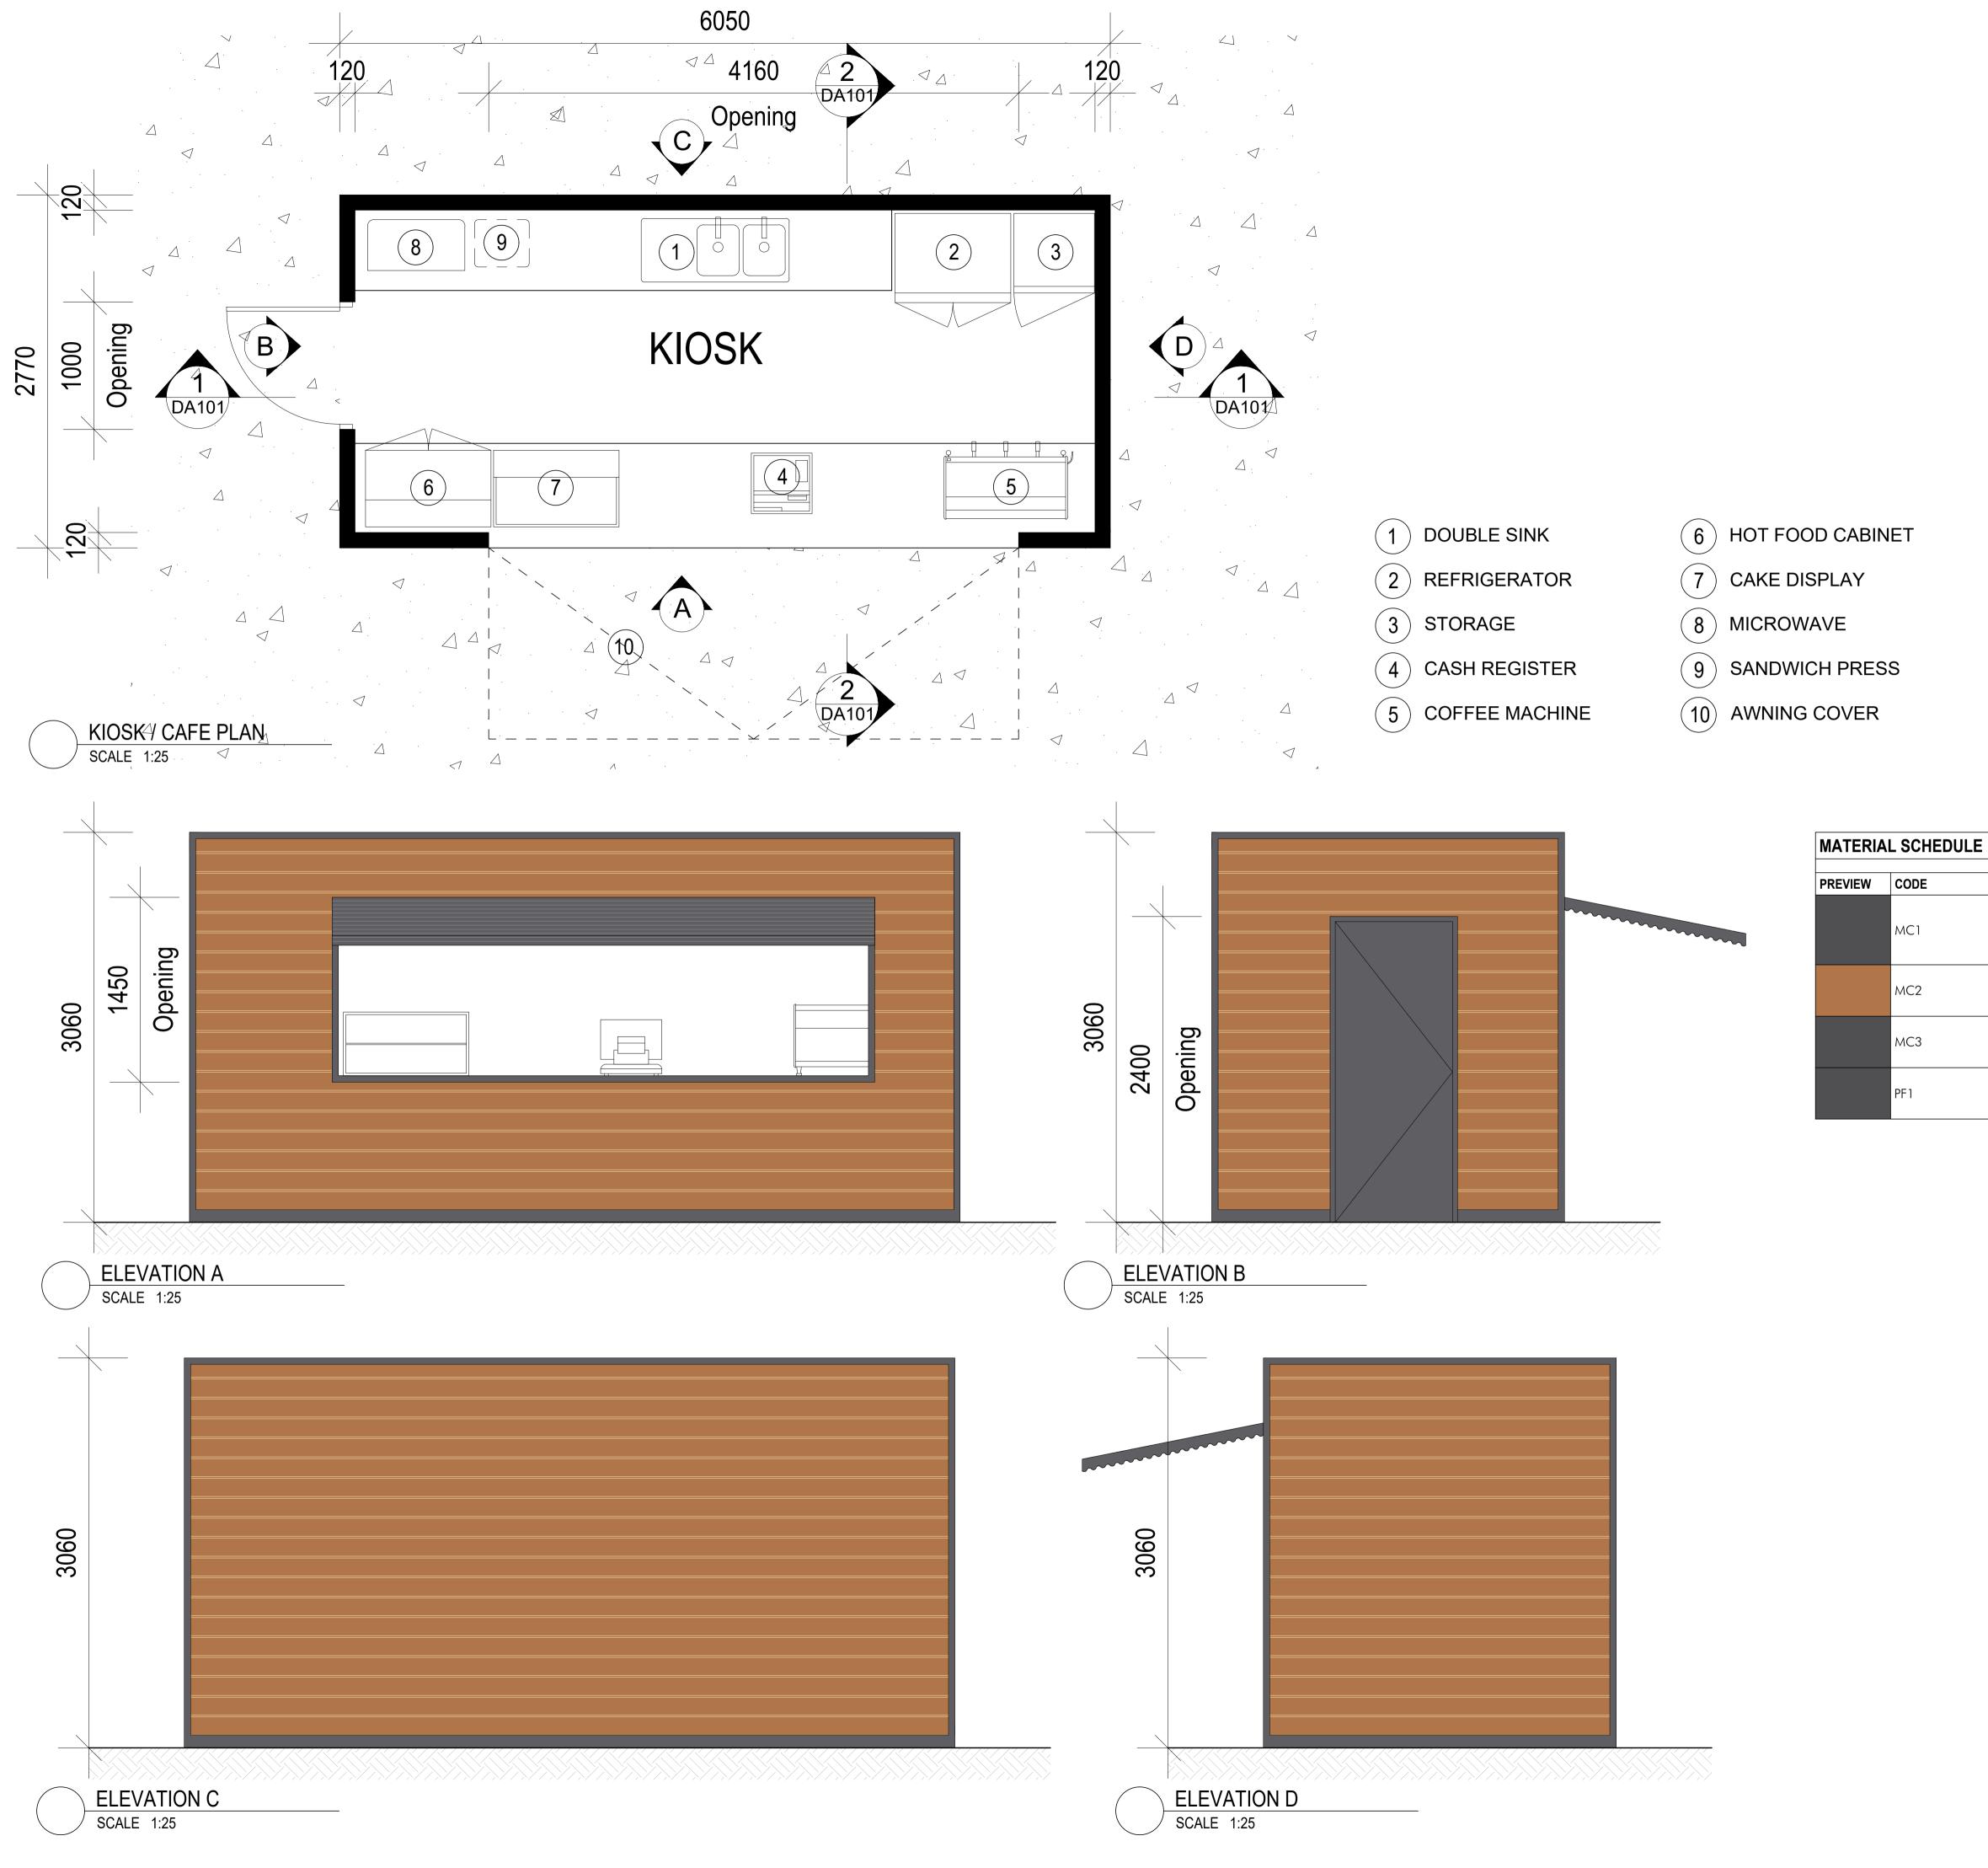
Job No.

Level 11, Meriton Tower 528 Kent St, Sydney 2000 T: +612 9287 2888 F: +612 9287 2777

10/04/19

Project







- (6) HOT FOOD CABINET
- CAKE DISPLAY
- 8) MICROWAVE
- 9 SANDWICH PRESS

PREVIEW CODE

MC1

MC2

MC3

PF1

(10) AWNING COVER

Nominated Architects: Neil Warner-O`Connell. Reg. 10405

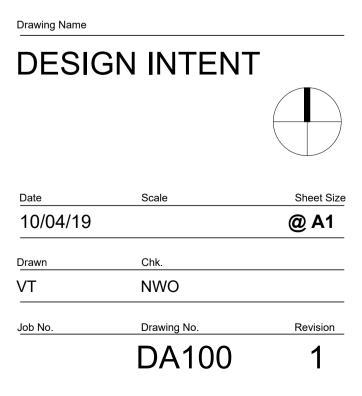
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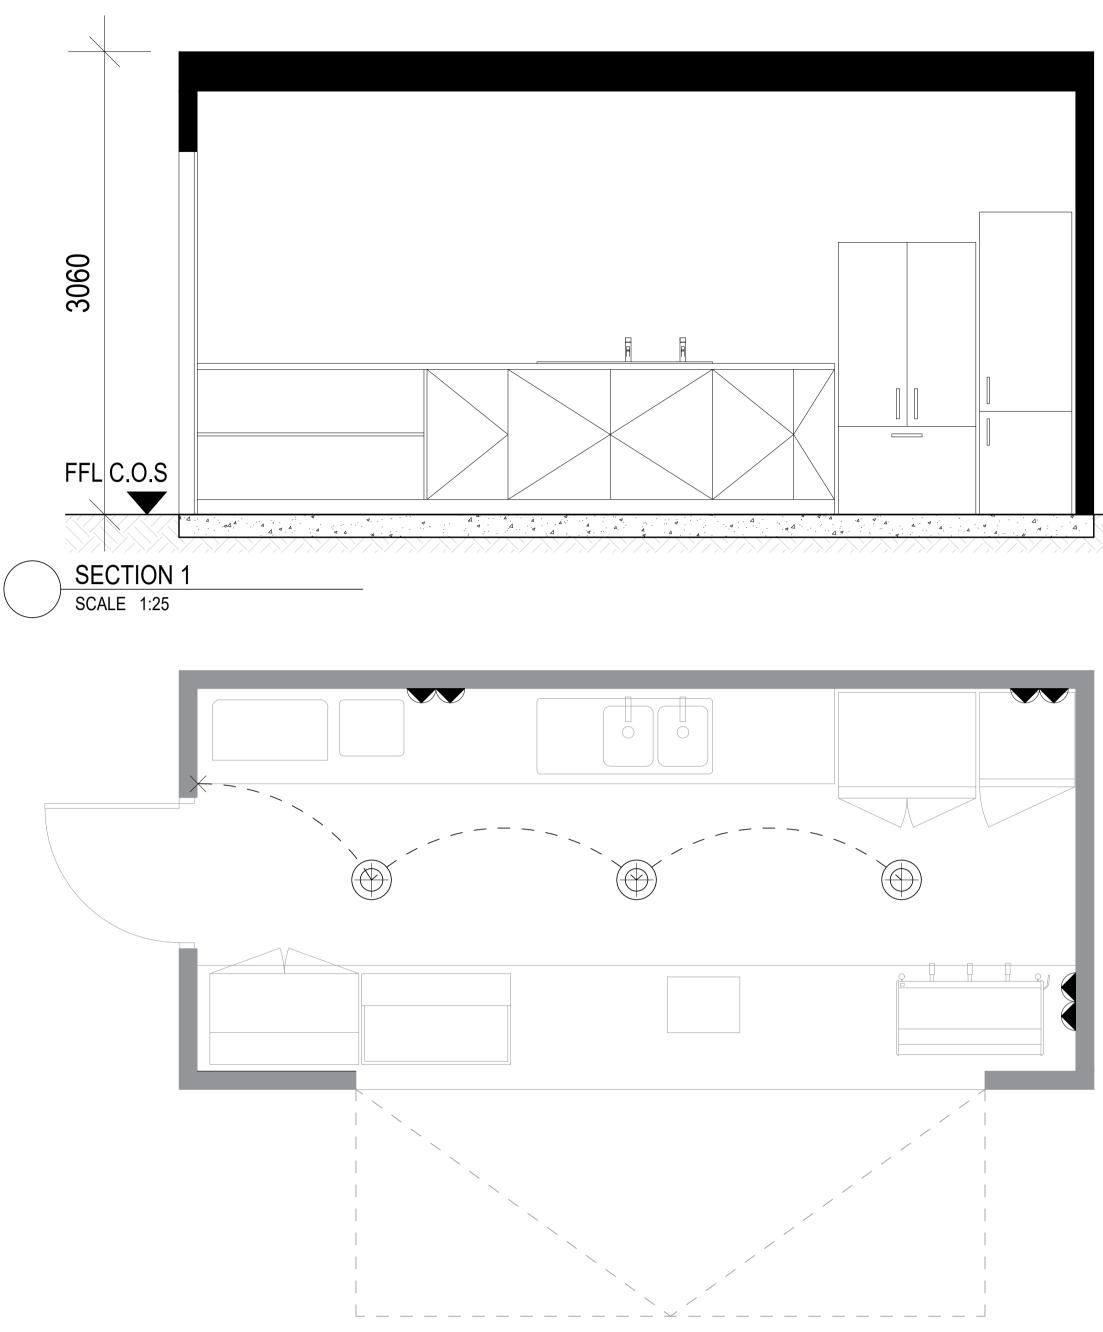
 DESCRIPTION
METAL ROOF CLADDING. COLOUR: DURATEC ZEUS 'MONUMENT' SATIN (9007307S)
TIMBER LOOK CLADDING DECOWOOD: CASURINA
PAINTED STEEL DULUX 'DOMINO' (SG6G8)
PAINT FINISH: DULUX 'DOMINO' (SG6G8)

Project DEE WHY TOWN CENTRE KIOSK







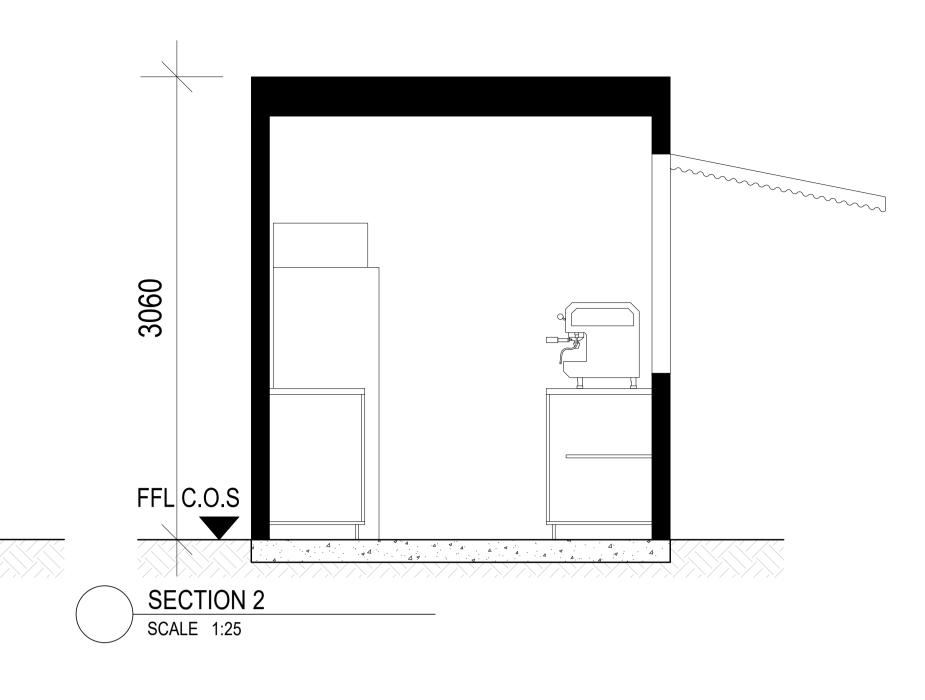


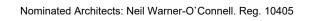
5

REFLECTED CEILING PLAN + ELECTRICAL LAYOUT SCALE 1:25

RCP / ELECTRICAL LEGEND

PREVIEW	DESCRIPTION
×	SINGLE ON/OFF SWITCH
\bigoplus	90mm SURFACE MOUNTED LED DOWNLIGHT
	DOUBLE GPO





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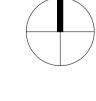
Project DEE WHY TOWN

CENTRE KIOSK

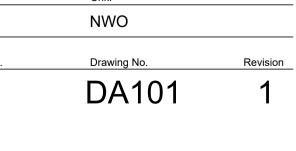
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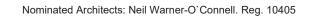


Scale Sheet Size Date 10/04/19 @ A1 Chk. Drawn NWO VT Drawing No. Job No. Revision









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DEE WHY TOWN CENTRE KIOSK

Scale

NTS

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NWO

Drawing No.

DA200

Date

VT

Job No.

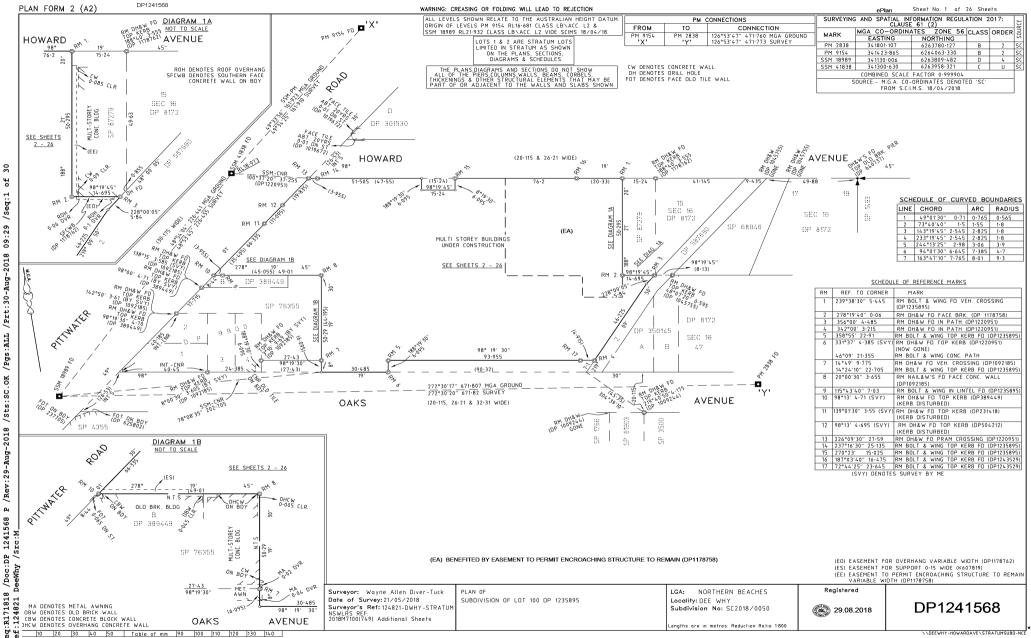
Level 11, Meriton Tower 528 Kent St, Sydney 2000 T: +612 9287 2888 F: +612 9287 2777



Sheet Size

Revision

Annexure 1: Registered Stratum Subdivision Plan



벙 /Seg:1 09:29 /Prt:30-Aug-2018 /Pgs:ALL оK /sts:sc. /Rev:29-Aug-2018 щ 1241568 B 3 /Doc:D DeeWhy R171818 124821 D Ref:

PLAN FORM 2 (A2)

DIAGRAMS & SECTIONS

DIAGRAMS & SECTIONS

DIAGRAMS & SECTIONS.

DIAGRAMS & SECTIONS.

DIAGRAMS & SECTIONS.

DIAGRAMS & SECTIONS

DIAGRAMS & SECTIONS.

BY NOTE PL2-19.

HEIGHT TO RL13-0.

DIAGRAMS & SECTIONS.

NOTES PL2-19:

NOTE PL1-1:

NOTE PL2-14:

NOTE PL2-9:

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R171818 124821

PARKING LEVEL 3 & BELOW

IN HEIGHT TO THE LEVEL &\OR INCLINED PLANES THAT DEFINE THE LOWER STRATUM LIMIT OF THE

IN HEIGHT TO THE LEVEL \$100 INCLINED DI ANEC

THAT DEFINE THE LOWER STRATUM LIMIT OF THE

PARKING LEVEL 2 NOTES PL2-1, PL2-2, PL2-3 & PL2-4: PT 1 IS LIMITED IN DEPTH TO RL10-8 AND IS

LIMITED IN HEIGHT TO THE LEVEL & OR INCLINED

THE LOT ABOVE PT 1 AS SHOWN ON THE PLANS

THE LOT ABOVE PT 2 AS SHOWN ON THE PLANS,

NOTES PL2-6, PL2-7 & PL2-8: PT 2 IS LIMITED IN DEPTH TO THE INCLINED PLANES DEFINED IN PLAN AND LEVEL BY THE

TRIANGLE APEXES SHOWN AND IS LIMITED IN

THAT DEFINE THE LOWER STRATIM LIMIT OF

THE LOT ABOVE PT 2 AS SHOWN ON THE PLANS, DIAGRAMS & SECTIONS,

NOTES PL2-10, PL2-11, PL2-12, PL2-13, PL2-15, PL2-16 & PL2-17,

HEIGHT TO THE LEVEL & OR INCLINED PLANES

THE LOT ABOVE PT 2 AS SHOWN ON THE PLANS,

PT 1 IS LIMITED IN DEPTH TO RL10-2 AND IS LIMITED IN HEIGHT TO THE LEVEL &\OR INCLINED

PT 2 IS LIMITED IN DEPTH TO RUID-2 AND IS

NOTE PL2-18: PT 1 IS LIMITED IN DEPTH TO RL10-2 AND IS

PT 2 IS LIMITED IN DEPTH TO THE INCLINED PLANES DEFINED IN PLAN AND LEVEL BY THE

TRIANGLE APEXES SHOWN AND IS LIMITED IN

PARKING LEVEL 1

ON THE PLANS, DIAGRAMS & SECTIONS.

IS LIMITED IN DEPTH TO RL13-6 AND IS

NOTES PL1-2, PL1-3, PL1-4, PL1-5, PL1-6, PL1-7 & PL1-8;

THE LOT ABOVE PT 1 AS SHOWN ON THE PLANS.

PT 1 IS LIMITED IN DEPTH TO RL13-6 AND IS

NOTE PL1-9, PL1-14 & PL1-16; PT 2 IS LIMITED IN DEPTH TO THE INCLINED

PLANES DEFINED IN PLAN AND LEVEL BY THE

TRIANGLE APEXES SHOWN AND IS LIMITED IN HEIGHT TO THE LEVEL & OR INCLINED PLANES

10 20 30 40 50 Table of mm 90 100 110 120 130 140

THAT DEFINE THE LOWER STRATUM LIMIT OF THE LOT ABOVE PT 2 AS SHOWN ON THE

PLANS, DIAGRAMS & SECTIONS.

THE LOT ABOVE PT 2 AS SHOWN ON THE PLANS,

NOTE PL2-5: PT 2 IS LIMITED IN DEPTH TO RL10-8 AND IS

LOT ABOVE PT 1 AS SHOWN ON THE PLANS,

NOTES PL3-5, PL3-6, PL3-7, PL3-8 & PL3-9; PT 2 IS UNLIMITED IN DEPTH AND IS LIMITED

LOT ABOVE PT 2 AS SHOWN ON THE PLANS,

NOTES PL3-1, PL3-2, PL3-3 & PL3-4: PT 1 IS UNLIMITED IN DEPTH AND IS LIMITED

DP1241568

NOTE PL1-10-

D TO REJECTION			ePla	n Sheet No. 2 of 26 Sheets
				INDEX TO DIAGRAMS
NOTE GL-29. PT 2 IS LIMITED IN DEPTH TO RL17:3 A LIMITED IN HEIGHT TO THE LEVEL & \OF PLANES THAT DEFINE THE LOVER STR. THE LOT ABOVE PT 2 AS SHOWN ON T DIAGRAMS & SECTIONS. NOTE GL-30. PT 1 IS LIMITED IN DEPTH TO RL10:57 PT 1 IS LIMITED IN DEPTH TO RL10:57 PT 1 IS LIMITED IN DEPTH TO RL10:72 DIAGRAMS & SECTIONS. NOTE GL-31. PT 1 IS LIMITED IN DEPTH TO RL10:9. NOTE GL-32. PLANES THAT DEFINE THE LOVER STR. THE LOT ABOVE PT 1 AS SHOWN ON T DIAGRAMS & SECTIONS. NOTE GL-32. PLANES INTED IN DEPTH TO RL10:9.A LIMITED IN HEIGHT TO THE LEVEL & \OF PLANES INTED IN DEPTH TO RL10:9.A LIMITED IN HEIGHT TO THE LEVEL & \OF PLANES THAT DEFINE THE LOVER STR. THE LOT ABOVE PT 1 AS SHOWN ON T DIAGRAMS & SECTIONS. NOTE GL-32. THE LOT ABOVE PT 1 AS SHOWN ON T DIAGRAMS & SECTIONS. NOTE GL-32. PLANES THAT DEFINE THE LOVER STR. THE LOT ABOVE PT 1 AS SHOWN ON TO DIAGRAMS & SECTIONS. NOTE GL-33. PT 2 IS LIMITED IN DEPTH TO RL15:85	RINCLINED THE PLANS, AND IS RINCLINED ATUM LIMIT OF HE PLANS, AND IS RINCLINED RINCLINED RINCLINED RINCLINED ATUM LIMIT OF HE PLANS,	THE LOT ABOVE PT 1 AS DIAGRAMS & SECTIONS. LEVEL 22. NOTES L2-1 & L2-2. PT 1 IS LINTED IN DEPT LIMITED IN HEIGHT TO TH PLANES THAT DEFINE TH THE LOT ABOVE PT 1 AS DIAGRAMS & SECTIONS. NOTES L2-3. L2-4. L2-5. PT 2 IS LIMITED IN DEPT LIMITED IN HEIGHT TO TH PLANES THAT DEFINE THI THE LOT ABOVE PT 2 AS DIAGRAMS & SECTIONS. NOTES L2-6. PT 1 IS LIMITED IN DEPT LIMITED IN HEIGHT TO TH PLANES THAT DEFINE THI THE LOT ABOVE PT 1 AS	I TO RL21-15 AND IS E LEVEL & XOR INCLINED LOWER STRATUM LIMIT OF SHOWN ON THE PLANS, I TO RL24-7 AND IS E LEVEL & XOR INCLINED LOWER STRATUM LIMIT OF SHOWN ON THE PLANS, L2-7 & L2-8; I TO RL24-7 AND IS E LEVEL & XOR INCLINED E LOWER STRATUM LIMIT OF SHOWN ON THE PLANS, I TO RL25-S5 AND IS E LOWER & STRATUM LIMIT OF LOWER STRATUM LIMIT OF LOWER & STRATUM LIMIT OF LEVEL & XOR INCLINED E LOWER STRATUM LIMIT OF I OR RL25-S5 AND IS E LOWER STRATUM LIMIT OF LOWER STRATUM LIMIT OF I OR RL25-S5 AND IS E LOWER STRATUM LIMIT OF I OR RL25-S5 AND IS I TO RL25-S5 AND IS I LOWER STRATUM LIMIT OF	No. No.
$\begin{array}{c} \hline 17 2.1 \times LIMITED IN DEPTH TO RUIS-85 \\ \hline 1017ED IN HEIGHT TO THE LEVEL & XOP PLANES THAT DEFINE THE LOVER STR. THE LOT REGUVE PT 2 AS SHOWN ON T DIAGRAMS & SECTIONS. NOTE GL-34. PLANES THAT DEFINE THE LOVER STR. THE LOT ABOVE PT 1 AS LIMITED IN DEPTH TO RLIG-13 A LIMITED IN DEPTH TO RLIG-14 A VOP PT 1 AS SHOWN ON T DIAGRAMS & SECTIONS. NOTE GL-35. PLANES THAT DEFINE THE LOVER STR. THE LOT ABOVE PT 1 AS SHOWN ON T DIAGRAMS & SECTIONS. NOTE GL-35. PT 2 IS LIMITED IN DEPTH TO RLIG-2 A LIMITED IN HEIGHT TO THE LEVEL & VOP PT 2 AS SHOWN ON T DIAGRAMS & SECTIONS. NOTE GL-35. PT 2 IS LIMITED IN DEPTH TO RL10-2 A LIMITED IN HEIGHT TO THE LEVEL & VOP PLANES STATE DEFINE THE LOVER STR. THE LOT ABOVE PT 2 AS SHOWN ON TO DIAGRAMS & SECTIONS. NOTES LI-2 & LI-35. PT 1 IS LIMITED IN DEPTH TO RL21-35. LIMITED IN HEIGHT TO RHE LOVER STR. THE LOT ABOVE PT 2 AS SHOWN ON TO DIAGRAMS & SECTIONS. NOTES LI-2 & LI-36. PT 1 IS LIMITED IN DEPTH TO RL21-35. LIMITED IN HEIGHT TO RHE IOWER STR. THE LOT ABOVE PT 2 AS SHOWN ON TO DIAGRAMS & SECTIONS. NOTES LI-2 & LI-36. PT 1 IS LIMITED IN DEPTH TO RL21-35. LIMITED IN HEIGHT TO THE LEVEL & VOP PT 10 RL21-35. LIMITED IN HEIGHT TO THE LEVEL VALOR STR. THE LOT ABOVE PT 2 AS SHOWN ON TO DIAGRAMS & SECTIONS. $	ATUM LIMIT OF HE PLANS, AND IS R INCLINED R INCLINED ATUM LIMIT OF HE PLANS, MID IS R INCLINED ATUM LIMIT OF HE PLANS, AND IS R INCLINED AND IS R INCLINED	DIAGRAMS & SECTIONS DIAGRAMS & SECTIONS PT I IS LIMITED IN DEPT LIMITED IN HEIGHT TO TH PLANES THAT DEFINE THI THE LOT ABOVE PT I AS DIAGRAMS & SECTIONS. NOTES 12-0: NOTES 12-0: NOTES 12-0: NOTES 12-0: NOTES 12-0: NOTES 12-0: NOTES 12-0: NOTES 12-0: NOTES 12-0: NOTES 12-0: LIMITED IN DEPT HANS THAT DEFINE THI PLANES THAT DEFINE THI DATA SECTIONS. LEVEL 3 & A NOTES 13-1: PT I IS LIMITED IN DEPT UNLIMITED IN DEPT UNLIMITED IN DEPT UNLIMITED IN DEPT UNLIMITED IN HEIGHT AS PLANS, DIAGRAMS & SECTIONS. PT IS LIMITED IN DEPT UNLIMITED IN HEIGHT AS PLANS, DIAGRAMS & SECTIONS. NOTES 13-1: 3, 13-4: & 13-2: PT I IS LIMITED IN DEPT	I TO RL23-6 AND IS E LEVEL & AOR INCLINED E LOWER STRATUM LIMIT OF SHOWN ON THE PLANS, I TO RL22-75 AND IS E LOWER STRATUM LIMIT OF SHOWN ON THE PLANS, I TO RL23-6 AND IS E LOWER STRATUM LIMIT OF SHOWN ON THE PLANS, I TO RL23-75 AND IS SHOWN ON THE I TO RL27-75 AND IS SHOWN ON THE I TO RL27-75 AND IS SHOWN ON THE IONS.	$\begin{tabular}{ c c c c c c c c c c c c c c c c c c c$
PLANES THAT DEFINE THE LOWERS STR. THE LOT ABOVE PT 1 AS SHOWN ON T DIAGRAMS & SECTIONS. MOTE L1-4: PT 2 IS LIMITED IN DEPTH TO RL21-65 LIMITED IN HEIGHT TO THE LEVEL & SOU PLANES THAT DEFINE THE LOWER STR. THE LOT ABOVE PT 2 AS SHOWN ON TO DIAGRAMS & SECTIONS. MOTES L1-5, L1-6, L1-7 & L1-8: PT 1 IS LIMITED IN DEPTH TO RL21-35 LIMITED IN DEGNT TO THE LEVEL & SOU PLANES THAT DEFINE THE LOWER STR. THE LOT ABOVE PT 1 AS SHOWN ON TO DIAGRAMS & SECTIONS. MOTES L1-9; PT 2 IS LIMITED IN DEPTH TO RL22-3 LIMITED IN DEGNT TO RL22-3 LIMITED IN DEGN	THE PLANS, AND IS R INCLINED ATUM LIMIT OF THE PLANS, AND IS R INCLINED ATUM LIMIT OF THE PLANS, AND IS R INCLINED ATUM LIMIT OF THE PLANS, AND IS B INCLINED	PT 2 IS LIMITED IN DEPT UNLIMITED IN HEIGHT AS PLANS, DIAGRAMS & SEC ROAD WIDENING LOWER SI NOTE RW-3: THE ROAD WIDENING IS LI NOTES RW-4 & RW-5: THE ROAD WIDENING IS LI	H TO RL27-75 AND IS SNOWN ON THE TIONS. IRATUM LIMITS (DP1235895) MITED IN DEPTH TO RL17-1. MITED IN DEPTH TO THE LEVEL HAT DEFINE THE LOVER STRAT	
PLANES THAT DEFINE THE LOWER STR THE LOT ABOVE PT 2 AS SHOWN ON " DIAGRAMS & SECTIONS. JP 1235895	ATUM LIMIT OF THE PLANS, LGA: NORT Locality: DEE	HERN BEACHES WHY 10: SC2018/0050	Registered	DP1241568

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Lengths are in metres. Reduction Ratio N/A

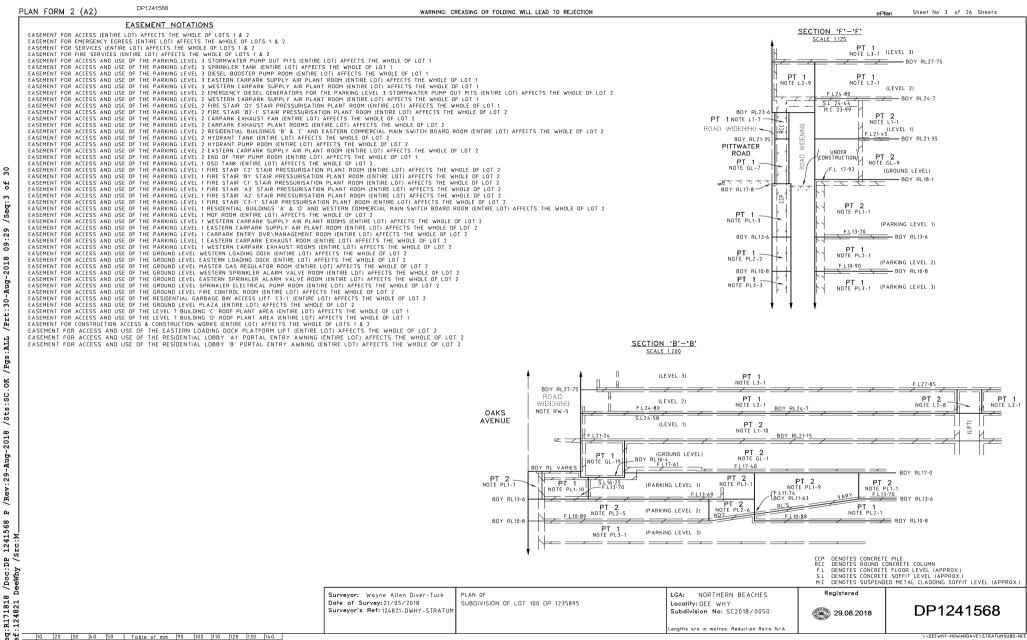
PT 1 IS LIMITED IN DEPTH TO RL13.6 AND IS LIMITED IN HEIGHT TO THE LEVEL & OR INCLINED PLANES THAT DEFINE THE LOWER STRATUM LIMIT OF THE LOT OR ROAD WIDENING ABOVE PT 1 AS SHOWN ON THE PLANS, DIAGRAMS & SECTIONS. NOTES PL1-11, PL1-12 & PL1-13. PT 1 IS LIMITED IN DEPTH TO RL13-0 AND IS LIMITED IN HEIGHT TO THE LEVEL &\OR INCLINED PLANES THAT DEFINE THE LOWER STRATUM LIMIT OF THE LOT ABOVE PT 1 AS SHOWN ON THE PLANS, DIAGRAMS & SECTIONS. NOTE PL1-15 PT 2 IS LIMITED IN DEPTH TO RL12-0 AND IS LIMITED IN HEIGHT TO THE LEVEL &\OR INCLINED PLANES THAT DEFINE THE LOWER STRATUM LIMIT OF THE LOT ABOVE PT 2 AS SHOWN ON THE PLANS. DIAGRAMS & SECTIONS. NOTE PL1-17: 2 IS LIMITED IN DEPTH TO PLISA AND IS LIMITED IN HEIGHT TO THE LEVEL & OR INCLINED PLANES THAT DEFINE THE LOWER STRATUM LIMIT OF PLANES THAT DEFINE THE LOWER STRATUM LIMIT OF THE LOT ABOVE PT 2 AS SHOWN ON THE PLANS, DIAGRAMS & SECTIONS. GROUND LEVEL NOTE GL-1: LIMITED IN HEIGHT TO THE LEVEL & VOR INCLINED PLANES THAT DEFINE THE LOWER STRATUM LIMIT OF PT 2 IS LIMITED IN DEPTH TO RL17-0 AND IS LIMITED IN HEIGHT TO THE LEVEL &\OR INCLINED PLANES THAT DEFINE THE LOWER STRATUM LIMIT OF THE LOT ABOVE PT 2 AS SHOWN ON THE PLANS, DIAGRAMS & SECTIONS. NOTE GL-2: PT 2 IS LIMITED IN DEPTH TO RL16-65 AND IS LIMITED IN HEIGHT TO THE LEVEL &\OR INCLINED PLANES THAT DEFINE THE LOWER STRATUM LIMIT OF THE LOT ABOVE PT 2 AS SHOWN ON THE PLANS. DIAGRAMS & SECTIONS. NOTES GL-3 & GL-5: PT 2 IS LIMITED IN DEPTH TO RI 17-8 AND IS PT 2 IS LIMITED IN DEPTH TO RL8-9 AND IS LIMITED IN HEIGHT TO THE LEVEL &\OR INCLINED PLANES THAT DEFINE THE LOWER STRATUM LIMIT OF LIMITED IN HEIGHT TO THE LEVEL &\OR INCLINED PLANES THAT DEFINE THE LOWER STRATUM LIMIT OF THE LOT ABOVE PT 2 AS SHOWN ON THE PLANS, DIAGRAMS & SECTIONS NOTES GL-4, GL-6, GL-7 & GL-8; PT 1 IS LIMITED IN DEPTH TO RL17-8 AND IS LIMITED IN HEIGHT TO THE LEVEL &\OR INCLINED PLANES THAT DEFINE THE LOWER STRATUM LIMIT OF THE LOT ABOVE PT 1 AS SHOWN ON THE PLANS, PLANES THAT DEFINE THE LOWER STRATUM LIMIT OF THE LOT ABOVE PT 1 AS SHOWN ON THE PLANS. DIAGRAMS & SECTIONS NOTE GL-9: PT 2 IS LIMITED IN DEPTH TO RL18-1 AND IS LIMITED IN HEIGHT TO THE LEVEL &\OR INCLINED PLANES THAT DEFINE THE LOWER STRATUM LIMIT OF THE LOT ABOVE PT 2 AS SHOWN ON THE PLANS. LIMITED IN HEIGHT TO THE LEVEL &\OR INCLINED PLANES THAT DEFINE THE LOWER STRATUM LIMIT OF DIAGRAMS & SECTIONS. NOTE GL-10: PT 1 IS LIMITED IN DEPTH TO RU18-2 AND IS LIMITED IN HEIGHT TO THE LEVEL & OR INCLINED PLANES THAT DEFINE THE LOWER STRATUM LIMIT OF THE LOT ABOVE PT 1 AS SHOWN ON THE PLANS, LIMITED IN HEIGHT TO THE INCLINED PLANES THAT DEFINE THE LOWER STRATUM LIMIT OF LOT 2 DEFINED DIAGRAMS & SECTIONS NOTE GL-11: PT 1 IS LIMITED IN DEPTH TO RL18-5 AND IS LIMITED IN HEIGHT TO THE LEVEL & VOR INCLINED PLANES THAT DEFINE THE LOWER STRATUM LIMIT OF THE LOT ABOVE PT 1 AS SHOWN ON THE PLANS. DIAGRAMS & SECTIONS. NOTES GL-12 & GL-13: PT 1 IS LIMITED IN DEPTH TO RL17-0 AND IS LIMITED IN HEIGHT TO THE LEVEL &\OR INCLINED PLANES THAT DEFINE THE LOWER STRATUM LIMIT OF LIMITED IN HEIGHT TO THE LEVEL &\OR INCLINED PLANES THAT DEFINE THE LOWER STRATUM LIMIT OF THE LOT ABOVE PT 1 AS SHOWN ON THE PLANS, THE LOT OR ROAD WIDENING ABOVE PT 2 AS SHOWN DIAGRAMS & SECTIONS NOTE GL-14: PT 1 IS LIMITED IN DEPTH TO RL17.6 AND IS LIMITED IN HEIGHT TO THE LEVEL &\OR INCLINED THE LOT ABOVE PT 1 AS SHOWN ON THE PLANS, DIAGRAMS & SECTIONS. PLANES THAT DEFINE THE LOWER STRATUM LIMIT OF NOTE GL-28: THE LOT ABOVE PT 1 AS SHOWN ON THE PLANS, LIMITED IN HEIGHT TO THE LEVEL & OR INCLINED PLANES THAT DEFINE THE LOWER STRATUM LIMIT OF PT 1 IS LIMITED IN DEPTH TO RI 17-45 AND IS DIAGRAMS & SECTIONS. LIMITED IN HEIGHT TO THE LEVEL &\OR INCLINED PLANES THAT DEFINE THE LOWER STRATUM LIMIT OF NOTE GL-15: PT 1 IS LIMITED IN DEPTH TO RL16-65 AND IS LIMITED IN HEIGHT TO THE LEVEL &\OR INCLINED THE LOT ABOVE PT 1 AS SHOWN ON THE PLANS DIAGRAMS & SECTIONS. PLANES THAT DEFINE THE LOWER STRATUM LIMIT OF THE LOT ABOVE PT 1 AS SHOWN ON THE PLANS, DIAGRAMS & SECTIONS Surveyor: Wayne Allen Diver-Tuck Date of Survey: 21/05/2018 Surveyor's Ref: 124821-DWHY-STRATU

STRATUM NOTES

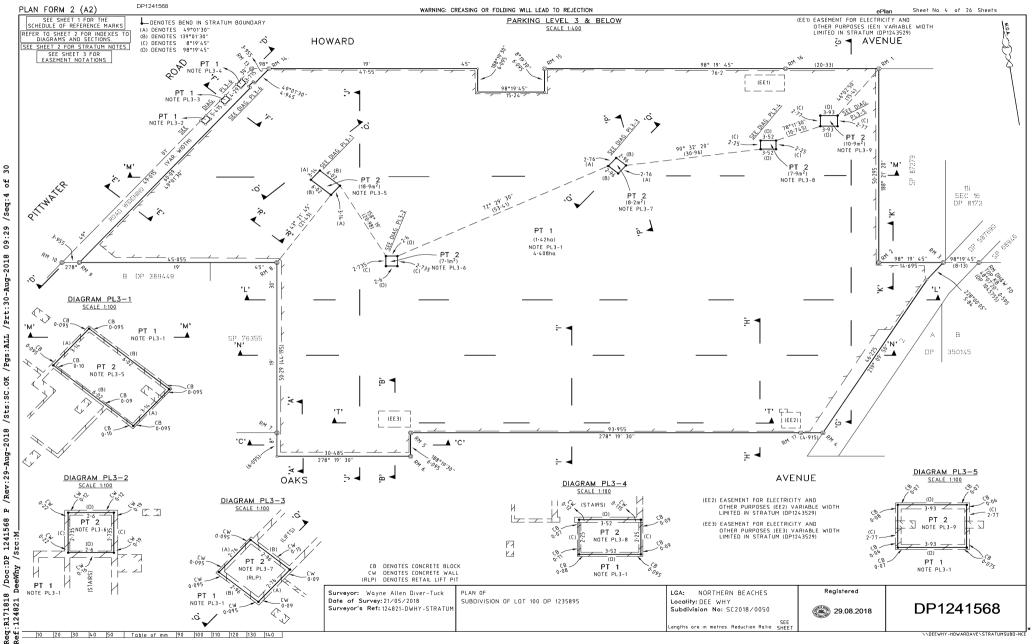
NOTE GL-16: PT 1 IS LIMITED IN DEPTH TO RL17-65 AND IS NOTE GL-29: PT 2 IS LIMITED IN DEPTH TO LIMITED IN HEIGHT TO THE LEVEL & OR INCLINED PLANES THAT DEFINE THE LOWER STRATUM LIMIT OF LIMITED IN HEIGHT TO THE LEV PLANES THAT DEFINE THE LOW THE LOT ABOVE PT 1 AS SHOWN ON THE PLANS THE LOT ABOVE DT 2 AS SHO DIAGRAMS & SECTIONS. DIAGRAMS & SECTIONS. NOTE GL-30: NOTE GL-17: NULE UL-17: PT 1 IS LIMITED IN DEPTH TO RL17-2 AND IS LIMITED IN HEIGHT TO THE LEVEL &\OR INCLINED PLANES THAT DEFINE THE LOWER STRATUM LIMIT OF THE LOT ABOVE PT 1 AS SHOWN ON THE PLANS, PT 1 IS LIMITED IN DEPTH TO F LIMITED IN HEIGHT TO THE LEVI PLANES THAT DEFINE THE LOW THE LOT ABOVE PT 1 AS SHOW DIAGRAMS & SECTIONS. DIAGRAMS & SECTIONS NOTE GL-18: PT 1 IS LIMITED IN DEPTH TO RL17.5 AND IS NOTE GL-31: PT 1 IS LIMITED IN DEPTH TO LIMITED IN HEIGHT TO THE LEVEL & OR INCLINED PLANES THAT DEFINE THE LOWER STRATUM LIMIT OF LIMITED IN HEIGHT TO THE LEV PLANES THAT DEFINE THE LOW THE LOT ABOVE PT 1 AS SHOWN ON THE PLANS THE LOT ABOVE BT 1 AS SHOT DIAGRAMS & SECTIONS. DIAGRAMS & SECTIONS NOTE GL-19: NOTE GL - 32: PT 1 IS LIMITED IN DEPTH TO BUIG-4 AND IS PT 1 IS LIMITED IN DEPTH TO I LIMITED IN HEIGHT TO THE LEV LIMITED IN HEIGHT TO THE LEVEL & OR INCLINED PLANES THAT DEFINE THE LOWER STRATUM LIMIT OF PLANES THAT DEFINE THE LOW THE LOT ABOVE PT I AS SHOWN ON THE PLANS, DIAGRAMS & SECTIONS. THE LOT ABOVE PT 1 AS SHOW DIAGRAMS & SECTIONS NOTE GL-20: PT 2 IS LIMITED IN DEPTH TO RL16-4 AND IS LIMITED IN HEIGHT TO THE LEVEL &\OR INCLINED <u>NOTE GL-33:</u> PT 2 IS LIMITED IN DEPTH TO F LIMITED IN HEIGHT TO THE LEVE PLANES THAT DEFINE THE LOWER STRATUM LIMIT OF THE LOT ABOVE PT 2 AS SHOWN ON THE PLANS. PLANES THAT DEFINE THE LOW THE LOT ABOVE PT 2 AS SHOW DIAGRAMS & SECTIONS. DIAGRAMS & SECTIONS. NOTE GL-21: NOTE GL-34: PT 2 IS LIMITED IN DEPTH TO RL14-9 AND IS PT 1 IS LIMITED IN DEPTH TO LIMITED IN HEIGHT TO THE LEVEL & OR INCLINED PLANES THAT DEFINE THE LOWER STRATUM LIMIT OF LIMITED IN HEIGHT TO THE LEVI PLANES THAT DEFINE THE LOW THE LOT ABOVE PT 2 AS SHOWN ON THE PLANS, THE LOT ABOVE PT 1 AS SHOW DIAGRAMS & SECTIONS. DIAGRAMS & SECTIONS NOTE GL-22: NOTE GL-35: PT 2 IS LIMITED IN DEPTH TO P LIMITED IN HEIGHT TO THE LEVI PT 2 IS LIMITED IN DEPTH TO RL16-05 AND IS LIMITED IN HEIGHT TO THE LEVEL &\OR INCLINED PLANES THAT DEFINE THE LOWER STRATUM LIMIT OF THE LOT ABOVE PT 2 AS SHOWN ON THE PLANS, PLANES THAT DEFINE THE LOW THE LOT ABOVE PT 2 AS SHOW DIAGRAMS & SECTIONS. DIAGRAMS & SECTIONS NOTE GL-23: PT 1 IS LIMITED IN DEPTH TO RL13-85 AND IS NOTE L1-1: PT 2 IS LIMITED IN DEPTH TO LIMITED IN HEIGHT TO THE LEVEL &\OR INCLINED PLANES THAT DEFINE THE LOWER STRATUM LIMIT OF THE LOT ABOVE PT 1 AS SHOWN ON THE PLANS, LIMITED IN HEIGHT TO THE LEV PLANES THAT DEFINE THE LOW THE LOT ABOVE PT 2 AS SHO DIAGRAMS & SECTIONS DIAGRAMS & SECTIONS. NOTE GL-24: PT 2 IS LIMITED IN DEPTH TO RL13-85 AND IS NOTES L1-2 & L1-3: PT 1 IS LIMITED IN DEPTH TO F LIMITED IN HEIGHT TO THE LEVI LIMITED IN HEIGHT TO THE LEVEL & OR INCLINED PLANES THAT DEFINE THE LOWER STRATUM LIMIT OF PLANES THAT DEFINE THE LOW THE LOT ABOVE PT 2 AS SHOWN ON THE PLANS THE LOT ABOVE PT 1 AS SHOT DIAGRAMS & SECTIONS. DIAGRAMS & SECTIONS NOTE GL-25: PT 1 IS LIMITED IN DEPTH TO RL16-05 AND IS LIMITED IN HEIGHT TO THE LEVEL &\OR INCLINED NOTE L1-4: PT 2 IS LIMITED IN DEPTH TO LIMITED IN HEIGHT TO THE LEV PLANES THAT DEFINE THE LOWER STRATUM LIMIT OF THE LOT ABOVE PT 1 AS SHOWN ON THE PLANS, PLANES THAT DEFINE THE LOW THE LOT ABOVE PT 2 AS SHO DIAGRAMS & SECTIONS. DIAGRAMS & SECTIONS NOTE GL-26: NOTES L1-5, L1-6, L1-7 & L1-8 PT 2 IS LIMITED IN DEPTH TO RL17-45 AND IS LIMITED IN HEIGHT TO THE LEVEL &\OR INCLINED PT 1 IS LIMITED IN DEPTH TO LIMITED IN HEIGHT TO THE LEV PLANES THAT DEFINE THE LOW PLANES THAT DEFINE THE LOWER STRATUM LIMIT OF THE LOT ABOVE PT 2 AS SHOWN ON THE PLANS, THE LOT ABOVE PT 1 AS SHO' DIAGRAMS & SECTIONS. DIAGRAMS & SECTIONS. NOTE GL-27: PT 1 IS LIMITED IN DEPTH TO RL16-8 AND IS NOTE L1-9: PT 2 IS LIMITED IN DEPTH TO LIMITED IN HEIGHT TO THE LEVEL &\OR INCLINED PLANES THAT DEFINE THE LOWER STRATUM LIMIT OF LIMITED IN HEIGHT TO THE LEV PLANES THAT DEFINE THE LOW

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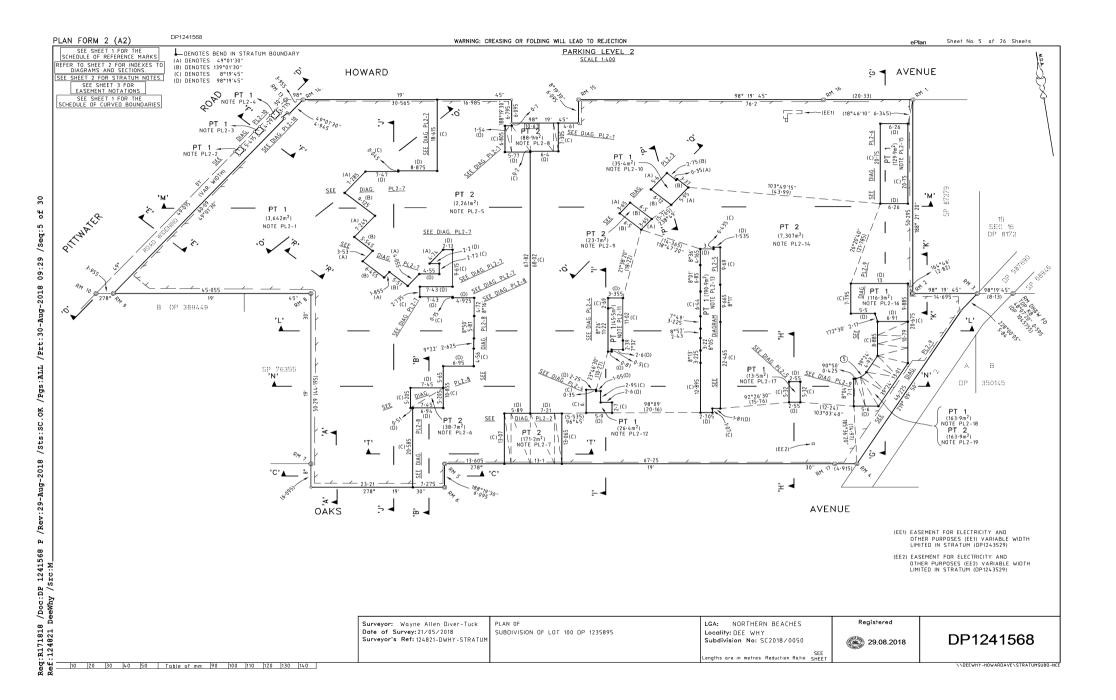
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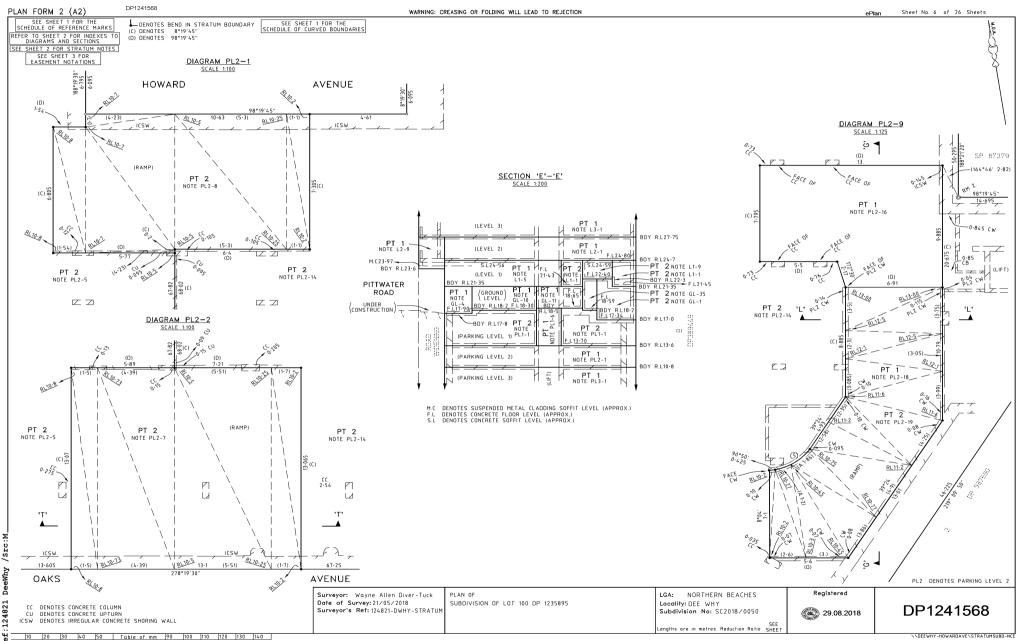


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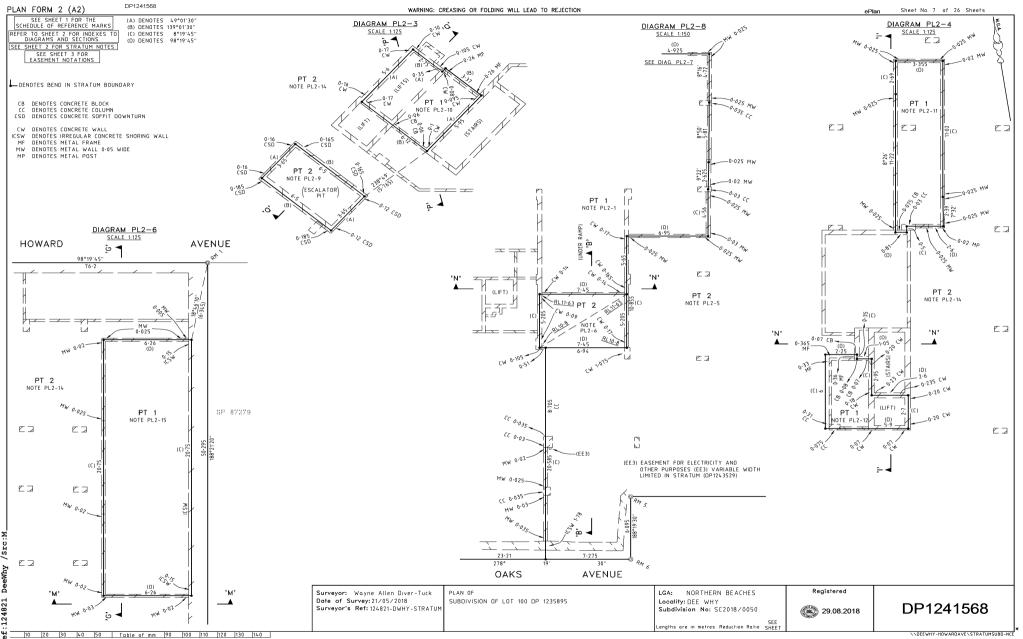
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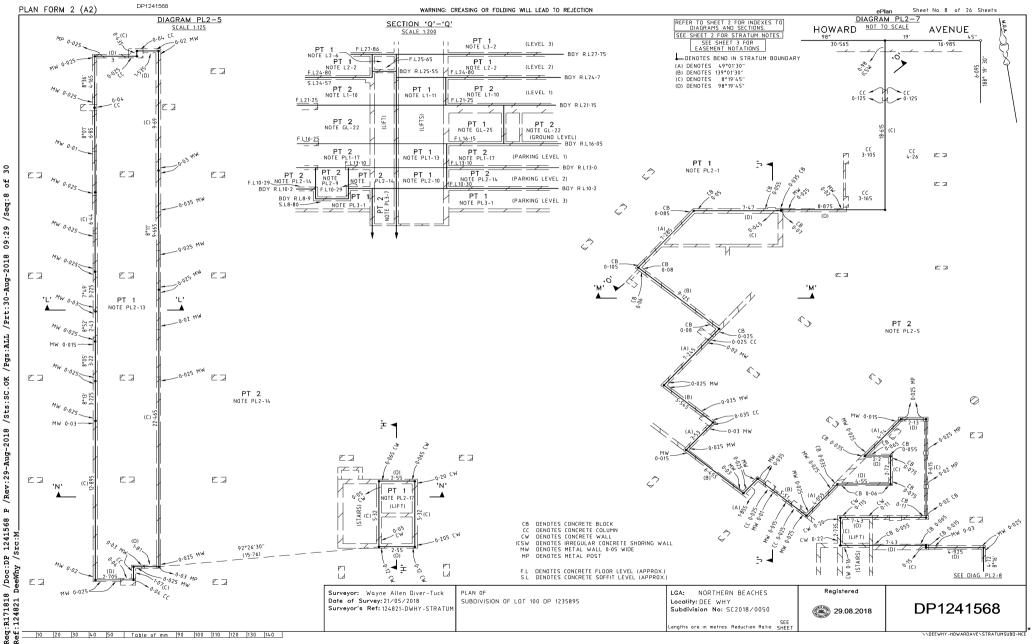




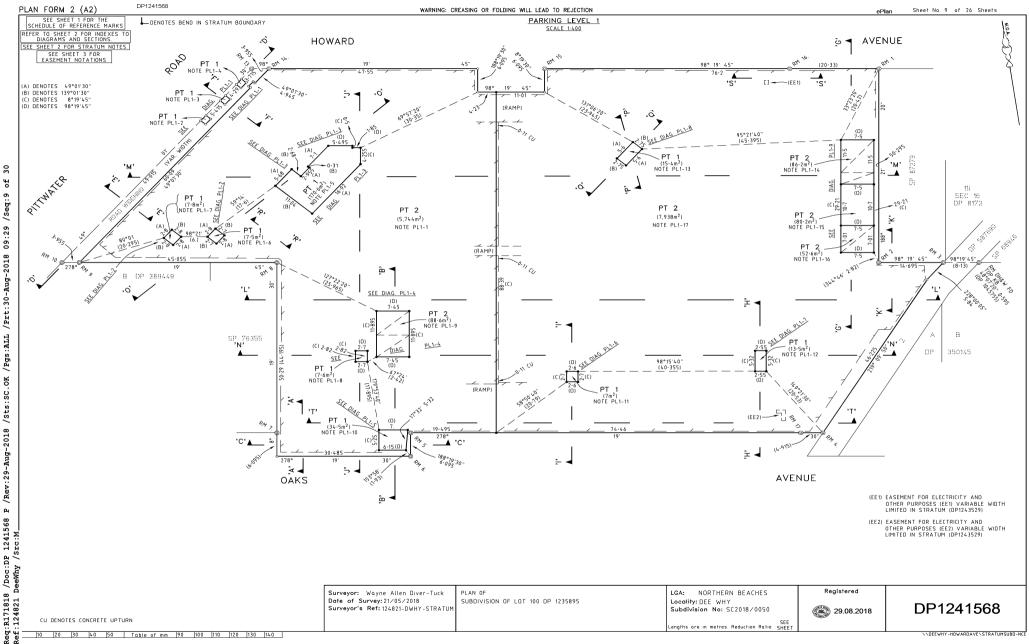
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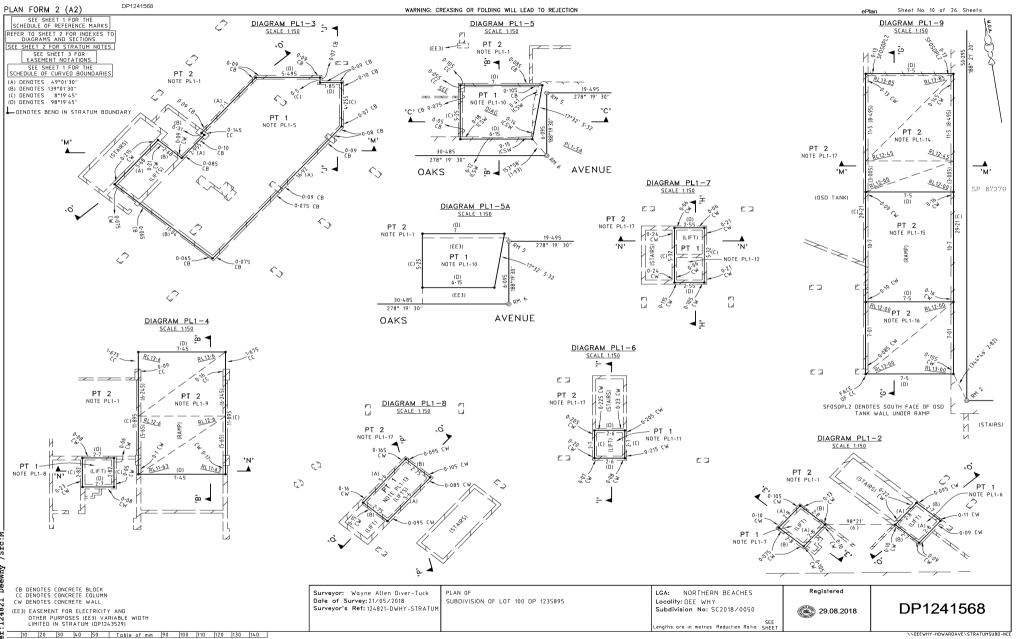




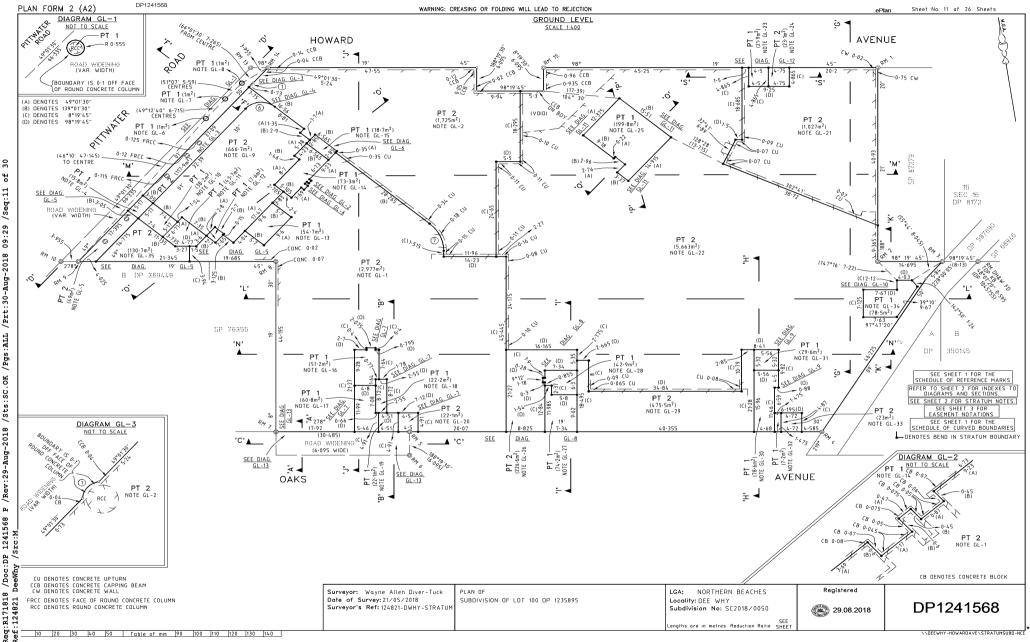
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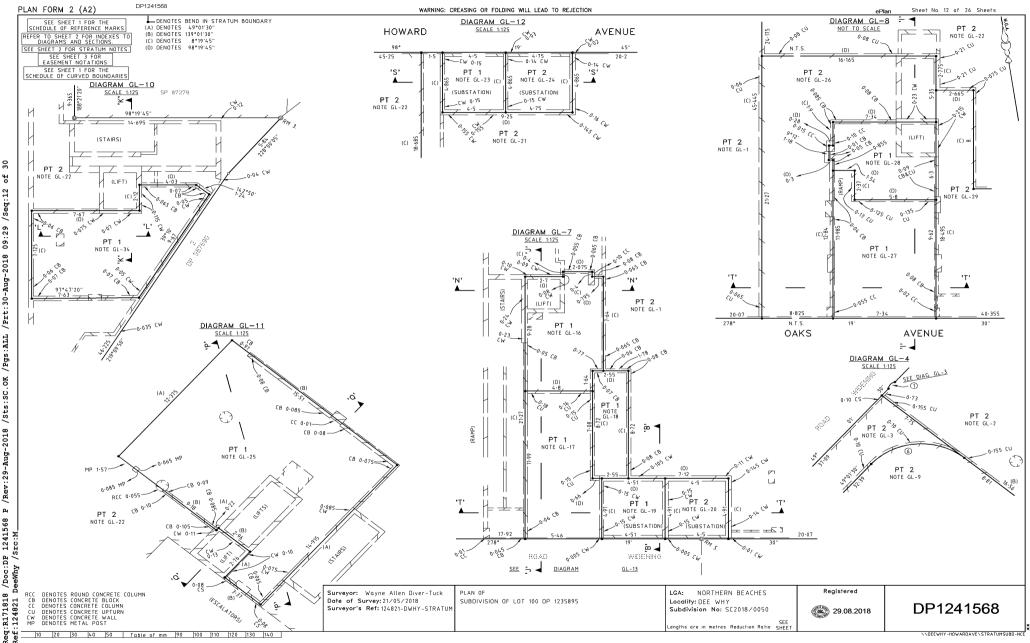
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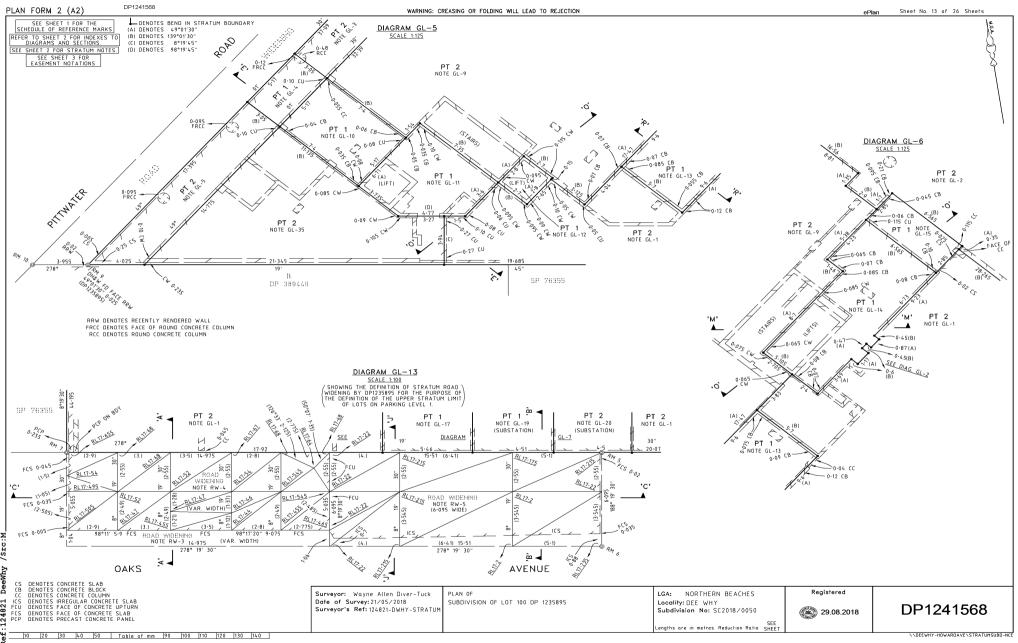
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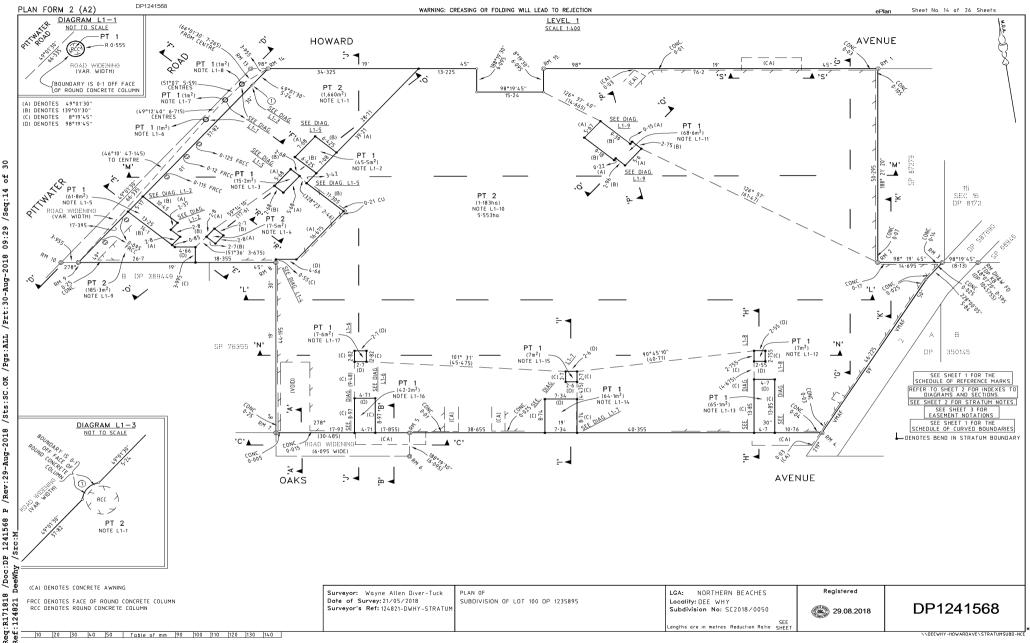
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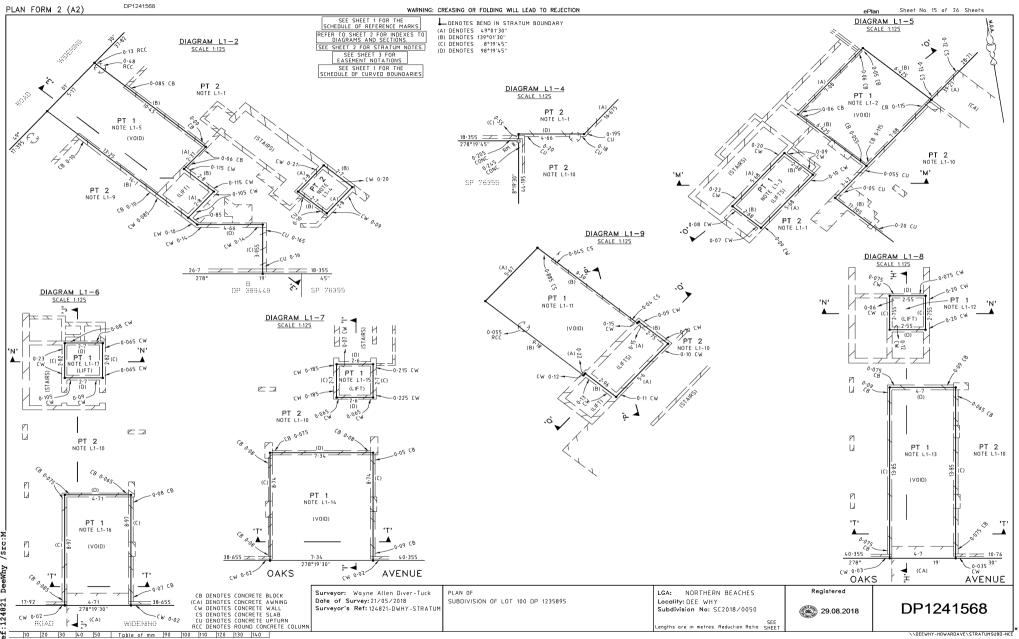
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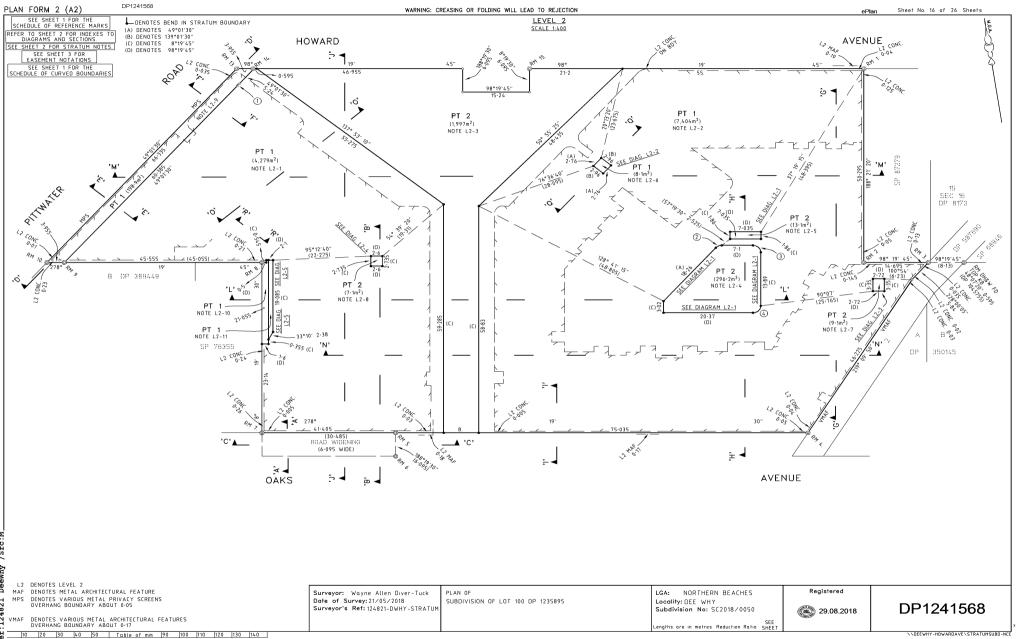
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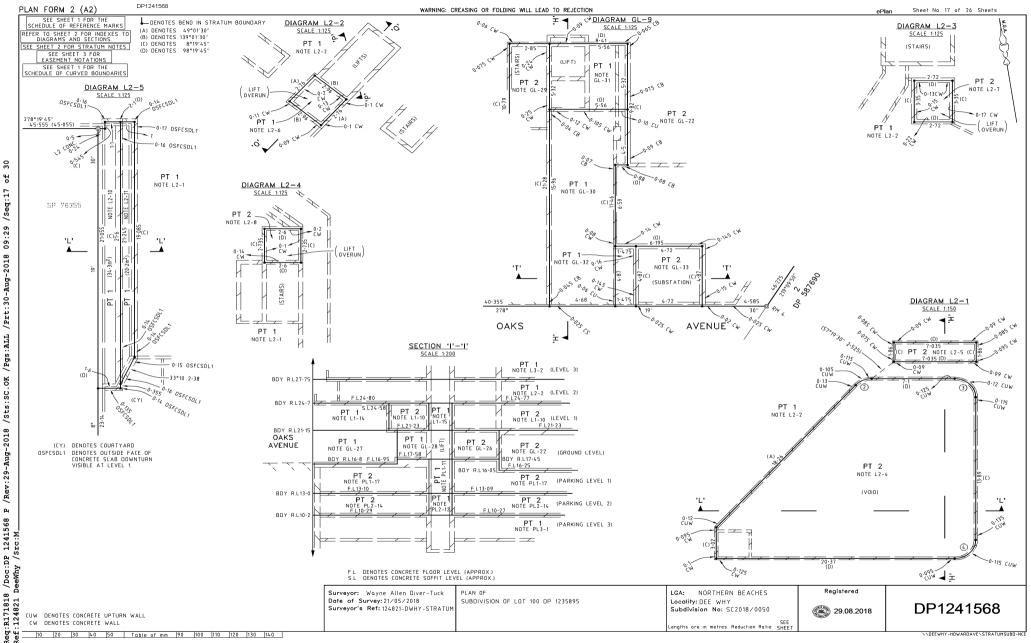
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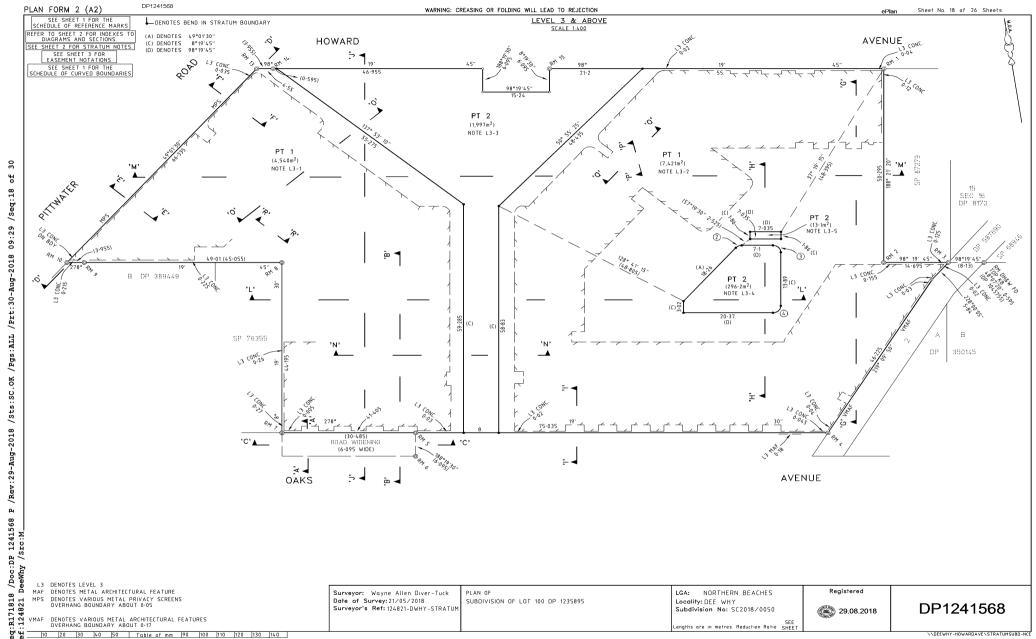


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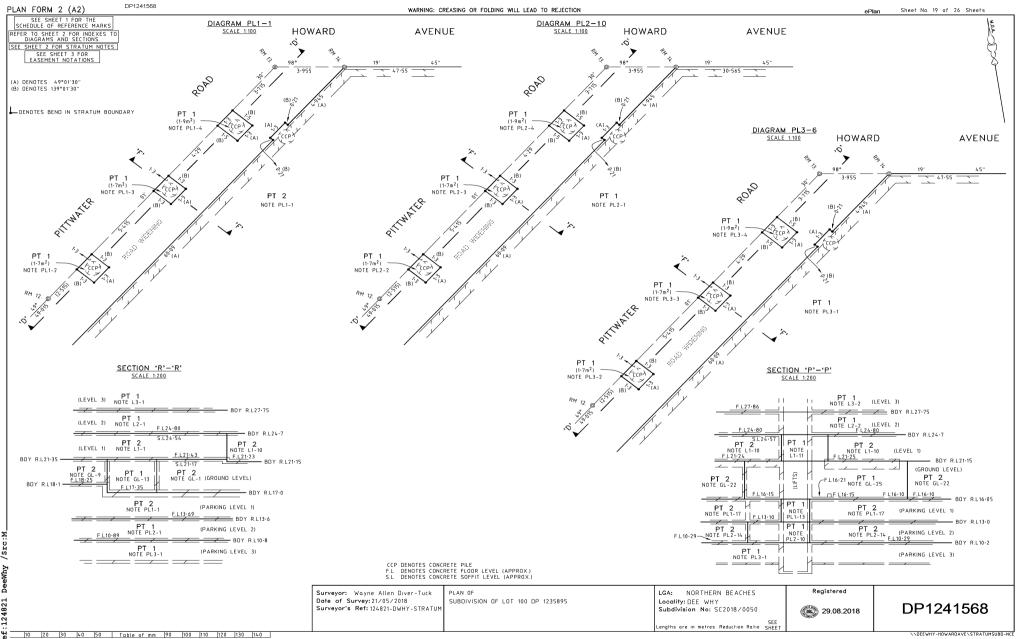


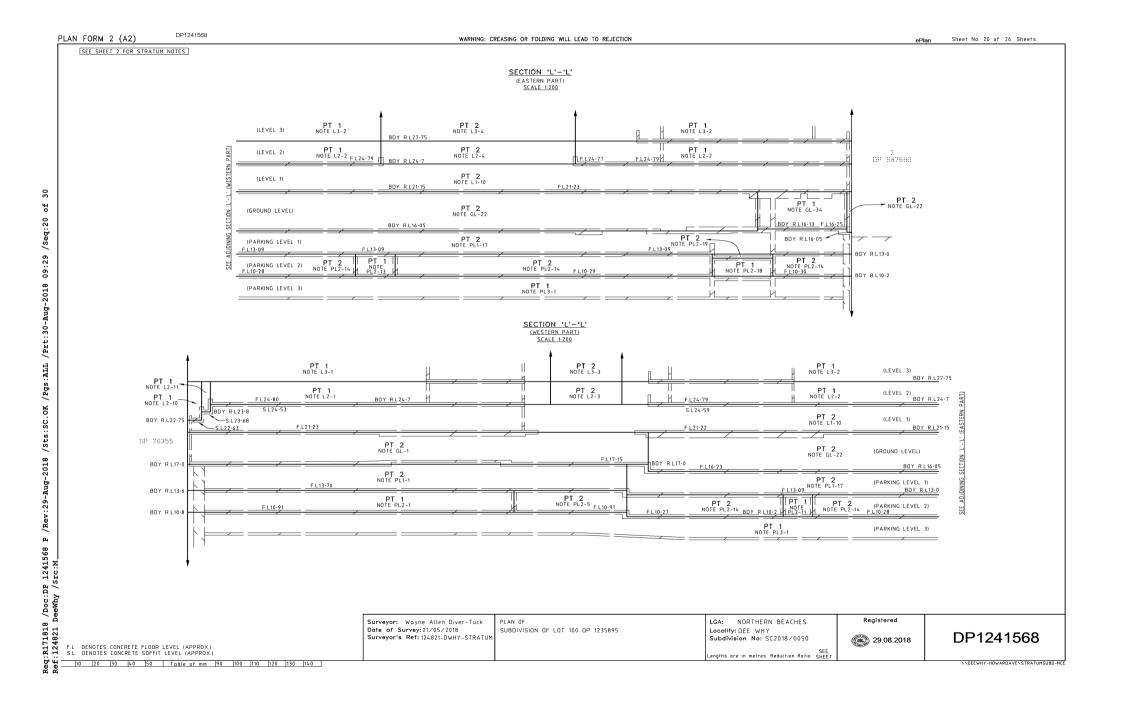
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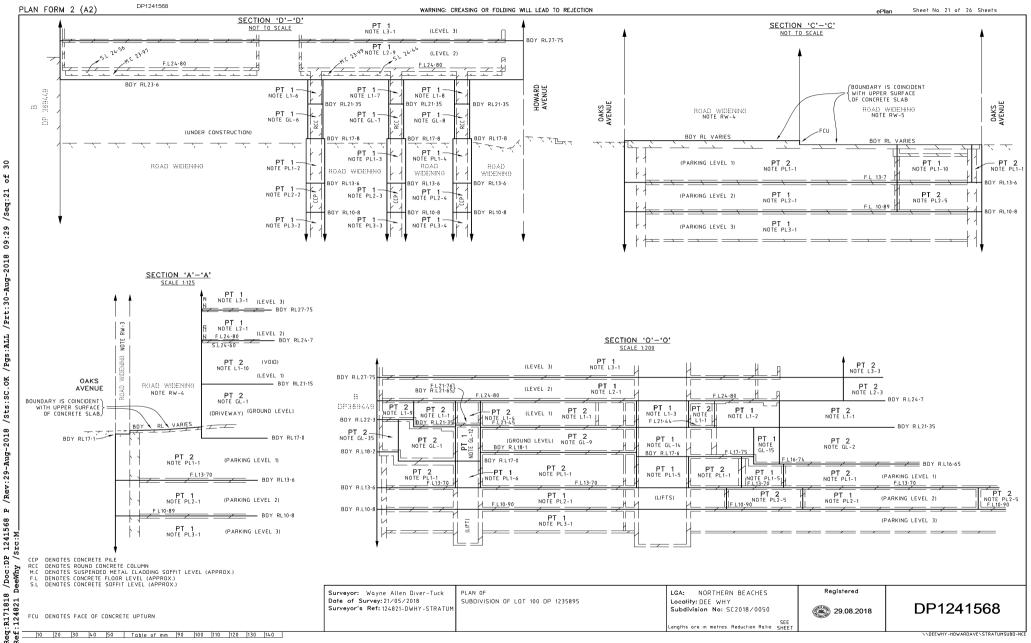
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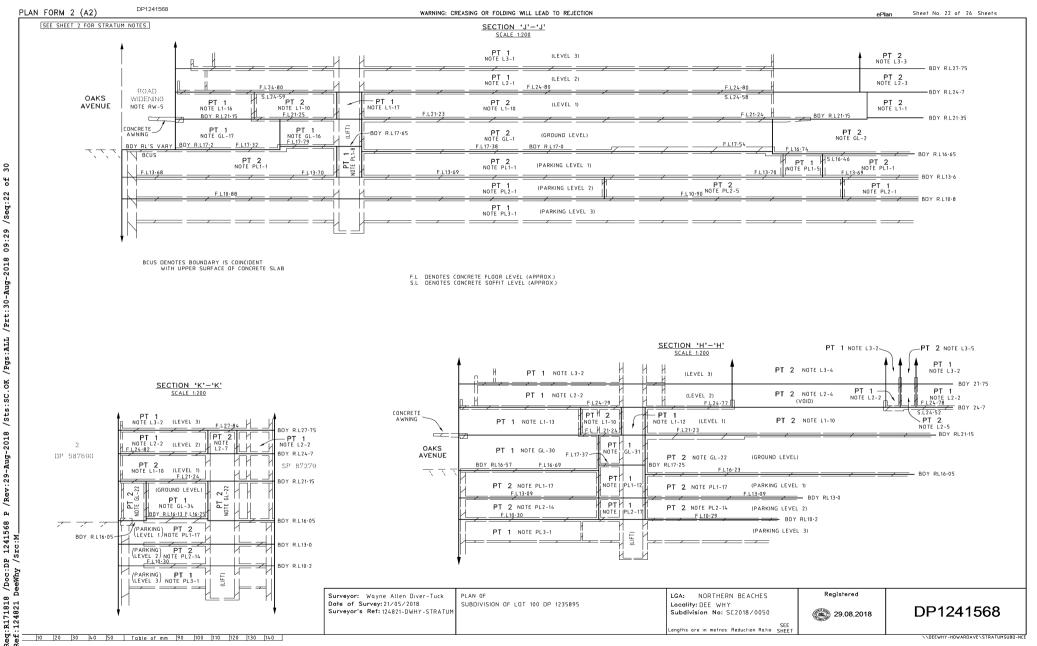


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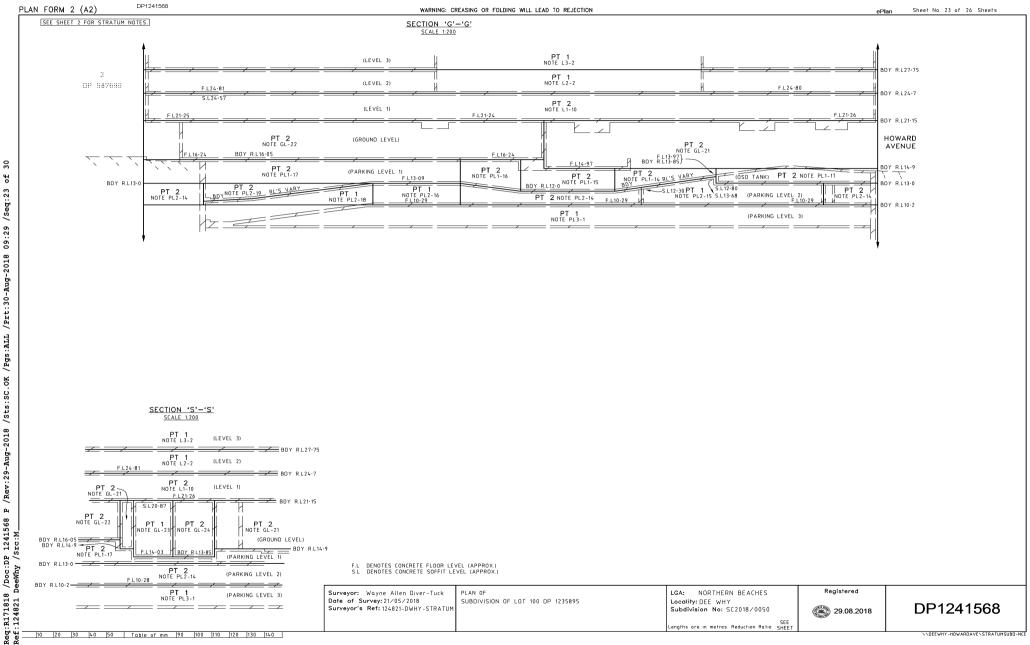




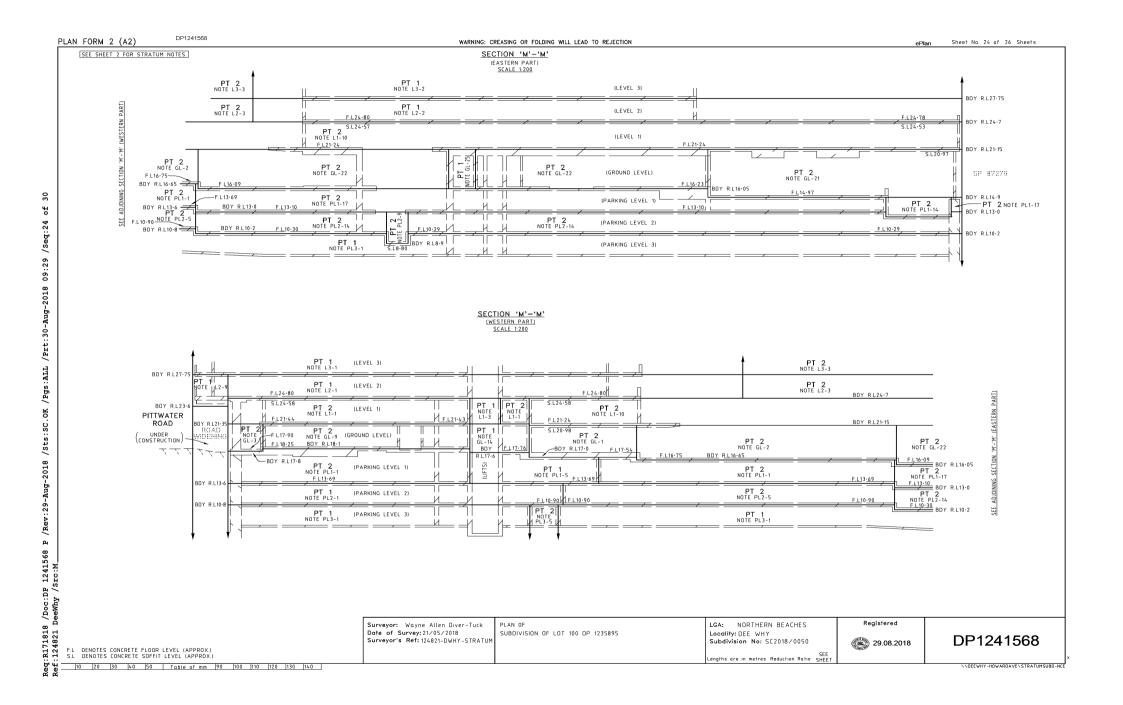


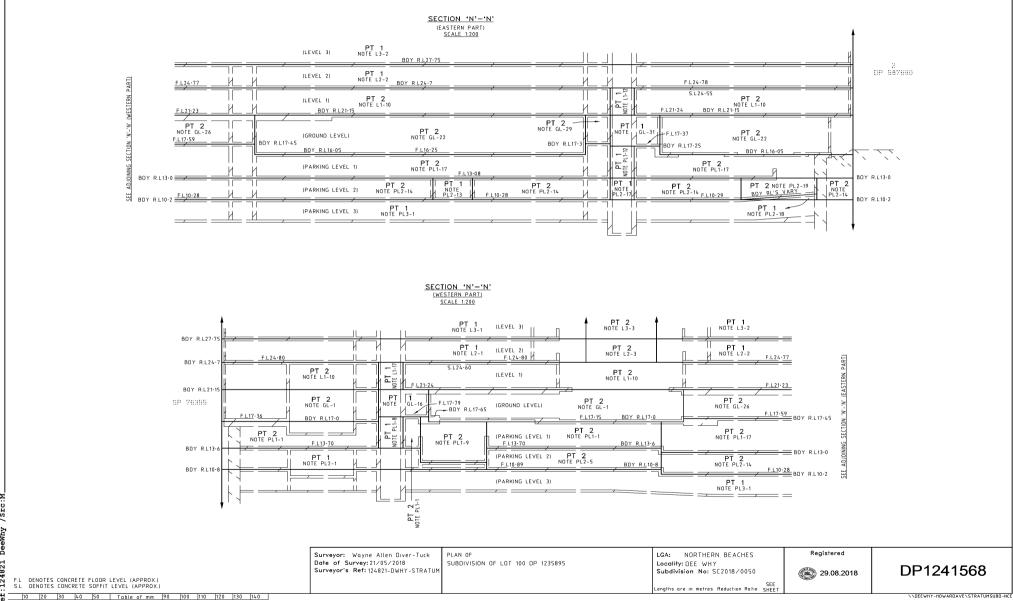


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SEE SHEET 2 FOR STRATUM NOTES.

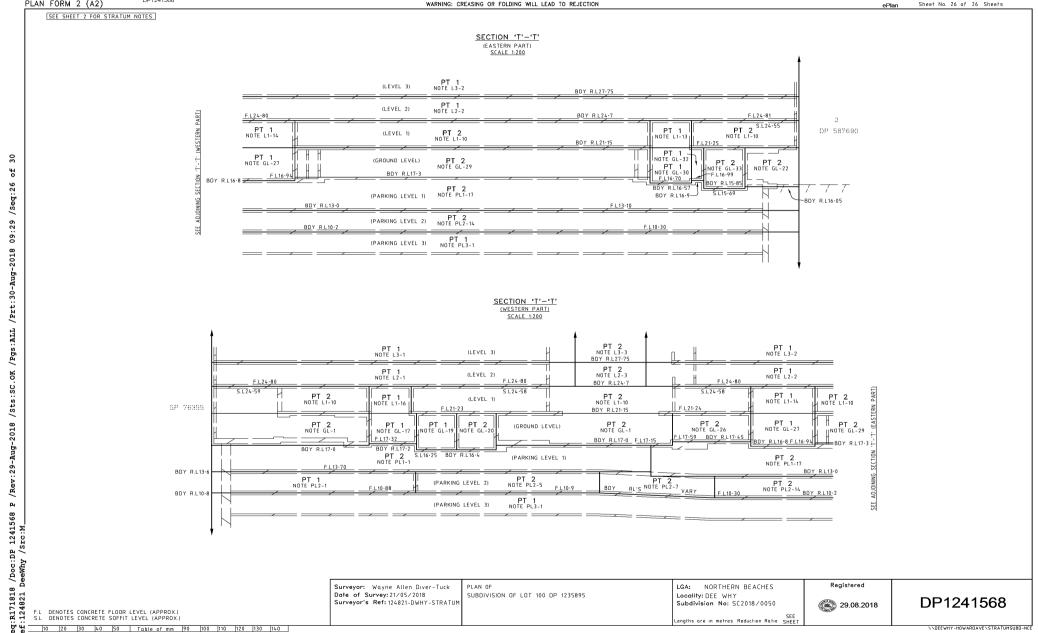
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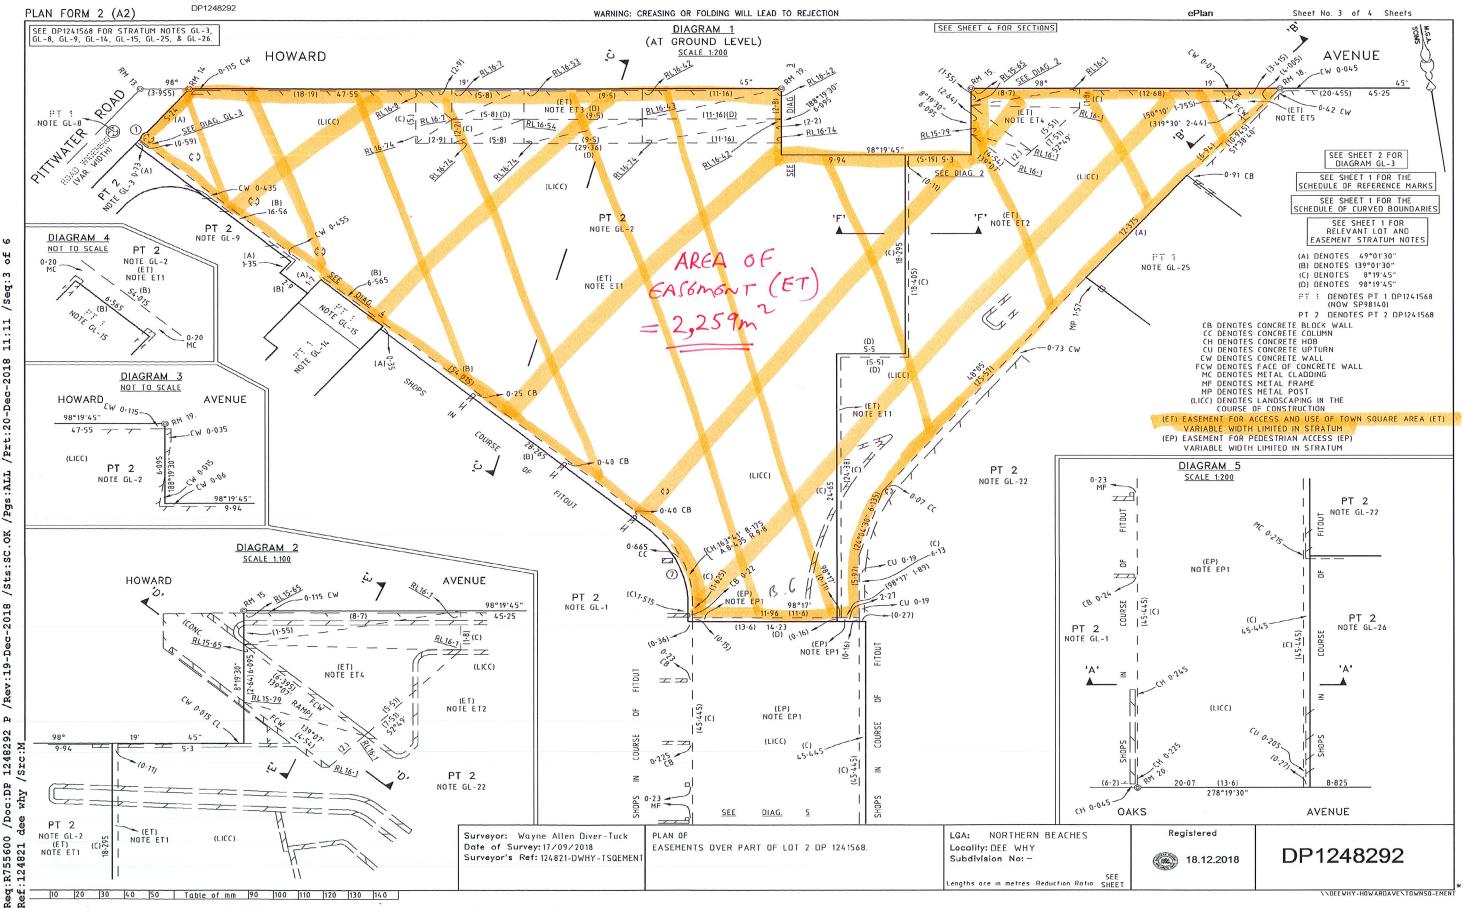
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Annexure 2: Registered Easement Plan



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