NORTH CURL CURL SURF LIFE SAVING CLUB INC.

location:

HUSTON PARADE,
NTH. GURL GURL. N.S.W. 2099
Lot 7356 D.P.1167221

building alterations section 96(2) application



LOCALITY PLAN

NORTH CURL CURL SURF LIFE SAVING CLUB



DRAWING SCHEDULE:

DA 01: COVER SHEET, LOCALITY PLAN & DRAWING SCHEDULE

DA 02: SITE, SITE ANALYSIS & LANDSCAPE PLAN

DA 03: LOWER LEVEL & CARETAKERS FLOOR PLANS & NOTES & MATERIALS LIST

DA 04: UPPER LEVEL FLOOR PLAN

DA 05: NORTH, SOUTH, EAST AND WEST ELEVATIONS

DA 06: SECTIONAL VIEWS

DA 07: ROOF PLAN


DA 08: DOOR & WINDOW SCHEDULES, GENERAL NOTES, SAFETY NOTES,


MATERIALS SPECIFICATION & COMPLIANCE WITH STANDARDS


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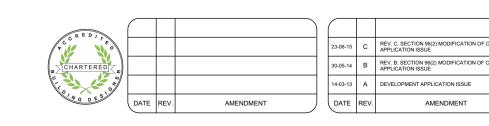




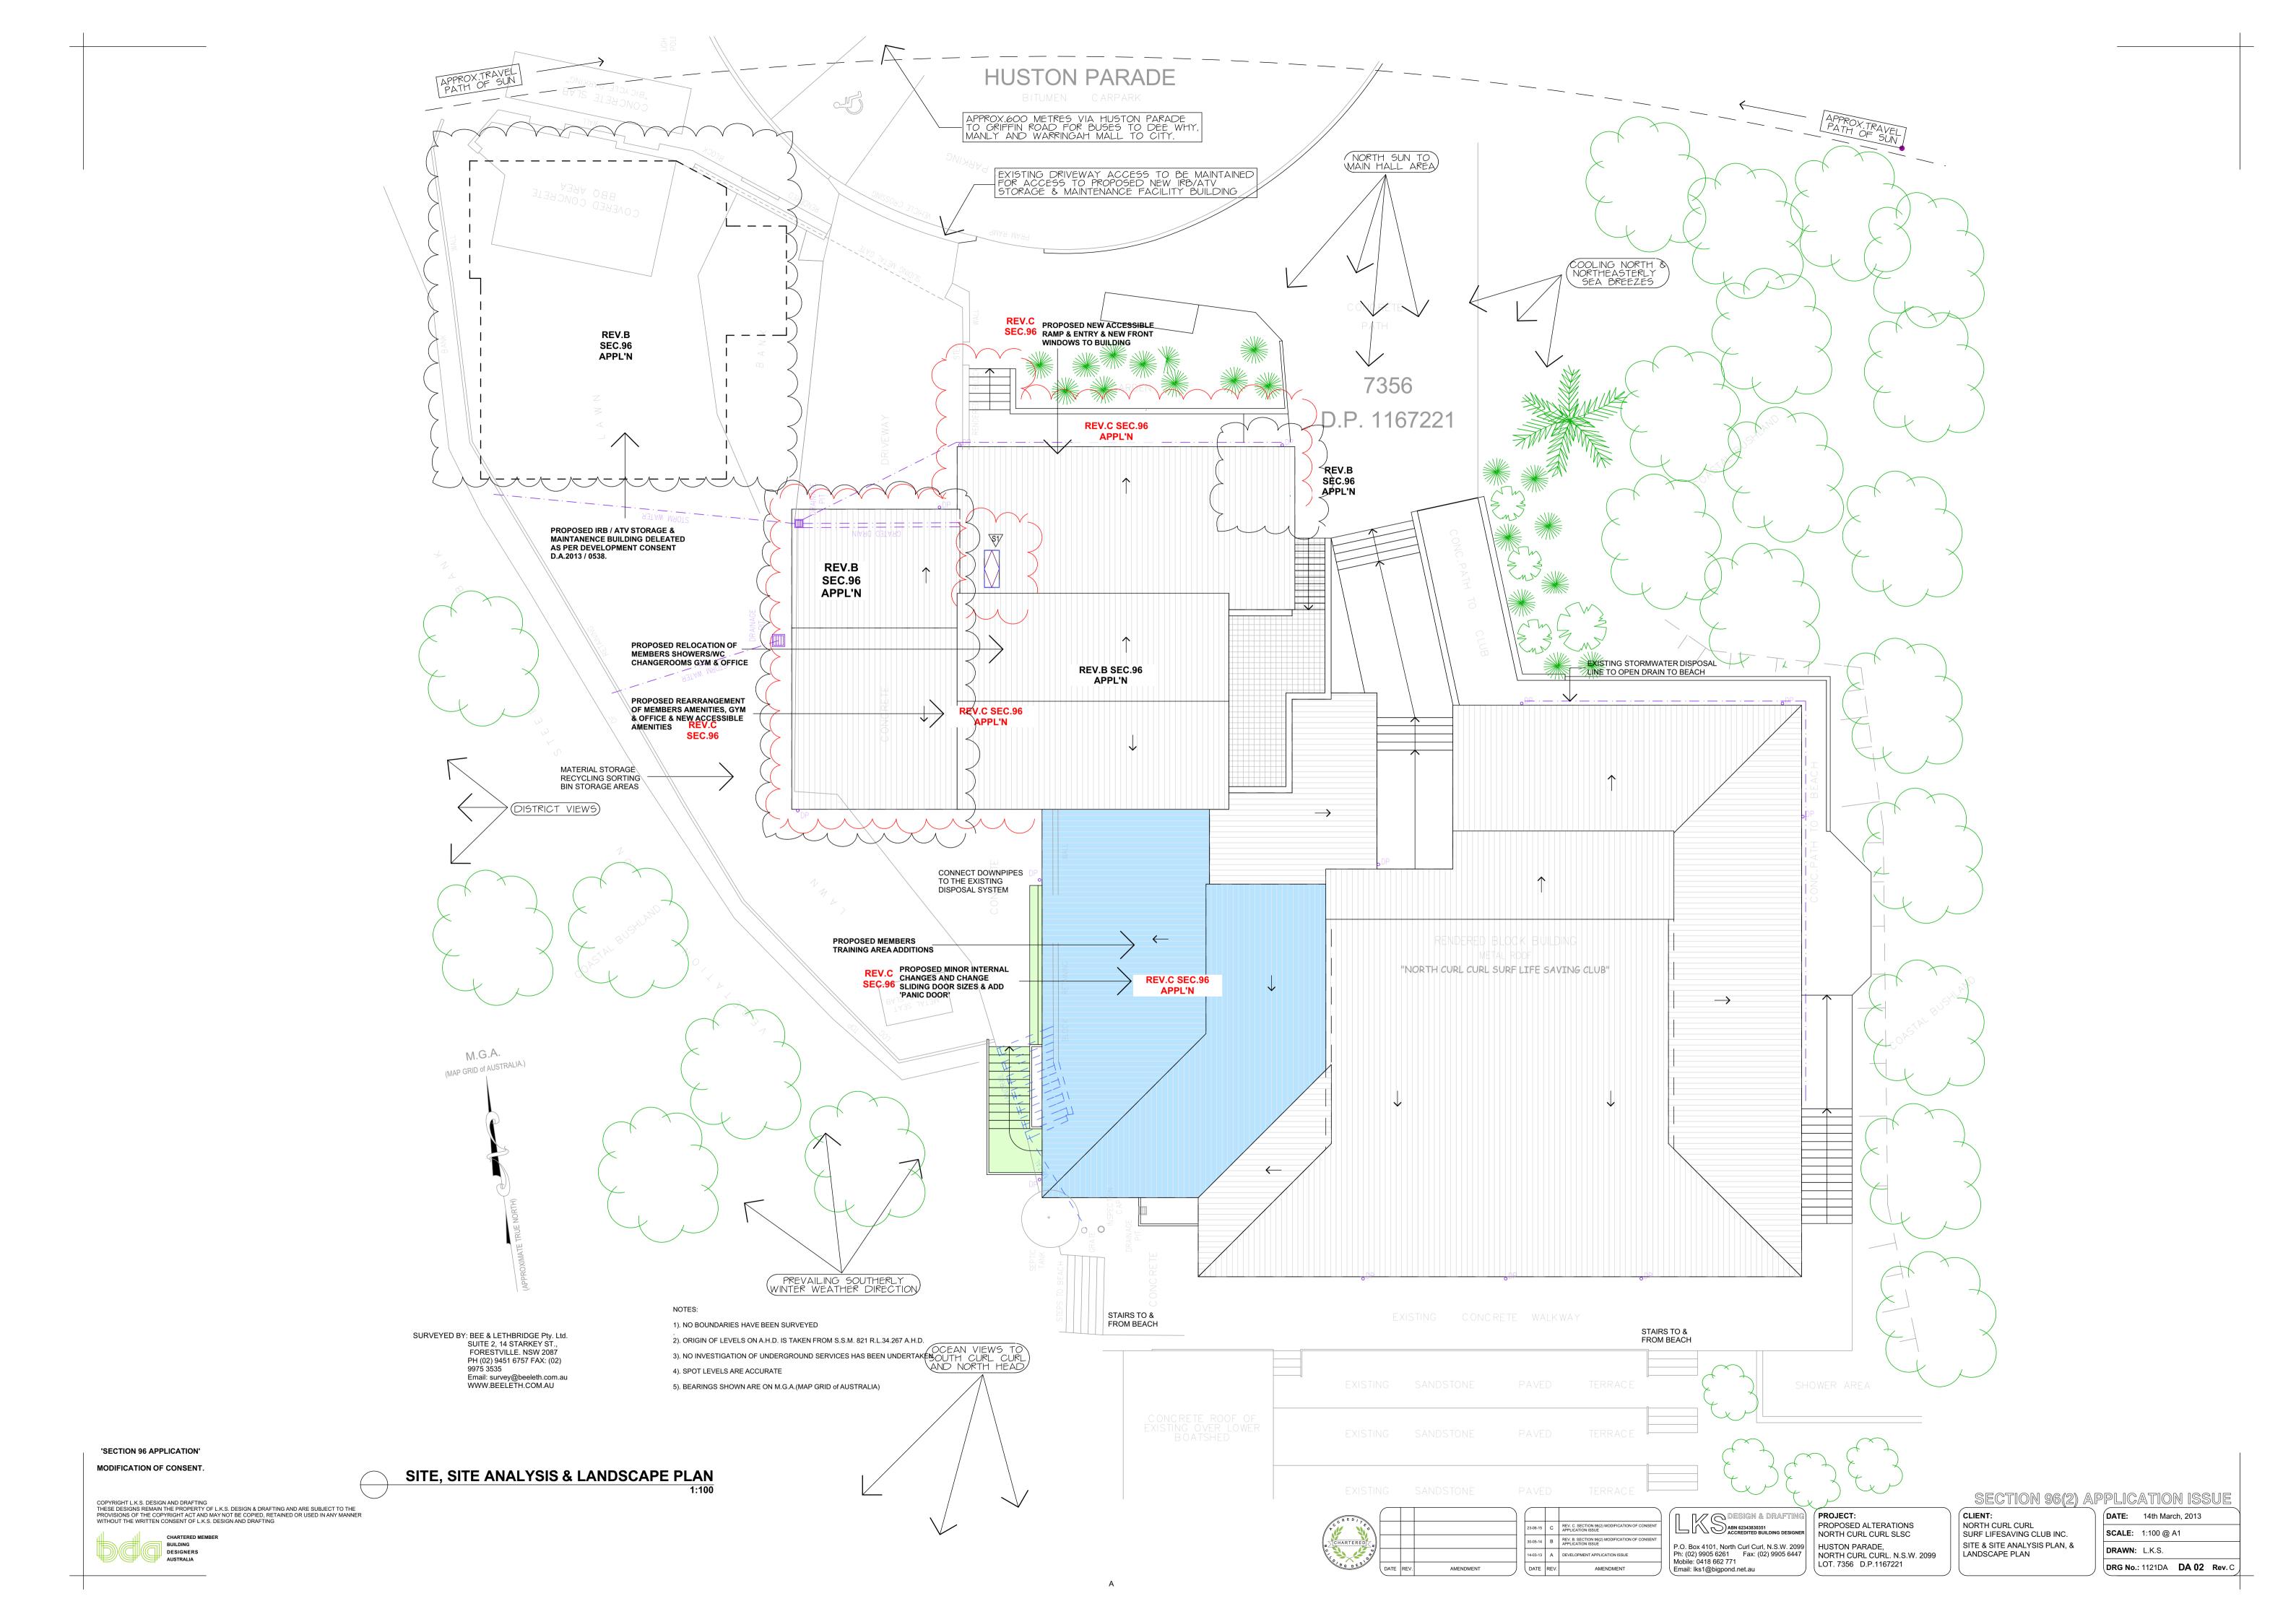

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BUILDING
DESIGNERS
AUSTRALIA

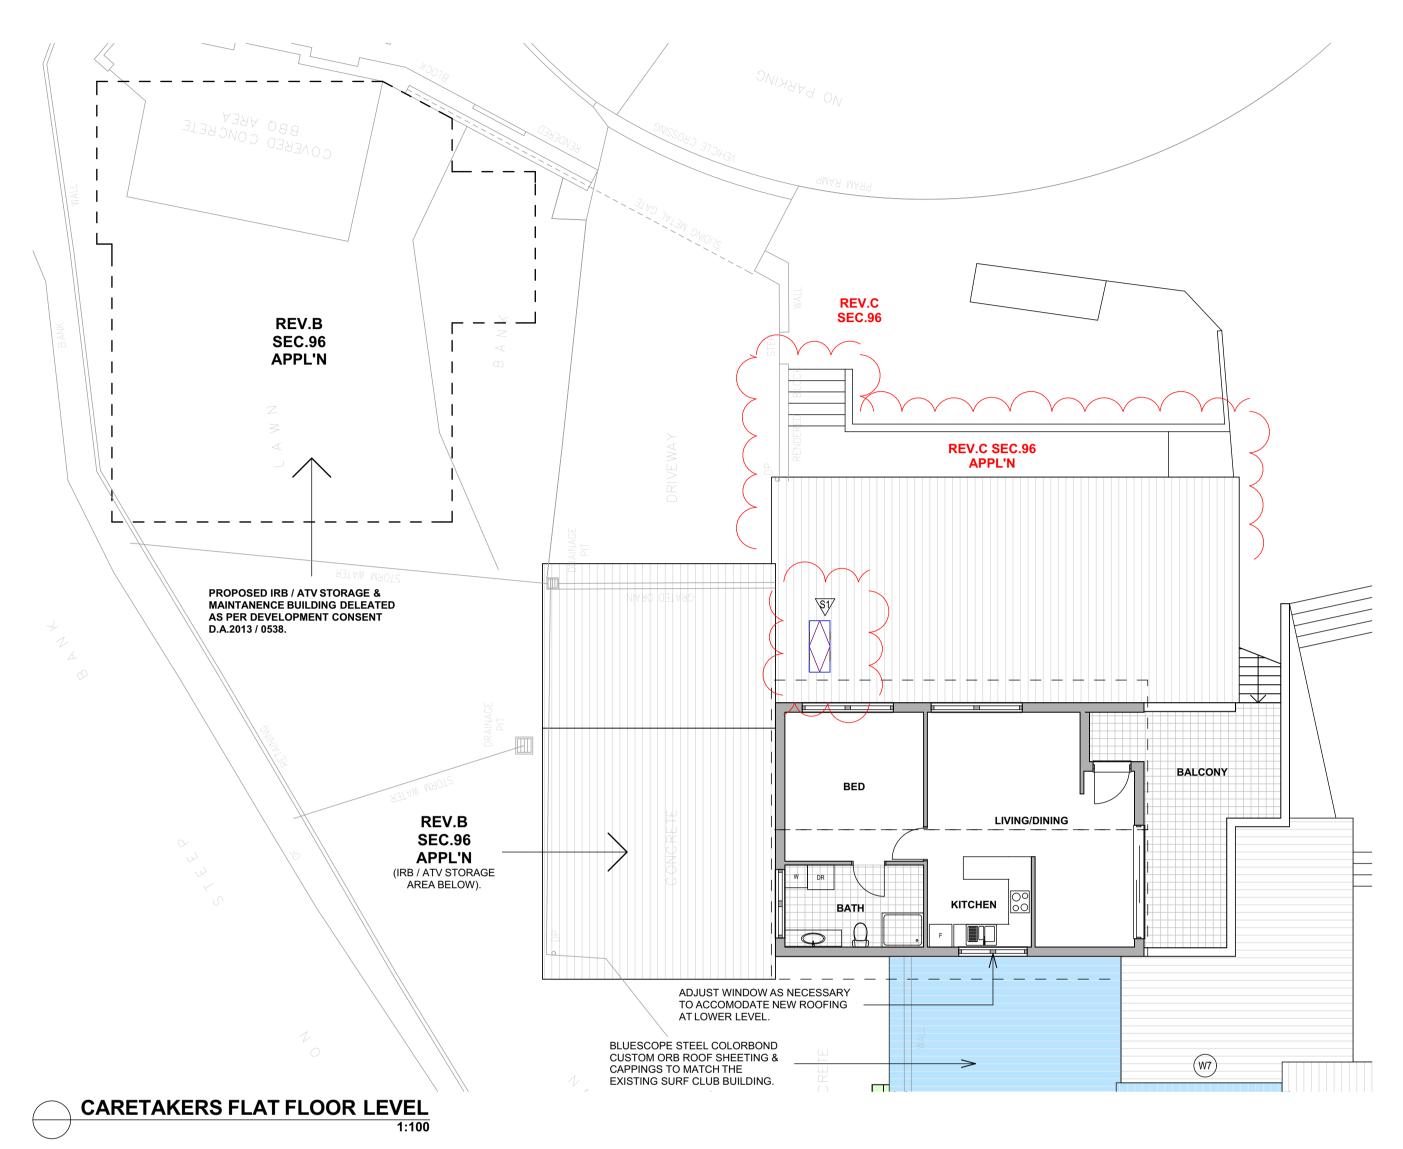LOWER FLOOR LEVEL

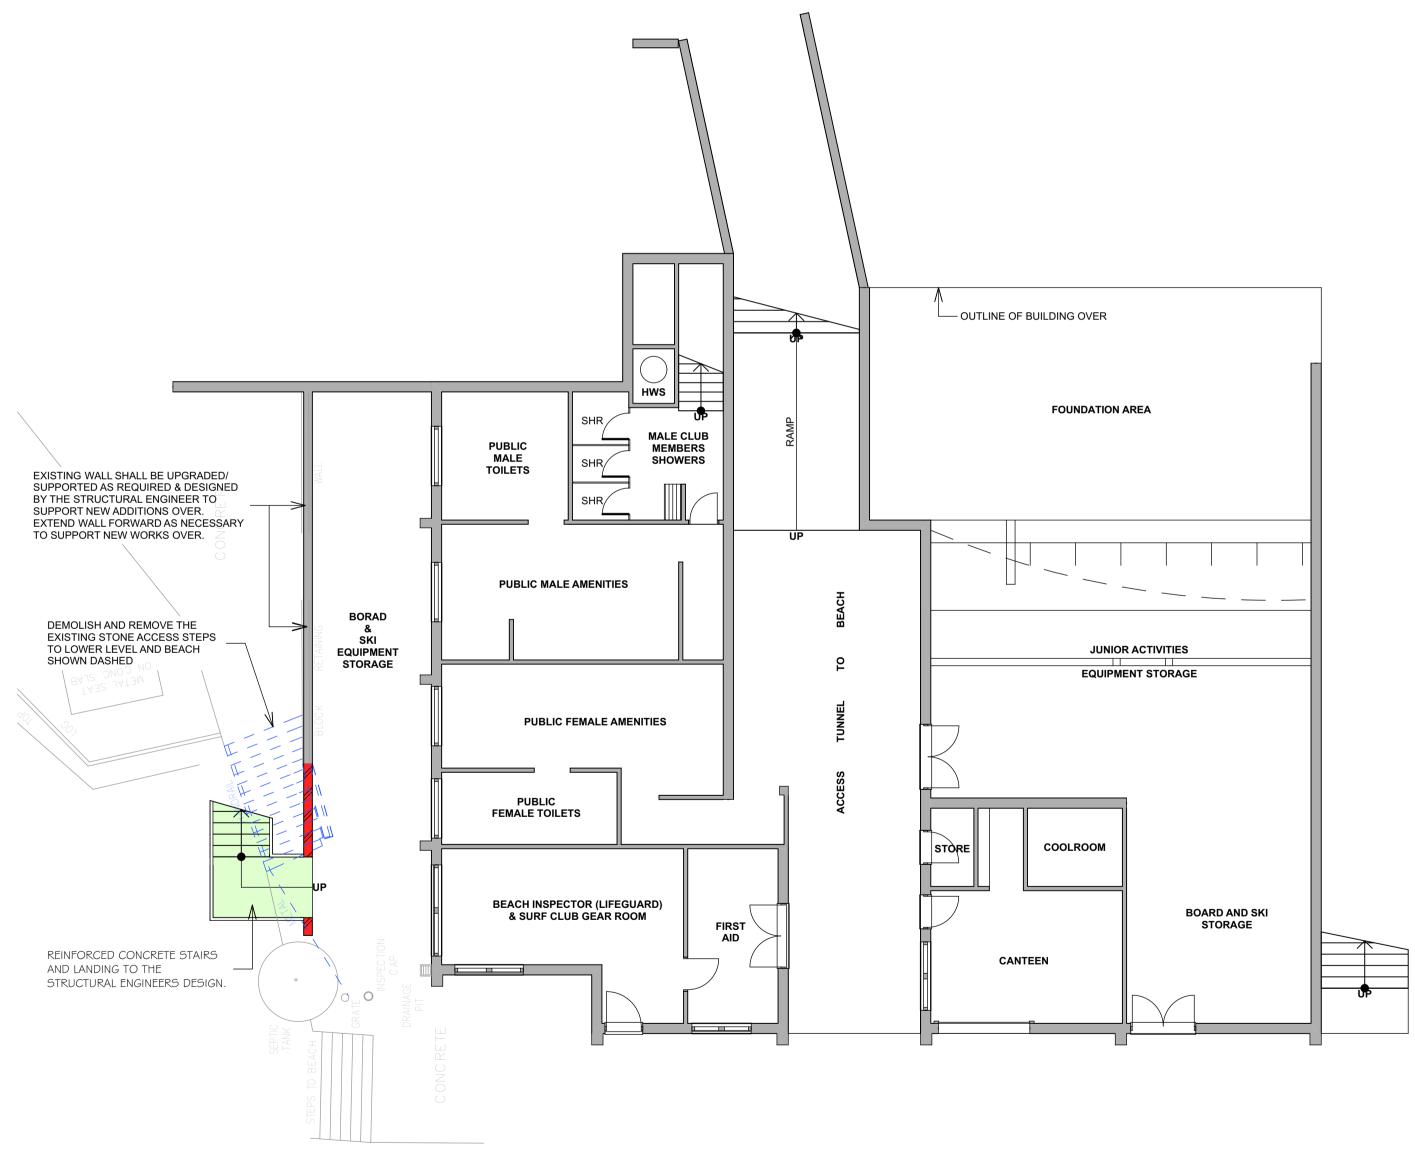


DESIGN & DRAFTING PROJECT: ABN 62343830351 ACCREDITED BUILDING DESIGNER NORTH CURL CURL SLSC P.O. Box 4101, North Curl Curl, N.S.W. 2099
Ph: (02) 9905 6261 Fax: (02) 9905 6447
Mobile: 0418 662 771
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HUSTON PARADE,
NORTH CURL CURL
LOT. 7356 D.P.1167

NORTH CURL CURL. N.S.W. 2099 LOT. 7356 D.P.1167221

SECTION 96(2) APPLICATION ISSUE CLIENT: **DATE:** 14th March, 2013 NORTH CURL CURL SURF LIFESAVING CLUB INC. SCALE: 1:100 @ A1 LOWER LEVEL & CARETAKERS DRAWN: L.K.S. FLAT FLOOR PLANS


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'SECTION 96 APPLICATION'

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BUILDING DESIGNERS AUSTRALIA

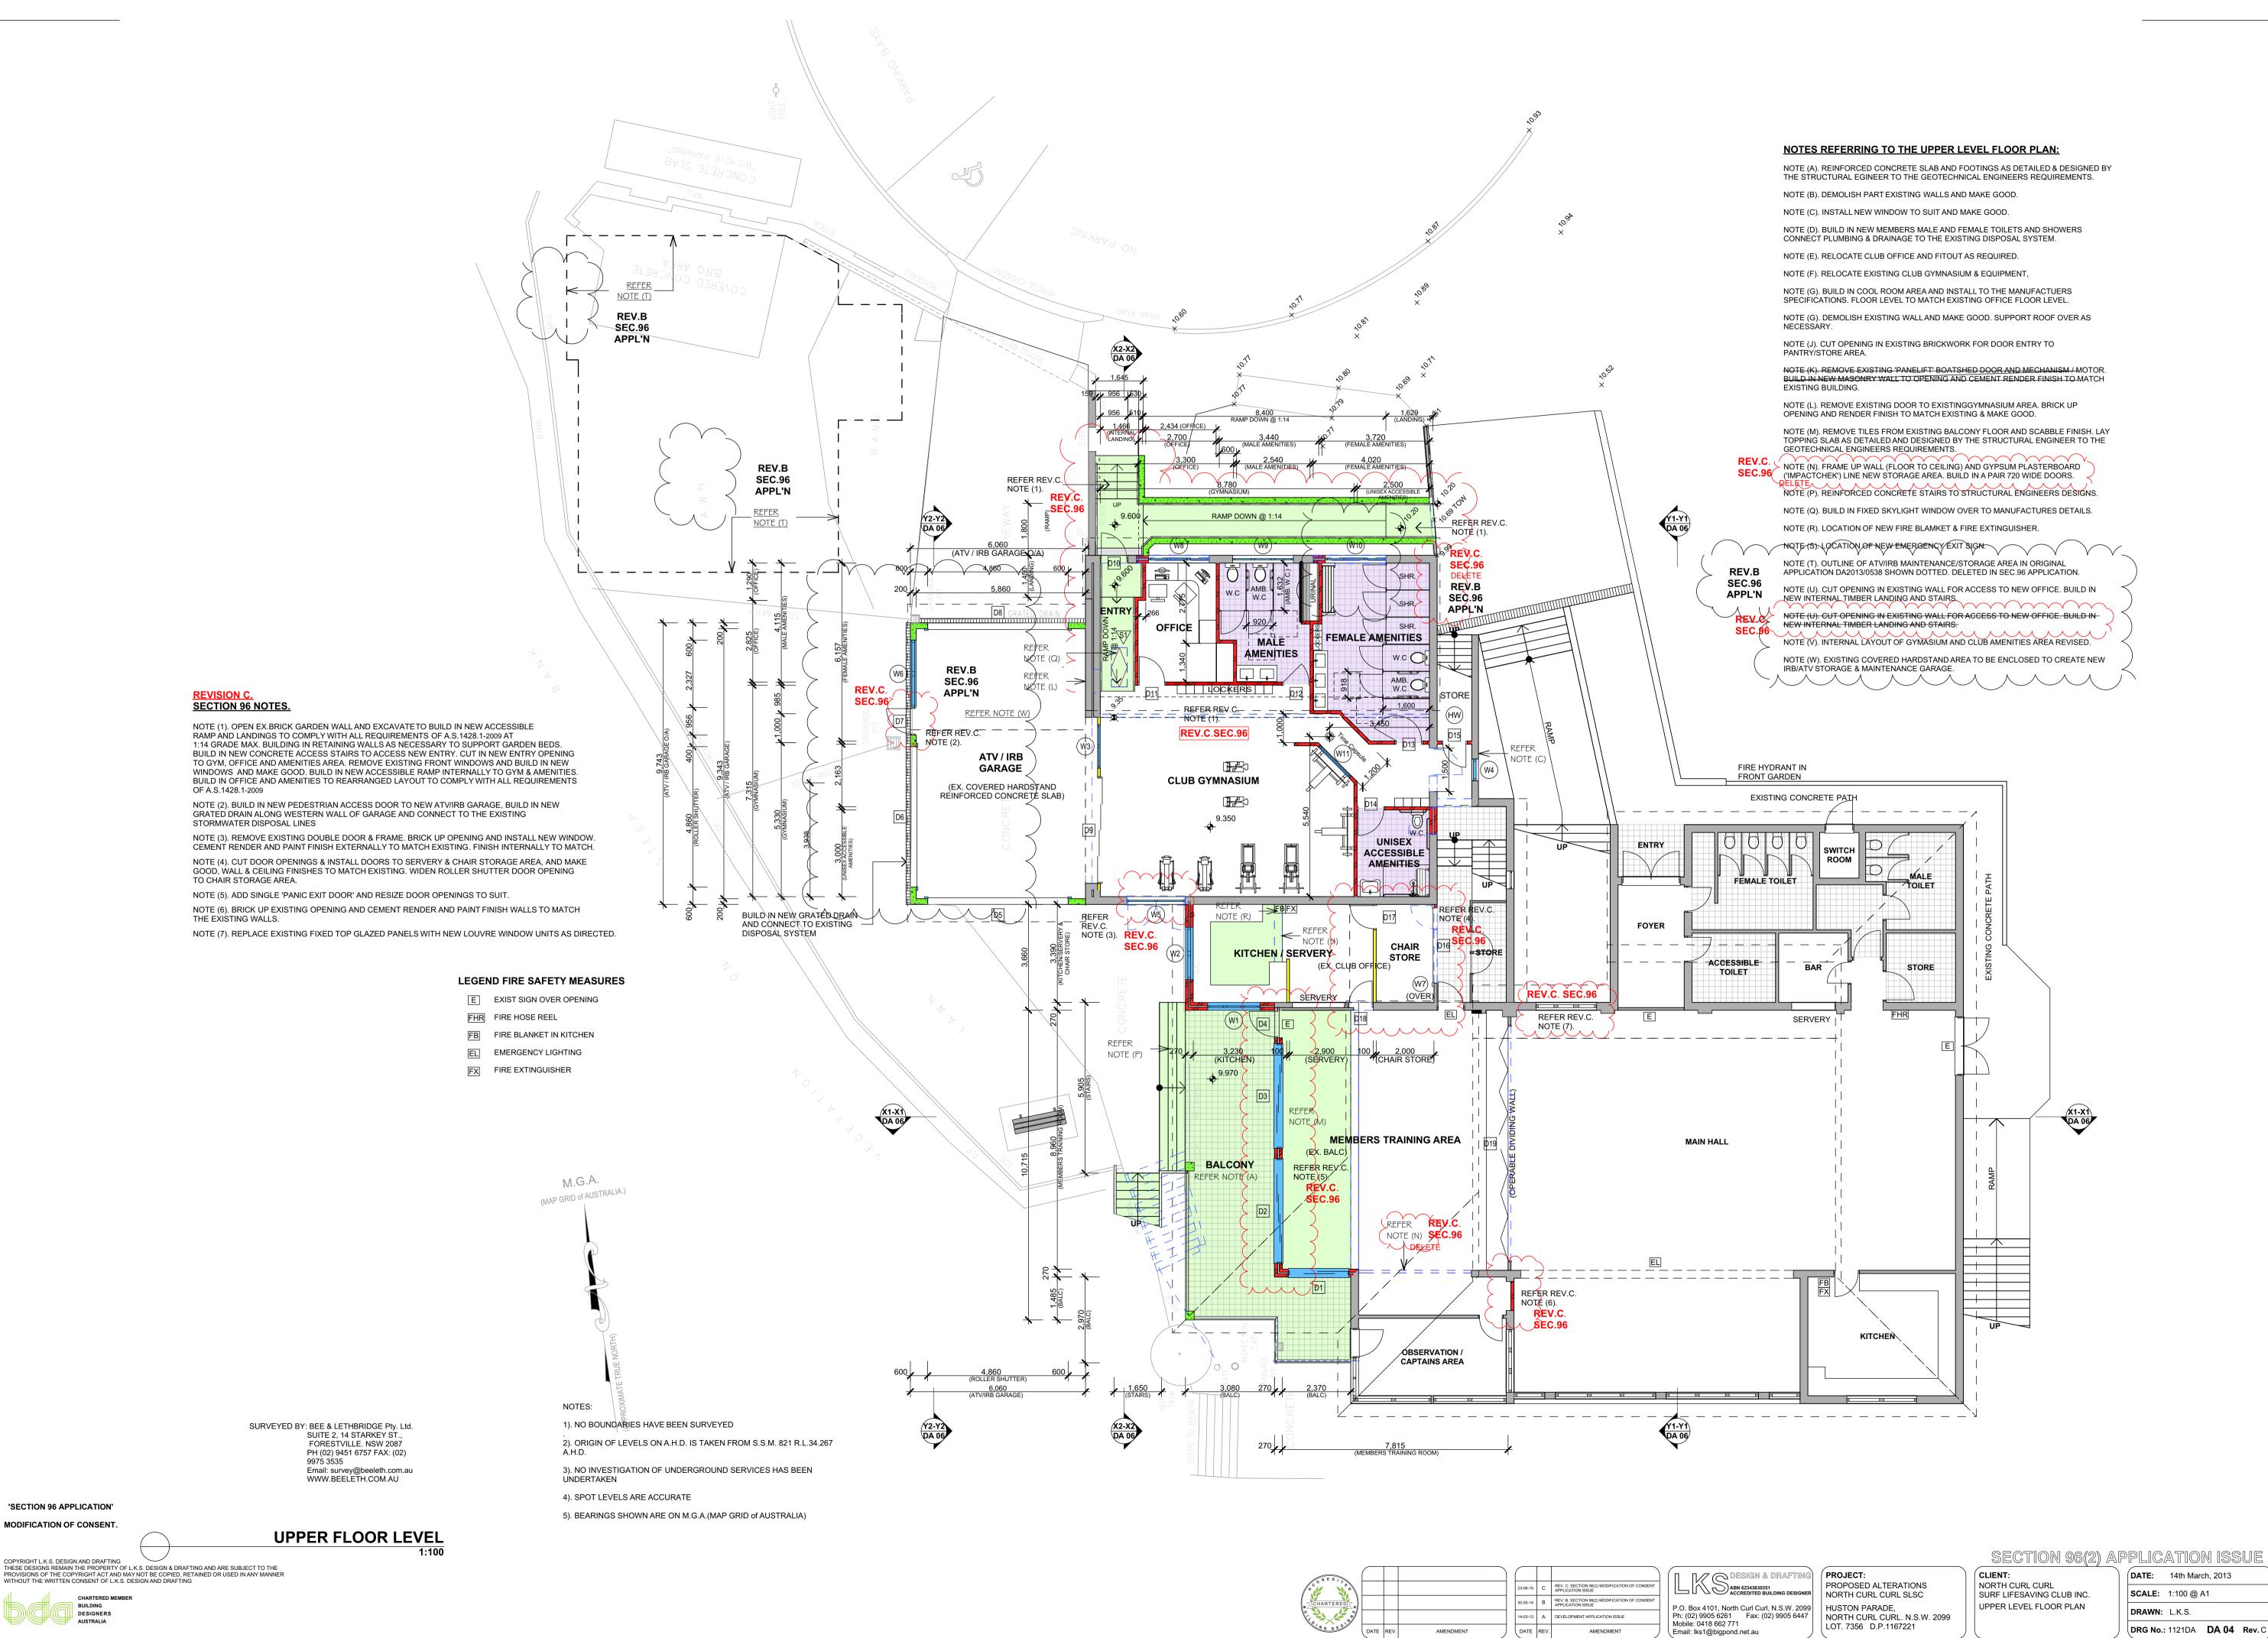

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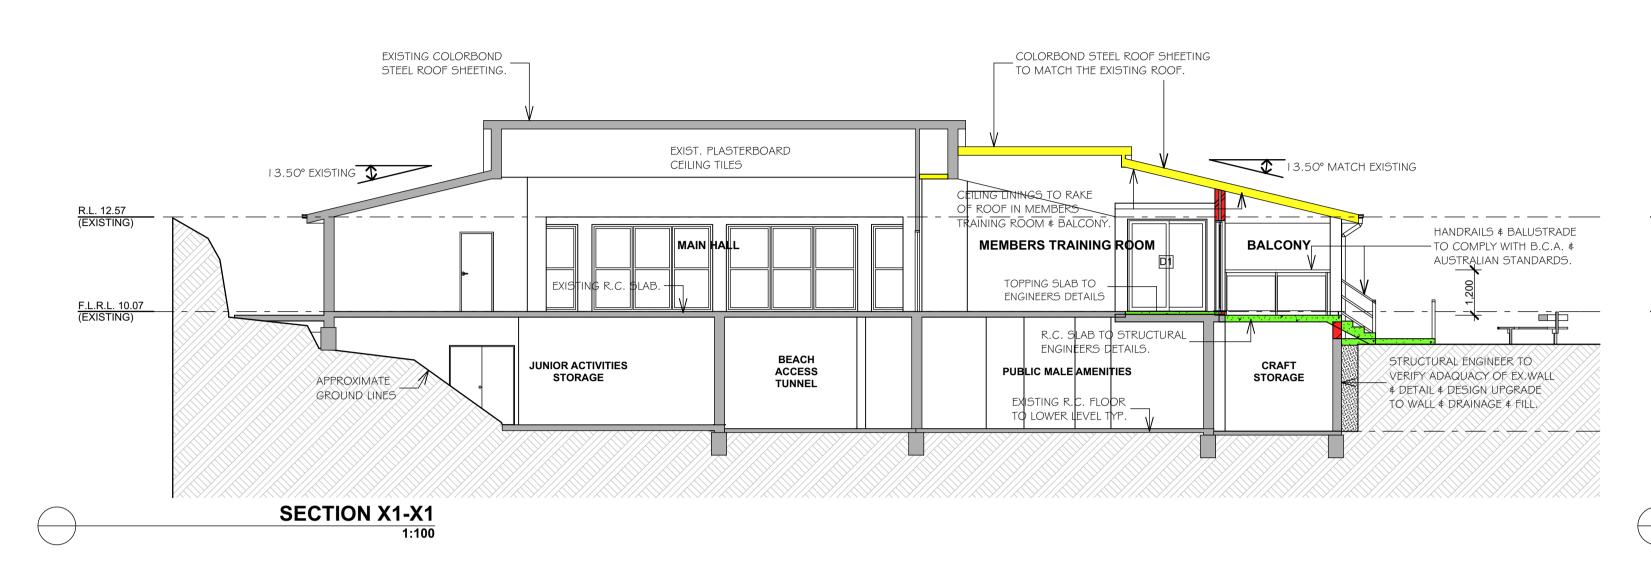
CHARTERED MEMBER
BUILDING
DESIGNERS
AUSTRALIA


DESIGN & DRAFTING PROJECT: P.O. Box 4101, North Curl Curl, N.S.W. 2099 HUSTON PARADE, Ph: (02) 9905 6261 Fax: (02) 9905 6447 Mobile: 0418 662 771 Email: lks1@bigpond.net.au

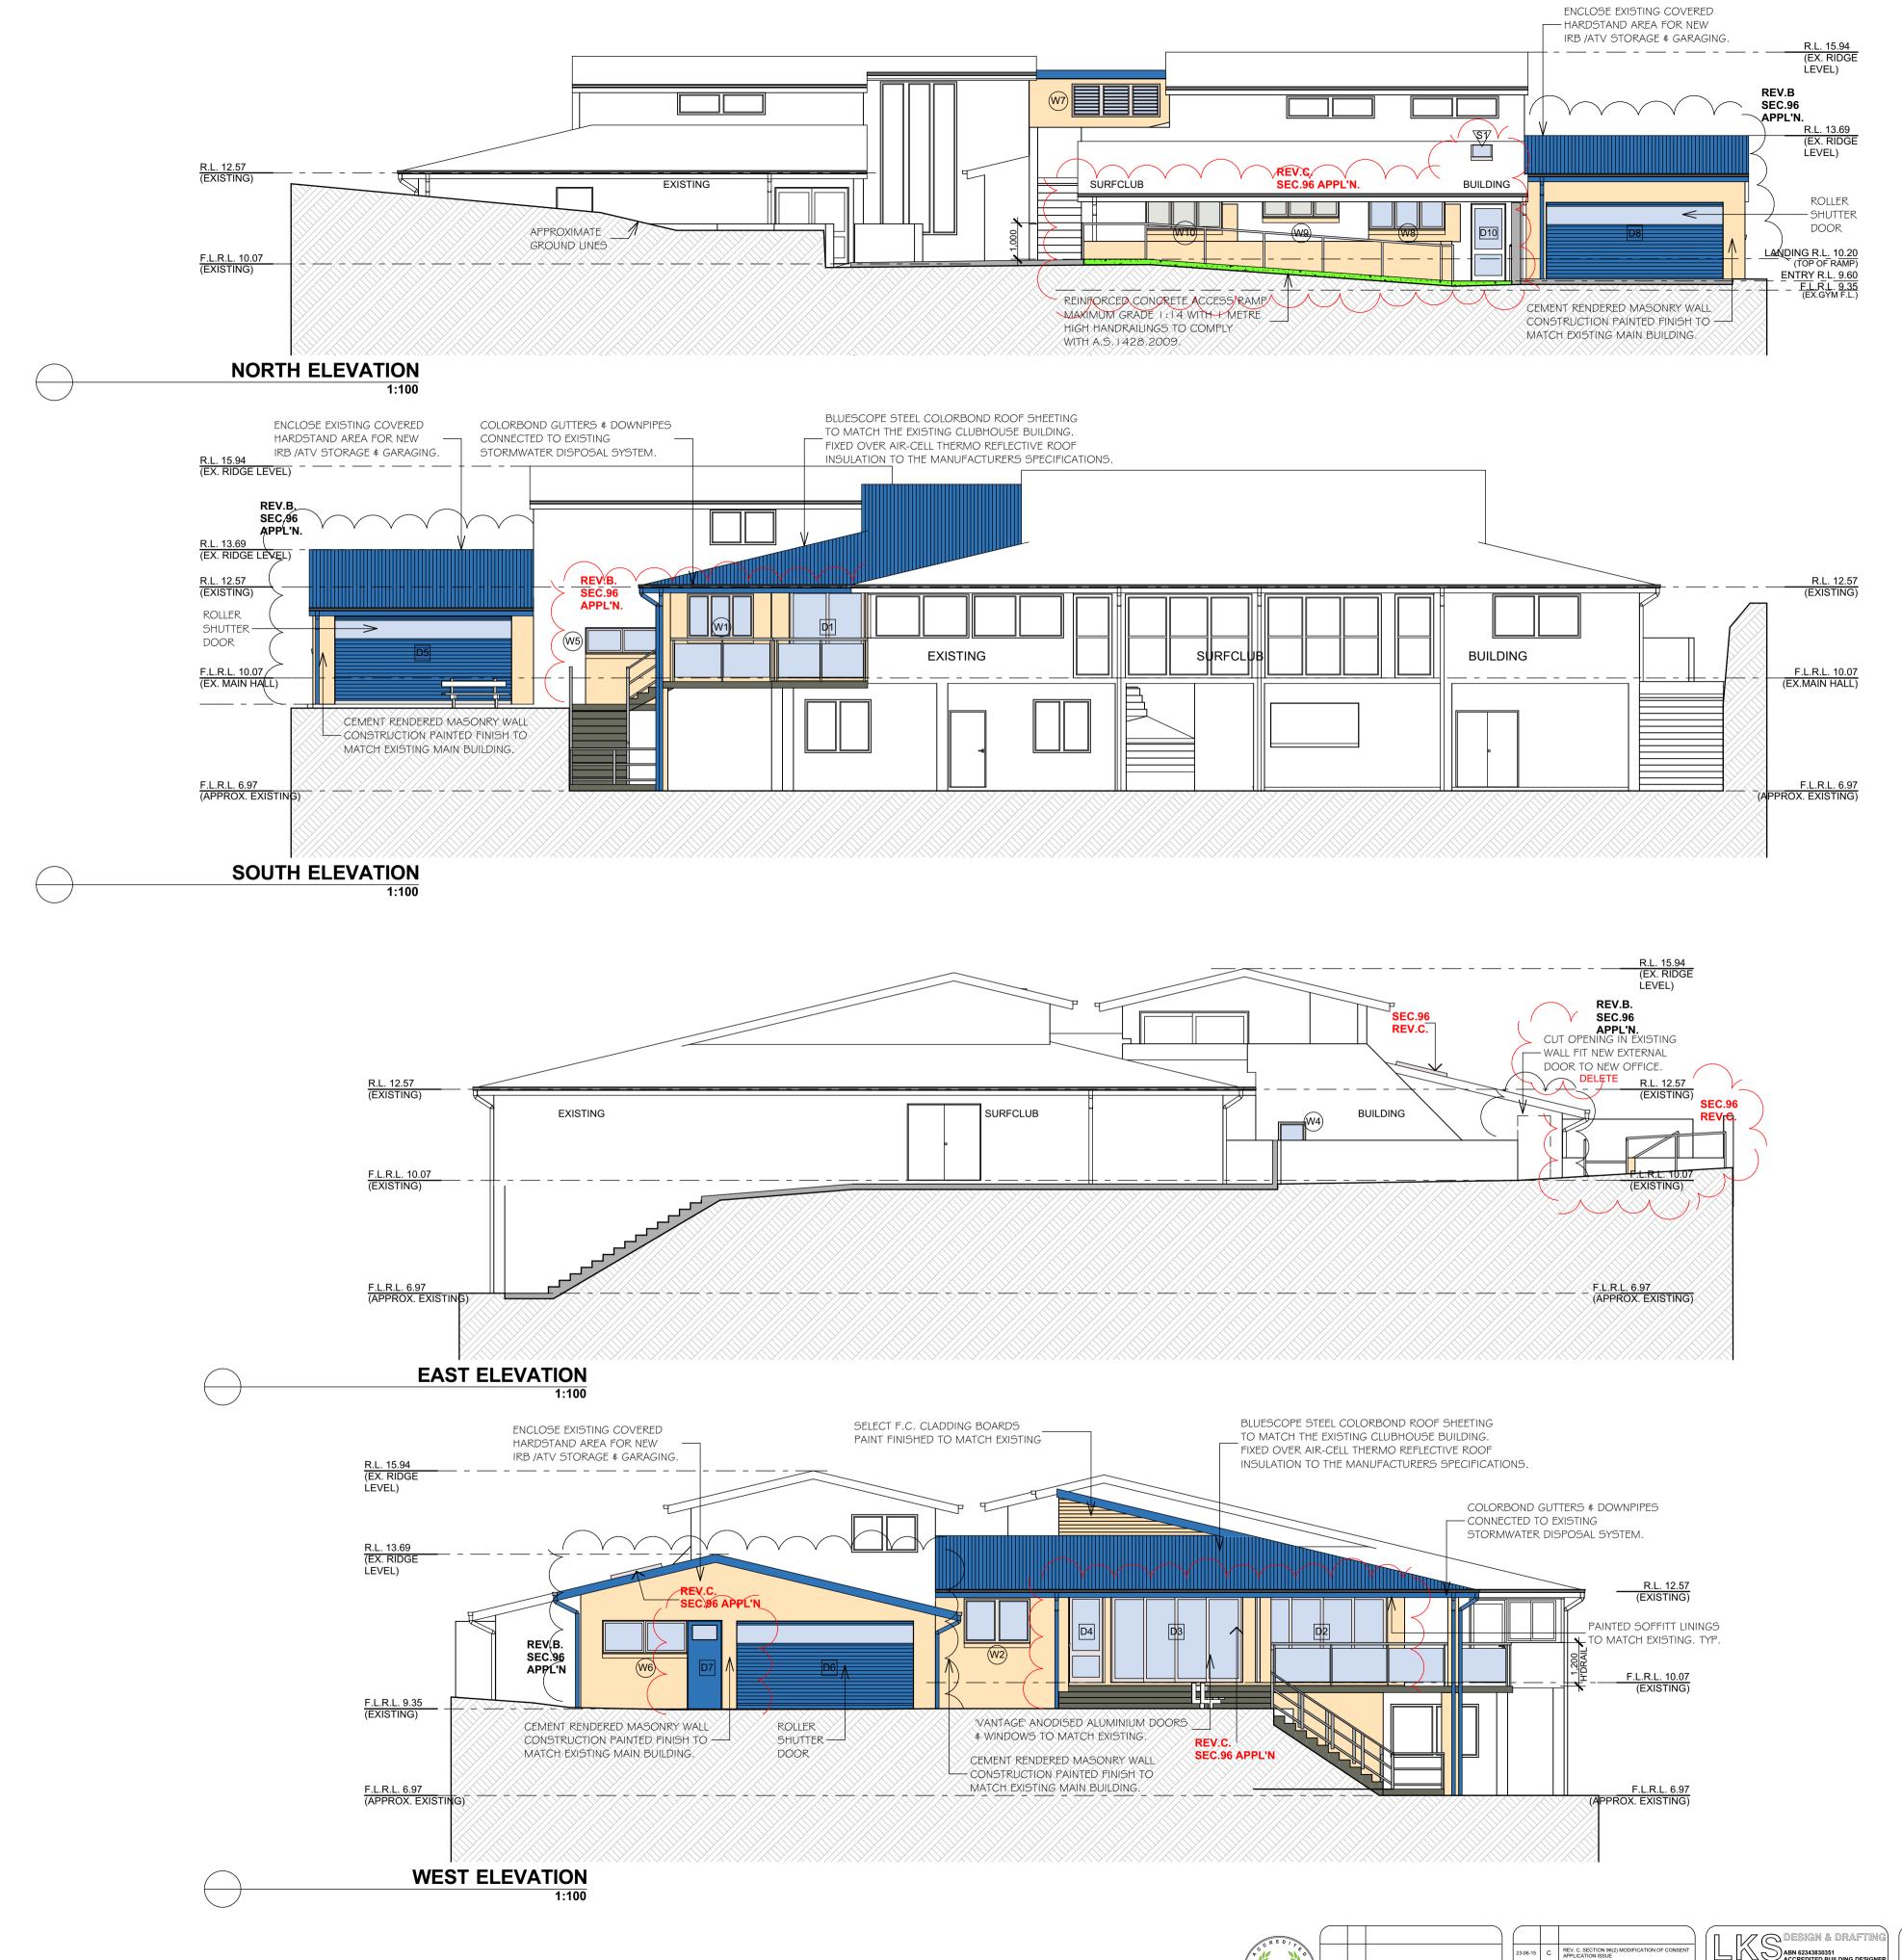PROPOSED ALTERATIONS NORTH CURL CURL SLSC NORTH CURL CURL. N.S.W. 2099 LOT. 7356 D.P.1167221 CLIENT: NORTH CURL CURL SURF LIFESAVING CLUB INC. NORTH, SOUTH, EAST & WEST ELEVATIONS


SECTION 96(2) APPLICATION ISSUE **DATE:** 14th March, 2013 SCALE: 1:100 @ A1 DRAWN: L.K.S.


DRG No.: 1121DA DA 05 Rev. C




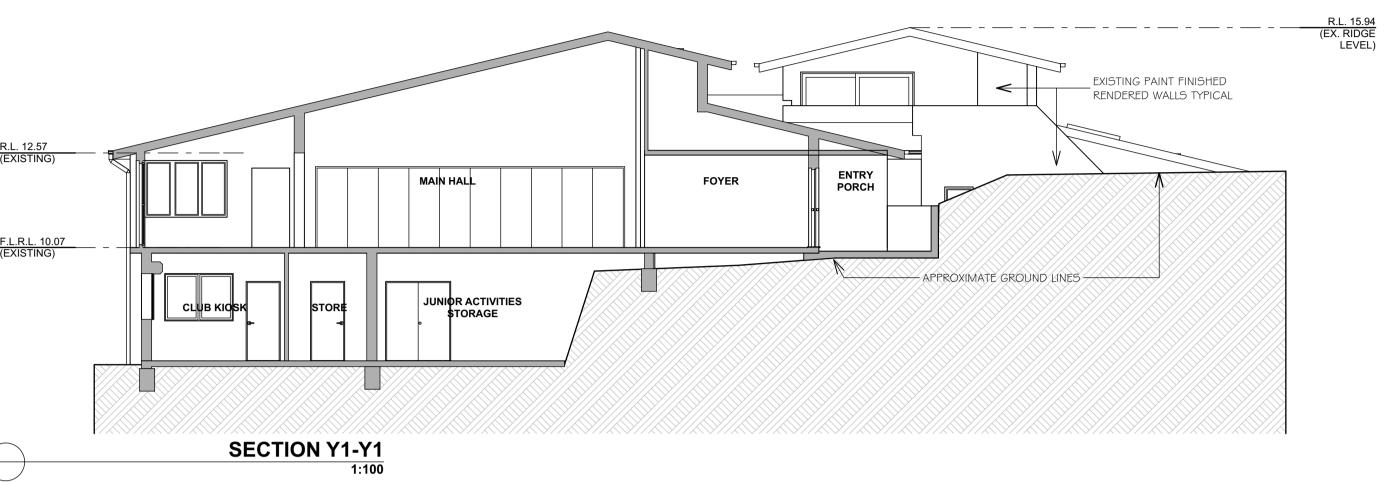



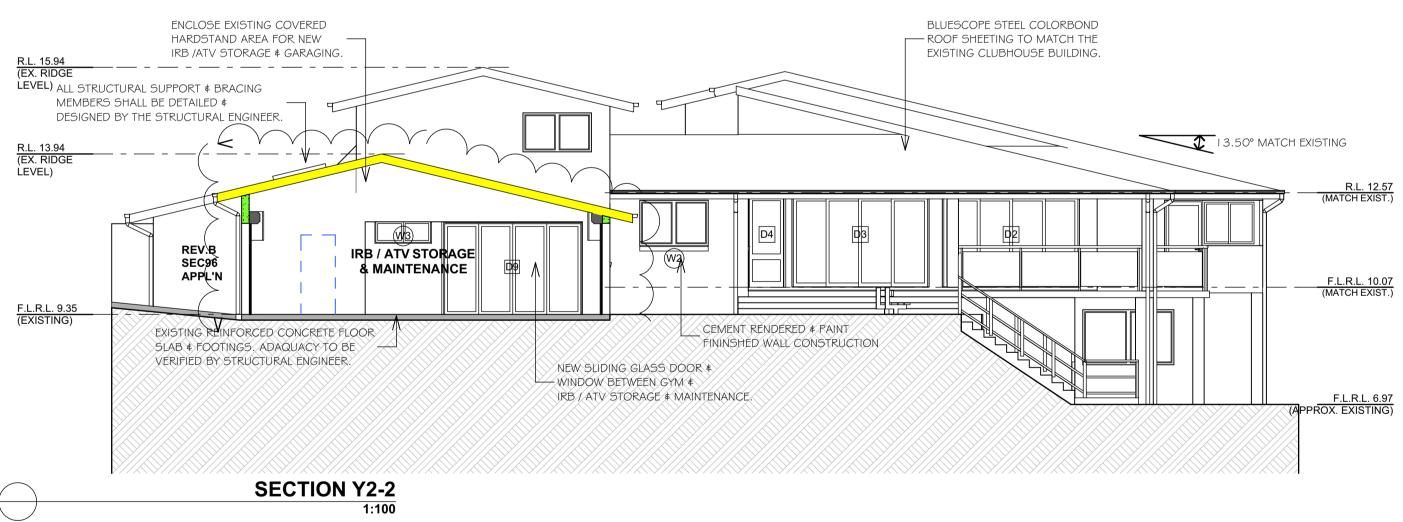

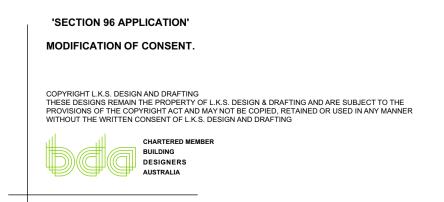

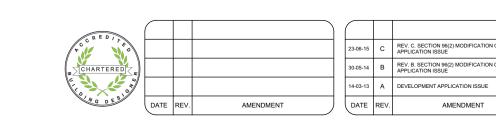


Design & Drafting Project: ABN 62343830351 PROPOSED ALTERATIONS ACCREDITED BUILDING DESIGNER NORTH CURL CURL SLSC P.O. Box 4101, North Curl Curl, N.S.W. 2099
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NORTH CURL CURL. N.S.W. 2099 LOT. 7356 D.P.1167221

SECTION 96(2) APPLICATION ISSUE CLIENT: **DATE:** 14th March, 2013 NORTH CURL CURL SURF LIFESAVING CLUB INC. SCALE: 1:100 @ A1 SECTIONAL VIEWS

DRAWN: L.K.S. **DRG No.**: 1121DA **DA 06 Rev**. C



	DOOR SCHEDULE								
NO.	SIZE (W x H)	LOCATION	TYPE	FRAME	View from Opening Side				
D1	2,020x2,400	MEMBERS TRAINING ROOM	SLIDING	ALUMINIUM					
D2	3,627x2,400	MEMBERS TRAINING ROOM	SLIDING STACKING	ALUMINIUM					
D3	3,627x2,400	MEMBERS TRAINING ROOM	SLIDING STACKING	ALUMINIUM					
D4	900x2,400	MEMBERS TRAINING ROOM	HINGED 'PANIC' DOOR GLAZED	ALUMINIUM					
D5	4,840x2,400	ATV/IRB GARAGE	SELECT AUSTRAL ROLLER SHUTTER WITH SLOTTED LIGHT PANELS	COLOURBOND STEEL					
D6	4,840x2,400	ATV/IRB GARAGE	SELECT AUSTRAL ROLLER SHUTTER WITH SLOTTED LIGHT PANELS	COLOURBOND STEEL					
D7	900x2,400	ATV/IRB GARAGE	SELECT TIMBER EXTERNAL GLAZED	TIMBER					
D8	4,840x2,400	ATV/IRB GARAGE	SELECT AUSTRAL ROLLER SHUTTER WITH SLOTTED LIGHT PANELS	COLOURBOND STEEL					
D9	3,600x2,400	GYMNASIUM	ALUMINIUM SLIDING	ALUMINIUM					
D10	900x2,100	OFFICE/GYM ACCESSIBLE ENTRY	HINGED ALUMINIUM GLAZED	ALUMINIUM					
D11	900x2,100	OFFICE	SELECT TIMBER GLAZED	ALUMINIUM					
D12	900x2,100	MALE AMENITIES	SELECT TIMBER	ALUMINIUM					
D13	900x2,100	FEMALE AMENITIES	SELECT TIMBER	ALUMINIUM					
D14	900x2,100	UNISEX ACCESSIBLE AMENITIES	SELECT TIMBER	ALUMINIUM					
D15	820x2,100	STORE / HWS	SELECT TIMBER	ALUMINIUM					
D16	2,580x2,100	CHAIR STORE	AUSTRAL ROLLER SHUTTER	COLOURBOND STEEL					
D17	820x2,100	CHAIR STORE	SELECT TIMBER	TIMBER					
D18	820x2,100	KITCHEN / SERVERY	SELECT TIMBER	TIMBER					
D19	8,100x2,100	HALL/MEMBERS TRAINING ROOM	SELECT 'HUFCOR' SLIDING PANEL FOLDING	ALUMINIUM					

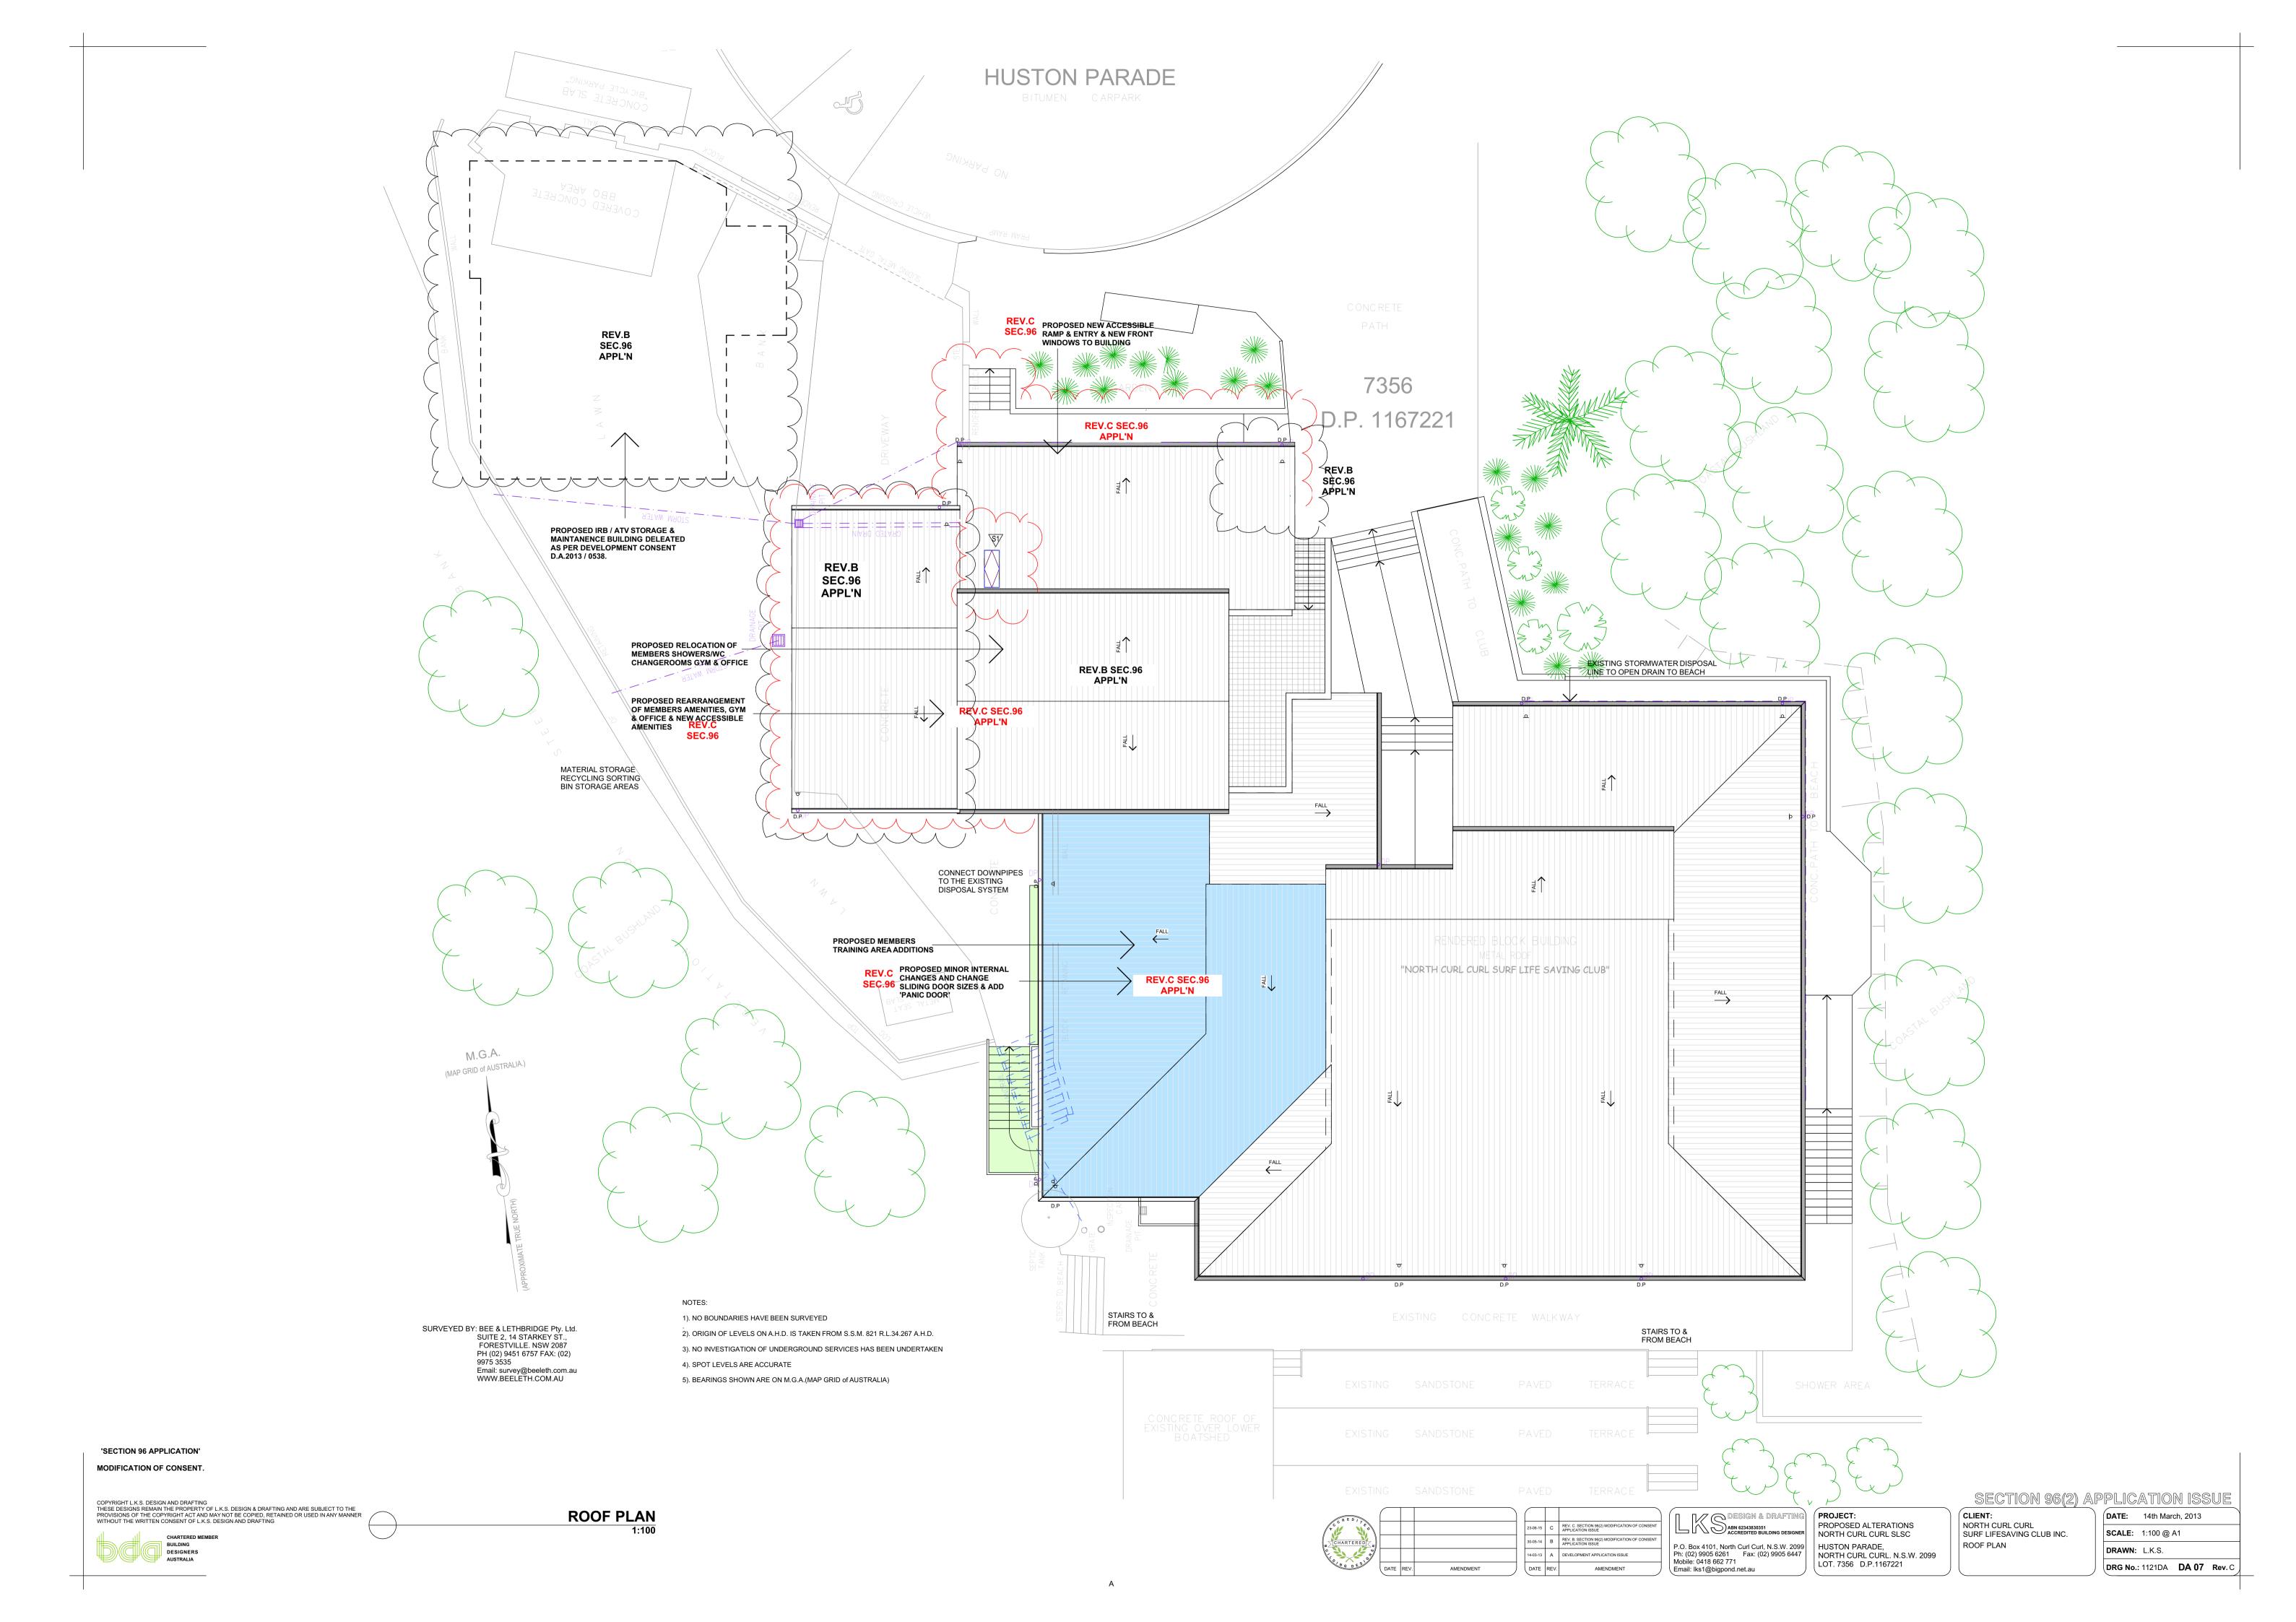WINDOW SCHEDULE								
NO.	SIZE (W x H)	LOCATION	TYPE	FRAME	ELEVATION VIEW			
W1	1,810x1,200	KITCHEN	STACKING SLIDING	ALUMINIUM				
W2	1,810x1,200	KITCHEN	SLIDING	ALUMINIUM				
W3	1,500x600	IRB/ATV/GYM	SLIDING	ALUMINIUM				
W4	750x1,500	HALL AMENITIES AREA	FIXED	ALUMINIUM				
W5	2,020x700	GYM SOUTH WALL	AWNING	ALUMINIUM				
W6	2,327x900	IRB/ATV	SLIDING	ALUMINIUM				
W7	2,420x900	MEMBERS TRAINING ROOM HI-LIGHT	LOUVRES	ALUMINIUM				
W8	2,100x900	CLUB OFFICE	AWNING	ALUMINIUM				
W9	2,100x570	MALE AMENITIES	AWNING OBSCURE GLASS	ALUMINIUM				
W10	2,100x900	FEMALE AMENITIES	AWNING OBSCURE GLASS	ALUMINIUM				
W11	1,500x1,500	GYM INTERNAL	FIXED	ALUMINIUM				

COMPLIANCE WITH AUSTRALIAN STANDARDS

DA 2013/0538 - LOT 7356 D.P.1167221, HUSTON PARADE, NORTH CURL CURL. NSW. - (North Curl Curl Surf Life Saving Club Inc.)

AS 2601.2001 - Demolition of Structures -Builders/Demolishers shall comply with standard with all necessary demolition on site

AS 4361.2 - Guide to lead paint management - Residential and commercial buildings

-Builder shall comply with all requirements of the Standard.

AS 4282:1997 Control of the Obtrusive Effects of Outdoor Lighting -Owners/Clients shall choose appropriate external lighting on advice from Electrician. Electrician shall install lighting as selected by

AS 4373 - 2007 'Pruning of Amenity Trees' (Note: if approval granted). -Not Applicable to this application, no approval granted.

AS 4970 - 2009 'Protection of trees on development sites' -The Builder shall protect all Trees on site adjacent to all new works as required by the Standard.

AS/NZS 2890.1:2004 Parking facilities - Off-street car parking -Not Applicable to this application

AS 2890.2 - 2002 Parking facilities - Off-street commercial vehicle facilities

AS 2890.3 - 1993 Parking Facilities - Bicycle parking facilities

 Not Applicable to this application AS 2890.5 - 1993 Parking Facilities - On-street parking - Not Applicable to this application

- Not Applicable to this application

AS/NZS 2890.6 - 2009 Parking facilities - Off-street parking for people with disabilities - Not Applicable to this application, disability parking spaces provided in existing carpark

AS 1742 Set - Manual of Uniform Traffic Control Devices Set - Not Applicable to this application

AS 1428.1 - 2009* Design for access and mobility - General requirements for access - New building work Builder to address accessibility to all new works as required by the Standard

AS 1428.2 - 1992* Design for access & mobility - Enhanced & additional requirements - Buildings & facilities - Builder to address accessibility to all new works as required by the Standard

GENERAL NOTES

THE PROPOSED ALTERATIONS & ADDITIONS SHALL BE CONSTRUCTED IN ACCORDANCE

(1) THE BUILDING CODE OF AUSTRALIA AND ALL LEGALLY CONSTIUTED AUTHORITIES FOR LOCAL GOVERNMENT AND SERVICES.

(2) ALL RELEVANT AUSTRALIAN STANDARDS AND IN A COMPETANT AND TRADESMANLIKE

(3) ALL MATERIALS AND SYSTEMS USED SHALL COMPLY WITH ALL RELEVANT AUSTRALIAN STANDARDS.

- DIMENSIONS SHALL NOT BE OBTAINED BY SCALING OFF DRAWINGS. ALL DIMENSIONS SHALL BE SITE CHECKED PRIOR TO ORDERING OF MATERIALS AND COMMENCEMENT OF WORKS. - DURING CONSTRUCTION THE STRUCTURE SHALL BE MAINTAINED IN A STABLE CONDITION AND NO PART SHALL BE OVERSTESSED

- FLASHINGS AND DAMPROOF COURSES ARE TO BE PLACED IN ACCORDANCE WITH GOOD BUILDING PRINCIPLES. WHETHER OR NOT SHOWN ON THE DRAWINGS.

- PROVIDE ELECTRICAL OUTLETS AND SERVICES AS DIRECTED BY THE OWNERS TO THE

REGULATING AUTHORITIES STANDARDS AND REQUIREMENTS - MATERIALS ARE TO BE NEW UNLESS OTHERWISE NOTED ON THE DRAWINGS - CARRY OUT ALL DRAINAGE WORKS AS REQUIRED AND CONNECT TO THE EXISTING

DISPOSAL SYSTEMS ONSITE. - CARRY OUT DEMOLITION WORKS AS REQUIRED, AND REMOVE DEMOLISHED MATERIALS

FROM THE SITE UNLESS OTHERWISE INSTRUCTED. - ON COMPLETION OF WORKS, THE SITE SHALL BE CLEAN OF ALL SURPLUS MATERIALS AND RUBBISH, AND READY FOR HABITATION.

BEE & LETHBRIDGE PTY.LTD. QUALITY SURVEYING AND DEVELOPMENT SOLUTIONS

- LEVELS QUOTED ARE TO AHD AS PROVIDED BY

SUITE 2, 14 STARKEY STREET, FORESTVILLE. NSW 2087 PH (02) 9451 6757 FAX (02) 9975 3535

- ALL WINDOWS & DOORS SHALL BE FRAMED & GLAZED AS PER THE WINDOW, DOOR SCHEDULE AND ALL REQUIREMENTS OF THE 'BASIX' SUSTAINABILITY REPORT.

- THESE DRAWINGS SHALL BE READ IN CONJUCTION WITH THE ATTACHED SPECIFICATION AND ALL OTHER CONSULTANTS DETAILS & DESIGNS.

MATERIALS SPECIFICATION - SCHEDULE OF FINISHES

- ROOF COVERING : SELECT COLOURBOND STEEL ROOF SHEETING, RIDGE, HIP & BARGE

CAPPINGS FIXED TO MANUFACTURERS SPECIFICATIONS. 'AIR-CELL' GLARESHIELD-THERMO REFLECTIVE ANTIGLARE INSULATION - ROOF INSULATION: UNDER ROOF SHEETING, INSTALL TO MANUFACTURERS SPECIFICATIONS. WALLS EXTERNAL: SELECT FACE BRICK WALLS TO MATCH EXISTING BUILDING

KINGSPAN 'AIR-CELL' GLARESHIELD THERMO REFLECTIVE ANTIGLARE - WALL INSULATION: INSULATION TO WALL CAVITY TO THE MANUFACTURERS SPECIFICATIONS. GYPSUM PLASTERBOARD LINED AND PAINT FINISHED THROUGHOUT - WALLS INTERNAL: RELINE EXISTING AS REQUIRED & DIRECTED BY OWNERS. COLOURBOND STEEL AS SELECTED BY THE OWNERS. CONNECT TO

- ROOF GUTTERS: DOWNPIPES. COLOUR TO MATCH EXISTING GUTTERING COLOURBOND STEEL TO MATCH NEW GUTTERS. CONNECT TO 100DIA. - RAINWATER PIPES: UPVC PIPES TO EXISTING STORMWATER DISPOSAL SYSTEM. F.C.SHEET LININGS.

- SOFFITT LININGS: REINFORCED CONCRETE SLABS TO STRUCTURAL ENGINEERS DESIGN. - INTERNAL FLOORING: - CEILING LININGS: GYPSUM PLASTERBOARD THROUGHOUT. - CORNICE: GYPSUM PLASTERBOARD MATCH EXISTING OR AS SELECTED BY THE

- SKIRTING & ARCHITRAVES: MATCH EXISTING OR AS SELECTED BY THE OWNERS - INTERNAL DOORS: TIMBER PANELLED TO MATCH THE EXISTING - WINDOWS:

NEW ALUMINIUM FRAMED WINDOWS BY 'ARCHITECTURAL WINDOW SYSTEMS PTY.LTD. (AWS). WINDOWS SHALL HAVE WEATHER STRIPPING ALL ROUND, & SHALL COMPLY WITH SECTION J

REQUIREMENTS OF NATIONAL CONSTRUCTION CODE. NEW ALUMINIUM FRAMED DOORS BY 'ARCHITECTURAL WINDOW - EXTERNAL DOORS: SYSTEMS PTY.LTD. (AWS). DOORS SHALL HAVE WEATHER STRIPPING ALL ROUND, & SHALL COMPLY WITH SECTION J REQUIREMENTS OF NATIONAL CONSTRUCTION CODE.

1. FALLS, SLIPS, TRIPS

a) WORKING AT HEIGHTS

DURING CONSTRUCTION Wherever possible, components for this building should be prefabricated off-site or at ground level to minimise the risk of workers falling more than two metres. However, construction of this building will require workers to be working at heights where a fall in excess of two metres is possible and injury is likely to result from such a fall. The builder should provide a suitable barrier wherever a person is required to work in a situation where falling more than two metres is a possibility.

DURING OPERATION OR MAINTENANCE For houses or other low-rise buildings where scaffolding is

Cleaning and maintenance of windows, walls, roof or other components of this building will require persons to be situated where a fall from a height in excess of two metres is possible. Where this type of activity is required, scaffolding, ladders or trestles should be used in accordance with relevant codes of practice regulations or legislation.

For buildings where scaffold, ladders, trestles are not appropriate: Cleaning and maintenance of windows, walls, roof or other components of this building will require persons to be situated where a fall from a height in excess of two metres is possible. Where this type of activity is required, scaffolding, fall barriers or Personal Protective Equipment (PPE) should be used in accordance with relevant codes of practice, regulations or legislation.

ANCHORAGE POINTS Anchorage points for portable scaffold or fall arrest devices have been included in the design for use by maintenance workers. Any persons engaged to work on the building after completion of construction work should be informed about the anchorage points.

b) SLIPPERY OR UNEVEN SURFACES

FLOOR FINISHES Specified If finishes have been specified by designer, these have been selected to minimise the risk of floors and paved areas becoming slippery when wet or when walked on with wet shoes/feet. Any changes to the specified finish should be made in consultation with the designer or, if this is not practical, surfaces with an equivalent or better slip resistance should be chosen. FLOOR FINISHES By Owner

If designer has not not been involved in the selection of surface finishes, the owner is responsible for the selection of surface finishes in the pedestrian trafficable areas of this building. Surfaces should be selected in accordance with AS HB 197:1999 and AS/NZ

STEPS, LOOSE OBJECTS AND UNEVEN SURFACES Due to design restrictions for this building, steps and/or ramps are included in the building which may be a hazard to workers carrying objects or otherwise occupied. Steps should be clearly marked with both visual and tactile warning during construction, maintenance. demolition and at all times when the building operates as a Building owners and occupiers should monitor the pedestrian

access ways and in particular access to areas where maintenance is routinely carried out to ensure that surfaces have not moved or cracked so that they become uneven and present a trip hazard. Spills, loose material, stray objects or any other matter that may cause a slip or trip hazard should be cleaned or removed from access ways. Contractors should be required to maintain a tidy work site during

construction, maintenance or demolition to reduce the risk of trips and falls in the workplace. Materials for construction or maintenance should be stored in designated areas away from access ways and work areas.

2. FALLING OBJECTS

LOOSE MATERIALS OR SMALL OBJECTS Construction, maintenance or demolition work on or around this building is likely to involve persons working above ground level or above floor levels. Where this occurs one or more of the following measures should be taken to avoid objects falling from the area where the work is being carried out onto persons below.

1. Prevent or restrict access to areas below where the work is being carried out.

Provide toeboards to scaffolding or work platforms. Provide protective structure below the work area. 4. Ensure that all persons below the work area have Personal

Protective Equipment (PPE).

BUILDING COMPONENTS

During construction, renovation or demolition of this building, parts of the structure including fabricated steelwork, heavy panels and many other components will remain standing prior to or after supporting parts are in place. Contractors should ensure that temporary bracing or other required support is in place at all times when collapse which may injure persons in the area is a possibility.

Mechanical lifting of materials and components during construction, maintenance or demolition presents a risk of falling objects. Contractors should ensure that appropriate lifting devices are used, that loads are properly secured and that access to areas below the load is prevented or restricted.

3. TRAFFIC MANAGEMENT

For building on a major road, narrow road or steeply sloping road: Parking of vehicles or loading/unloading of vehicles on this roadway may cause a traffic hazard. During construction, maintenance or demolition of this building designated parking for workers and loading areas should be provided. Trained traffic management personne should be responsible for the supervision of these areas. For building where on-site loading/unloading is restricted: Construction of this building will require loading and unloading of materials on the roadway. Deliveries should be well planned to avoid congestion of loading areas and trained traffic management personnel should be used to supervise loading/unloading areas. For all buildings:

Busy construction and demolition sites present a risk of collision where deliveries and other traffic are moving within the site. A traffic management plan supervised by trained traffic management personnel should be adopted for the work site.

Rupture of services during excavation or other activity creates a

4. SERVICES

variety of risks including release of hazardous material. Existing services are located on or around this site. Where known, these are identified on the plans but the exact location and extent of services may vary from that indicated. Services should be located using an appropriate service (such as Dial Before You Dig), appropriate excavation practice should be used and, where necessary, specialist contractors should be used. Locations with underground power: Underground power lines MAY be located in or around this site. All underground power lines must be disconnected or carefully located and adequate warning signs used prior to any construction, maintenance or demolition commencing Locations with overhead power lines: Overhead power lines MAY be near or on this site. These pose a risk of electrocution if struck or approached by lifting devices or other plant and persons working above ground level. Where there is a danger of this occurring, power lines should be, where practical, disconnected or relocated. Where this is not practical adequate

warning in the form of bright coloured tape or signage should be

used or a protective barrier provided.

5. MANUAL TASKS

Components within this design with a mass in excess of 25kg should be lifted by two or more workers or by mechanical lifting device. Where this is not practical, suppliers or fabricators should be required to limit the component mass. All material packaging, building and maintenance components should clearly show the total mass of packages and where practical all items should be stored on site in a way which minimises bending before lifting. Advice should be provided on safe lifting methods in all areas where lifting may occur. Construction, maintenance and demolition of this building will require the use of portable tools and equipment. These should be fully maintained in accordance with manufacturer's specifications and not used where faulty or (in the case of electrical equipment) not carrying a current electrical safety tag. All safety guards or devices should be regularly checked and Personal Protective Equipment should be used in accordance with manufacturer's specification.

6. HAZARDOUS SUBSTANCES

ASBESTOS For alterations to a building constructed prior to 1990: If this existing building was constructed prior to: 1990 - it therefore may contain asbestos 1986 - it therefore is likely to contain asbestos either in cladding material or in fire retardant insulation material. In either case, the builder should check and, if necessary, take appropriate action before demolishing, cutting, sanding, drilling or otherwise disturbing the existing structure.

POWDERED MATERIALS Many materials used in the construction of this building can cause harm if inhaled in powdered form. Persons working on or in the building during construction, operational maintenance or demolition should ensure good ventilation and wear Personal Protective Equipment including protection against inhalation while using powdered material or when sanding, drilling, cutting or otherwise disturbing or creating powdered material.

TREATED TIMBER

The design of this building may include provision for the inclusion of treated timber within the structure. Dust or fumes from this material can be harmful. Persons working on or in the building during construction, operational maintenance or demolition should ensure good ventilation and wear Personal Protective Equipment including protection against inhalation of harmful material when sanding, drilling, cutting or using treated timber in any way that may cause harmful material to be released. Do not burn treated timber.

VOLATILE ORGANIC COMPOUNDS Many types of glue, solvents, spray packs, paints, varnishes and some cleaning materials and disinfectants have dangerous emissions. Areas where these are used should be kept well ventilated while the material is being used and for a period after installation. Personal Protective Equipment may also be required. The manufacturer's recommendations for use must be carefully

SYNTHETIC MINERAL FIBRE Fibreglass, rockwool, ceramic and other material used for thermal or sound insulation may contain synthetic mineral fibre which may be harmful if inhaled or if it comes in contact with the skin, eves or other sensitive parts or the body. Personal Protective Equipment including protection against inhalation of harmful material should be used when installing, removing or working near bulk insulation material.

TIMBER FLOORS

considered at all times.

This building may contain timber floors which have an applied finish. Areas where finishes are applied should be kept well ventilated during sanding and application and for a period after installation. Personal Protective Equipment may also be required. The manufacturer's recommendations for use must be carefully considered at all times

7. CONFINED SPACES

EXCAVATION Construction of this building and some maintenance on the building will require excavation and installation of items within excavations. Where practical, installation should be carried out using methods which do not require workers to enter the excavation. Where this is not practical, adequate support for the excavated area should be provided to prevent collapse. Warning signs and barriers to prevent accidental or unauthorised access to all excavations should be provided.

ENCLOSED SPACES

For buildings with enclosed spaces where maintenance or other access may be required: Enclosed spaces within this building may present a risk to persons entering for construction, maintenance or any other purpose. The design documentation calls for warning signs and barriers to unauthorised access. These should be maintained throughout the life of the building. Where workers are required to enter enclosed spaces, air testing equipment and Personal Protective Equipment

should be provided

SMALL SPACES For buildings with small spaces where maintenance or other access may be required: Some small spaces within this building will require access by construction or maintenance workers. The design documentation calls for warning signs and barriers to unauthorised access. These should be maintained throughout the life of the building. Where workers are required to enter small spaces they should be scheduled so that access is for short periods. Manual lifting and

other manual activity should be restricted in small spaces.

8. PUBLIC ACCESS

Public access to construction and demolition sites and to areas under maintenance causes risk to workers and public. Warning signs and secure barriers to unauthorised access should be provided. Where electrical installations, excavations, plant or loose materials are present they should be secured when not fully supervised.

9. OPERATIONAL USE OF BUILDING

provisions of the Work Health and Safety Act 2011 or subsequent

RESIDENTIAL BUILDINGS This building has been designed as a residential building. If it, at a later date, it is used or intended to be used as a workplace, the

replacement Act should be applied to the new use. **NON-RESIDENTIAL BUILDINGS** For non-residential buildings where the end-use has not been

This building has been designed to requirements of the classification identified on the drawings. The specific use of the building is not known at the time of the design and a further assessment of the workplace health and safety issues should be undertaken at the time of fit-out for the end-user.

For non-residential buildings where the end-use is known: This building has been designed for the specific use as identified on the drawings. Where a change of use occurs at a later date a further assessment of the workplace health and safety issues

should be undertaken. 10.OTHER HIGH RISK ACTIVITY


All electrical work should be carried out in accordance with Code of Practice: Managing Electrical Risks at the Workplace, AS/NZ 3012 and all licensing requirements. All work using Plant should be carried out in accordance with Code of Practice: Managing Risks of Plant at the Workplace. All work should be carried out in accordance with Code of Practice: Managing Noise and Preventing Hearing Loss at Work. Due to the history of serious incidents it is recommended that particular care be exercised when undertaking work involving steel construction and concrete placement. All the above applies.

THESE NOTES MUST BE READ AND UNDERSTOOD BY ALL INVOLVED IN THE PROJECT. THIS INCLUDES (but is not excluded to): OWNER, BUILDER, SUB-CONTRACTORS, CONSULTANTS, RENOVATORS, OPERATORS, MAINTENORS, DEMOLISHERS.

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03-06-15 A REV.A.CONSTRUCTION CERTIFICATE ISSUE

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PROJECT PROPOSED ALTERATIONS NORTH CURL CURL SLSC LOT. 7356 D.P.1167221

NORTH CURL CURL. N.S.W. 2099

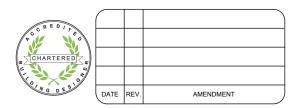CLIENT: NORTH CURL CURL COMPLIANCE WITH STANDARDS

SURF LIFESAVING CLUB INC. DOOR & WINDOW SCHEDULES, GENERAL NOTES, SAFTEY NOTES, MATERIALS SPECIFICATION &

SECTION 96(2) APPLICATION ISSUE **DATE:** 14th March, 2013 SCALE: 1:100 @ A1 DRAWN: L.K.S.

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