# DRAWING LIST

|      | COVER SH | HEET                      |
|------|----------|---------------------------|
| A001 | -        | COVER SHEET               |
|      | SITE     |                           |
| A002 |          | SITE ANALYSIS PLAN        |
| A010 | ;        | SITE PLAN                 |
| A011 |          | DEMOLITION PLAN           |
| A012 |          | EXCAVATION PLAN           |
|      | FLOOR PL | ANS                       |
| A100 |          | BASEMENT LEVEL 2 PLAN     |
| A101 |          | BASEMENT LEVEL 1 PLAN     |
| A102 |          | GROUND FLOOR PLAN         |
| A103 |          | LEVEL 1 PLAN              |
| A104 |          | LEVEL 2 PLAN              |
| A105 |          | ROOF PLAN                 |
|      | ELEVATIO | NS                        |
| A300 |          | SOUTH ELEVATION           |
| A301 |          | EAST ELEVATION            |
| A302 |          | NORTH AND WEST ELEVATION  |
|      | SECTIONS | 3                         |
| A310 |          | SECTION AA                |
| A311 |          | SECTION BB                |
| A312 |          | SECTION CC                |
|      | MATERIAL | AND FINISHES              |
| A320 |          | MATERIAL AND FINISHES     |
|      | SHADOW   | DIAGRAMS                  |
| A400 |          | SHADOW DIAGRAM - SHEET 01 |
| A401 |          | SHADOW DIAGRAM - SHEET 02 |
|      | SOLAR ST | UDY DIAGRAMS              |
| A405 |          | SOLAR STUDIES - SHEET 01  |
| A406 |          | SOLAR STUDIES - SHEET 02  |
| A407 |          | SOLAR STUDIES - SHEET 03  |
|      |          |                           |

# NOTES

| INOIL | <u>.</u> S  |
|-------|---|
| C2.9  | TABLE 3 - TYPE A CONSTRUCTION<br>MINIMUM FRL OF BUILDING ELEMENT<br>BASEMENT FLOORS - B1 AND B2 - 120/120/120   |
| C2.9  | TABLE 3 - TYPE A CONSTRUCTION<br>MINIMUM FRL OF BUILDING ELEMENT<br>GROUND FLOOR SLAB - 240/240/240   |
| C2.9  | TABLE 3 - TYPE A CONSTRUCTION MINIMUM FRL OF BUILDING ELEMENT ALL RESIDENTIAL FLOOR SLABS - 90/90/90 ACOUSTIC RATING - Rw+Ctr > 50 and Ln.W > 62          |
| C3.11 | ALL SOLE OCCUPANCY UNITS TO HAVE A SELF-CLOSING FIRE DOOR WITH MINIMUM FRL OF -/60/30   |
| D1.7  | BASEMENT 1 ACCESSIBLE WC TO HAVE A SELF-CLOSING FIRE DOOR WITH MINIMUM FRL OF -/60/30   |
| D3.3  | ALL ACCESSIBLE BATHROOMS TO INCLUDE ALL AS1428:1<br>CIRCULATION - FITTINGS - FIXTURES - CLEARANCES IN<br>THE LIKE FOR FULL COMPLIANCE - INCLUDING SHELVES |
| E1.3  | FIP LOCATED IN RESIDENTIAL LOBBY  |
| E1.3  | BOOSTER ASSEMBLY LOCATED ON ROBERTSON ROAD ENTRY  |
| E1.5  | SPRINKLERS LOCATED IN ALL BASEMENT LEVELS   |

# UNITS

| UNIT  | LEVEL | 1 BED | 2 BED | BATH | ENS | ADPT. | UNIT<br>AREA        | BALCONY/<br>COURTYARD<br>AREA   | LIFT<br>ACCESS | DIRECT<br>SUNLIGHT      | CROSS<br>THROUGH<br>VENTILATIO           | SINGLE<br>ASPECT<br>N  | LIVING<br>ROOM<br>WIDTH | PARKING<br>REQUIRED |
|-------|-------|-------|-------|------|-----|-------|---------------------|---------------------------------|----------------|-------------------------|--|------------------------|-------------------------|---------------------|
| 01    | 1     |       |       |      |     |       | 90.4m <sup>2</sup>  | 24.7m <sup>2</sup>              |                |                         |  |                        | > 4m                    | 2                   |
| 02    | 1     |       |       |      |     |       | 97.7m <sup>2</sup>  | 33.0m <sup>2</sup>              |                |                         |  |                        | >4m                     | 2                   |
| 03    | 1     |       |       |      |     |       | 87.1m <sup>2</sup>  | 36.8m <sup>2</sup>              |                |                         |  |                        | 4m                      | 2                   |
| 04    | 1     |       |       |      |     |       | 95.8m <sup>2</sup>  | 21.7m <sup>2</sup>              |                |                         |  |                        | > 4m                    | 2                   |
| 05    | 1     |       |       |      |     |       | 96.5m <sup>2</sup>  | 27.5m <sup>2</sup>              |                |                         |  |                        | >4m                     | 2                   |
| 06    | 1     |       |       |      |     |       | 90.2m <sup>2</sup>  | 33.9m <sup>2</sup>              |                |                         |  |                        | >4m                     | 2                   |
| 07    | 1     |       |       |      |     |       | 97.8m <sup>2</sup>  | 36.0m <sup>2</sup>              |                |                         |  |                        | > 4m                    | 2                   |
| 08    | 1     |       |       |      |     |       | 109.2m <sup>2</sup> | <sup>2</sup> 72.1m <sup>2</sup> |                |                         |  |                        | > 4m                    | 2                   |
| 09    | 2     |       |       |      |     |       | 91.5m <sup>2</sup>  | 102.2m <sup>2</sup>             |                |                         |  |                        | > 4m                    | 2                   |
| 10    | 2     |       |       |      |     |       | 86.8m <sup>2</sup>  | 52.8m <sup>2</sup>              |                |                         |  |                        | >4m                     | 2                   |
| 11    | 2     |       |       |      |     |       | 84.9m <sup>2</sup>  | 27.0m <sup>2</sup>              |                |                         |  |                        | > 4m                    | 2                   |
| 12    | 2     |       |       |      |     |       | 57.6m <sup>2</sup>  | 25.1m <sup>2</sup>              |                |                         |  |                        | >4m                     | 1                   |
| 13    | 2     |       |       |      |     |       | 82.0m <sup>2</sup>  | 38.2m <sup>2</sup>              |                |                         |  |                        | >4m                     | 2                   |
| 14    | 2     |       |       |      |     |       | 96.4m <sup>2</sup>  | 42.0m <sup>2</sup>              |                |                         |  |                        | >4m                     | 2                   |
| TOTAL |       | 1     | 13    | 14UN | ITS | 3     | 1263.9r             | $n^2$                           |                | 85.7% ( <del>12</del> ) | 92.85% ( <sup>13</sup> / <sub>14</sub> ) | 7.14% ( <del>1</del> ) |                         | 27                  |

# RETAIL

| RETAIL<br>SPACE | AREA                 | STORAGE<br>AREA    | PARKING<br>REQUIRED       | PARKING<br>PROVIDED |
|-----------------|----------------------|--------------------|---------------------------|---------------------|
| 1               | 48.89m <sup>2</sup>  | 22.6m <sup>2</sup> |                           |                     |
| 2               | 44.44m <sup>2</sup>  | 12.8m <sup>2</sup> |                           |                     |
| 3               | 44.44m <sup>2</sup>  | -                  |                           |                     |
| 4               | 44.44m <sup>2</sup>  | -                  | 1 space per               |                     |
| 5               | 49.87m <sup>2</sup>  | -                  | 30m <sup>2</sup>          |                     |
| 6               | 78.3m <sup>2</sup>   | -                  |                           |                     |
| 7               | 97.4m <sup>2</sup>   | 42.4m <sup>2</sup> |                           |                     |
| 8               | 99.4m <sup>2</sup>   | 24.4m <sup>2</sup> |                           |                     |
| 9               | 133.5m <sup>2</sup>  | -                  |                           |                     |
| TOTAL           | 640.68m <sup>2</sup> |                    | 21.3 $\binom{640.68}{30}$ | 22                  |

# PARKING

|          | UNITS | UNIT<br>VISITOR | RETAIL | TOTAL |
|----------|-------|-----------------|--------|-------|
| REQUIRED | 27    | 5               | 22     | 54    |
| PROVIDED | 27    | 5               | 22     | 54    |

| Asse   | ssor#                        | 20420                            | Cer                                  | tificate#                                | 00055063                   | 340            |              | Issued             | d: 15122         | .0          |
|--|------------------------------|----------------------------------|--------------------------------------|--|----------------------------|----------------|--------------|--------------------|------------------|-------------|
|  |                              |                                  | Therm                                | al Perform                               | ance Spe                   | cification     | s            |                    |                  |             |
| These are the Spec<br>specifications, thes<br>all instances of that<br>must be detailed be | e Specifica<br>t element fo  | tions shall ta<br>or the project | ke precedence.<br>. If alternate spe | lf only one specii<br>cifications are de | fication option is         | detailed for a | building ele | ement, that s      | specification mu | ist apply t |
| Windows  | Product                      | ID Gla                           | SS                                   | Frame                                    |                            | U value        | SHGC         | Area<br>M²         | Detail           |             |
| Single glazed  |                              | Lov                              | v e                                  | Aluminium                                |                            | 5.6            | 0.41         | 107                | As per plan      | S           |
| Skylights  | Product                      | ID Gla                           | ss                                   | Frame                                    |                            | U value        | SHGC         | Area<br>M²         | Detail           |             |
| Single glazed  |                              | Cle                              | ar                                   | Aluminium                                |                            |                |              |                    | As per plan      | s           |
| Window and skylig<br>lower, and the SHG<br>External walls<br>Brick veneer/Fra              | GC value is<br>Con           |                                  |                                      |  | d SHGC values<br>olar abs. |                |              |                    | used if their U  | value is    |
| Internal walls   | Con                          | struction                        | Insulation                           | Detail                                   |                            |                |              |                    |                  |             |
| Plasterboard   | 0011                         | diradion                         | None                                 | As per plan                              | ns.                        |                |              |                    |                  |             |
| Floors   | Con                          | struction                        | Insulation                           | Covering                                 | D                          | )<br>Detail    |              |                    |                  |             |
| Concrete   |                              |                                  | None/R2.0                            | Varies                                   | А                          | s per plans.   | Insulation   | where ca           | r park below.    |             |
| Ceilings   | Cons                         | struction                        | Insulation                           | Detail                                   |                            |                |              |                    |                  |             |
| Plasterboard   |                              |                                  | R2.5/None                            | As per plan                              | ns. Insulation             | where adjoin   | s roof/ext   | erior.             |                  |             |
| Roof   | Con                          | struction                        | Insulation                           | Colour – so                              | olar abs.                  | Petail         |              |                    |                  |             |
| Metal  |                              |                                  | Foil + R1.0                          | Medium                                   | А                          | s per plans.   |              |                    |                  |             |
| Window cover   | Inte                         | rnal (curtai                     | ns)                                  |  | External                   | (awnings, sh   | utters, et   | c)                 |                  |             |
| As plans   |                              |                                  |                                      |  | As plans                   |                |              |                    |                  |             |
| Fixed shading  |                              | es (width -<br>dows)             | inc. gutters, h                      | 't above                                 | Location                   |                |              |                    |                  |             |
| ea   | s<br>ans –<br>aves<br>offits | ·                                |                                      |  | As plans                   | – eaves/soff   | iits/louvre  | s as showi         | n                |             |
| Overshadowing  | <b>j</b> (                   | Overshado                        | wing structure                       | S  | Oversha                    | dowing trees   |              |                    |                  |             |
|  |                              |                                  |                                      |  |                            |                |              |                    |                  |             |
| Orientation, Ex  |                              |                                  |                                      | <b>on</b><br>ng area open t              | o entry:                   | Υ              | V            | entilated sl       | kvliahts:        | N           |
| Terrain category   |                              | Suburban                         |                                      | ors separate liv                         | •                          | ,<br>N         | 0            | pen fire, ui       |                  | N           |
|  |                              | Unventila                        |                                      | r open to heat                           | -                          | Y/N            |              | eat:<br>ented dowl | nliahte:         | N           |
| ROOF Ventilation   |                              | Oliveliula.                      | ica ola                              | i open to neat                           | ou aicas.                  | 1/14           | V            | crited down        | ingrito.         | 14          |
| Roof ventilation:<br>Cross ventilation   |                              | Standard                         | Sea                                  | ls to windows                            | and doors:                 | Υ              | \٨           | all and cei        | ling vents:      | N           |



| ADAM CLERKE SURVEYORS PTY LTD   | 38 KEVIN AVENUE, AVALON 2107   | 02 9918 4111   |
|---------------------------------|--|--|
| SITE IMAGE-LANSCAPE ARCHITECT   | LEVEL 1, 3-5 BAPTIST STREET REDFERN NSW 2016   | 02 8332 5600   |
| DEMLAKIAN ENGINEERING           | 5 RIDGE ST, NORTH SYDNEY NSW 2060  | 02 9955 4485   |
| TRANSPORT AND TRAFFIC PLANNING  | SUITE 502, L5 282 VICTORIA AVE, CHATSWOOD 2067   | 02 9411 5660   |
| SBMG PTY LTD                    | PO BOX 8136, GLENMORE PARK NSW 2745  | 0467 370 380   |
| ACCESSIBLE BUILDING SOLUTIONS   | 124 UPPER WASHINGTON DRIVE, BONNET BAY NSW 2226  | 02 9528 0276   |
| ASSET GEOTECHNICAL              | SUITE 2.05/56 DELHI RD, NORTH RYDE NSW 2113  | 0410 325 566   |
| DAMIAN OTOOLE TOWN PLANNING PTY | STUDIO 9,L5 35 BUCKINGHAM STREET, SURRY HILL 2010  | 0413 031 971   |
| HAMPTONS PROPERTY SERVICES      | SUITE 404, 203-233 NEW SOUTH HEAD ROAD, EDGECLIFF  | 02 9386 7009   |
| ARCHITECTURAL IMAGES            | 46/6-8 HERBERT STREET, ST LEONARDS NSW 2065  | 02 9460 8943   |
| DIX GARDNER GROUP               | LEVEL 4, 155 CASTELREAGH ST, SYDNEY NSW 2000   | 0428 281 188   |
| DAMIAN GREEN                    |  | 0450 575 677   |
|                                 | SITE IMAGE-LANSCAPE ARCHITECT DEMLAKIAN ENGINEERING TRANSPORT AND TRAFFIC PLANNING SBMG PTY LTD ACCESSIBLE BUILDING SOLUTIONS ASSET GEOTECHNICAL DAMIAN OTOOLE TOWN PLANNING PTY HAMPTONS PROPERTY SERVICES ARCHITECTURAL IMAGES DIX GARDNER GROUP | SITE IMAGE-LANSCAPE ARCHITECT  DEMLAKIAN ENGINEERING  TRANSPORT AND TRAFFIC PLANNING  SUITE 502, L5 282 VICTORIA AVE, CHATSWOOD 2067  SBMG PTY LTD  PO BOX 8136, GLENMORE PARK NSW 2745  ACCESSIBLE BUILDING SOLUTIONS  ASSET GEOTECHNICAL  DAMIAN OTOOLE TOWN PLANNING PTY  HAMPTONS PROPERTY SERVICES  ARCHITECTURAL IMAGES  DIX GARDNER GROUP  LEVEL 1, 3-5 BAPTIST STREET REDFERN NSW 2016  5 RIDGE ST, NORTH SYDNEY NSW 2060  SUITE 502, L5 282 VICTORIA AVE, CHATSWOOD 2067  PO BOX 8136, GLENMORE PARK NSW 2745  124 UPPER WASHINGTON DRIVE, BONNET BAY NSW 2226  SUITE 2.05/56 DELHI RD, NORTH RYDE NSW 2113  STUDIO 9,L5 35 BUCKINGHAM STREET, SURRY HILL 2010  HAMPTONS PROPERTY SERVICES  SUITE 404, 203-233 NEW SOUTH HEAD ROAD, EDGECLIFF  46/6-8 HERBERT STREET, ST LEONARDS NSW 2065  DIX GARDNER GROUP  LEVEL 4, 155 CASTELREAGH ST, SYDNEY NSW 2000 |





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 06
 20.12.15
 DA ISSUE

 05
 20.12.15
 DA ISSUE

 04
 20.11.23
 ISSUED TO COUNCIL

 03
 20.06.19
 REVISED ISSUED

 02
 20.30.06
 ISSUED TO COUNCIL
 19.10.15 DA ISSUE


DEVELOPMENT LINK


MIXED USE DEVELOPMENT

351-353 BARRENJOEY ROAD, NEWPORT NSW 2106

COVERSHEET SCHEDULE SCALE N/A APPROVED DRAWN MT CHECKED PG DATE JAN 2019



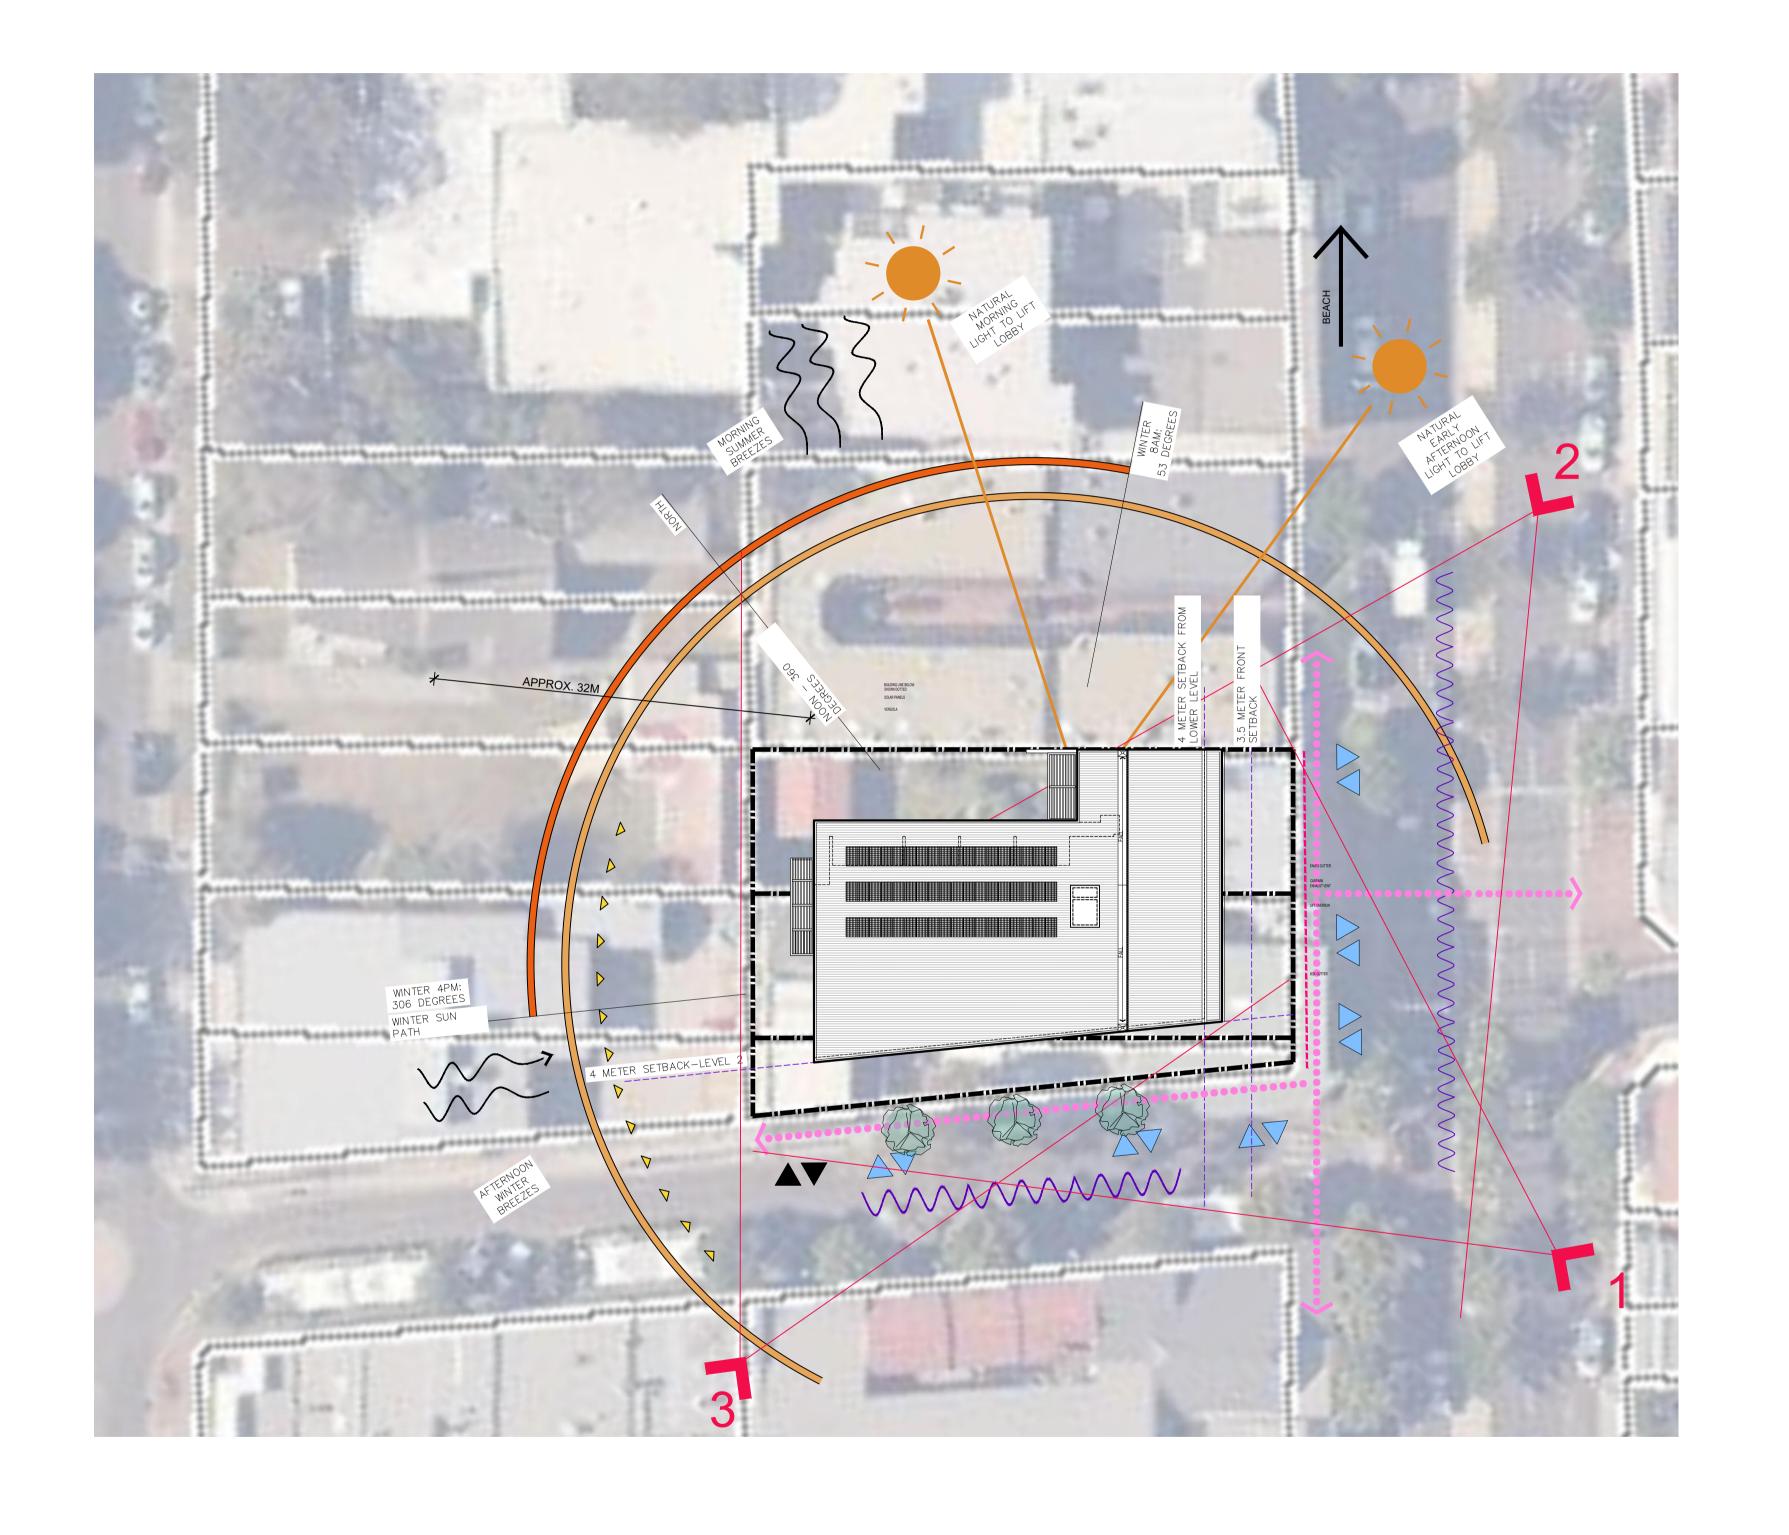

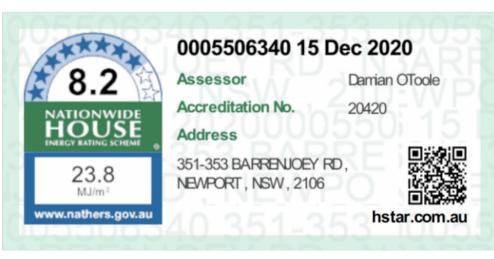



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20.03.06 ISSUED TO COUNCIL

19.10.15 DA ISSUE

ISSUE DATE AMENDMENTS

 
 20.12.15
 DA ISSUE

 20.12.15
 DA ISSUE

 20.11.23
 ISSUED TO COUNCIL
 3 20.06.19 REVISED ISSUED

PROJECT MIXED USE DEVELOPMENT

351-353 BARRENJOEY ROAD, NEWPORT NSW 2106

LOT 65 & 66 SEC 5 DP 6248

SITE ANALYSIS

SCALE N/A APPROVED DRAWN MT CHECKED PG DATE JAN 2019 STATUS DA



## Schedule of BASIX commitments

1. Commitments for Residential flat buildings - Mixed Use Building

(a) Dwellings

(i) Water (ii) Energy

(iii) Thermal Comfort (b) Common areas and central systems/facilities

(i) Water (ii) Energy

2. Commitments for multi-dwelling houses

Commitments for single dwelling houses

4. Commitments for common areas and central systems/facilities for the development (non-building specific)

(i) Water (ii) Energy

BASIX Planning, Industry & Environment www.basix.nsw.gov.au Version: 3.0 / DARWINIA\_3\_15\_1 Certificate No.: 1044257M\_02 Tuesday, 15 December 2020

#### Schedule of BASIX commitments

The commitments set out below regulate how the proposed development is to be carried out. It is a condition of any development consent granted, or complying development certificate issued, for the proposed development, that BASIX commitments be complied with.

#### 1. Commitments for Residential flat buildings - Mixed Use Building

#### (a) Dwellings

| (i) Water  | Show on<br>DA plans | Show on CC/CDC plans & specs | Certifier check |
|--|---------------------|------------------------------|-----------------|
| (a) The applicant must comply with the commitments listed below in carrying out the development of a dwelling listed in a table below.   |                     |                              |                 |
| (b) The applicant must plant indigenous or low water use species of vegetation throughout the area of land specified for the dwelling in the "Indigenous species" column of the table below, as private landscaping for that dwelling. (This area of indigenous vegetation is to be contained within the "Area of garden and lawn" for the dwelling specified in the "Description of Project" table).          | ~                   | ~                            |                 |
| (c) If a rating is specified in the table below for a fixture or appliance to be installed in the dwelling, the applicant must ensure that each such fixture and appliance meets the rating specified for it.  |                     | ~                            | V               |
| (d) The applicant must install an on demand hot water recirculation system which regulates all hot water use throughout the dwelling, where indicated for a dwelling in the "HW recirculation or diversion" column of the table below.   |                     | ~                            | ~               |
| (e) The applicant must install:  |                     |                              |                 |
| (aa) a hot water diversion system to all showers, kitchen sinks and all basins in the dwelling, where indicated for a dwelling in the "HW recirculation or diversion" column of the table below; and   |                     | ~                            | ~               |
| (bb) a separate diversion tank (or tanks) connected to the hot water diversion systems of at least 100 litres. The applicant<br>must connect the hot water diversion tank to all toilets in the dwelling.  |                     | ~                            | V               |
| (e) The applicant must not install a private swimming pool or spa for the dwelling, with a volume exceeding that specified for it in the table below.  | V                   | ~                            |                 |
| (f) If specified in the table, that pool or spa (or both) must have a pool cover or shading (or both).   |                     | V                            |                 |
| (g) The pool or spa must be located as specified in the table.   | V                   | V                            |                 |
| (h) The applicant must install, for the dwelling, each alternative water supply system, with the specified size, listed for that dwelling in<br>the table below. Each system must be configured to collect run-off from the areas specified (excluding any area which supplies<br>any other alternative water supply system), and to divert overflow as specified. Each system must be connected as specified. | ~                   | ~                            | ~               |

BASIX Planning, Industry & Environment www.basix.nsw.gov.au Version: 3.0 / DARWINIA\_3\_15\_1 Certificate No.: 1044257M\_02 Tuesday, 15 December 2020

3 star (> 4 star 4 star 4 star 4 star dwellings 4.5 but

|              |                                  |       | Alter         | native water source     |                       |                       |                |            |
|--------------|----------------------------------|-------|---------------|-------------------------|-----------------------|-----------------------|----------------|------------|
| Dwelling no. | Alternative water supply systems | Size  | Configuration | Landscape<br>connection | Toilet connection (s) | Laundry<br>connection | Pool<br>top-up | Spa top-up |
| None         | R#S                              | [r46] | -             | (+)                     | 1+3                   |                       | (4)            | 1=         |

| ii) Energy   | Show on<br>DA plans | Show on CC/CDC plans & specs | Certifier check |
|--|---------------------|------------------------------|-----------------|
| (a) The applicant must comply with the commitments listed below in carrying out the development of a dwelling listed in a table below.   |                     |                              |                 |
| (b) The applicant must install each hot water system specified for the dwelling in the table below, so that the dwelling's hot water is<br>supplied by that system. If the table specifies a central hot water system for the dwelling, then the applicant must connect that<br>central system to the dwelling, so that the dwelling's hot water is supplied by that central system.   | ~                   | ~                            | ~               |
| (c) The applicant must install, in each bathroom, kitchen and laundry of the dwelling, the ventilation system specified for that room in the table below. Each such ventilation system must have the operation control specified for it in the table.  |                     | ~                            | V               |
| (d) The applicant must install the cooling and heating system/s specified for the dwelling under the "Living areas" and "Bedroom areas" headings of the "Cooling" and "Heating" columns in the table below, in/for at least 1 living/bedroom area of the dwelling. If no cooling or heating system is specified in the table for "Living areas" or "Bedroom areas", then no systems may be installed in any such areas. If the term "zoned" is specified beside an air conditioning system, then the system must provide for day/night zoning between living areas and bedrooms.   |                     | ~                            | ~               |
| (e) This commitment applies to each room or area of the dwelling which is referred to in a heading to the "Artificial lighting" column of<br>the table below (but only to the extent specified for that room or area). The applicant must ensure that the "primary type of artificial<br>lighting" for each such room in the dwelling is fluorescent lighting or light emitting diode (LED) lighting. If the term "dedicated" is<br>specified for a particular room or area, then the light fittings in that room or area must only be capable of being used for<br>fluorescent lighting or light emitting diode (LED) lighting. |                     | _                            | ~               |

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| ii) Energy  | Show on<br>DA plans | Show on CC/CDC plans & specs | Certifier check |
|---|---------------------|------------------------------|-----------------|
| (f) This commitment applies to each room or area of the dwelling which is referred to in a heading to the "Natural lighting" column of<br>the table below (but only to the extent specified for that room or area). The applicant must ensure that each such room or area is<br>fitted with a window and/or skylight. | ~                   | ~                            | ~               |
| (g) This commitment applies if the applicant installs a water heating system for the dwelling's pool or spa. The applicant must:  |                     |                              |                 |
| (aa) install the system specified for the pool in the "Individual Pool" column of the table below (or alternatively must not install<br>any system for the pool). If specified, the applicant must install a timer, to control the pool's pump; and   |                     | ~                            |                 |
| (bb) install the system specified for the spa in the "Individual Spa" column of the table below (or alternatively must not install<br>any system for the spa). If specified, the applicant must install a timer to control the spa's pump.  |                     | ~                            |                 |
| (h) The applicant must install in the dwelling:   |                     |                              |                 |
| (aa) the kitchen cook-top and oven specified for that dwelling in the "Appliances & other efficiency measures" column of the<br>table below;  |                     | ~                            |                 |
| (bb) each appliance for which a rating is specified for that dwelling in the "Appliances & other efficiency measures" column of the table, and ensure that the appliance has that minimum rating; and   |                     | V                            | V               |
| (cc) any clothes drying line specified for the dwelling in the "Appliances & other efficiency measures" column of the table.  | 3:                  | V                            |                 |
| (i) If specified in the table, the applicant must carry out the development so that each refrigerator space in the dwelling is "well ventilated".   |                     | -                            |                 |

|                  | Hot water                   | Bathroom ver                             | ntilation system     | Kitchen vent                                | n ventilation system Laundry ventilation system |  |                     |
|------------------|-----------------------------|--|----------------------|---|---|--|---------------------|
| Dwelling<br>no.  | Hot water system            | Each bathroom                            | Operation control    | Each kitchen                                | Operation control                               | Each laundry                             | Operation control   |
| All<br>dwellings | gas instantaneous 5<br>star | individual fan, ducted to façade or roof | manual switch on/off | individual fan, ducted<br>to façade or roof | manual switch on/off                            | individual fan, ducted to façade or roof | manual switch on/of |

|                 | Coo   | ling             | Hea   | ting             | T.                               |  | Artificia       | al lighting                  |                 |                 | Natural lig                            | hting          |
|-----------------|---|------------------|---|------------------|----------------------------------|--|-----------------|------------------------------|-----------------|-----------------|--|----------------|
| Dwelling<br>no. | living areas                                | bedroom<br>areas | living areas                                | bedroom<br>areas | No. of<br>bedrooms<br>&/or study | No. of<br>living &/or<br>dining<br>rooms | Each<br>kitchen | All<br>bathrooms/<br>toilets | Each<br>laundry | All<br>hallways | No. of<br>bathrooms<br>&/or<br>toilets | Main<br>kitche |
|                 | 1-phase<br>airconditioning<br>EER 3.0 - 3.5 | -                | 1-phase<br>airconditioning<br>EER 3.0 - 3.5 | *                | 3                                | 1  | yes             | yes                          | yes             | yes             | 0                                      | yes            |
|                 | 1-phase<br>airconditioning<br>EER 3.0 - 3.5 | 2                | 1-phase<br>airconditioning<br>EER 3.0 - 3.5 | •:               | 1                                | 1  | yes             | yes                          | yes             | yes             | 0                                      | yes            |
|                 | 1-phase<br>airconditioning<br>EER 3.0 - 3.5 | •                | 1-phase<br>airconditioning<br>EER 3.0 - 3.5 | *                | 2                                | 1  | yes             | yes                          | yes             | yes             | 0                                      | yes            |

|                  | individual p           | 001          | individual s          | pa    |                             |              | Appliance                             | es & otner emic | iency meas        | ures             |  |  |
|------------------|------------------------|--------------|-----------------------|-------|-----------------------------|--------------|---------------------------------------|-----------------|-------------------|------------------|--|--|
| Dwelling<br>no.  | Pool heating<br>system | Timer        | Spa heating<br>system | Timer | Kitchen<br>cooktop/oven     | Refrigerator | Well<br>ventilated<br>fridge<br>space | Dishwasher      | Clothes<br>washer | Clothes<br>dryer | Indoor or<br>sheltered<br>clothes<br>drying line | Private<br>outdoor or<br>unsheltered<br>clothes<br>drying line |
| All<br>dwellings |                        | 1556<br>1556 | -                     | 2     | gas cooktop & electric oven | in .         | no                                    | 4.5 star        | 1 ± 1             | 2 star           | yes  | yes  |

| iii) Thermal Comfort   | Show on<br>DA plans | Show on CC/CDC plans & specs | Certifier check |
|--|---------------------|------------------------------|-----------------|
| (a) The applicant must attach the certificate referred to under "Assessor details" on the front page of this BASIX certificate (the "Assessor Certificate") to the development application and construction certificate application for the proposed development (or, if the applicant is applying for a complying development certificate for the proposed development, to that application). The applicant must also attach the Assessor Certificate to the application for a final occupation certificate for the proposed development. |                     |                              |                 |
| (b) The Assessor Certificate must have been issued by an Accredited Assessor in accordance with the Thermal Comfort Protocol.  |                     |                              |                 |
| (c) The details of the proposed development on the Assessor Certificate must be consistent with the details shown in this BASIX Certificate, including the details shown in the "Thermal Loads" table below.   |                     |                              |                 |

| -     |                                  |                      |                                |                              |                           |
|-------|----------------------------------|----------------------|--------------------------------|------------------------------|---------------------------|
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| iii) Thermal Comfort   | Show on<br>DA plans | Show on CC/CDC plans & specs | Certifie<br>check |
|--|---------------------|------------------------------|-------------------|
| (d) The applicant must show on the plans accompanying the development application for the proposed development, all matters<br>which the Thermal Comfort Protocol requires to be shown on those plans. Those plans must bear a stamp of endorsement from<br>the Accredited Assessor, to certify that this is the case.                       | ~                   |                              |                   |
| (e) The applicant must show on the plans accompanying the application for a construction certificate (or complying development<br>certificate, if applicable), all thermal performance specifications set out in the Assessor Certificate, and all aspects of the proposed<br>development which were used to calculate those specifications. |                     | ~                            |                   |
| (f) The applicant must construct the development in accordance with all thermal performance specifications set out in the Assessor<br>Certificate, and in accordance with those aspects of the development application or application for a complying development<br>certificate which were used to calculate those specifications.          |                     | ~                            | ~                 |
| (g) Where there is an in-slab heating or cooling system, the applicant must:   | ~                   | ~                            | V                 |
| <ul><li>(aa) Install insulation with an R-value of not less than 1.0 around the vertical edges of the perimeter of the slab; or</li></ul>  |                     |                              |                   |
| (bb) On a suspended floor, install insulation with an R-value of not less than 1.0 underneath the slab and around the vertical<br>edges of the perimeter of the slab.  |                     |                              |                   |
| (h) The applicant must construct the floors and walls of the development in accordance with the specifications listed in the table<br>below.   | ~                   | V                            | -                 |

|              |  | Thermal loads                            |
|--------------|--|--|
| Dwelling no. | Area adjusted heating load (in mJ/m²/yr) | Area adjusted cooling load (in mJ/m²/yr) |
| 1            | 12.0                                     | 20.0                                     |
| 2            | 13,0                                     | 26.0                                     |
| 3            | 9.0                                      | 22.0                                     |
| 4            | 2.0                                      | 25.0                                     |
| 5            | 16.0                                     | 23.0                                     |
| 6            | 5.0                                      | 26.0                                     |
| 7            | 3.0                                      | 20.0                                     |
| 8            | 2.0                                      | 29.0                                     |
| 9            | 5.0                                      | 21.0                                     |

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MIXED USE DEVELOPMENT 351-353 BARRENJOEY ROAD, NEWPORT NSW 2106

APPROVED DRAWN MT CHECKED PG DATE JAN 2019 PROJECT NUMBER DRAWING NUMBER

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|                     |  | Thermal loads                            |
|---------------------|--|--|
| Dwelling no.        | Area adjusted heating load (in mJ/m²/yr) | Area adjusted cooling load (in mJ/m²/yr) |
| 10                  | 6.0                                      | 22.0                                     |
| 11                  | 16.0                                     | 27.0                                     |
| 12                  | 19.0                                     | 22.0                                     |
| 13                  | 11.0                                     | 25.0                                     |
| All other dwellings | 7.0                                      | 28.0                                     |

| (i) Water                       |   |   |   |           | Show on<br>DA plans | Show on CC/CD<br>plans & specs |
|---------------------------------|---|---|---|-----------|---------------------|--------------------------------|
| (a) If, in carrying item must m | g out the development, the appl<br>neet the specifications listed for | icant installs a showerhead, toilet, ta<br>it in the table. | p or clothes washer into a common area,   | then that |                     | ~                              |
|                                 | stems" column of the table below                                      |   | ternative water supply system(s) specified<br>sized, be configured, and be connected, |           | ~                   | ~                              |
| (c) A swimming table.           | pool or spa listed in the table m                                     | oust not have a volume (in kLs) great                       | er than that specified for the pool or spa  | in the    | ~                   | ~                              |
| (d) A pool or sp                | a listed in the table must have a                                     | cover or shading if specified for the                       | pool or spa in the table.   |           |                     | V                              |
| (e) The applica                 | nt must install each fire sprinkle                                    | r system listed in the table so that the                    | e system is configured as specified in the  | table.    |                     | ~                              |
| (f) The applican                | nt must ensure that the central o                                     | ooling system for a cooling tower is o                      | configured as specified in the table.   |           |                     | ~                              |
|                                 |   |   |   | -         |                     |                                |
| Common area                     | Showerheads rating  | Toilets rating  | Taps rating   | Clo       | thes was her        | s rating                       |
| All common<br>areas             | no common facility  | no common facility  | no common facility  | no o      | common laun         | dry facility                   |

| i) Energy  | Show on<br>DA plans | Show on CC/CDC plans & specs | Certifier<br>check |
|--|---------------------|------------------------------|--------------------|
| (a) If, in carrying out the development, the applicant installs a ventilation system to service a common area specified in the table<br>below, then that ventilation system must be of the type specified for that common area, and must meet the efficiency measure<br>specified.   |                     | ~                            | ~                  |
| (b) In carrying out the development, the applicant must install, as the "primary type of artificial lighting" for each common area<br>specified in the table below, the lighting specified for that common area. This lighting must meet the efficiency measure specified.<br>The applicant must also install a centralised lighting control system or Building Management System (BMS) for the common area,<br>where specified. |                     | ~                            | ~                  |
| (c) The applicant must install the systems and fixtures specified in the "Central energy systems" column of the table below. In each case, the system or fixture must be of the type, and meet the specifications, listed for it in the table.   | -                   | ~                            | V                  |

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|                       | Common area               | ventilation system                       |                                     | Common area lighting          |                             |
|-----------------------|---------------------------|--|-------------------------------------|-------------------------------|-----------------------------|
| Common area           | Ventilation system type   | Ventilation efficiency measure           | Primary type of artificial lighting | Lighting efficiency measure   | Lighting control system/BMS |
| Car park area         | ventilation supply only   | carbon monoxide monitor +<br>2-speed fan | fluorescent                         | time clocks                   | No                          |
| Lift car (No.1)       | ·50                       | ā  | compact fluorescent                 | connected to lift call button | No                          |
| Garbage room          | ventilation supply only   | -  | fluorescent                         | manual on / manual off        | No                          |
| Plant or service room | no mechanical ventilation | -  | fluorescent                         | manual on / manual off        | No                          |
| Lobby                 | ventilation supply only   | time clock or BMS controlled             | compact fluorescent                 | motion sensors                | No                          |

| Central energy systems             | Туре                                | Specification               |                              |                           |         |
|------------------------------------|-------------------------------------|-----------------------------|------------------------------|---------------------------|---------|
| Lift (No. 1)                       | gearless traction with \<br>F motor | / V V Number of levels (inc | luding basement): 5          |                           |         |
|                                    | "                                   | •                           |                              |                           |         |
|                                    |                                     |                             |                              |                           |         |
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| i) Water   |   |  |  | Show on<br>DA plans              | Show on CC/CDC plans & specs | Certifier check |
|--|---|--|--|----------------------------------|------------------------------|-----------------|
| (a) If, in carryin<br>item must r  | ng out the development, the appl<br>meet the specifications listed for  | icant installs a showerhead, toilet, tap<br>it in the table.   | o or clothes washer into a common area, then the   | at                               | V                            | -               |
|  | stems" column of the table below  |  | ernative water supply system(s) specified in the<br>sized, be configured, and be connected, as | ~                                | ~                            | ~               |
| (c) A swimming table.  | g pool or spa listed in the table m   | nust not have a volume (in kLs) greate   | er than that specified for the pool or spa in the  | v                                | V                            |                 |
| (d) A pool or sp   | oa listed in the table must have a  | cover or shading if specified for the  | pool or spa in the table.  |                                  | ~                            |                 |
| (e) The applica  | nt must install each fire sprinkle  | r system listed in the table so that the   | system is configured as specified in the table.  |                                  | V                            | -               |
| (f) The applica  | 7. 7. 7. 7. 7. 7. 7. 7. 7. 7. 7. 7. 7. 7  |  |  |                                  |                              |                 |
| (i) The applical   | nt must ensure that the central o   | ooling system for a cooling tower is c   | onfigured as specified in the table.   |                                  | ~                            | V               |
| (і) тне аррісаі  | nt must ensure that the central c   | ooling system for a cooling tower is c   | onfigured as specified in the table.   |                                  | ~                            | ~               |
| 08 11001   | nt must ensure that the central o   | ooling system for a cooling tower is c   | onfigured as specified in the table.  Taps rating  | Clothes washer                   | s rating                     | ~               |
| Common area  |   |  |  | Clothes washer<br>no common laun | 51/22/18 of                  | _               |
| Common area<br>All common<br>areas   | Showerheads rating  | Toilets rating   | Taps rating  |                                  | 51/22/18 of                  | Certifier       |
| Common area All common areas  ii) Energy  (a) If, in carryin   | Showerheads rating no common facility   | Toilets rating no common facility icant installs a ventilation system to s   | Taps rating  | no common laun                   | Show on CC/CDC               | 777777777       |
| Common area All common areas  (ii) Energy  (a) If, in carryin below, then specified.  (b) In carrying specified in | Showerheads rating no common facility  ag out the development, the application that ventilation system must be out the development, the application that table below, the lighting spears must also install a centralised | no common facility  icant installs a ventilation system to so the type specified for that common ant must install, as the "primary type of cified for that common area. This light | Taps rating no common facility service a common area specified in the table                    | Show on DA plans                 | Show on CC/CDC               | 777777777       |

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| Central energy systems   | Туре                     | Specification               |                              |                           |  |
|--|--------------------------|-----------------------------|------------------------------|---------------------------|--|
| Alternative energy supply                                      | Photovoltaic system      | Rated electrical outp       | ut (min): 15.0 peak kW       |                           |  |
|  |                          |                             |                              |                           |  |
|  |                          |                             |                              |                           |  |
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| (a) (a) (a) (a) (a) (a) (b) (b) (b) (b) (b) (b) (b) (b) (b) (b |                          |                             |                              |                           | The state of the s |

| 1. In                               | hese commitments, "applicant" means the person carrying out the development.  |
|-------------------------------------|---|
| S                                   | e applicant must identify each dwelling, building and common area listed in this certificate, on the plans accompanying any development application, and on the plans and ecifications accompanying the application for a construction certificate / complying development certificate, for the proposed development, using the same identifying letter or ference as is given to that dwelling, building or common area in this certificate.   |
| re                                  | s note applies if the proposed development involves the erection of a building for both residential and non-residential purposes (or the change of use of a building for both sidential and non-residential purposes). Commitments in this certificate which are specified to apply to a "common area" of a building or the development, apply only to that part of a building or development to be used for residential purposes.  |
| 4. If t                             | nis certificate lists a central system as a commitment for a dwelling or building, and that system will also service any other dwelling or building within the development, then that stem need only be installed once (even if it is separately listed as a commitment for that other dwelling or building).   |
| 5. If a                             | star or other rating is specified in a commitment, this is a minimum rating.  |
| N                                   | alternative water systems to be installed under these commitments (if any), must be installed in accordance with the requirements of all applicable regulatory authorities. NOTE: SW Health does not recommend that stormwater, recycled water or private dam water be used to irrigate edible plants which are consumed raw, or that rainwater be used for iman consumption in areas with potable water supply.  |
| 1. Co<br>de<br>2. Co                | mmitments identified with a " " in the "Show on DA plans" column must be shown on the plans accompanying the development application for the proposed development (if a evelopment application is to be lodged for the proposed development).  "mmitments identified with a " " in the "Show on CC/CDC plans and specs" column must be shown in the plans and specifications accompanying the application for a construction  |
| 1. Co<br>de<br>2. Co                | mmitments identified with a " " in the "Show on DA plans" column must be shown on the plans accompanying the development application for the proposed development (if a evelopment application is to be lodged for the proposed development).  Immitments identified with a " " in the "Show on CC/CDC plans and specs" column must be shown in the plans and specifications accompanying the application for a construction of the proposed development.   |
| 2. Co<br>ce<br>3. Co                | mmitments identified with a " " in the "Show on DA plans" column must be shown on the plans accompanying the development application for the proposed development (if a evelopment application is to be lodged for the proposed development).  "mmitments identified with a " " in the "Show on CC/CDC plans and specs" column must be shown in the plans and specifications accompanying the application for a construction  |
| 1. Co<br>de<br>2. Co<br>ce<br>3. Co | mmitments identified with a " " in the "Show on DA plans" column must be shown on the plans accompanying the development application for the proposed development (if a evelopment application is to be lodged for the proposed development).  Immitments identified with a " " in the "Show on CC/CDC plans and specs" column must be shown in the plans and specifications accompanying the application for a construction entificate / complying development certificate for the proposed development.  Immitments identified with a " " in the "Certifier check" column must be certified by a certifying authority as having been fulfilled. (Note: a certifying authority must not issue an accupation certificate (either interim or final) for a building listed in this certificate, or for any part of such a building, unless it is satisfied that each of the commitments whose fulfilments.  |
| 1. Co<br>de<br>2. Co<br>ce<br>3. Co | mmitments identified with a " " in the "Show on DA plans" column must be shown on the plans accompanying the development application for the proposed development (if a evelopment application is to be lodged for the proposed development).  Immitments identified with a " " in the "Show on CC/CDC plans and specs" column must be shown in the plans and specifications accompanying the application for a construction entificate / complying development certificate for the proposed development.  Immitments identified with a " " in the "Certifier check" column must be certified by a certifying authority as having been fulfilled. (Note: a certifying authority must not issue an accupation certificate (either interim or final) for a building listed in this certificate, or for any part of such a building, unless it is satisfied that each of the commitments whose fulfillments. |

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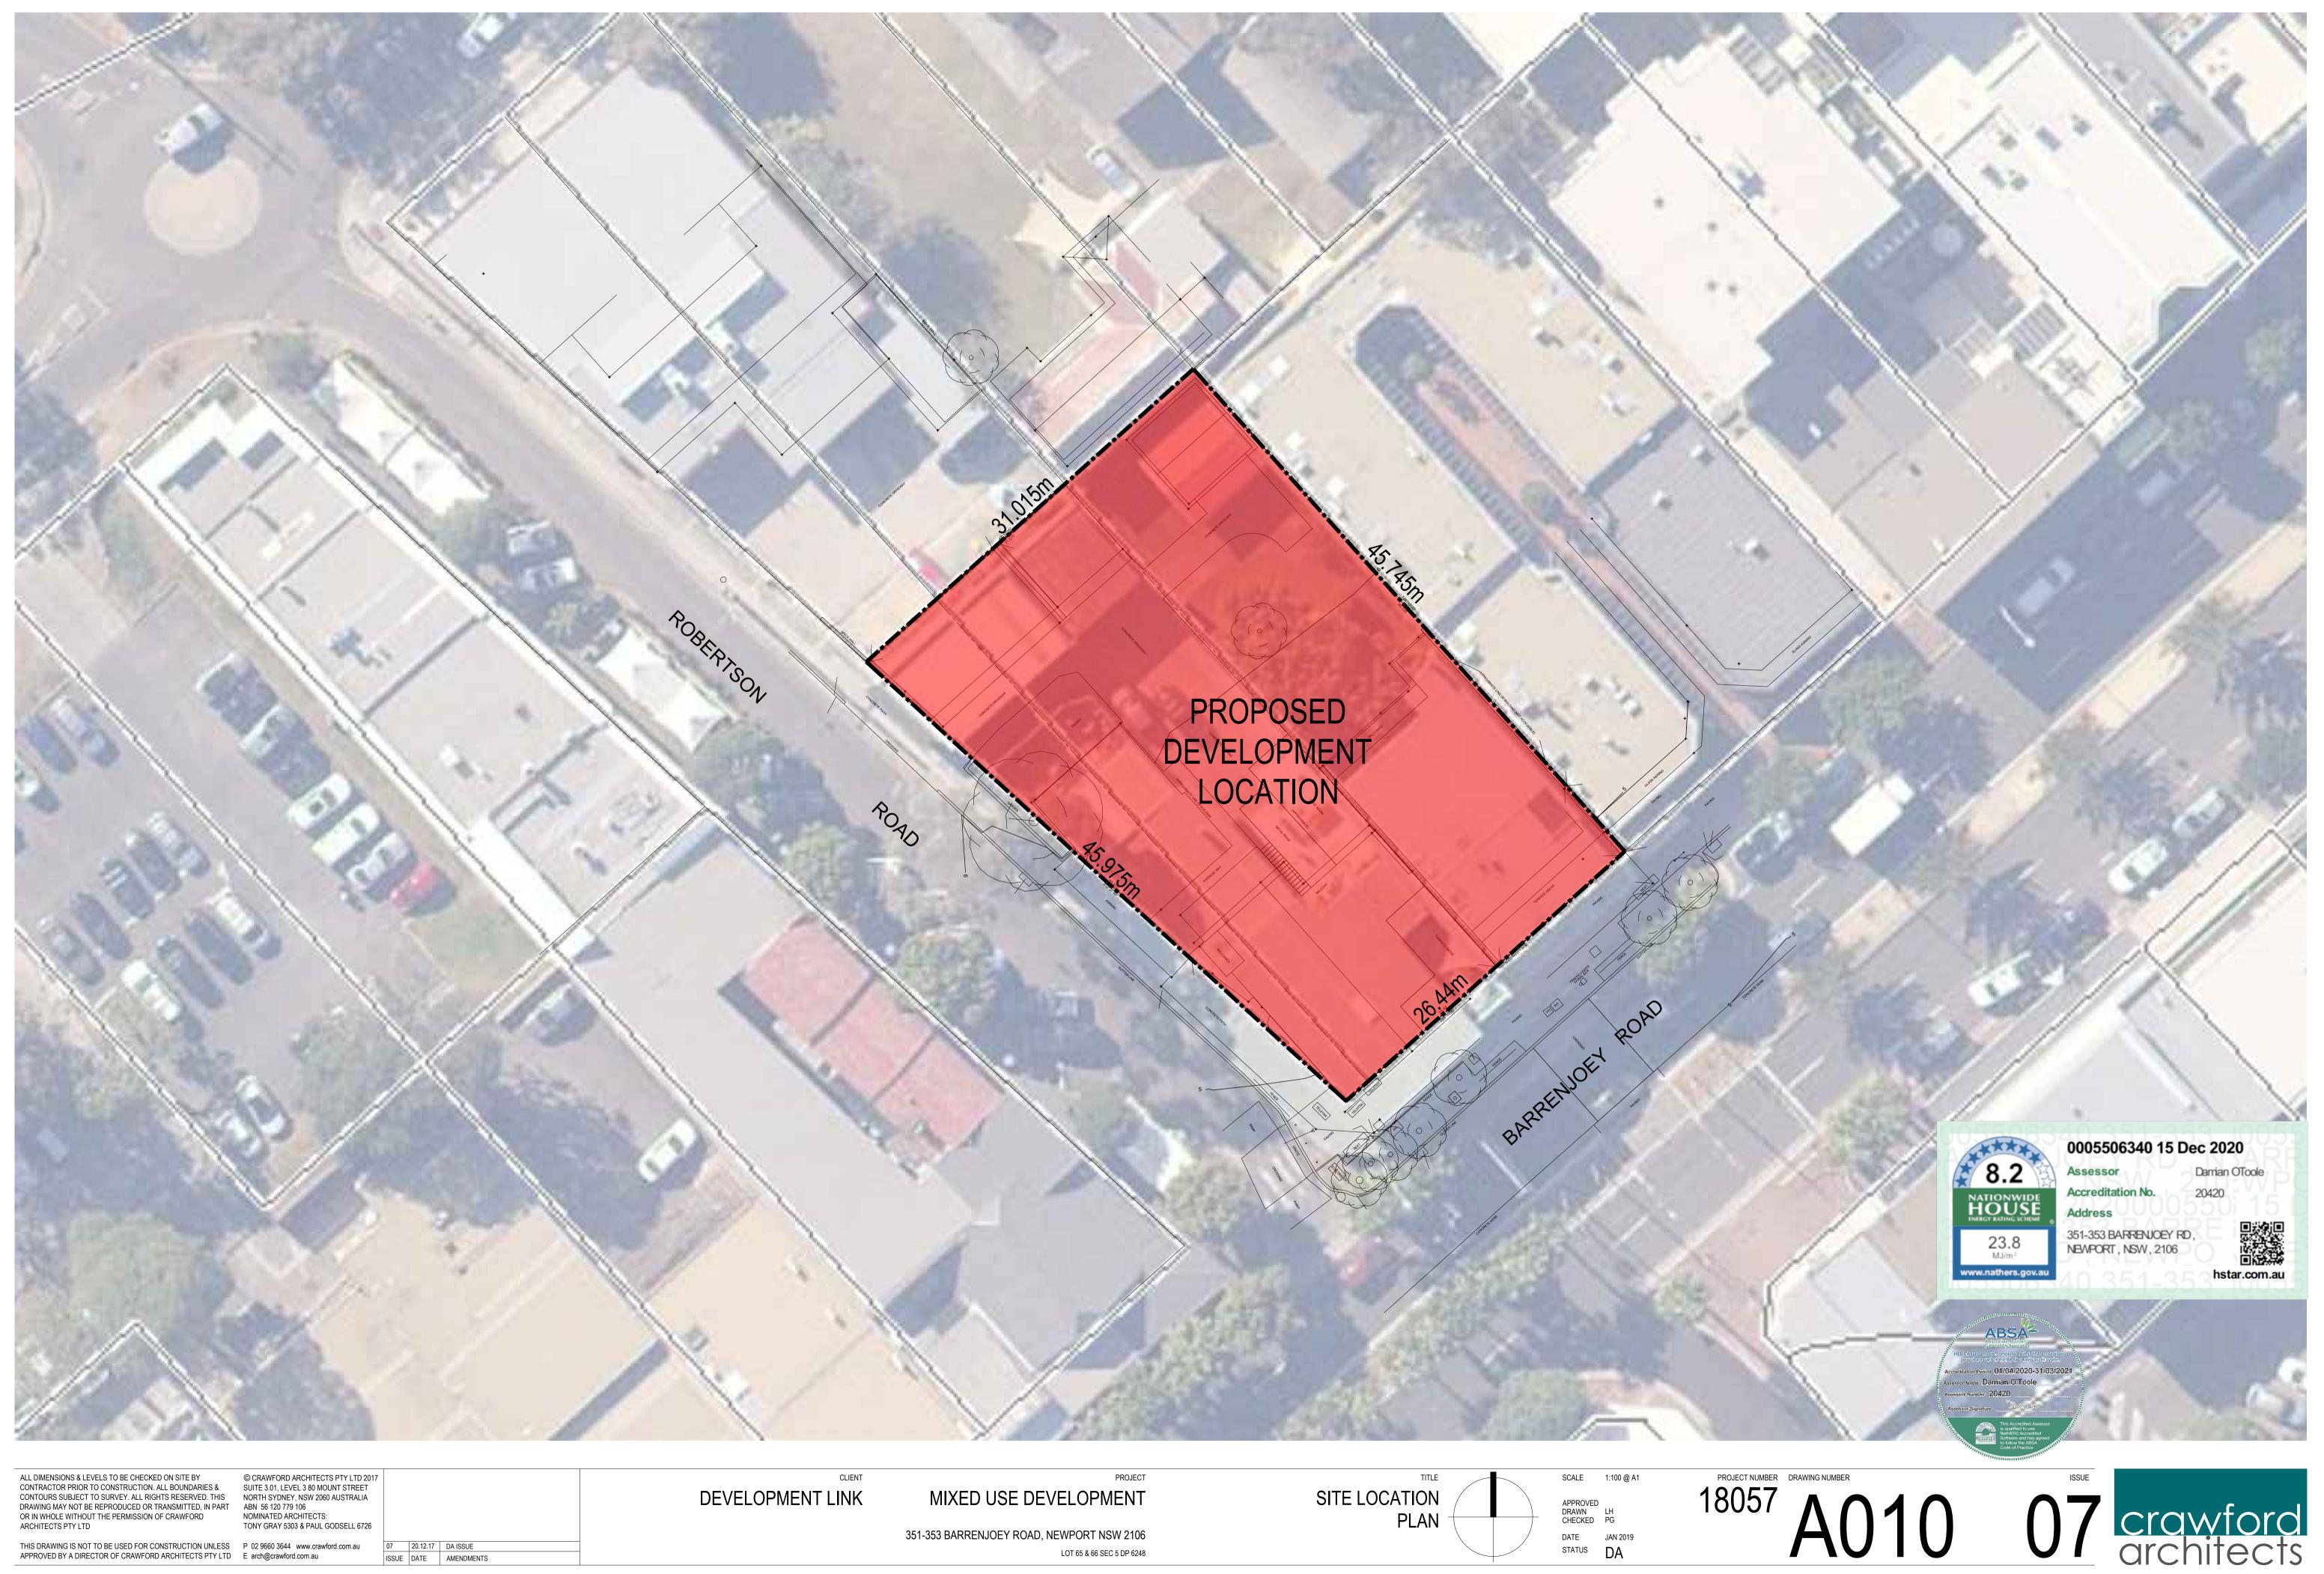
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MIXED USE DEVELOPMENT 351-353 BARRENJOEY ROAD, NEWPORT NSW 2106

LOT 65 & 66 SEC 5 DP 6248

TITLE BASIX SHEET 02


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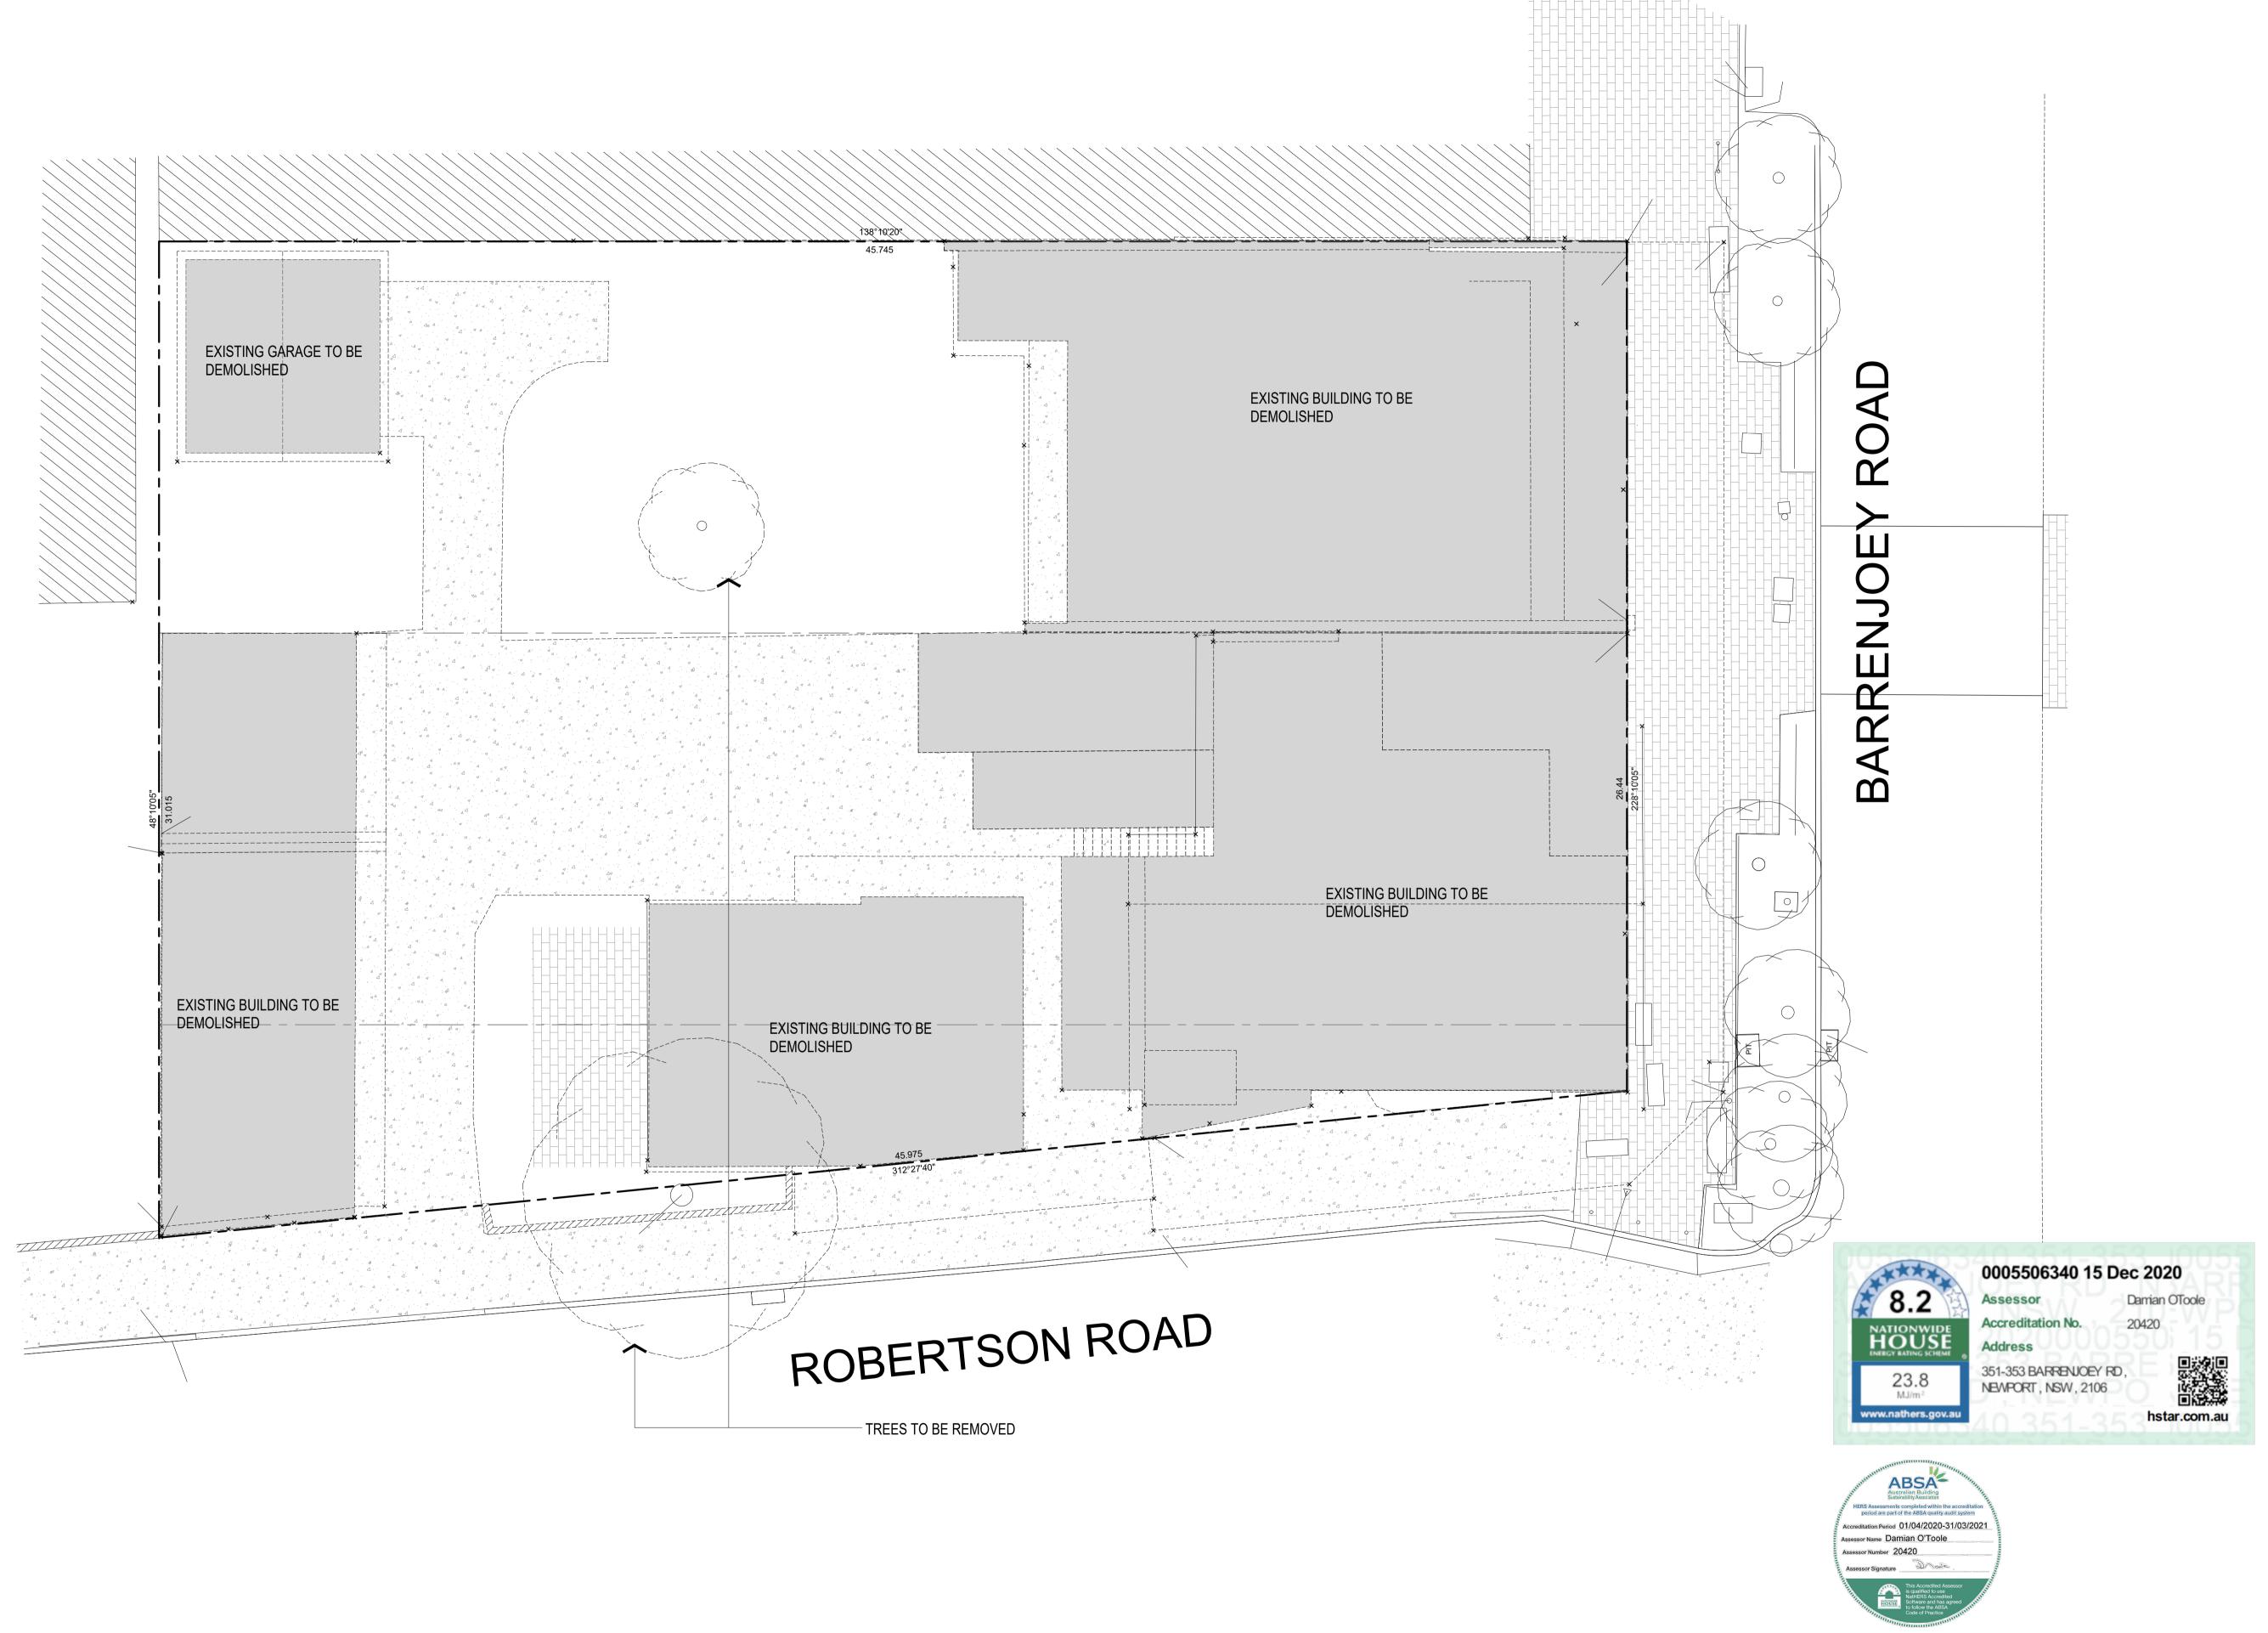
351-353 BARRENJOEY ROAD, NEWPORT NSW 2106 LOT 65 & 66 SEC 5 DP 6248



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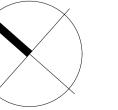
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20.12.15 DA ISSUE 20.11.23 ISSUED TO COUNCIL 20.06.19 REVISED ISSUED 20.03.06 ISSUED TO COUNCIL 19.10.15 DA ISSUE ISSUE DATE AMENDMENTS

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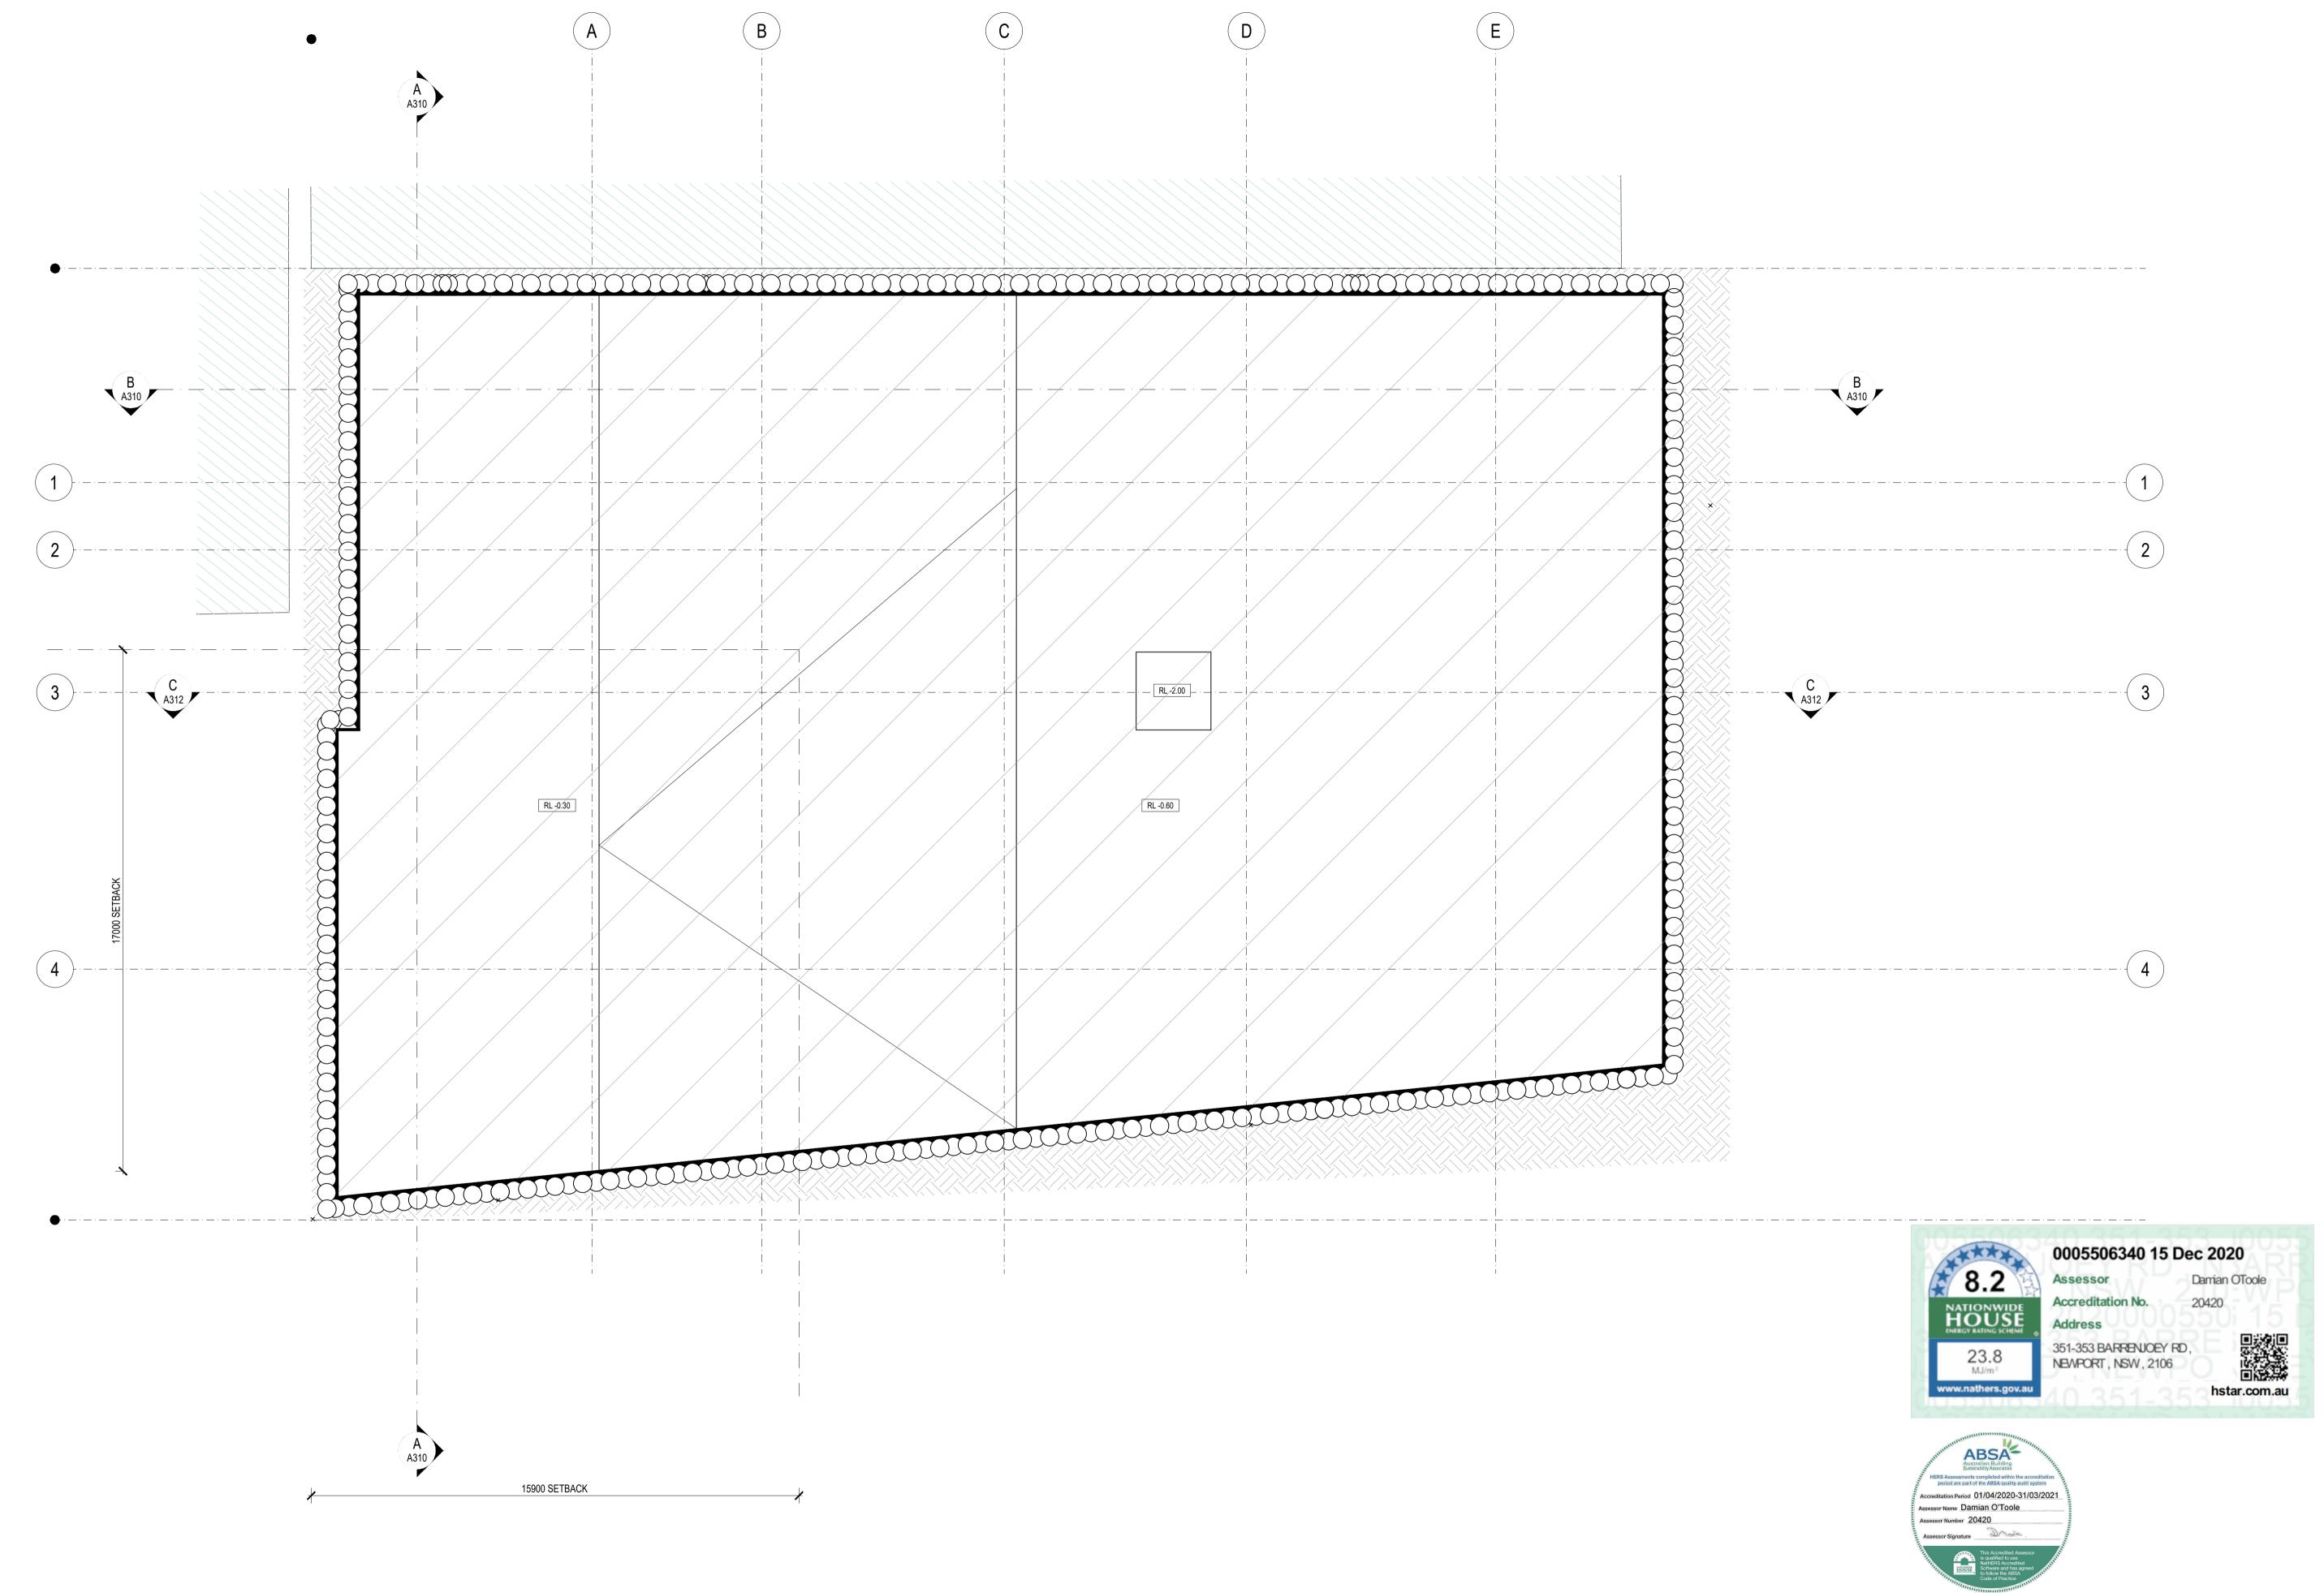
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LOT 65 & 66 SEC 5 DP 6248

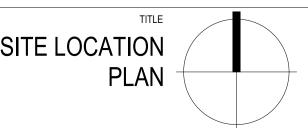

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 19.10.15 DA ISSUE

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DEVELOPMENT LINK

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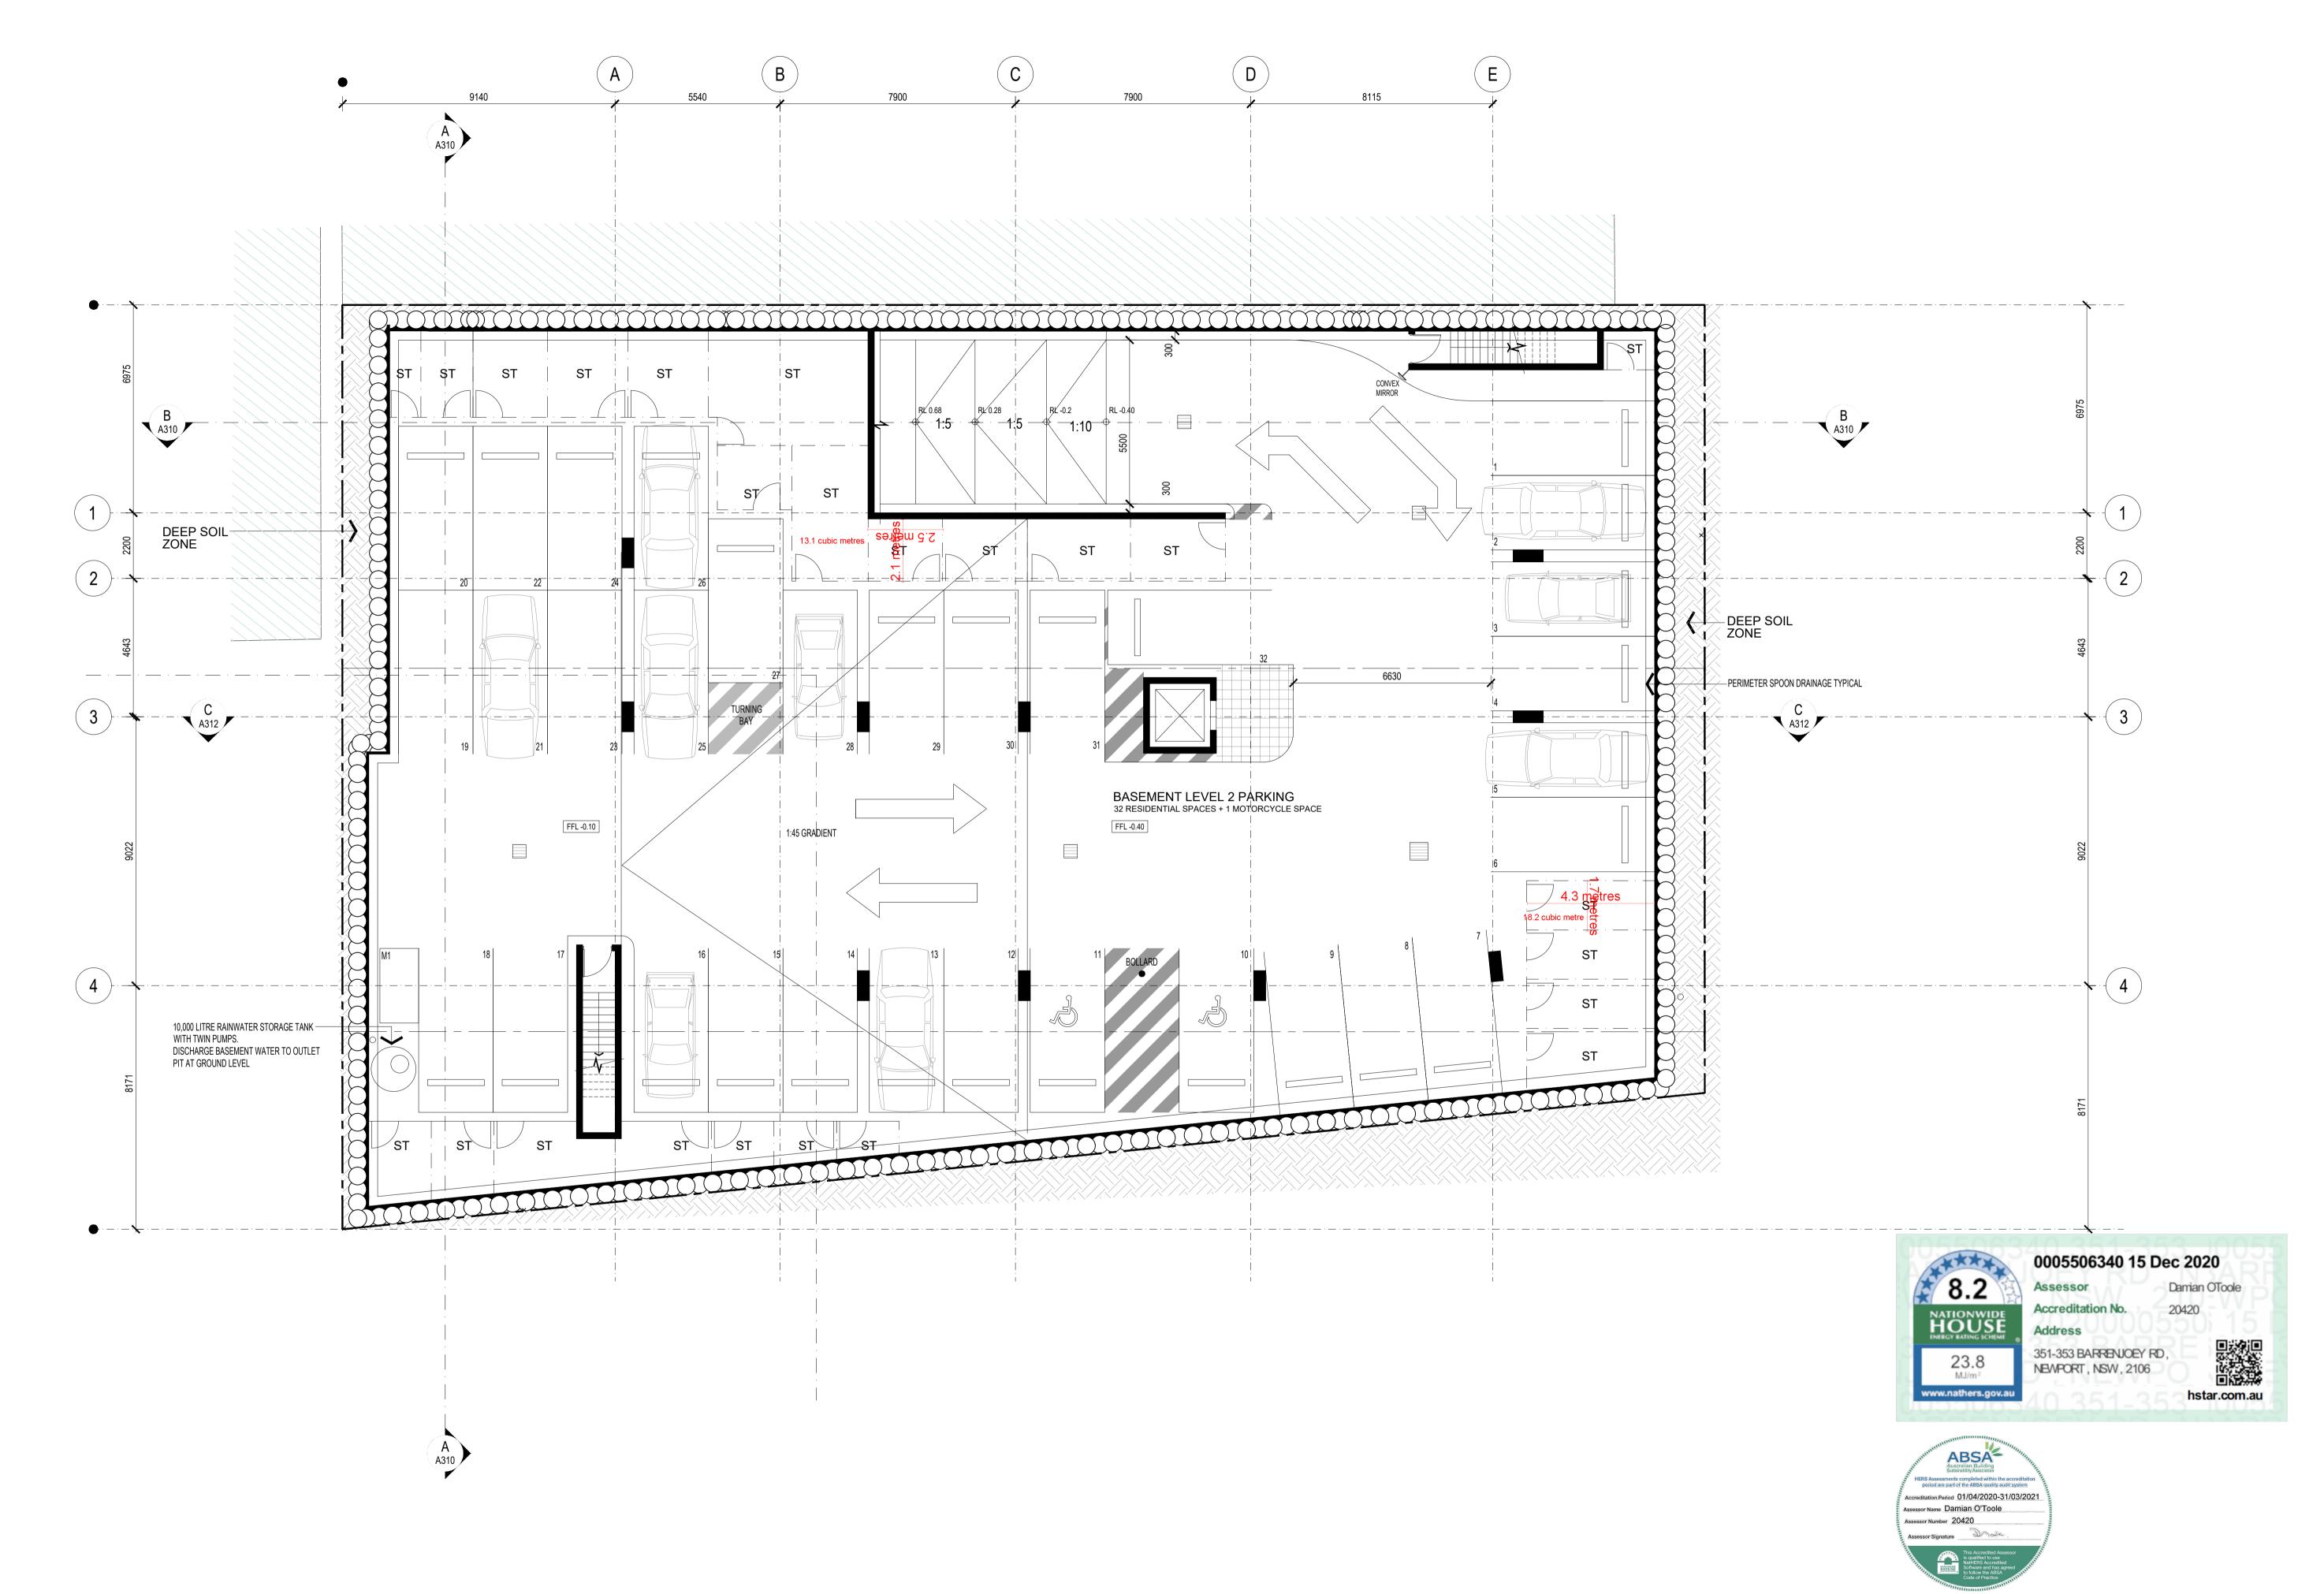
LOT 65 & 66 SEC 5 DP 6248

**EXCAVATION PLAN** 



APPROVED DRAWN MT CHECKED PG DATE JAN 2019 STATUS DA





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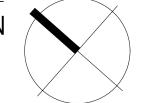
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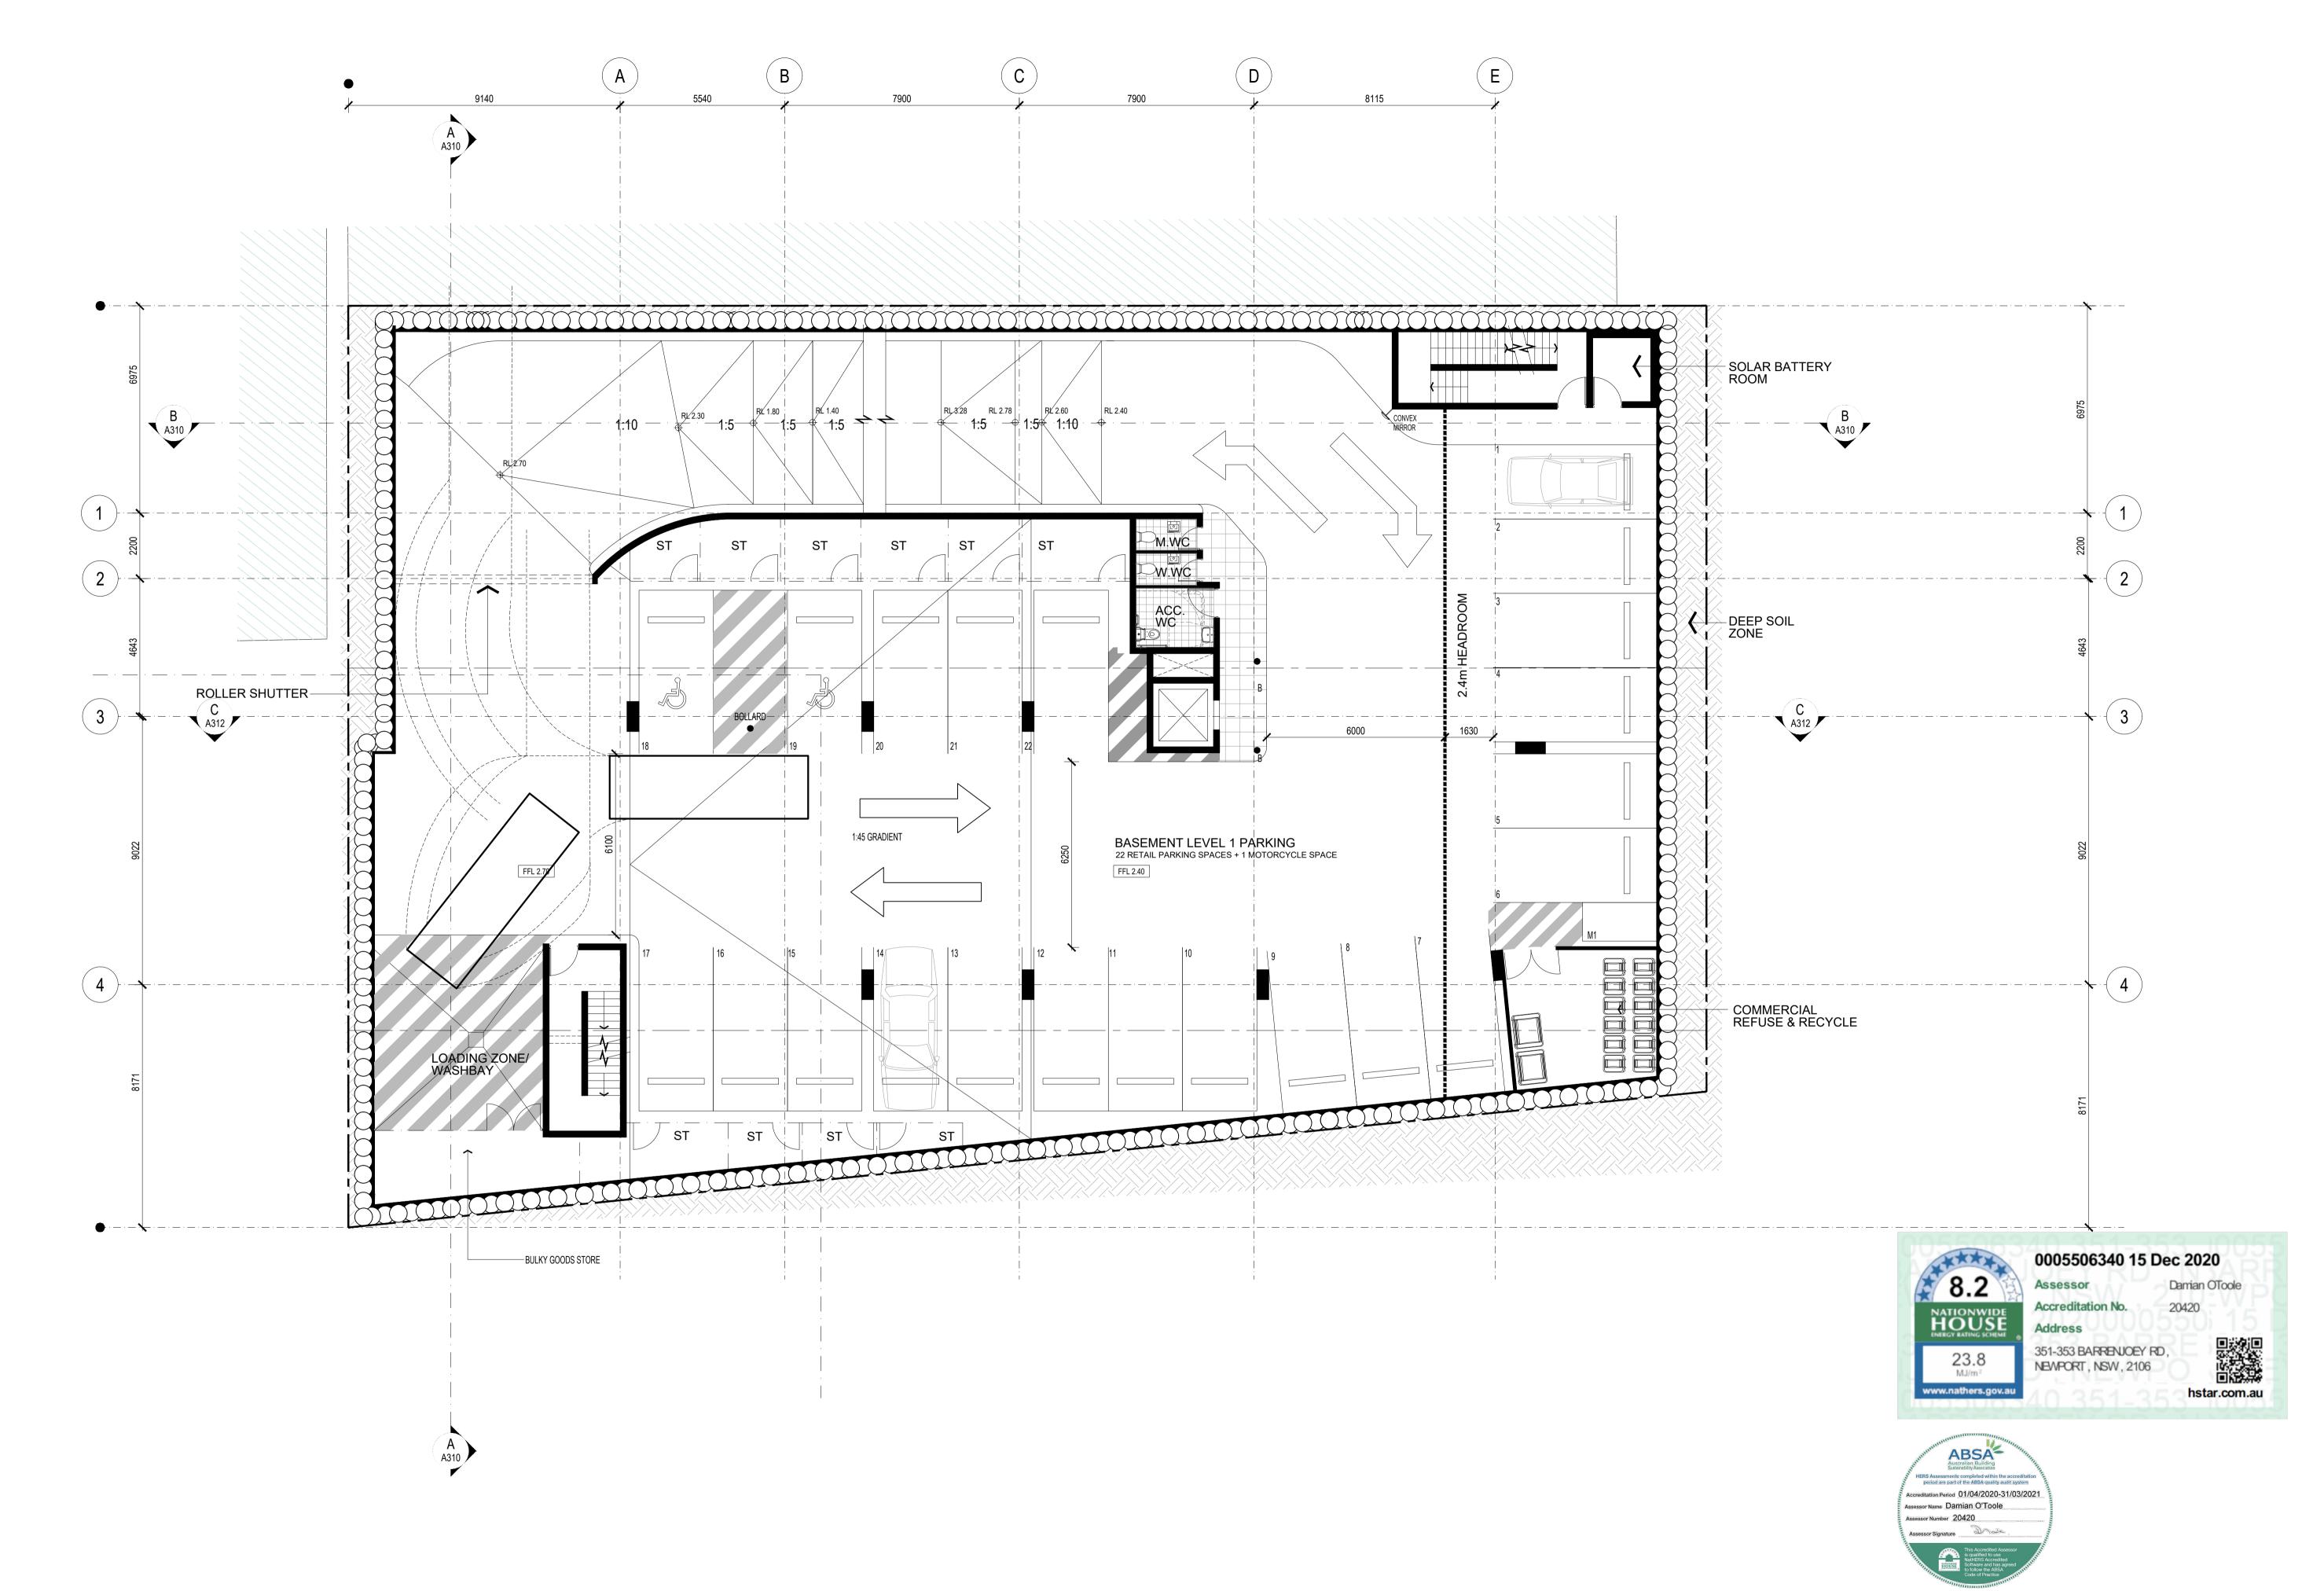
351-353 BARRENJOEY ROAD, NEWPORT NSW 2106

LOT 65 & 66 SEC 5 DP 6248

**BASEMENT 2 FLOOR PLAN** 



SCALE 1:100 @ A1 APPROVED DRAWN MT LH CHECKED PG DATE JAN 2019 STATUS DA



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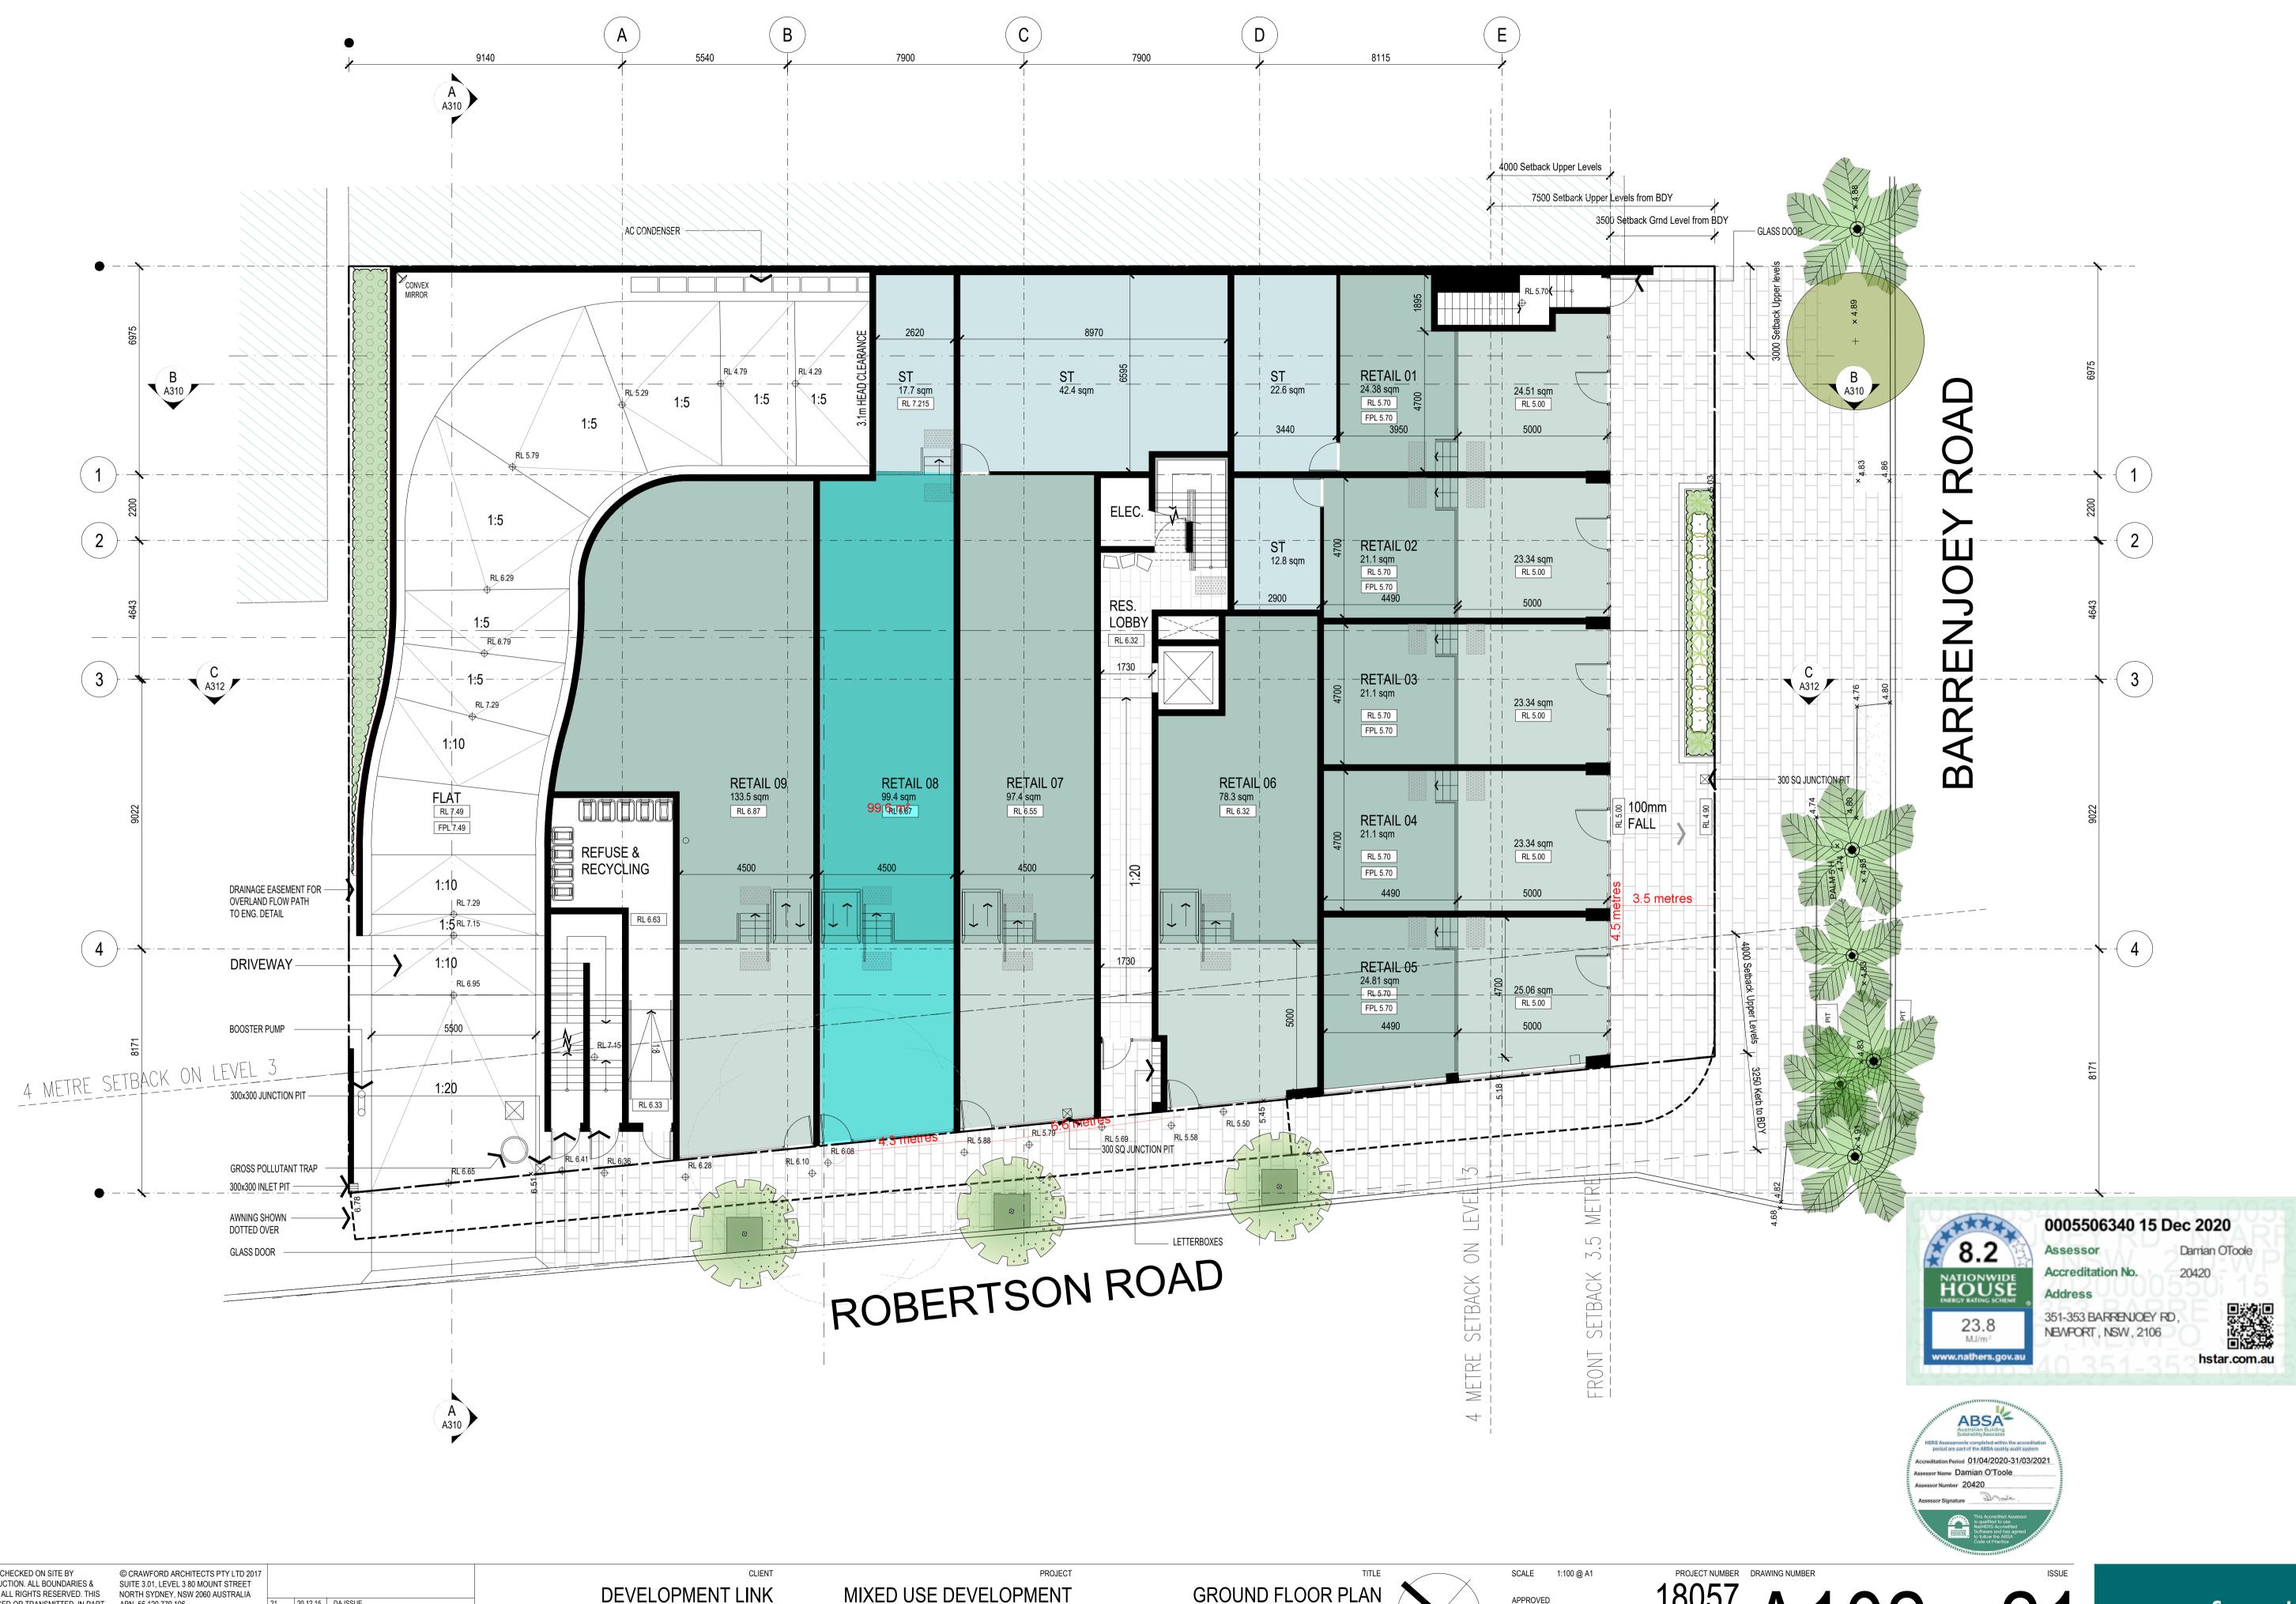
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351-353 BARRENJOEY ROAD, NEWPORT NSW 2106 LOT 65 & 66 SEC 5 DP 6248



SCALE 1:100 @ A1 APPROVED DRAWN MT LH CHECKED PG DATE JAN 2019 STATUS DA





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ISSUE DATE AMENDMENTS

MIXED USE DEVELOPMENT

351-353 BARRENJOEY ROAD, NEWPORT NSW 2106

LOT 65 & 66 SEC 5 DP 6248

**GROUND FLOOR PLAN** 

APPROVED DRAWN MT LH HH CHECKED PG DATE JAN 2019 STATUS DA





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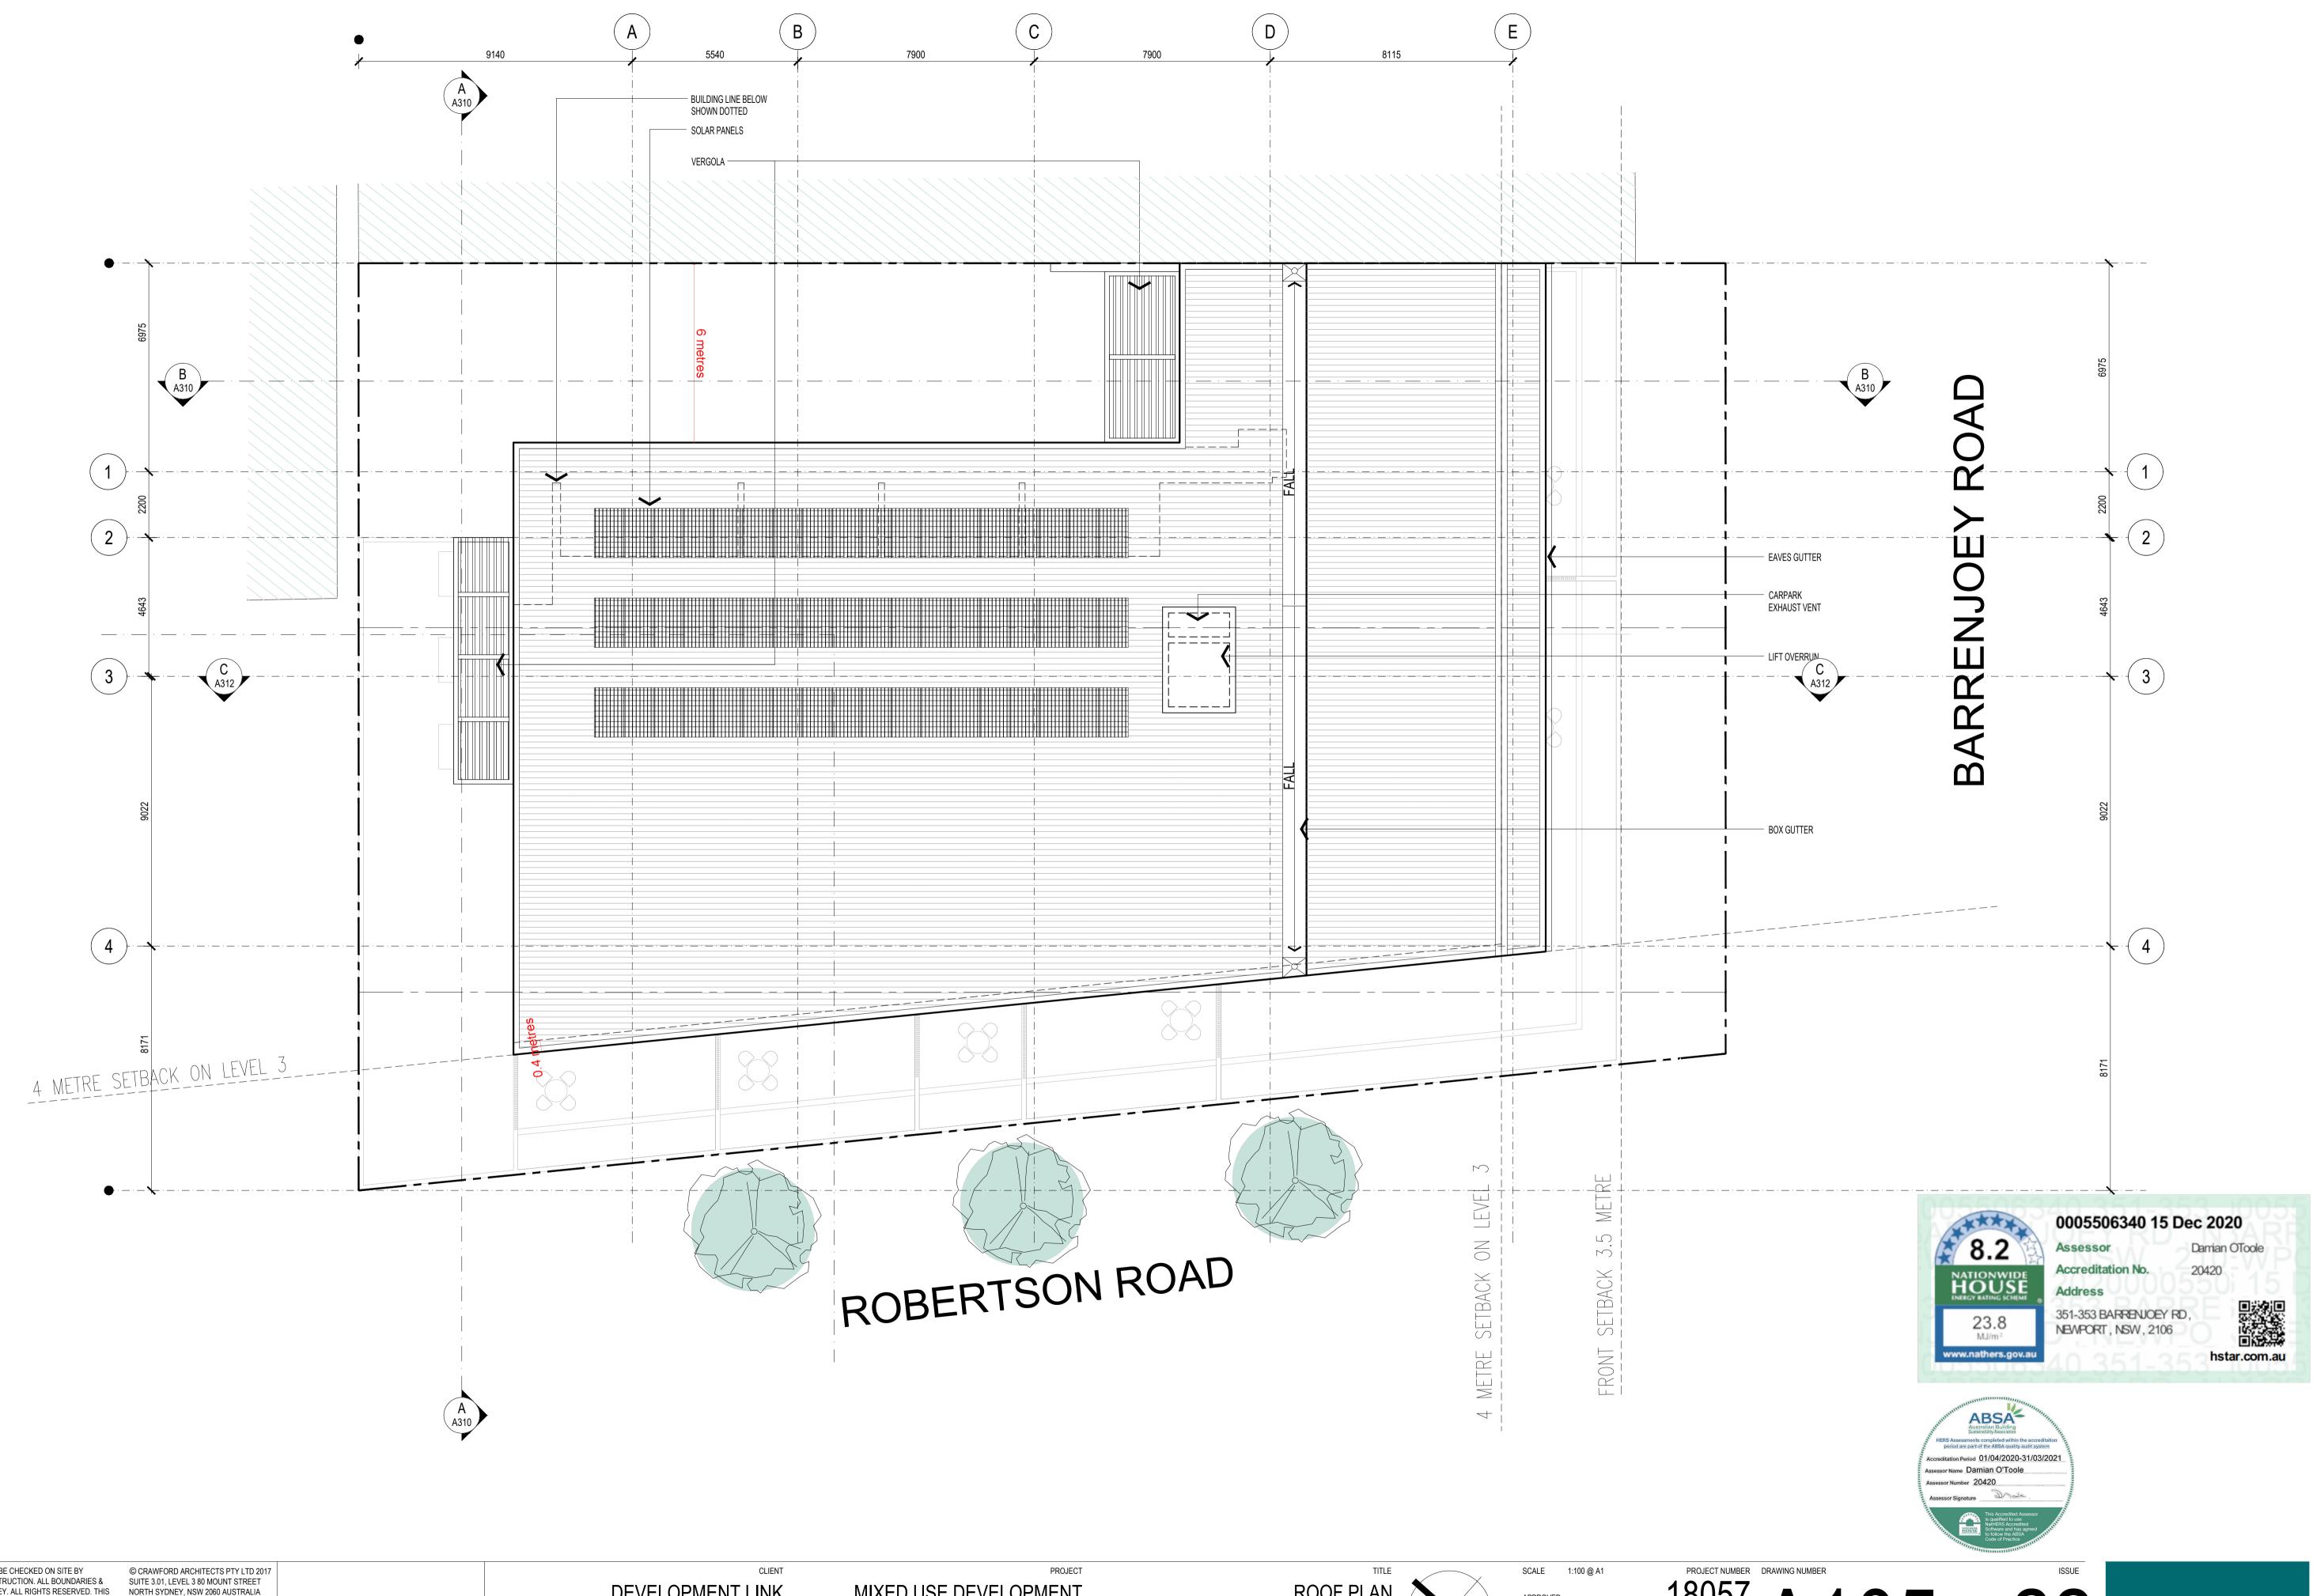
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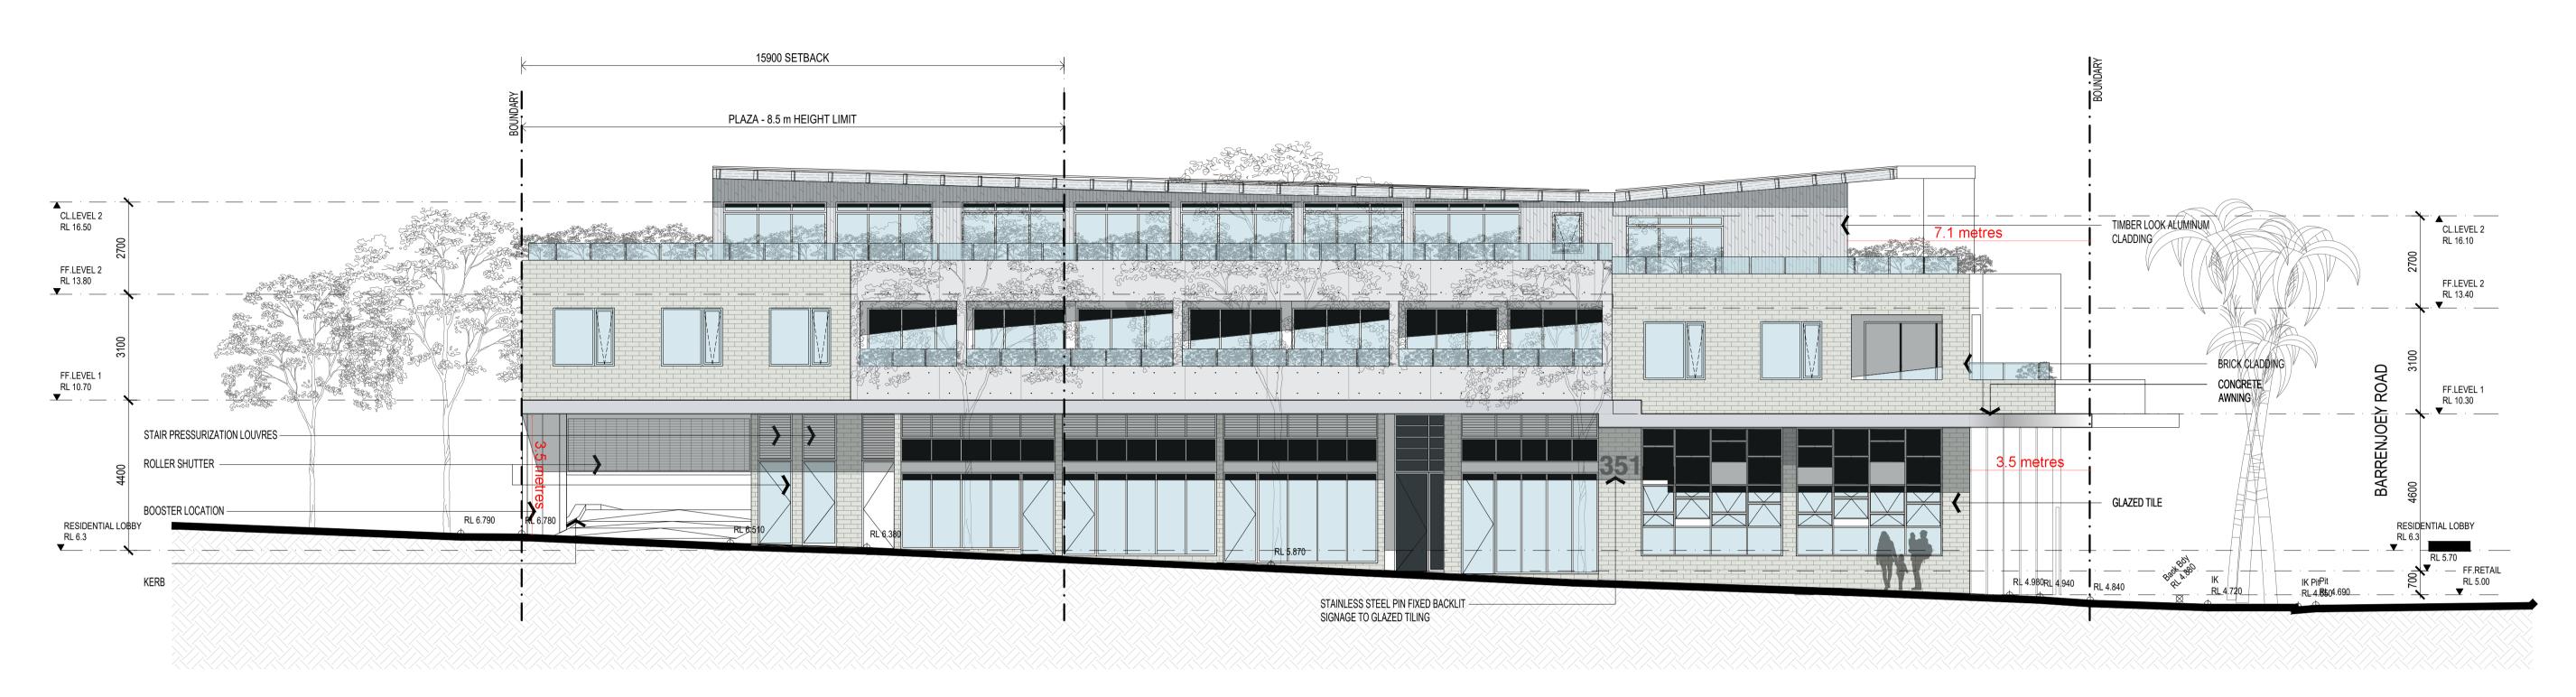
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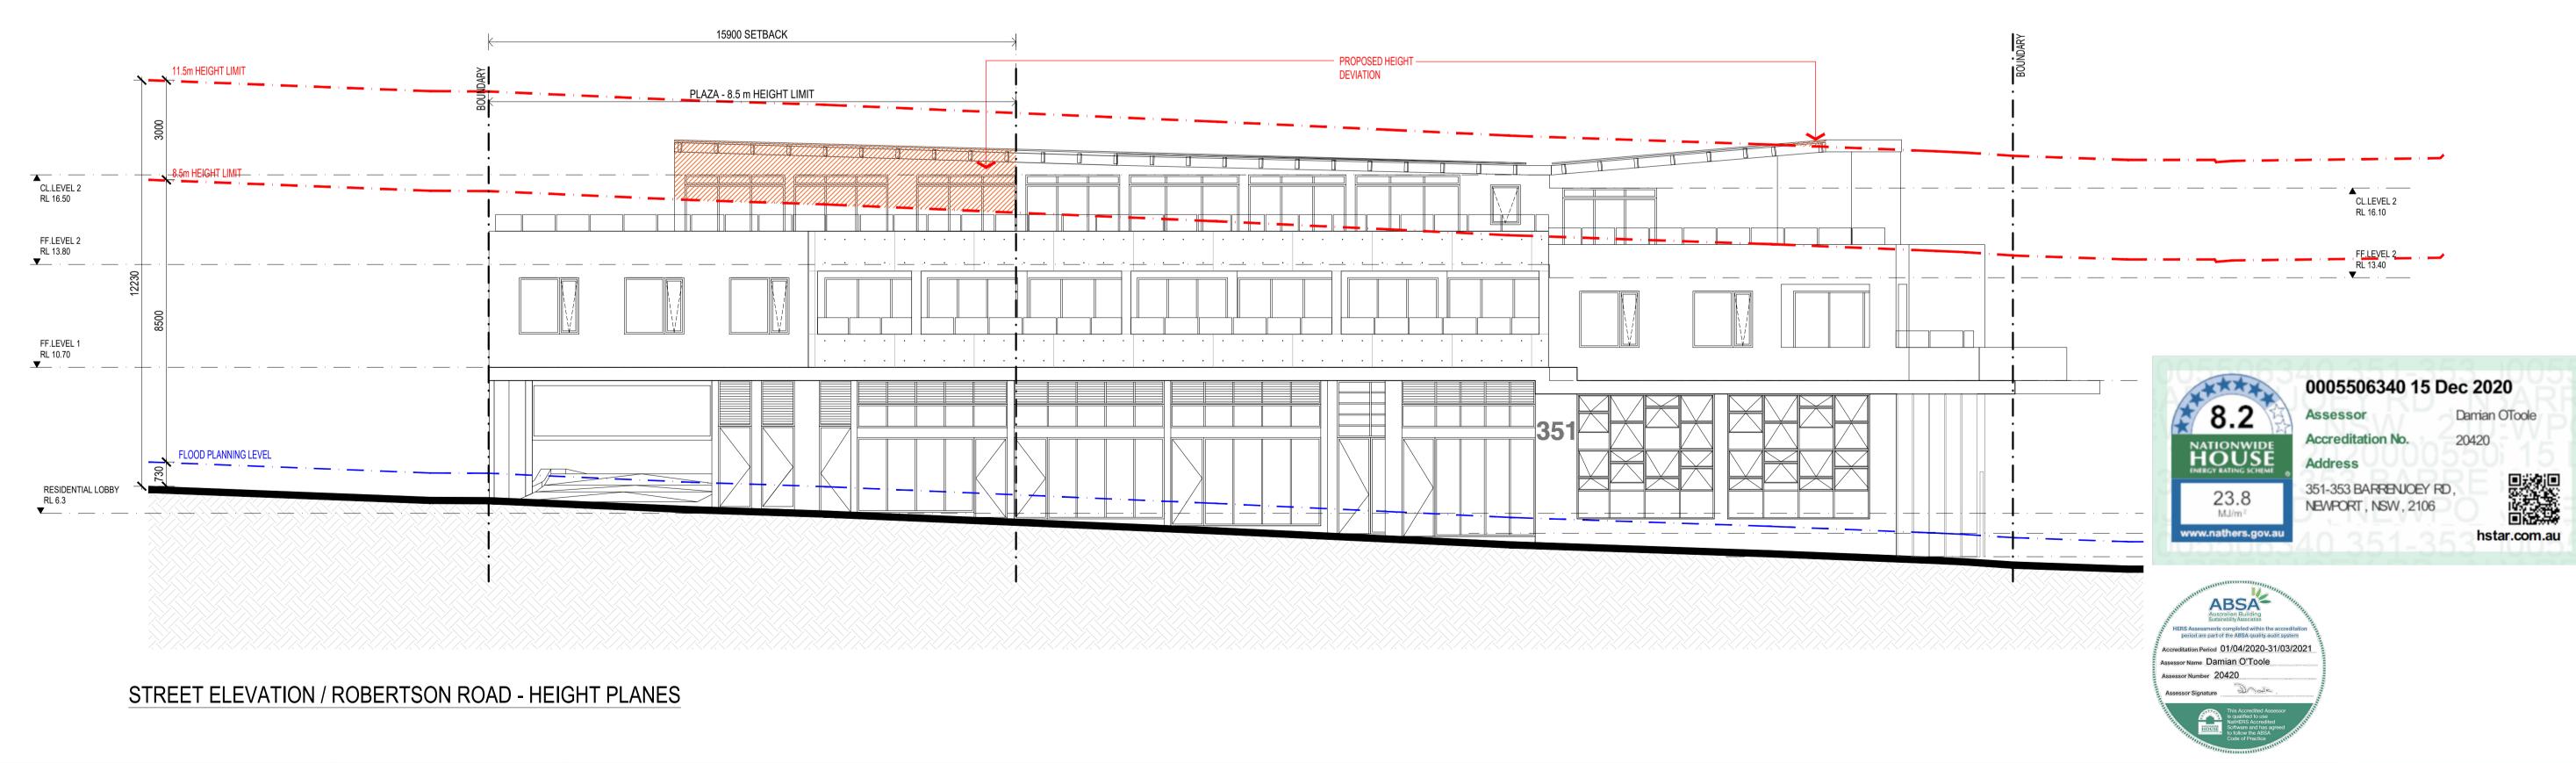
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APPROVED
DRAWN MT LH HH
CHECKED PG DATE JAN 2019 STATUS DA

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#### STREET ELEVATION / ROBERTSON ROAD



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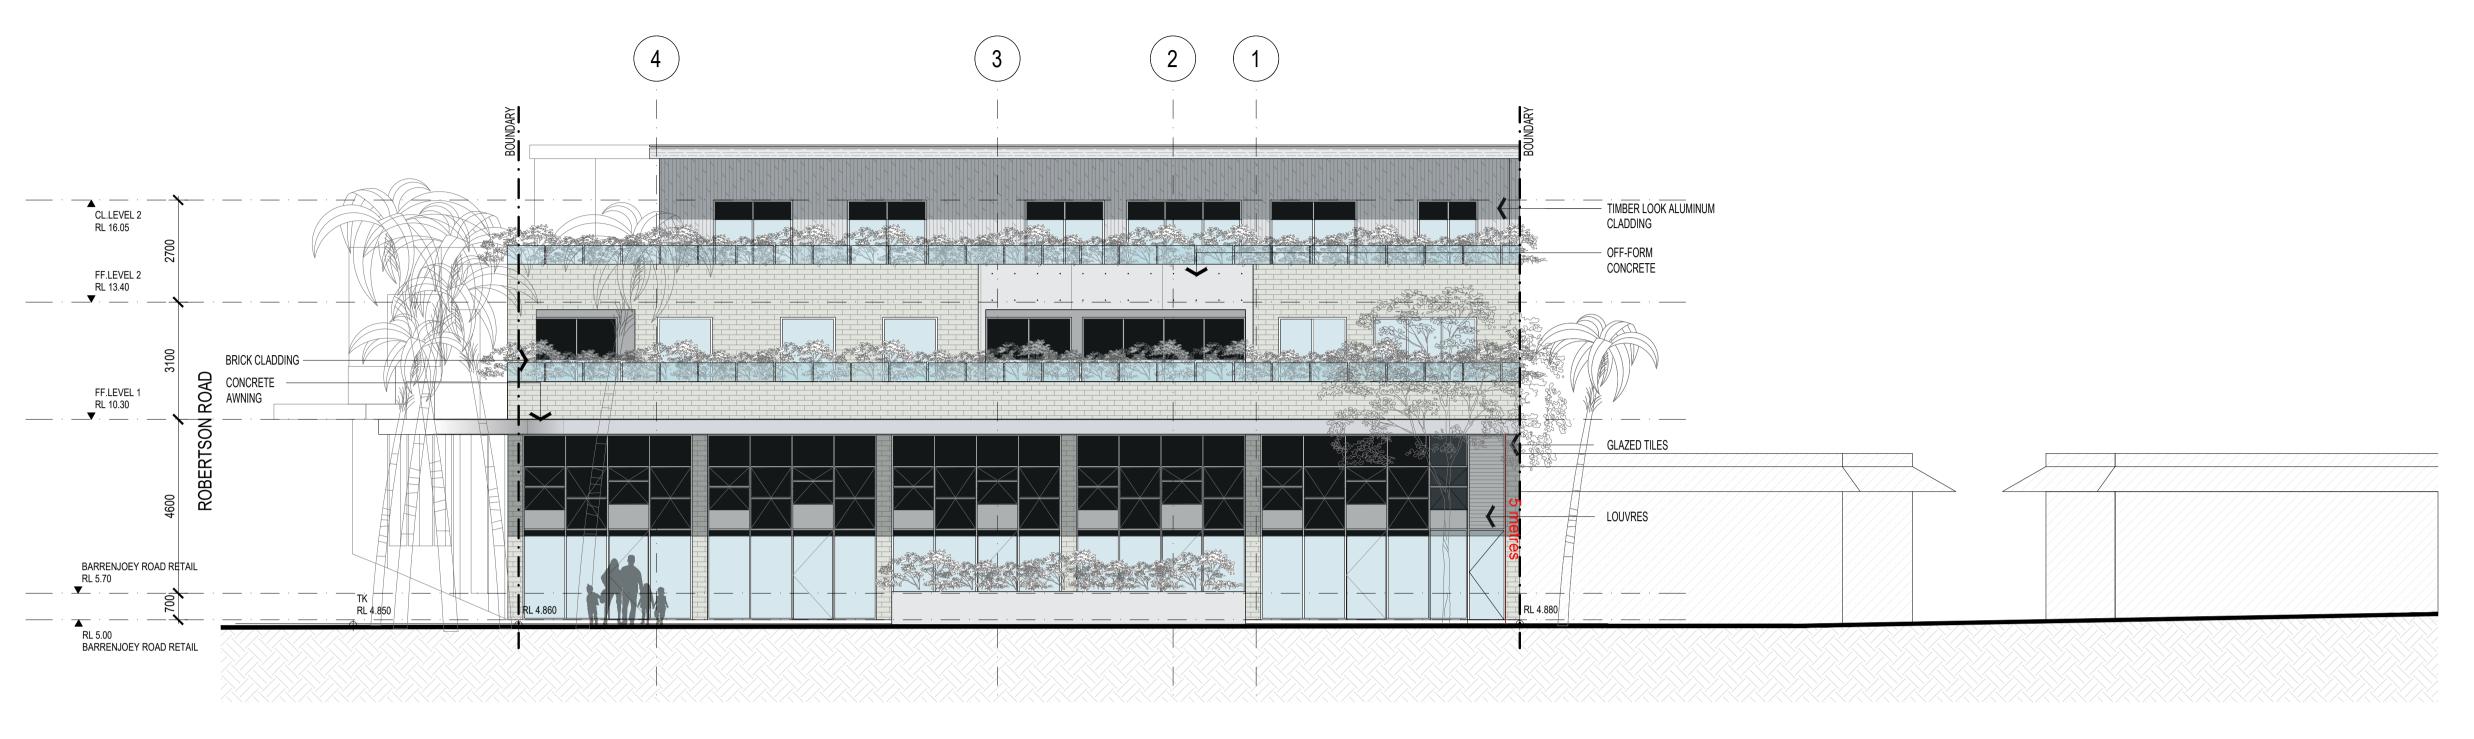
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LOT 65 & 66 SEC 5 DP 6248


SOUTH ELEVATION



SCALE 1:100 @ A1 APPROVED DRAWN MN CHECKED PG DATE JAN 2019 STATUS DA





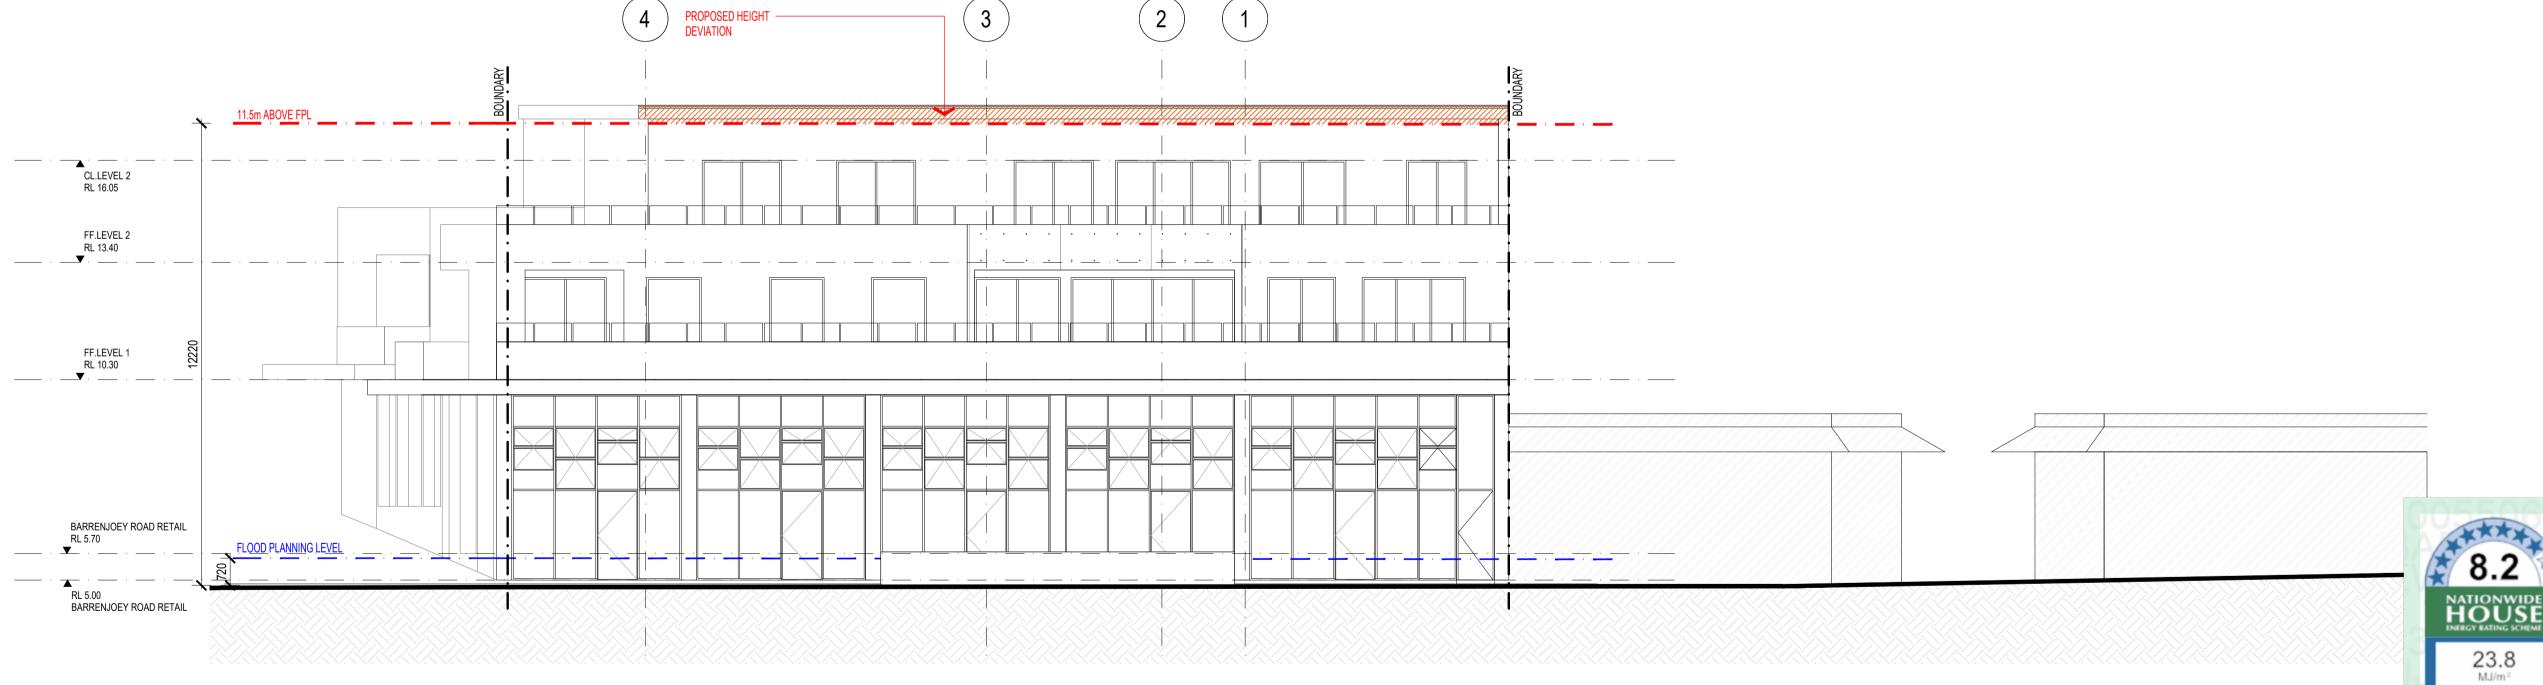

STREET ELEVATION / BARRENJOEY ROAD - HEIGHT PLANES



23.8 MJ/m²

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LOT 65 & 66 SEC 5 DP 6248

**EAST ELEVATION** 

SCALE 1:100 @ A1 APPROVED DRAWN MN CHECKED PG DATE JAN 2019 STATUS DA

PROJECT NUMBER DRAWING NUMBER

0005506340 15 Dec 2020

Damian OToole

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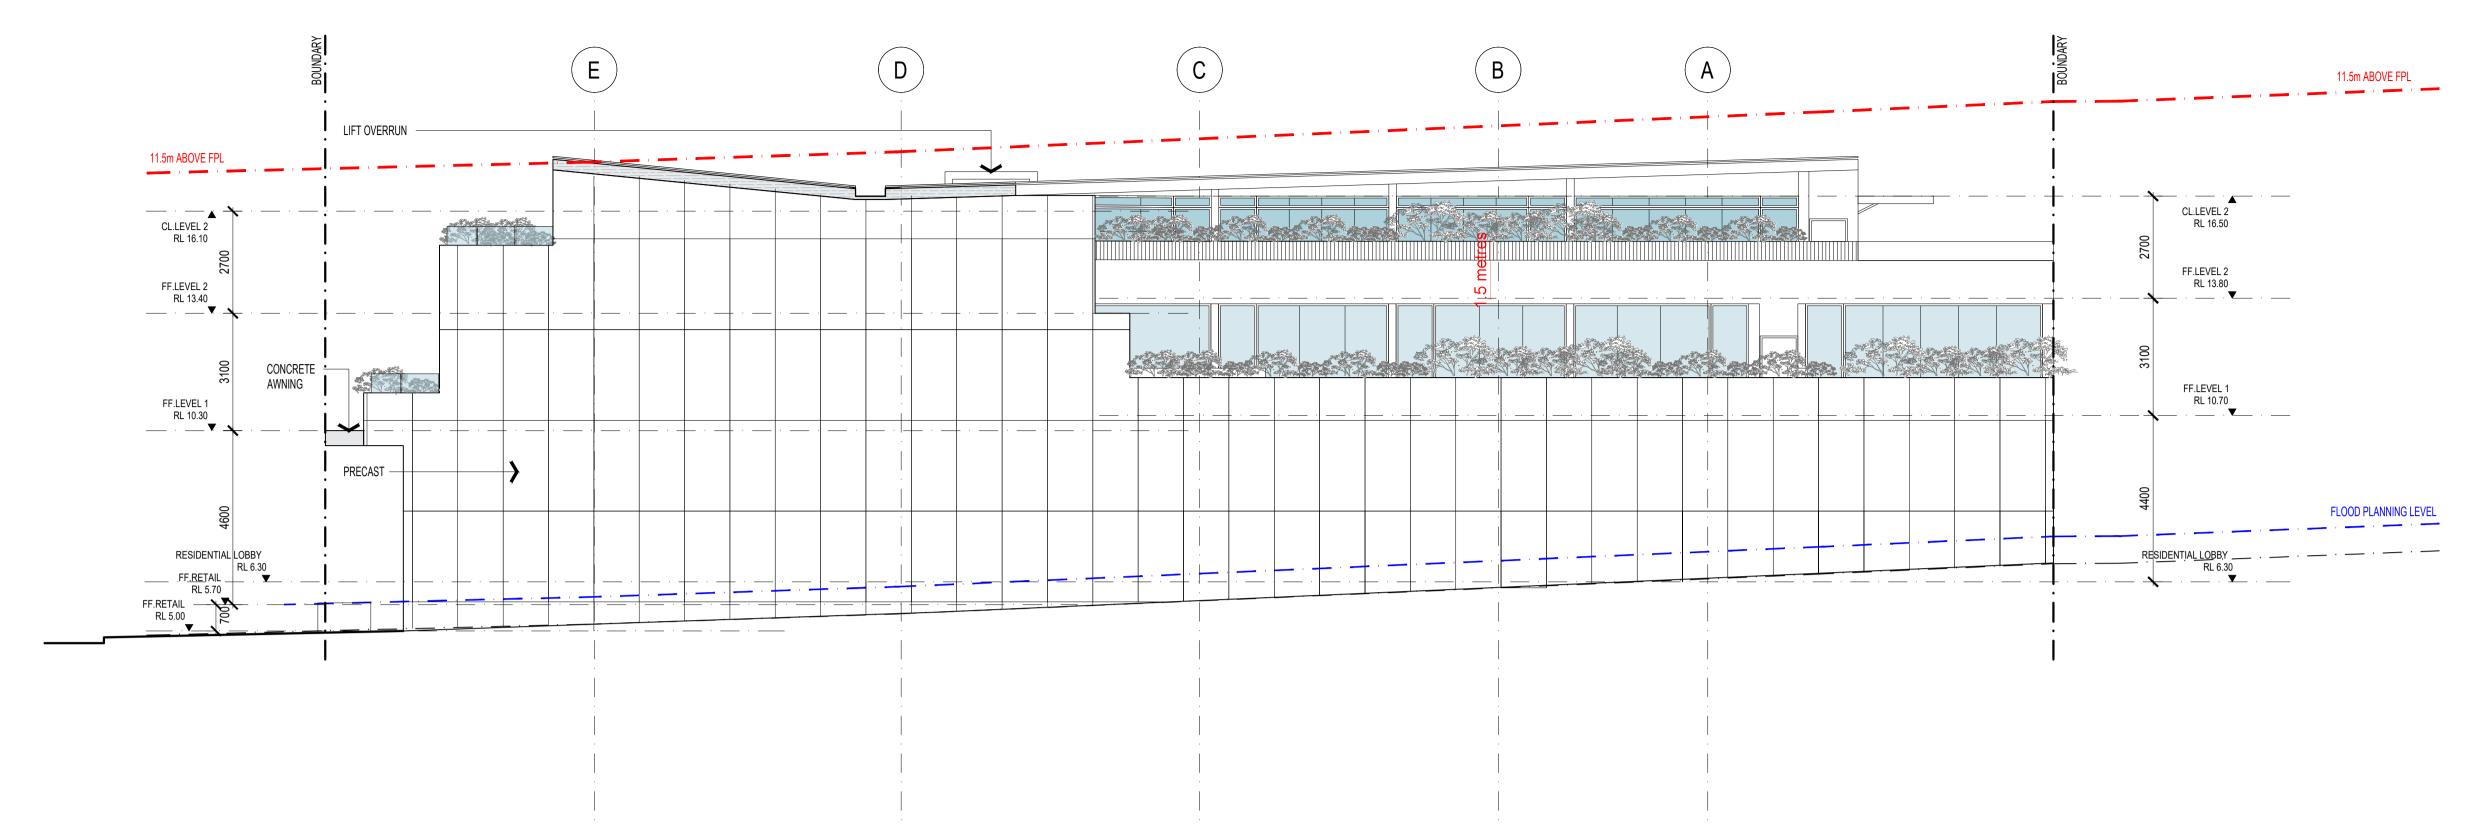
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Assessor


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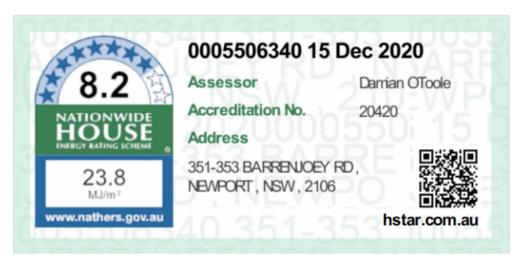
Accreditation No.

351-353 BARRENUOEY RD, NEWPORT, NSW, 2106



### NORTH ELEVATION



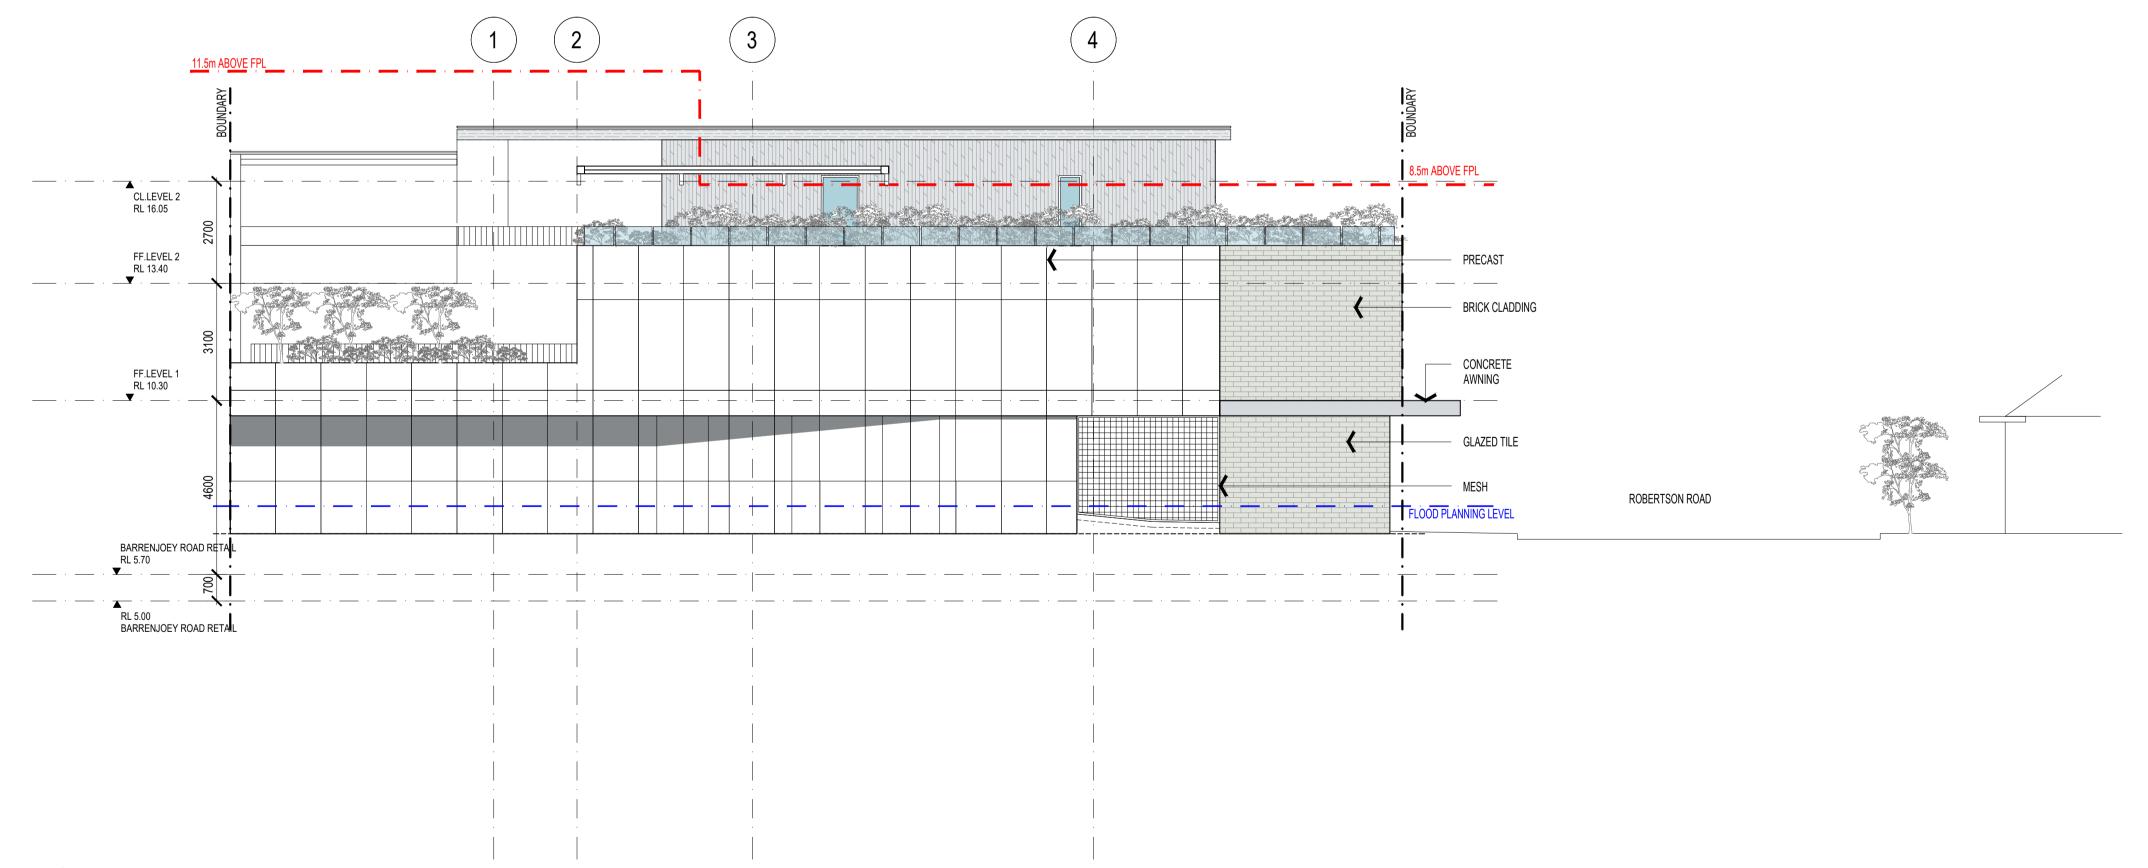



## WEST ELEVATION

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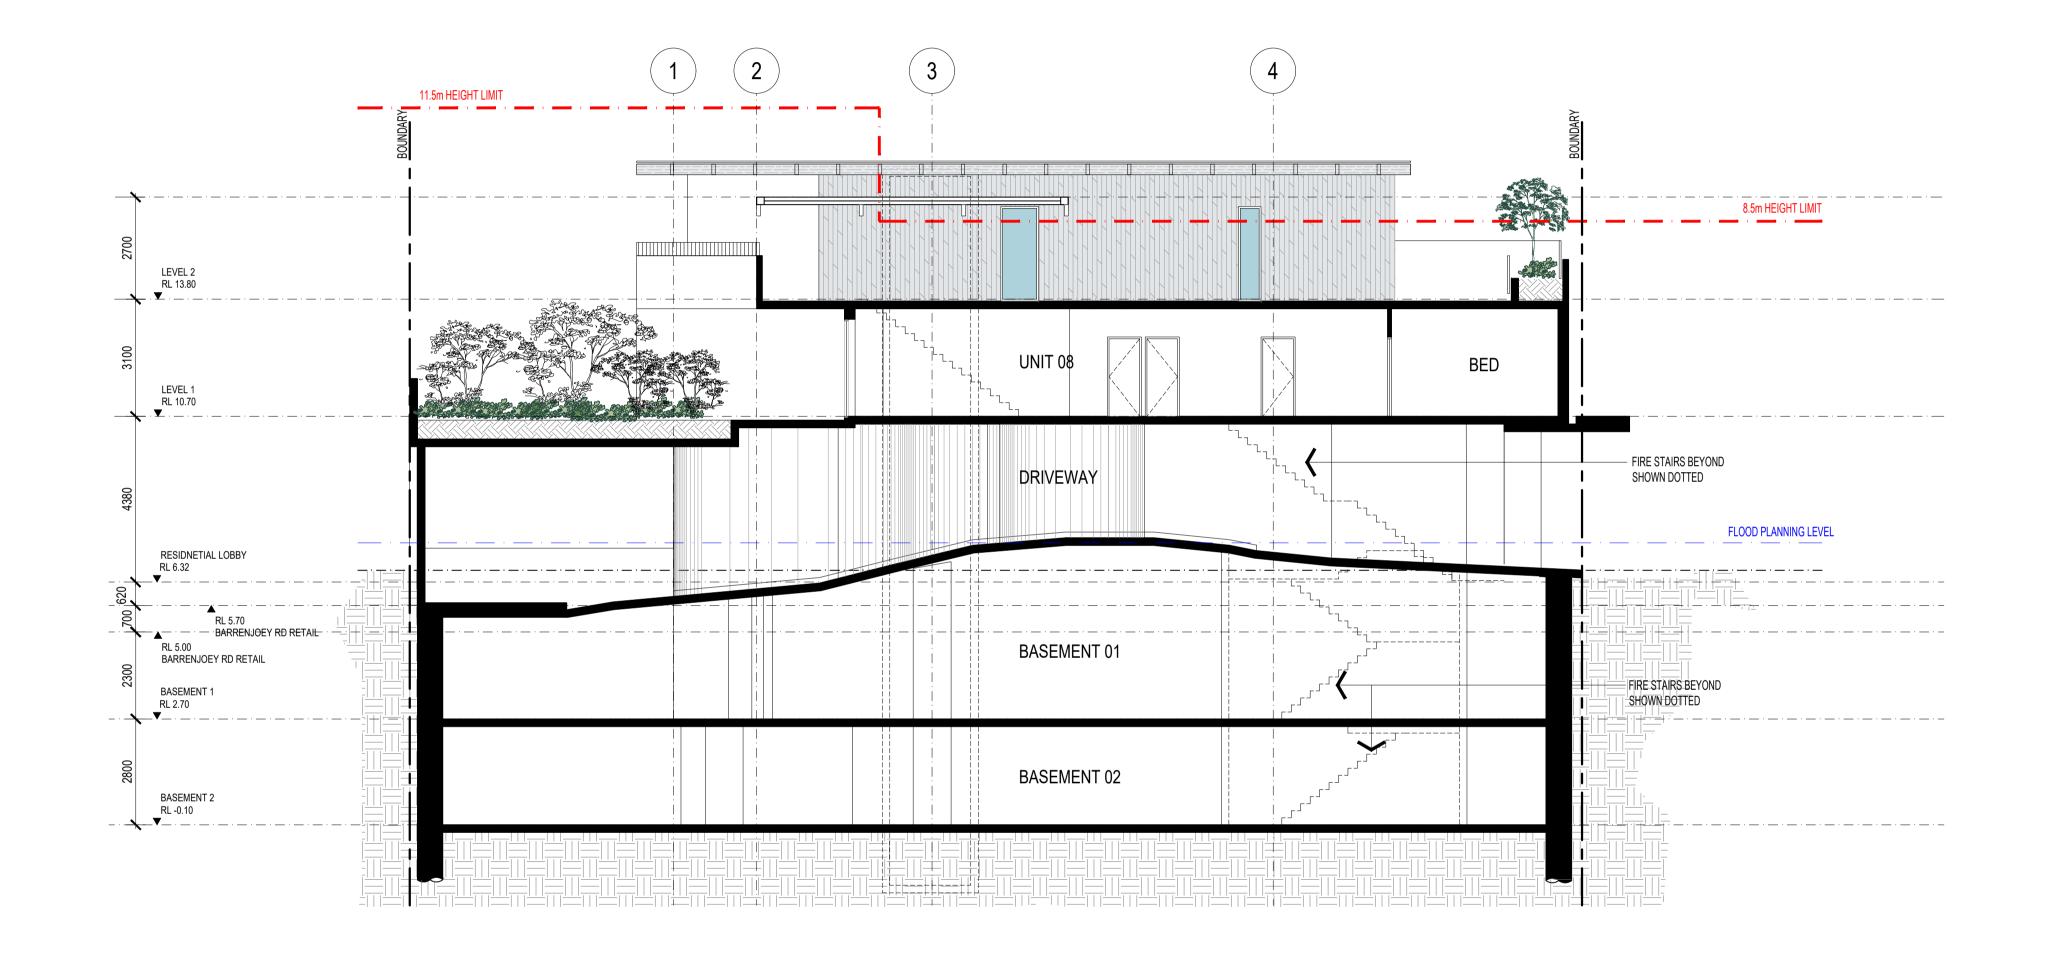
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ABN 56 120 779 106
NOMINATED ARCHITECTS: TONY GRAY 5303 & PAUL GODSELL 6726 13 20.12.15 DA ISSUE
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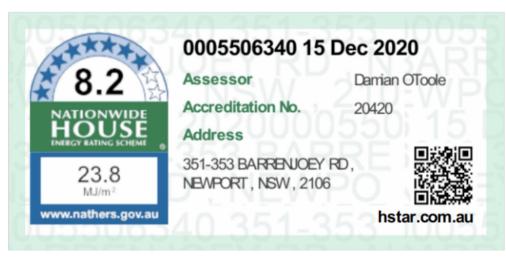
LOT 65 & 66 SEC 5 DP 6248

NORTH AND WEST **ELEVATIONS**  SCALE 1:100 @ A1 APPROVED DRAWN MN CHECKED PG DATE JAN 2019 STATUS DA



PROJECT

LOT 65 & 66 SEC 5 DP 6248





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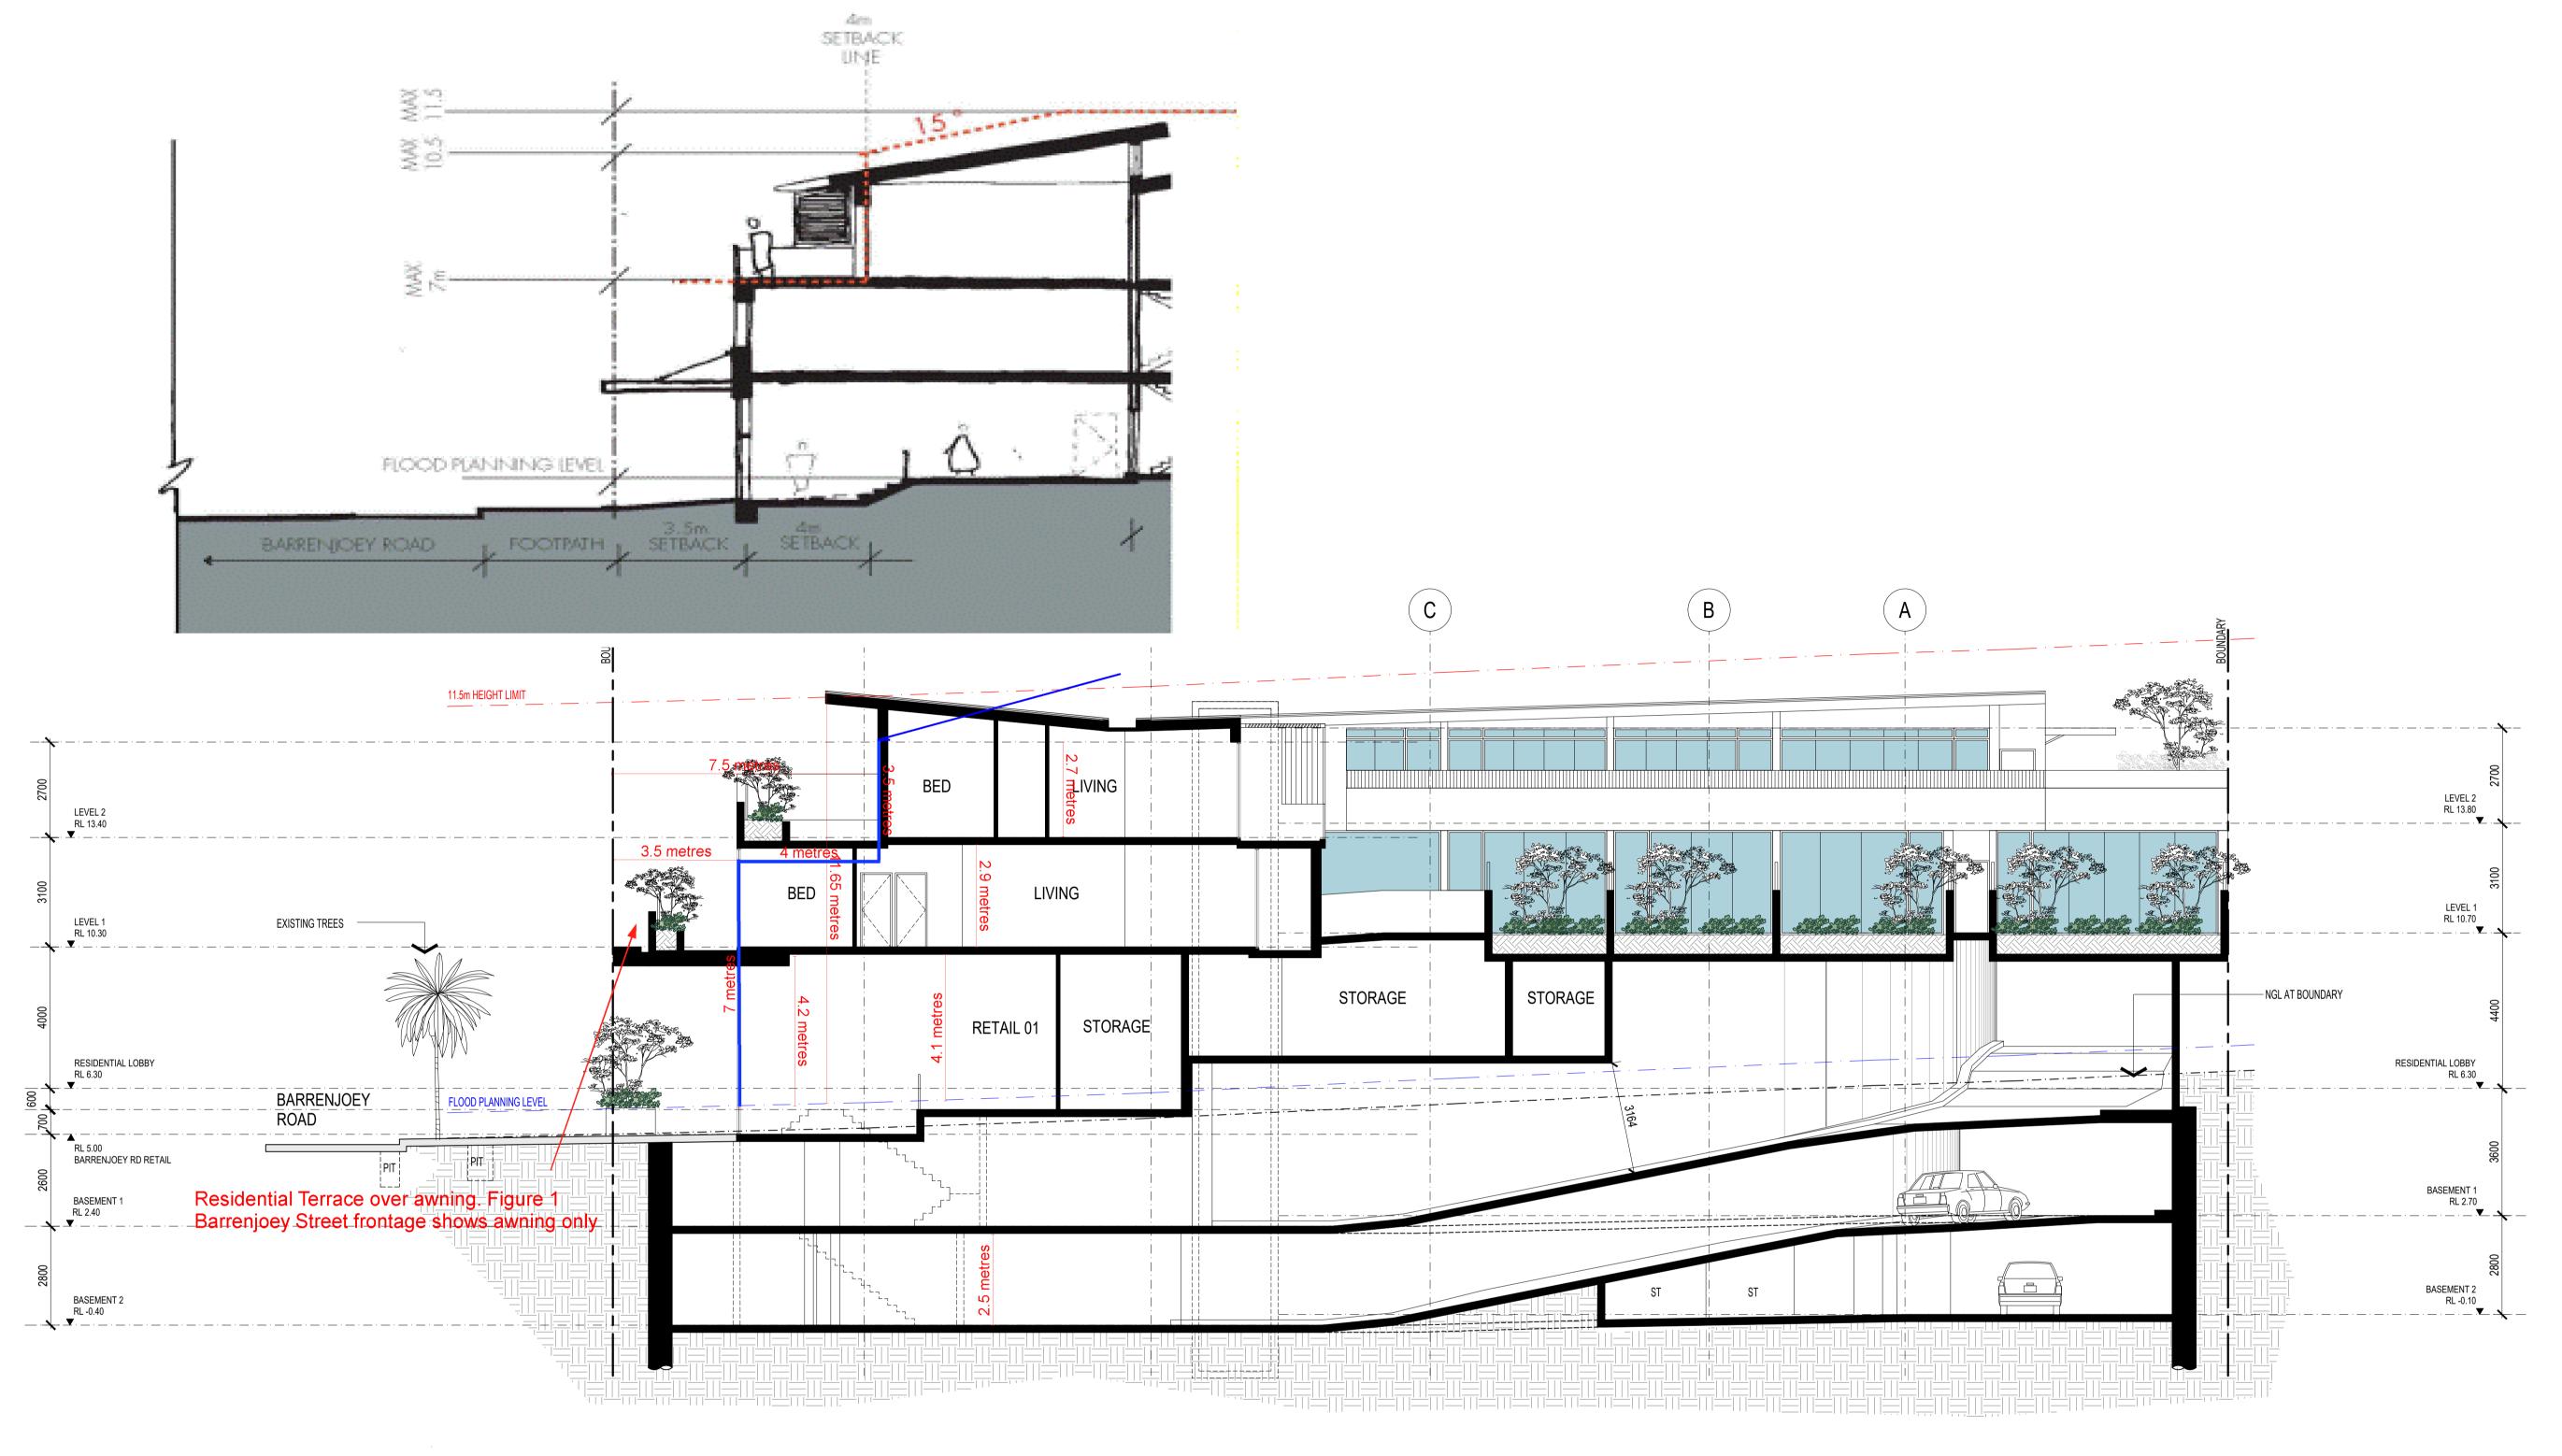
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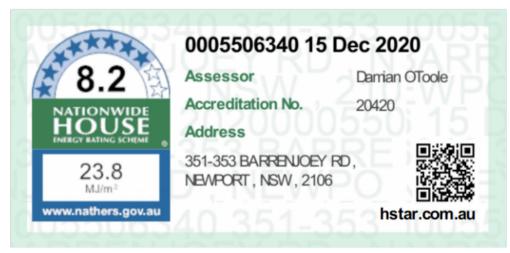
MIXED USE DEVELOPMENT DEVELOPMENT LINK

SECTION AA

SCALE 1:100 @ A1 APPROVED DRAWN HH - MT CHECKED PG DATE JAN 2019 STATUS DA









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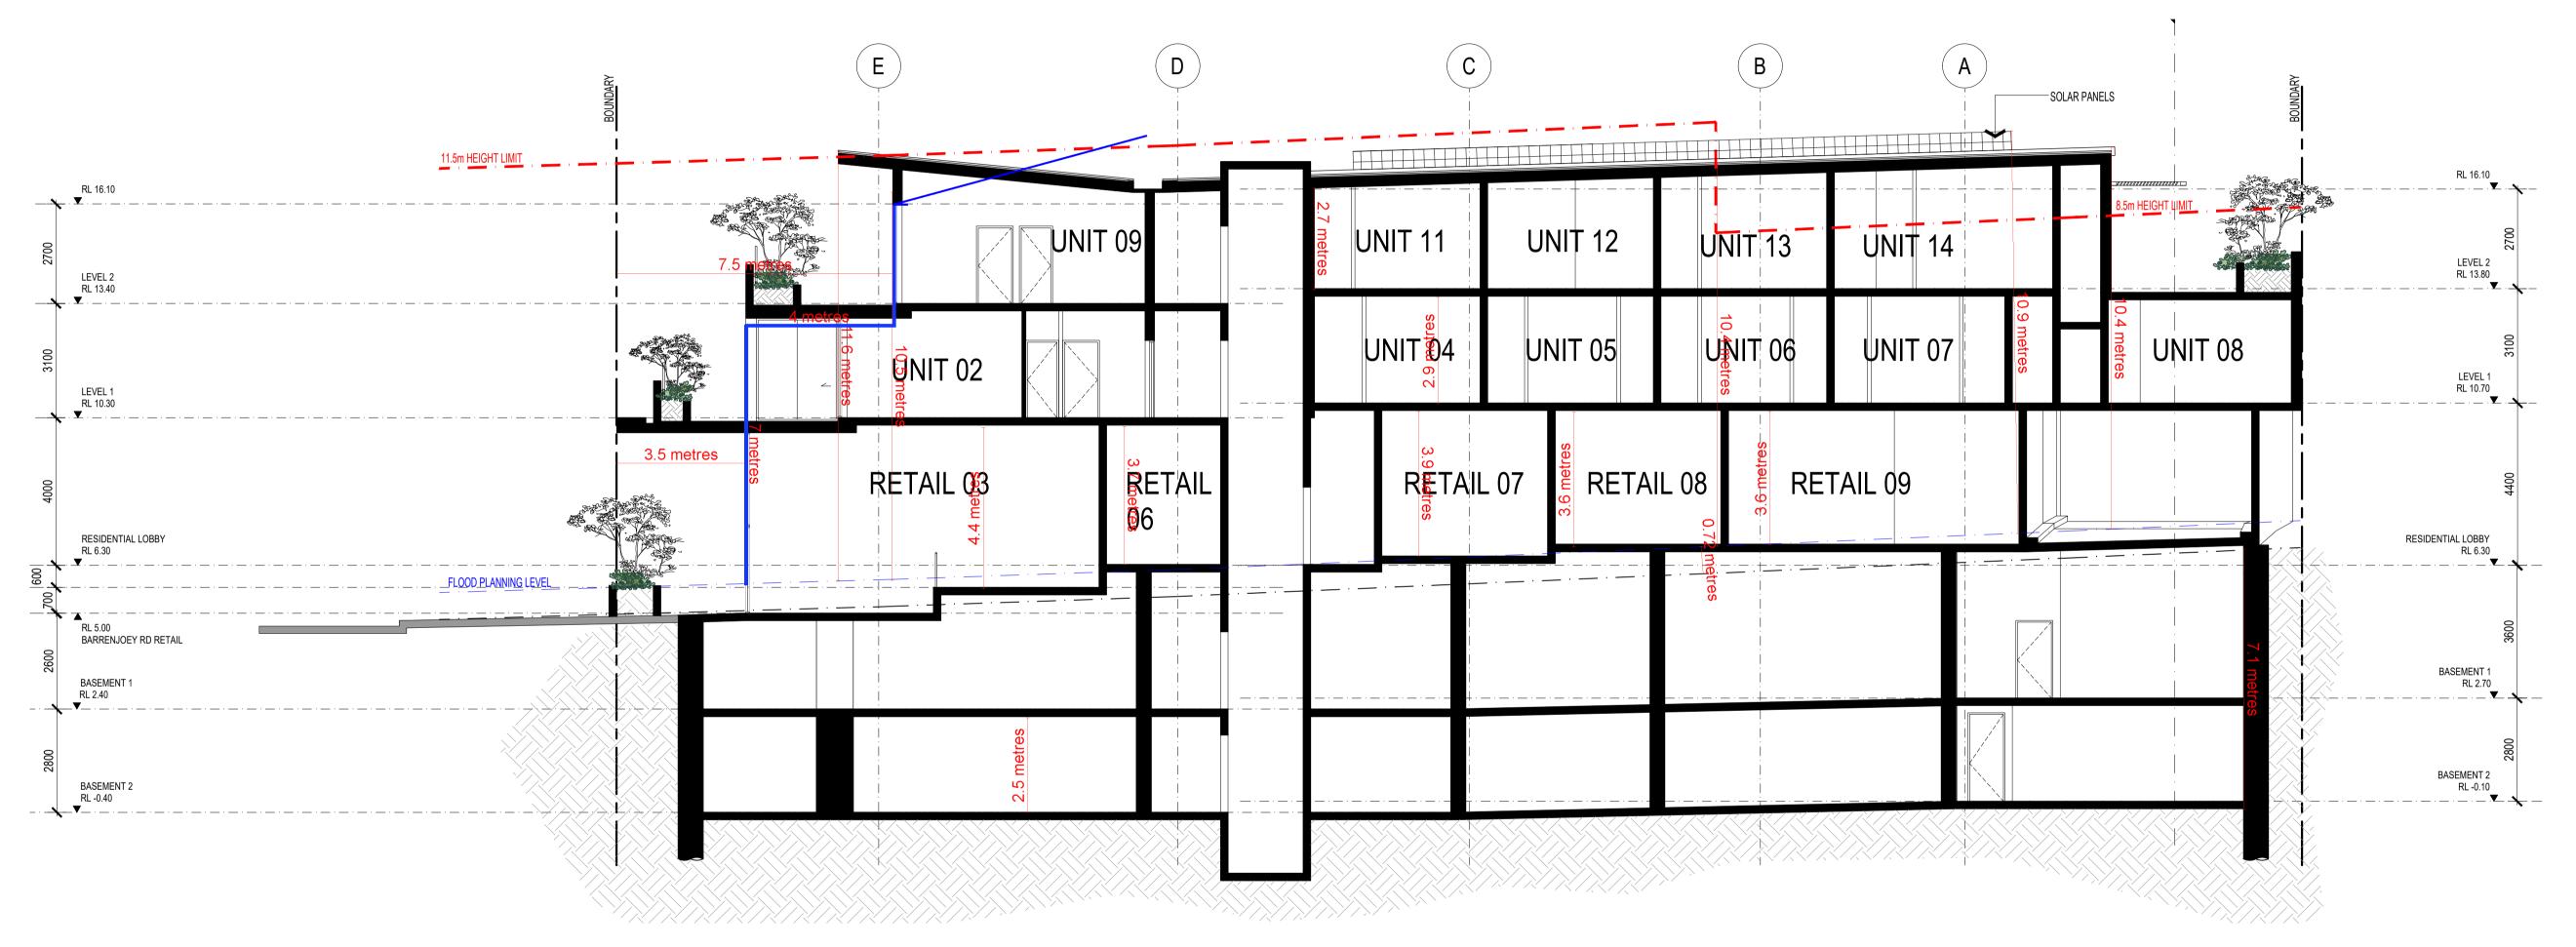
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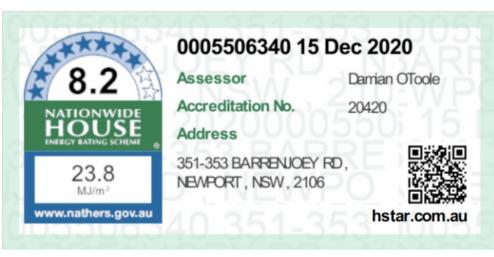
LOT 65 & 66 SEC 5 DP 6248

SECTION BB

SCALE 1:100 @ A1 APPROVED DRAWN HH - MT CHECKED PG DATE JAN 2019 STATUS DA









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LOT 65 & 66 SEC 5 DP 6248

SECTION CC

SCALE 1:100 @ A1 APPROVED DRAWN HH - MT CHECKED PG DATE JAN 2019 STATUS DA





# FRONT ELEVATION / ROBERTSON ROAD





















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 DA ISSUE

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 20.11.23
 ISSUED TO COUNCIL

 04
 20.07.02
 REVISED ISSUE

 03
 20.06.19
 REVISED ISSUE
 20.05.01 REVISED ISSUE 19.10.15 DA ISSUE ISSUE DATE AMENDMENTS

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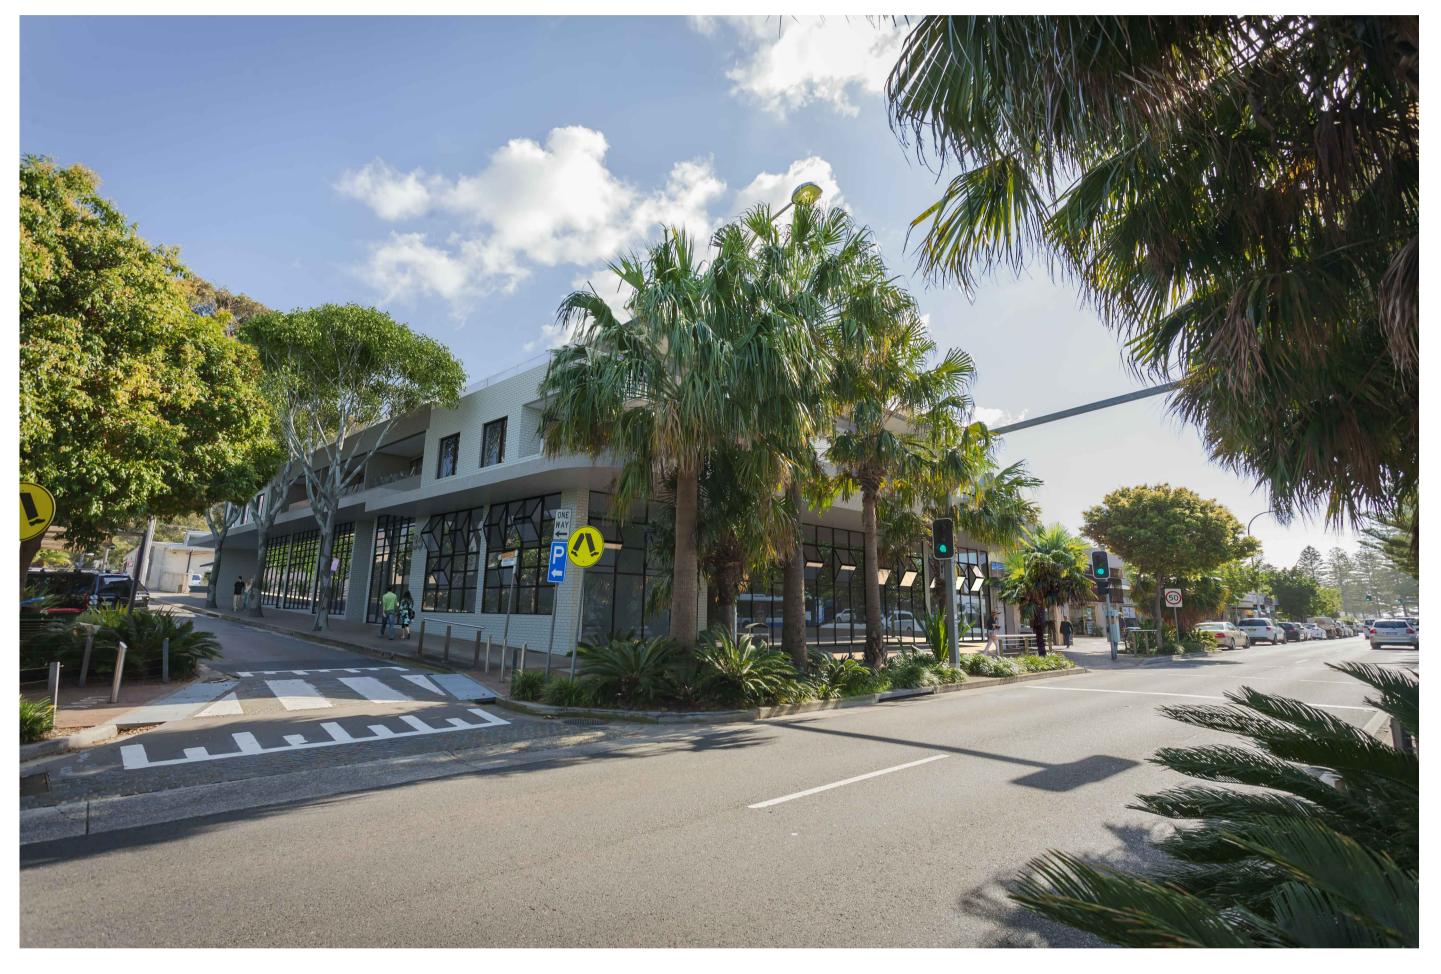
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**AFTER** 





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 04
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 03
 20.06.19
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 02
 20.05.04
 REVISED DA ISUE
 19.10.15 DA ISSUE

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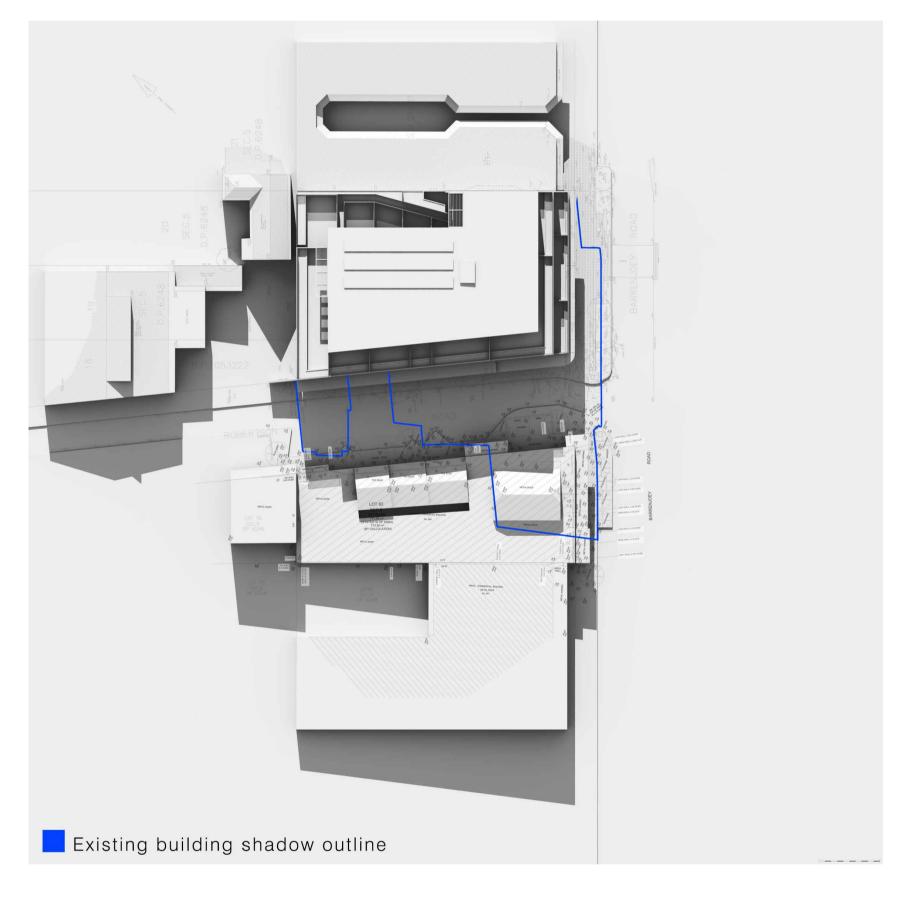
LOT 65 & 66 SEC 5 DP 6248

BEFORE & AFTER PHOTOMONTAGE SCALE APPROVED DRAWN HH CHECKED PG DATE JAN 2019


STATUS DA

PROJECT NUMBER DRAWING NUMBER

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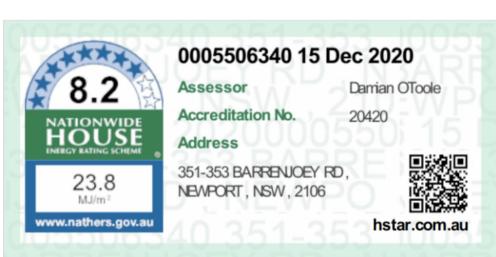




10:00am 21th JUNE

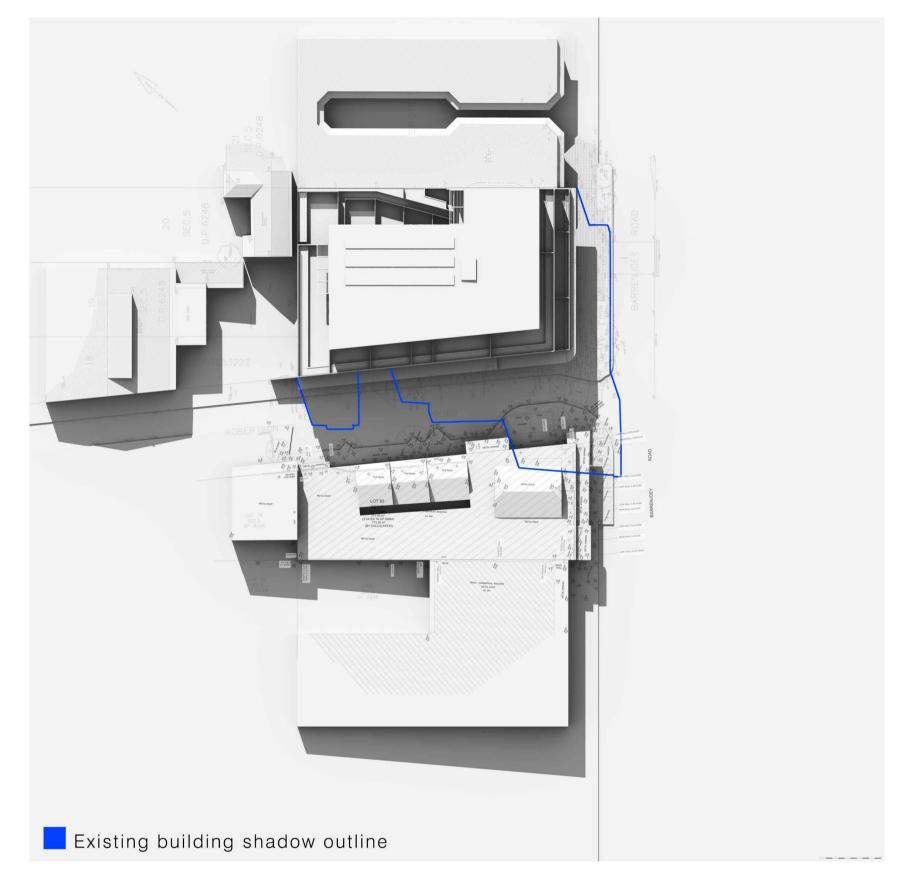

11:00am 21th JUNE





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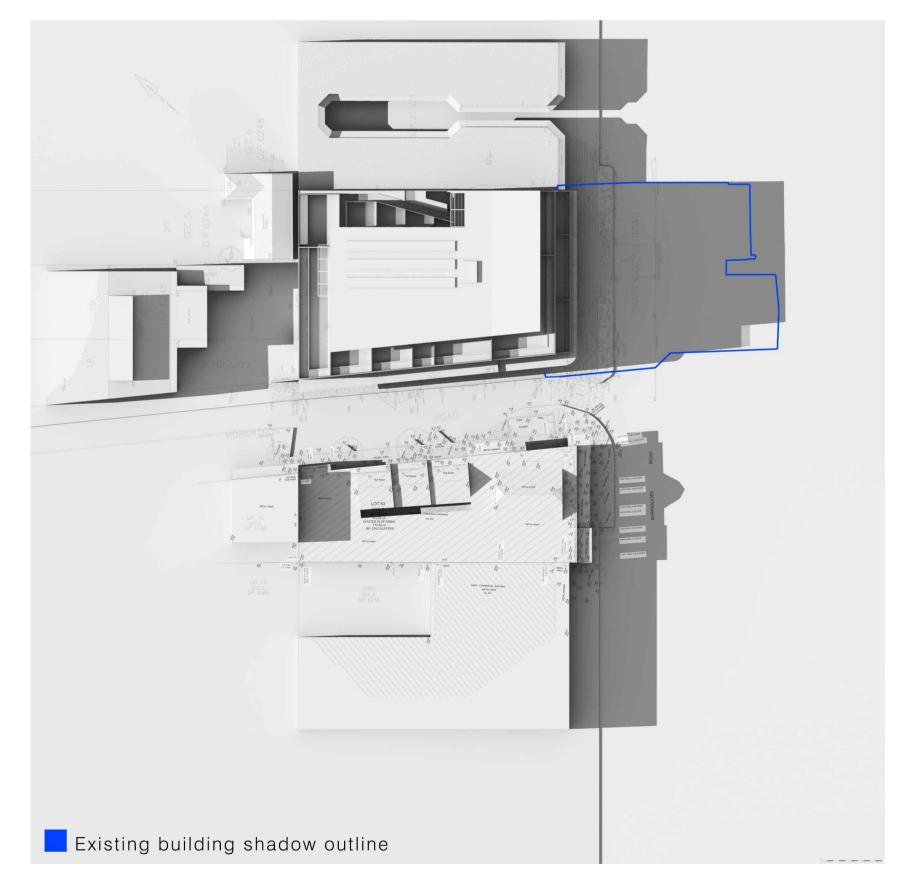
SHADOW DIAGRAMS SHEET 01


SCALE NTS APPROVED DRAWN CHECKED PG DATE JAN 2019 STATUS DA









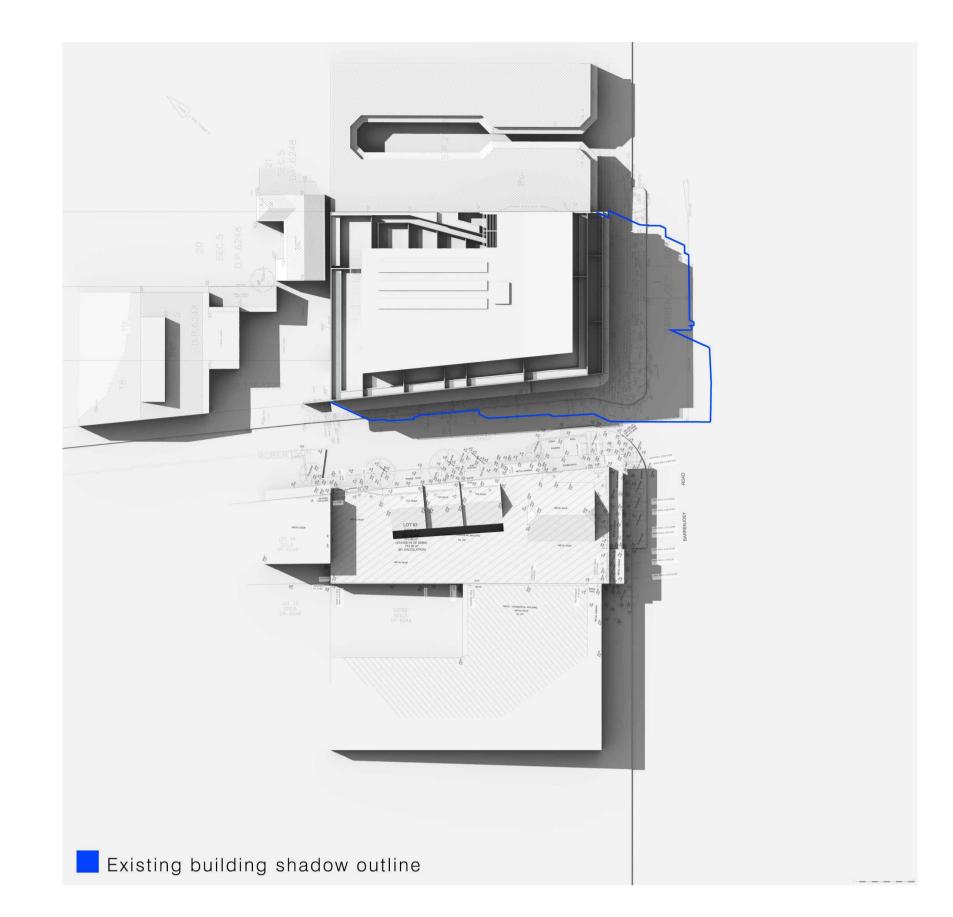

1:00pm 21th JUNE



2:00pm 21th JUNE





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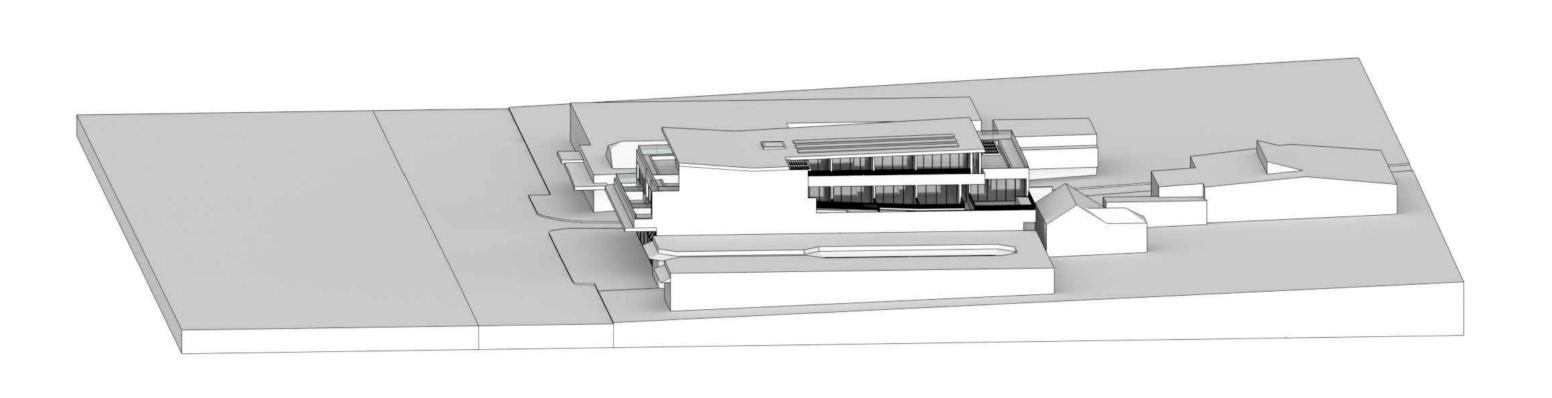
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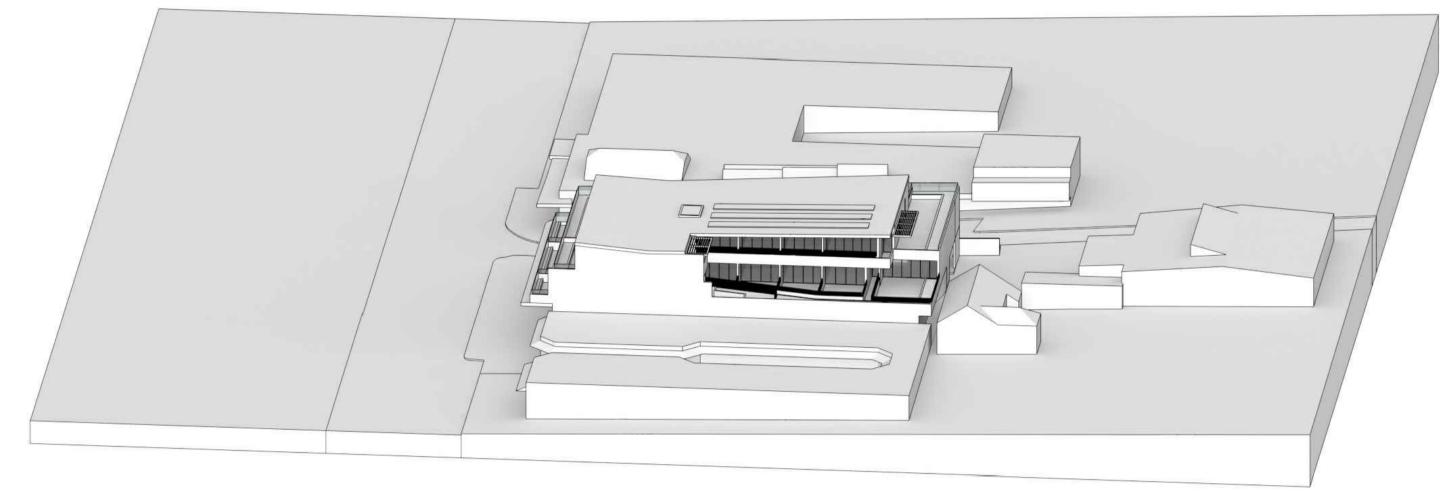
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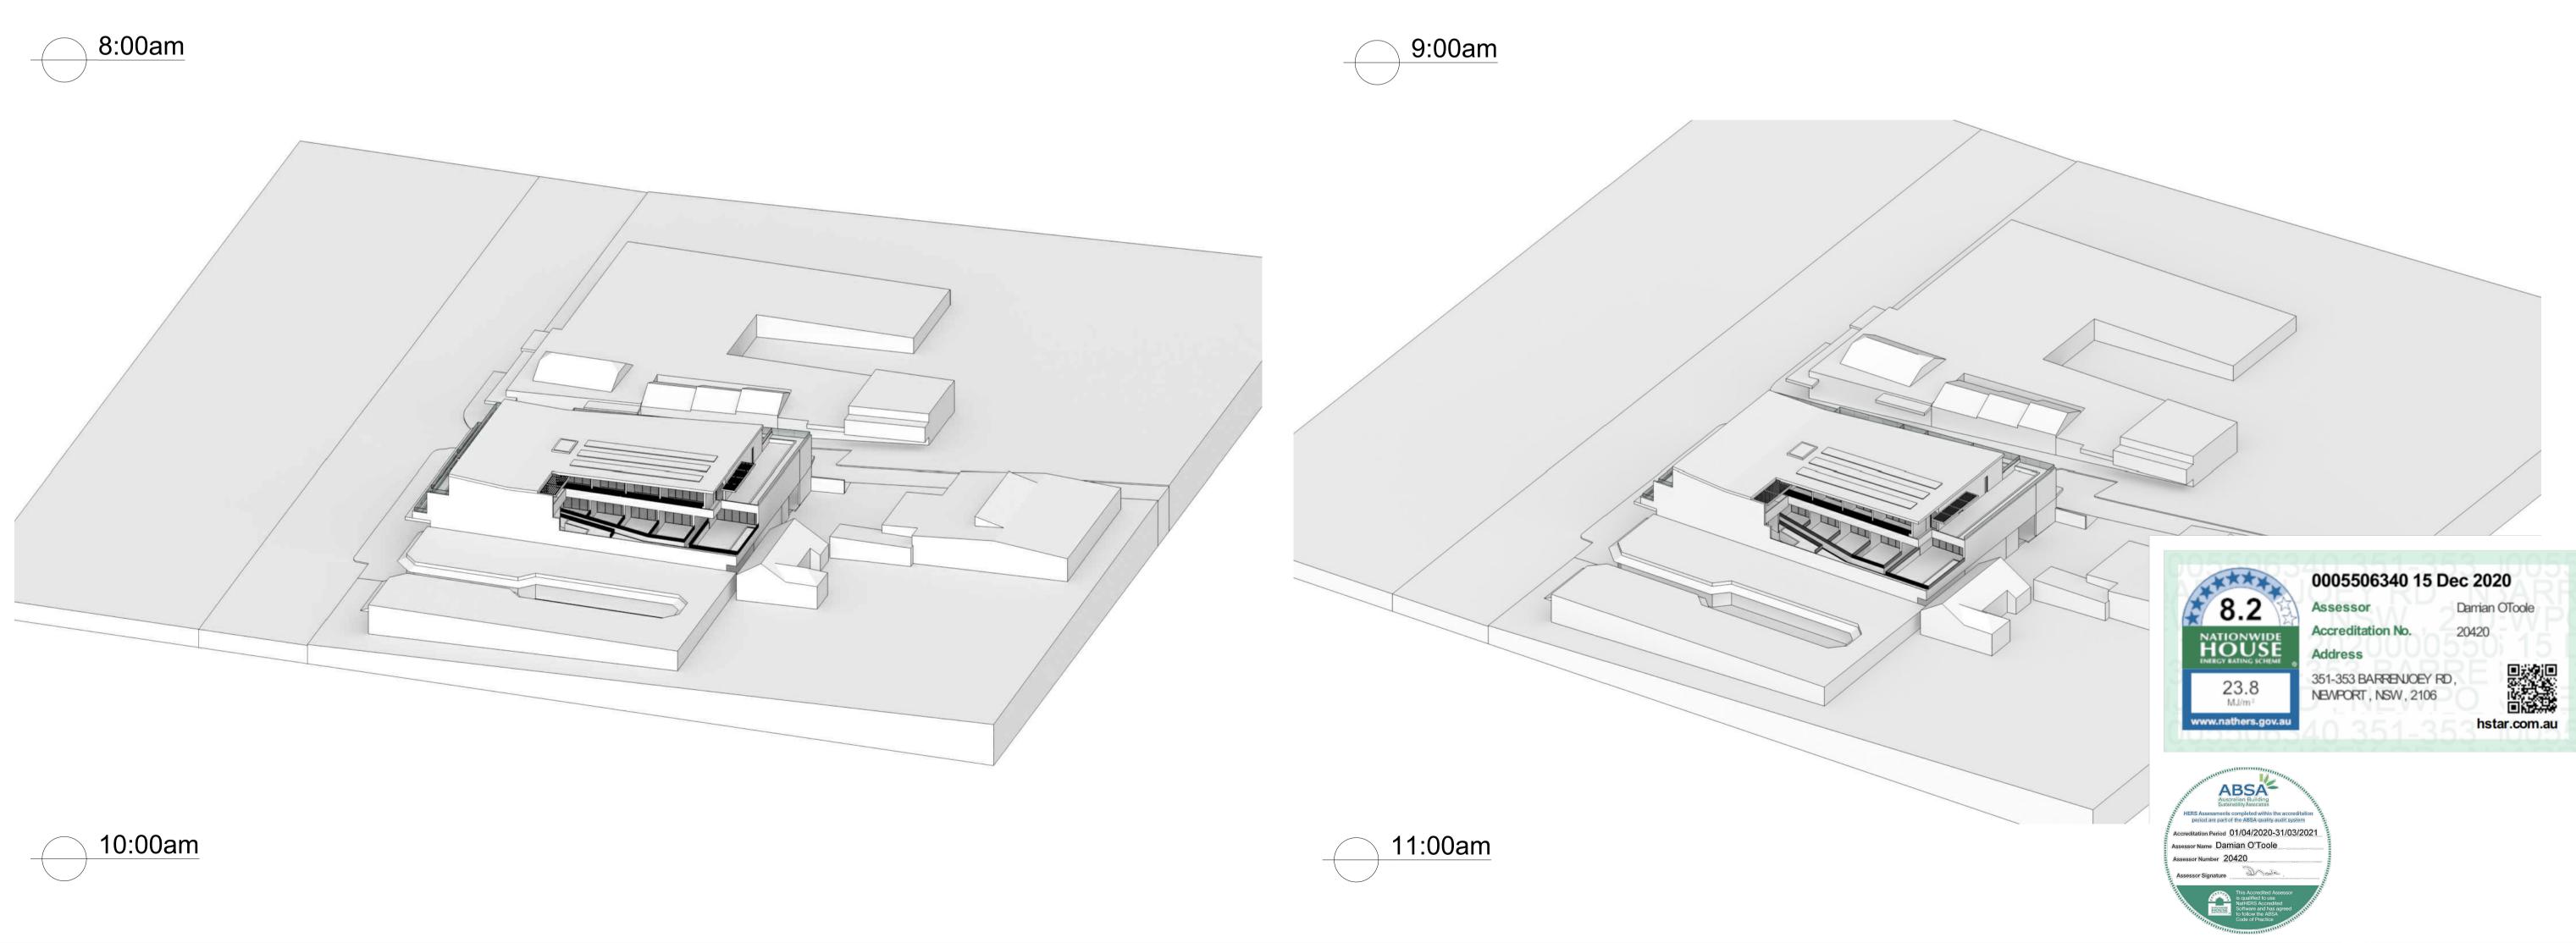
PROJECT NUMBER DRAWING NUMBER

Assessor Name Damian O'Toole









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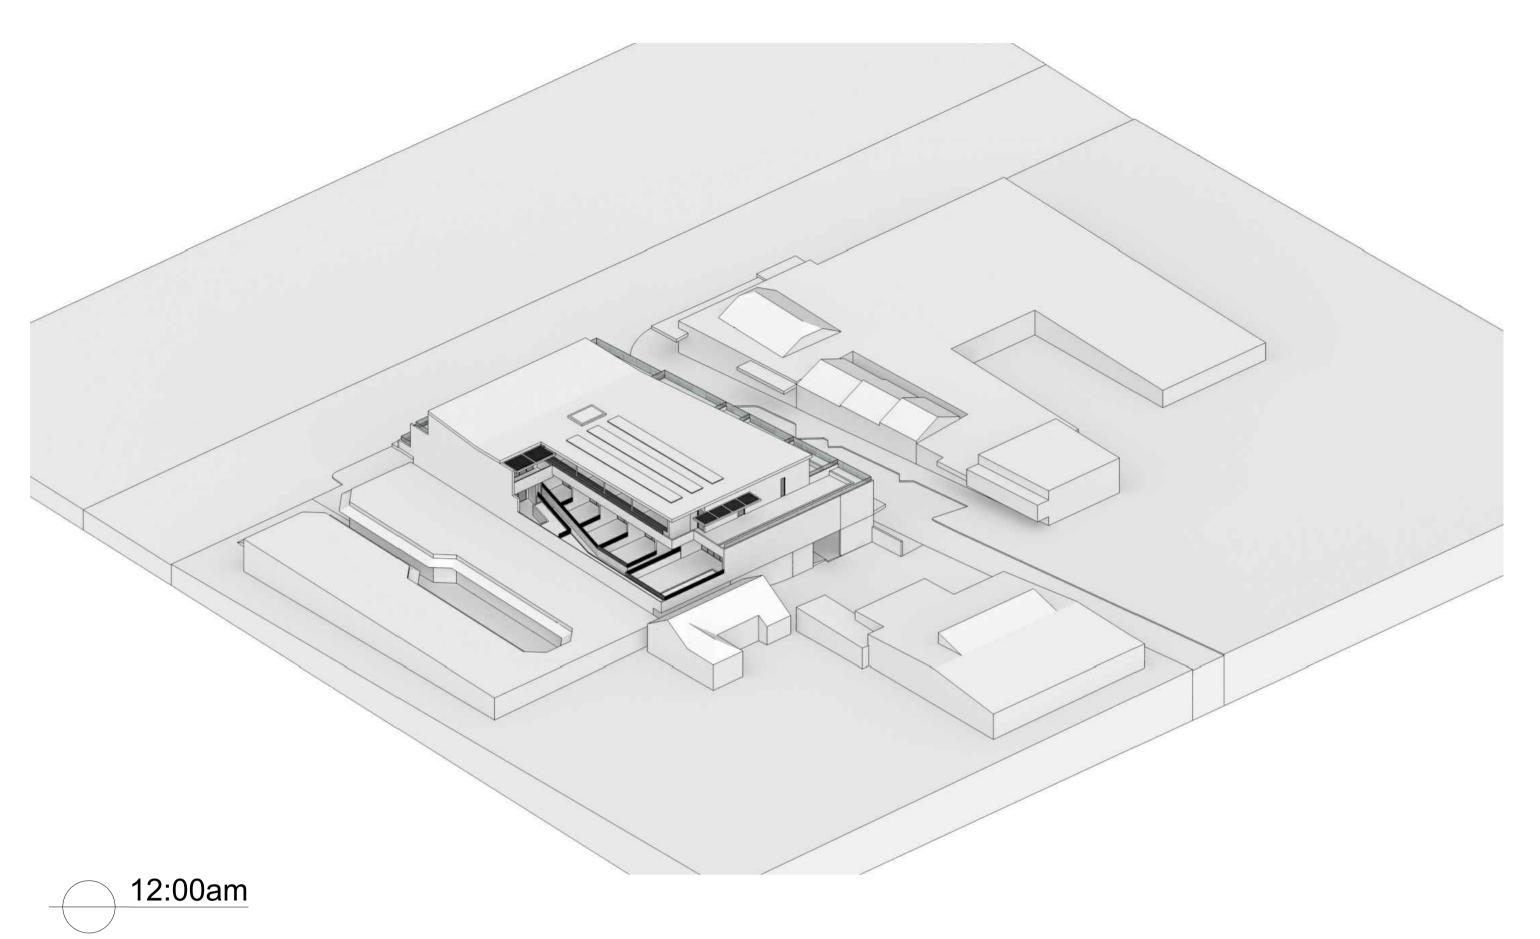
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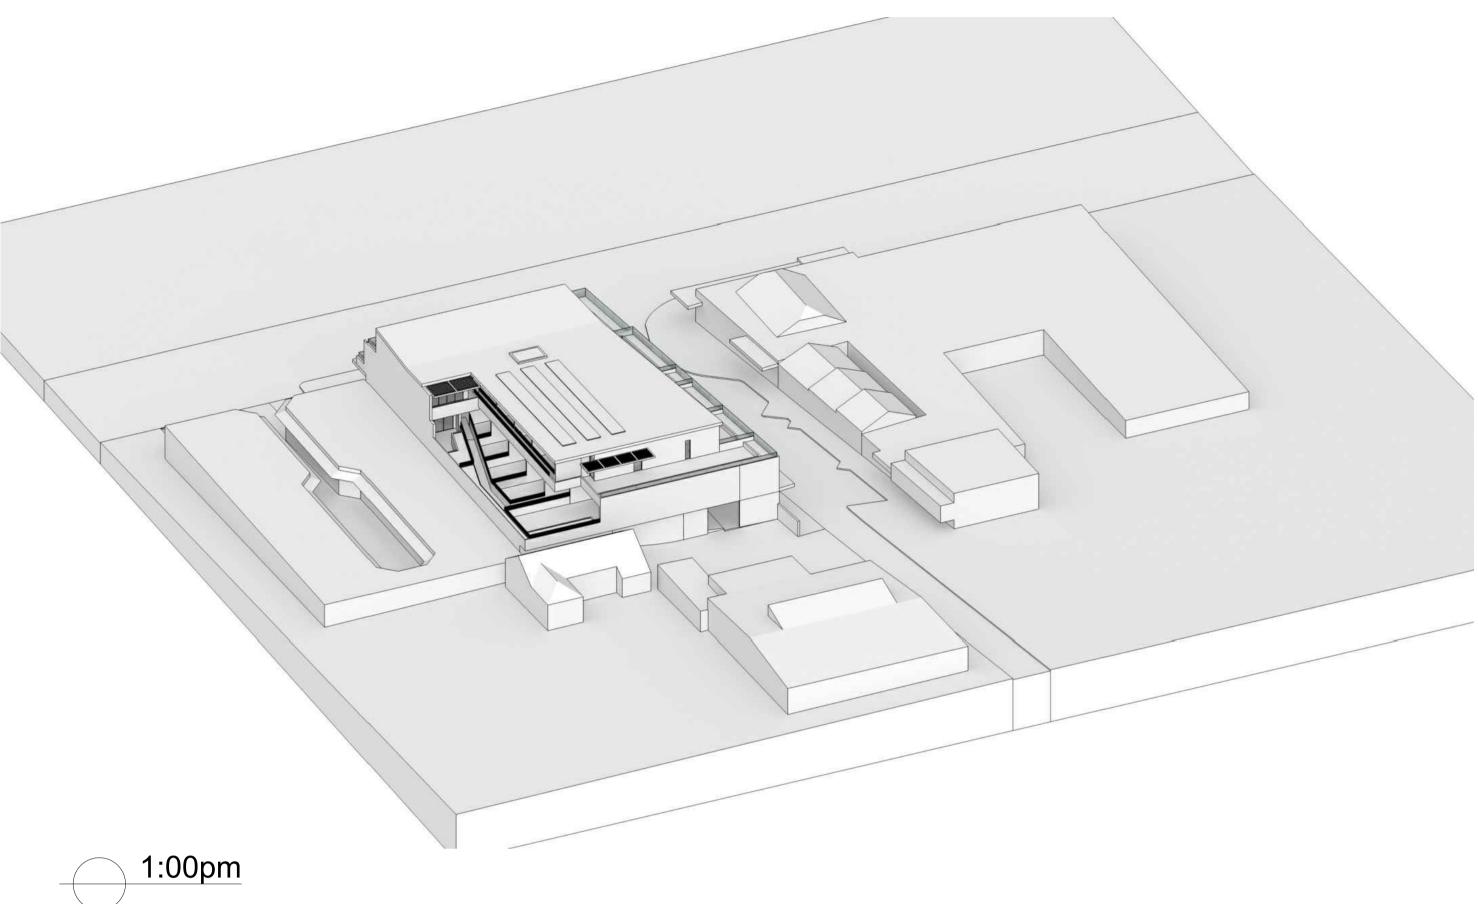
LOT 65 & 66 SEC 5 DP 6248


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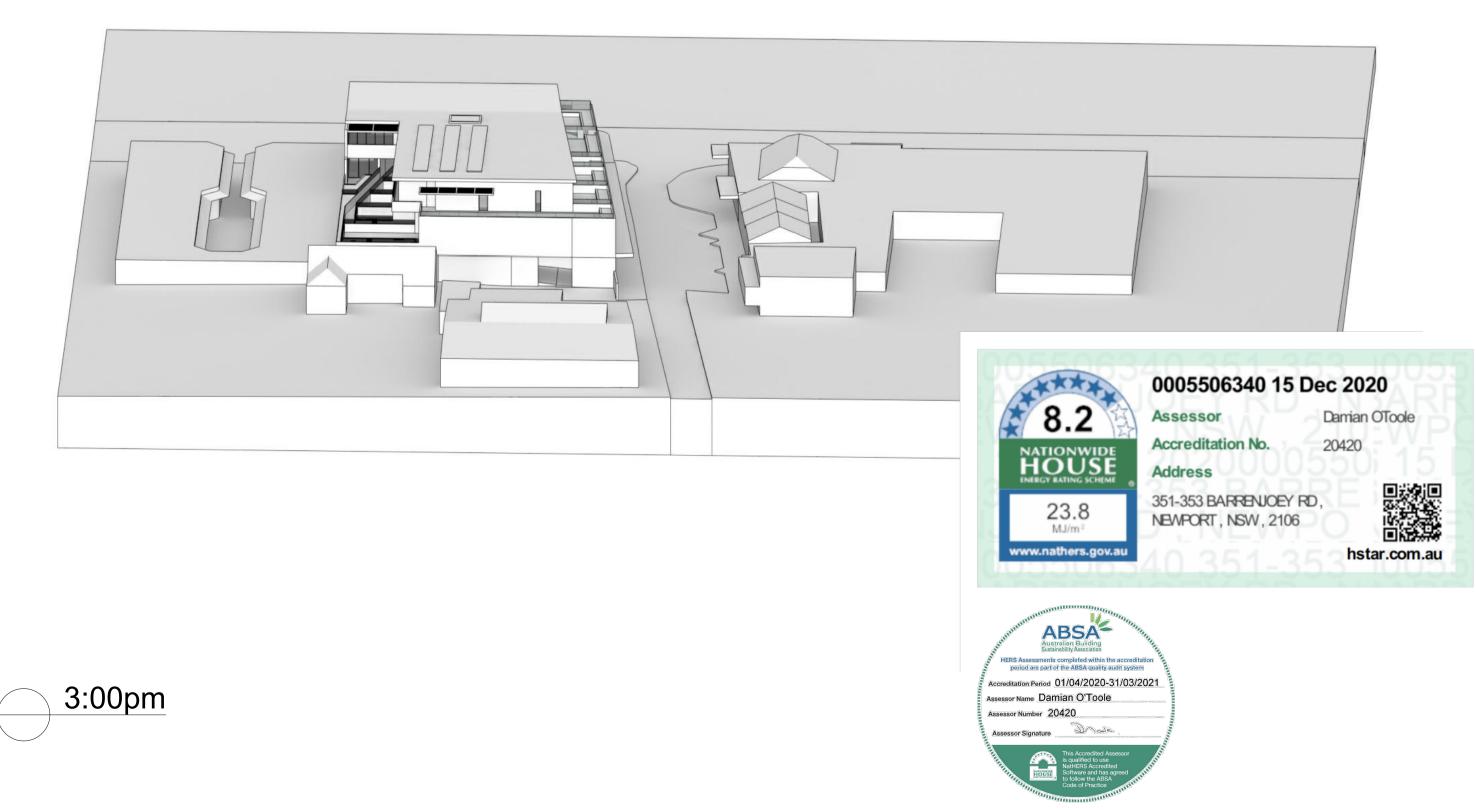
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ISSUE DATE AMENDMENTS

 03
 20.12.16
 DA ISSUE

 02
 20.12.15
 DA ISSUE

 01
 20.12.15
 DA ISSUE

DEVELOPMENT LINK

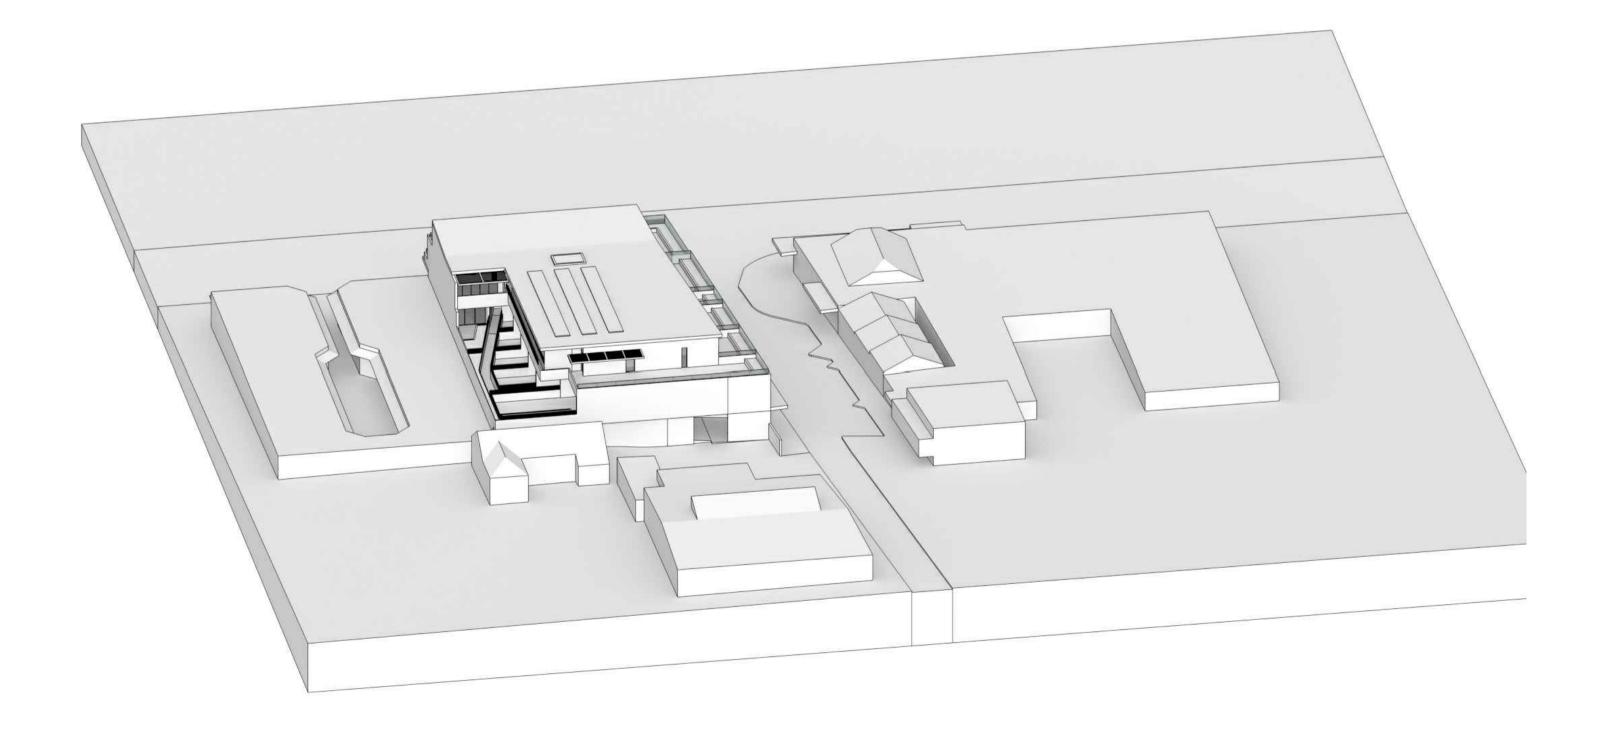
PROJECT MIXED USE DEVELOPMENT

LOT 65 & 66 SEC 5 DP 6248

351-353 BARRENJOEY ROAD, NEWPORT NSW 2106

SOLAR STUDIES SHEET 02

SCALE NTS APPROVED DRAWN CHECKED PG DATE JAN 2019 STATUS DA

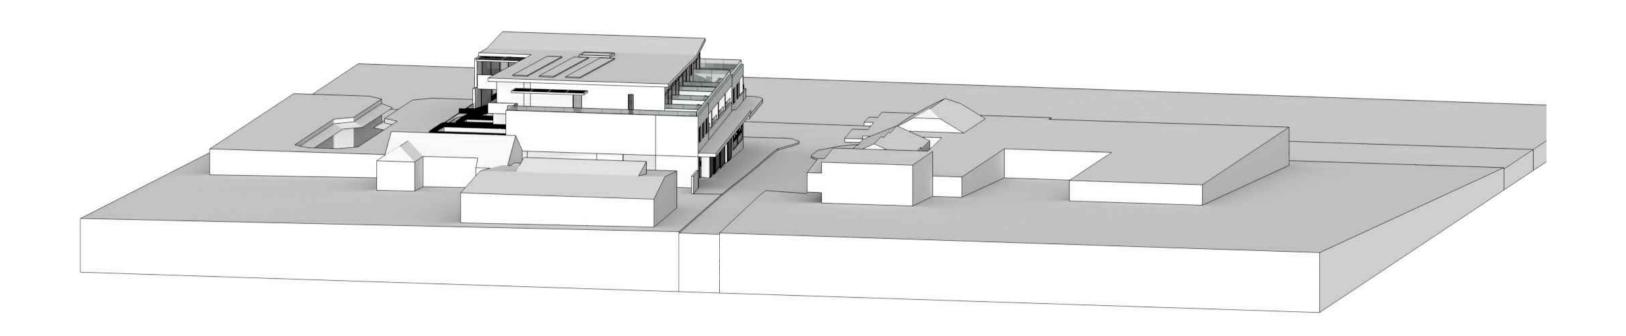







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**DEVELOPMENT LINK** 

PROJECT MIXED USE DEVELOPMENT

LOT 65 & 66 SEC 5 DP 6248

351-353 BARRENJOEY ROAD, NEWPORT NSW 2106

SOLAR STUDIES SHEET 03

SCALE NTS APPROVED DRAWN CHECKED PG DATE JAN 2019 STATUS DA

# MIXED USE DEVELOPMENT

# 351-353 Barrenjoey Road, Newport NSW 2106 Development Application

#### Drawing Schedule

| <b>Drawing Number</b> | Drawing Title                 | Scale    |
|-----------------------|-------------------------------|----------|
| 000                   | Landscape Coversheet          | N/A      |
| 101                   | Landscape Plan - Ground Floor | 1:100    |
| 102                   | Landscape Plan - Level 1      | 1:100    |
| 103                   | Landscape Plan - Level 2      | 1:100    |
| 501                   | Landscape Details             | AS SHOWN |

#### PLANT SCHEDULE

Sencio serpens

|           | Botanic Name                         | Common Name         | Mature Size | Pot Size | Density  | Qty |
|-----------|--------------------------------------|---------------------|-------------|----------|----------|-----|
| GROUND F  | LOOR                                 |                     |             |          |          |     |
| STREET TR | REES                                 |                     |             |          |          |     |
| TL        | Tristaniopsis 'Luscious'             | Water Gum           | 9 x 7       | 100L     | As Shown | 3   |
| SHRUBS &  | ACCENTS                              |                     |             |          |          |     |
| Ai        | Alcantarea imperialis 'Rubra'        | Imperial Bromeliad  | 1 x 1       | 300mm    | As shown | 2   |
| PX        | Philodendron 'Xanadu'                | Xanadu Philodendron | 1 x 1       | 300mm    | As Shown | 6   |
| Ss        | Spathiphyllum 'Sensation'            | Peace Lily          | 1 x 1       | 300mm    | As Shown | 4   |
| GRASSES   | & GROUND COVERS                      |                     |             |          |          |     |
| DSF       | Dichondra Silver Falls               | Silver Falls        | .1 x .7     | 300mm    | 4/lm     | 59  |
| PLANTING  | MATRIX                               |                     |             |          |          |     |
| Dc        | Dianella congesta                    | Beach Flax Lily     | 0.5 x 1     | 150mm    | 3/m2     | 53  |
| LV        | Lomandra 'Verday'                    | Spiny-head mat-rush | 0.5 x 1     | 150mm    | 3/m2     | 53  |
| LEVEL 1   |                                      |                     |             |          |          |     |
| SHRUBS &  | ACCENTS                              |                     |             |          |          |     |
| Ai        | Alcantarea imperialis 'Rubra'        | Imperial Bromeliad  | 1 x 1       | 300mm    | As shown | 23  |
| PX        | Philodendron 'Xanadu'                | Xanadu Philodendron | 1 x 1       | 300mm    | As Shown | 23  |
| Ri        | Raphiolepsis indica 'Oriental Pearl' | Indian Hawthorne    | 1 x 1       | 300mm    | As shown | 106 |
| Vo        | Viburnum odoratissimum               | Sweet Viburnum      | 3 x 2       | 300mm    | As shown | 34  |
| GRASSES   | & GROUND COVERS                      |                     |             |          |          |     |
| Cg        | Carpobrotus glaucascens              | Pig Face            | 0.2 x 1     | 150mm    | 4/lm     | 132 |
| DSF       | Dichondra Silver Falls               | Silver Falls        | .1 x .7     | 300mm    | 4/lm     | 157 |
| LEG       | Lirope muscari 'Evergreen Giant'     | Lirope              | 0.6 x 0.5   | 150mm    | 5/m2     | 29  |
| LEVEL 2   |                                      |                     |             |          |          |     |
| SHRUBS &  | ACCENTS                              |                     |             |          |          |     |
| Aa        | Agave 'Blue Glow'                    | Blue Glow Agave     | 1 x 1       | 300mm    | As Shown | 21  |
| СВВ       | Crassula 'Blue Bird'                 | Bluebird            | 1 x 1       | 300mm    | As shown | 39  |
| PM        | Pittospormum 'Miss Muffet'           | Miss Muffet         | 1 x 1       | 300mm    | As shown | 98  |
| Ri        | Raphiolepsis indica 'Oriental Pearl' | Indian Hawthorne    | 1 x 1       | 300mm    | As shown | 127 |
| GRASSES   | & GROUND COVERS                      |                     |             |          |          |     |
| Cg        | Carpobrotus glaucascens              | Pig Face            | 0.2 x 1     | 150mm    | 4/lm     | 165 |
| 909       | Canaia aarnana                       | Plus Chalk Sticks   | 02405       | 150mm    | 5/m2     | 140 |

Blue Chalk Sticks

 $0.2 \times 0.5$ 

5/m2


148

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The contractor shall check and verify all work on site (including work by others) before commencing the landscape installation. Any discrepancies are to be reported to the Project Manager or Landscape Architect prior to commencing work. Do not scale this drawing. Any required dimensions not shown shall be referred to the Landscape Architect for confirmation.

| D     | ARCHITECTURAL COORDINATION | JM    | NM    | 08.12.2020 |  |
|-------|----------------------------|-------|-------|------------|--|
| С     | STREET TREES ADDED         | JM    | NM    | 24.09.2019 |  |
| В     | FOR COMMENT                | SM    | NM    | 29.08.2019 |  |
| Α     | FOR COMMENT                | SM    | NM    | 29.08.2019 |  |
| Issue | Revision Description       | Drawn | Check | Date       |  |

LEGEND

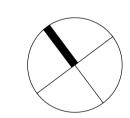

DEVELOPMENT LINK

Mixed Use Development 351-353 Barrenjoey Road Newport NSW 2106

SITE IMAGE

Level 1, 3-5 Baptist Street Redfern NSW 2016 Australia

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000 D

DEVELOPMENT APPLICATION

Landscape Coversheet


SS19-4170

Scale: Job Number:



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DEVELOPMENT LINK

P

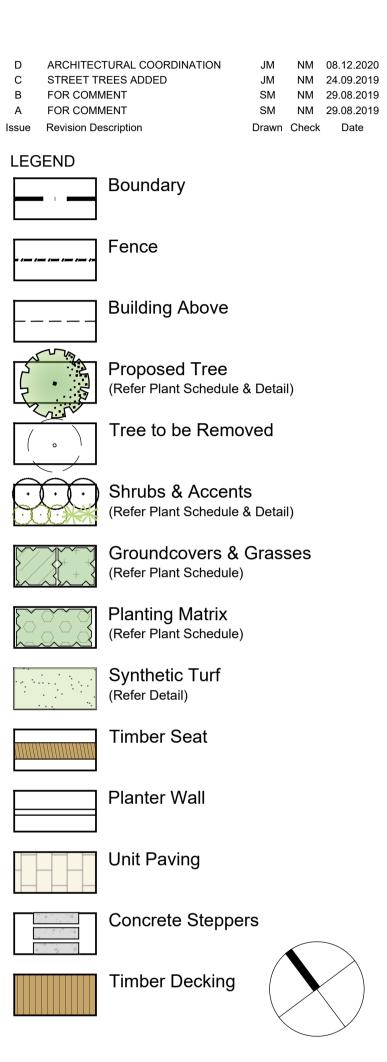Mixed Use Development 351-353 Barrenjoey Road Newport NSW 2106

SITE IMAGE

Landscape Architects

### DEVELOPMENT APPLICATION

Drawing Name:

Landscape Plan

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# Ground Floor

Scale: 1:100 @ A1 0 1 2 3 4


Job Number: Drawing Number:

SS19-4170 101 D

ROBERTSON ROAD

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Australia

Level 1, 3-5 Baptist Street Redfern NSW 2016

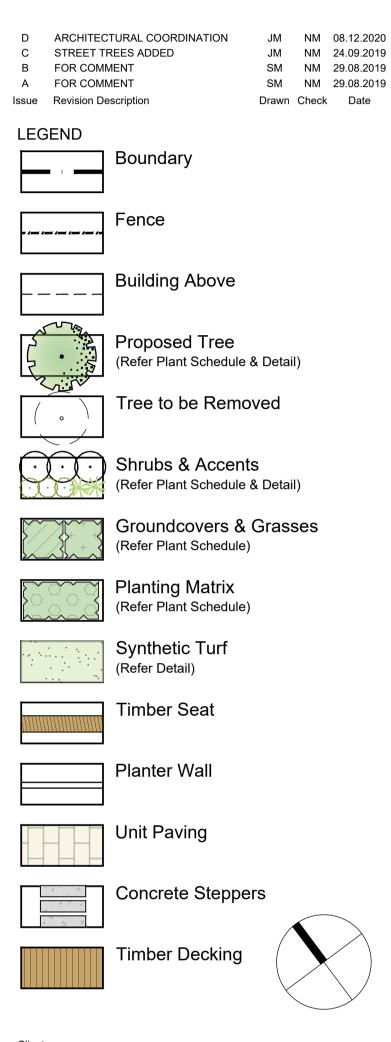Landscape Architects

DEVELOPMENT APPLICATION

Drawing Name:

Landsca

Landscape Plan

Level 1

Job Number:

A1 0 1 2 3 4 5


Drawing Number: Iss

SS19-4170

102 D

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Landscape Architects

#### DEVELOPMENT APPLICATION

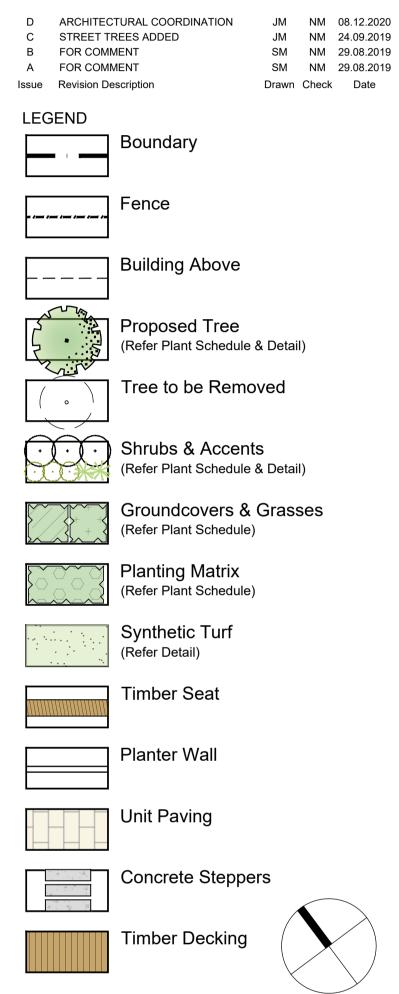Landscape Plan


Level 2

Job Number:


103 D

SS19-4170


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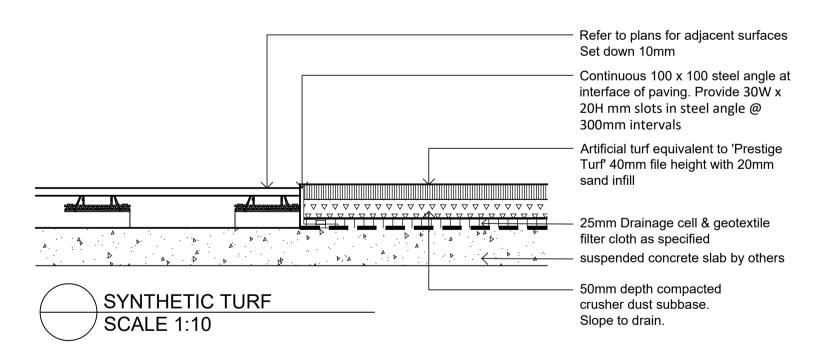


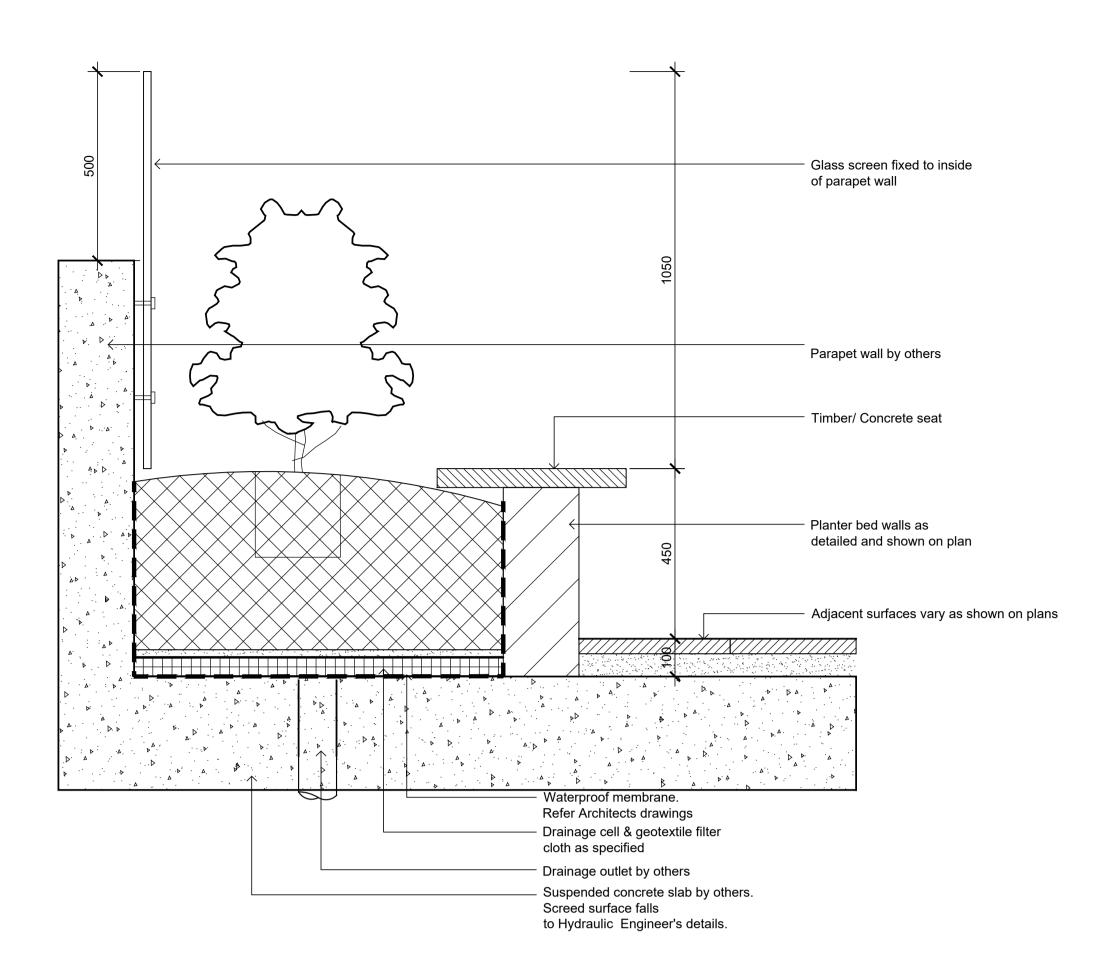


Detail Shrub Accent & Groundcover Planting on Structure

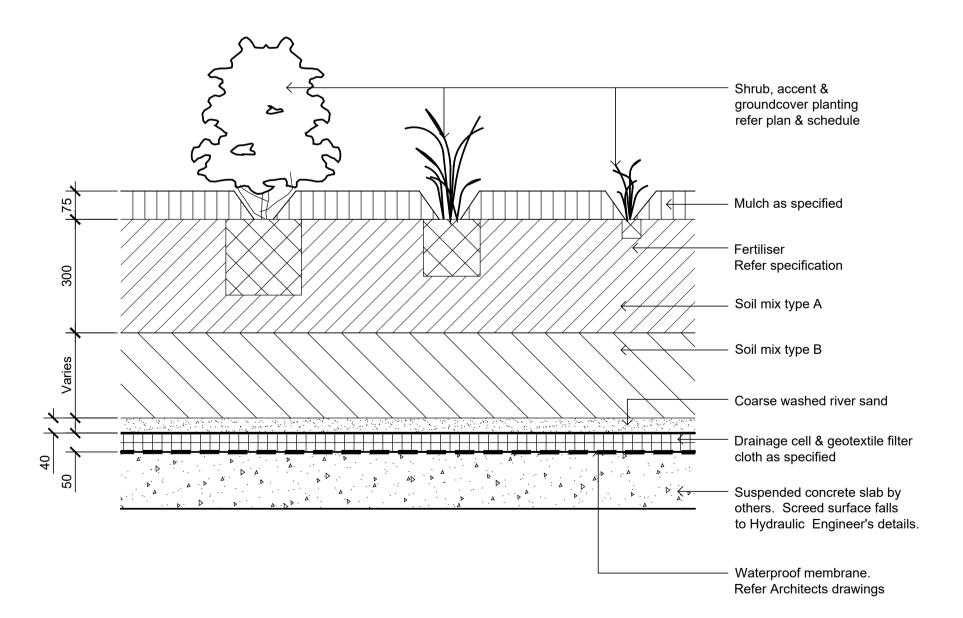

Section - Typical Raised Planter Bed on Structure Inspection riser pipe

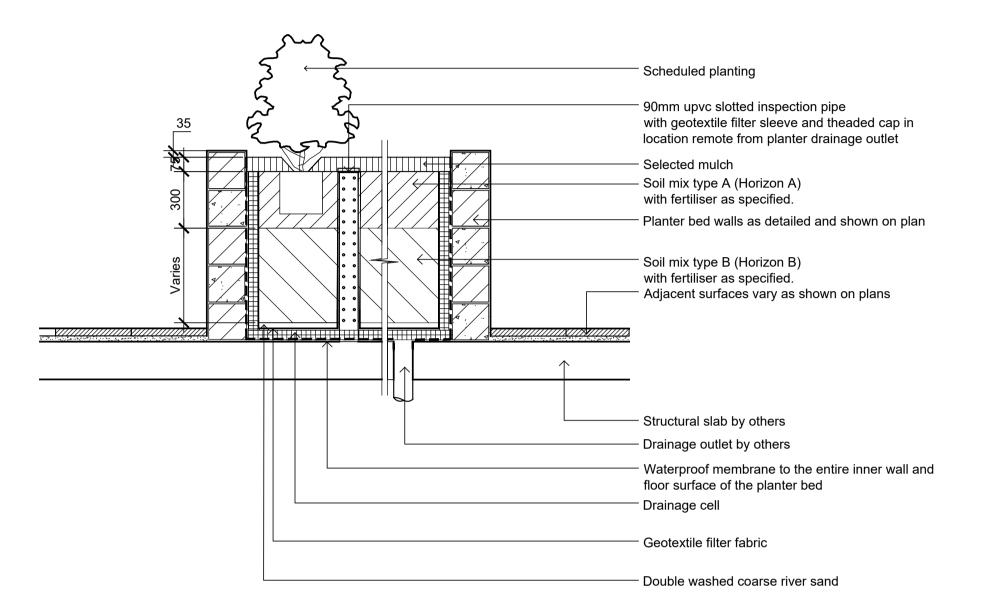

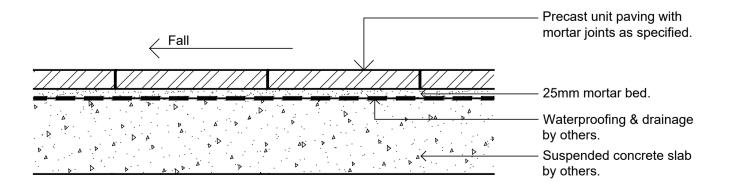




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D ARCHITECTURAL COORDINATION JM NM 08.12.2020 STREET TREES ADDED JM NM 24.09.2019 B FOR COMMENT SM NM 29.08.2019 A FOR COMMENT SM NM 29.08.2019 Issue Revision Description Drawn Check Date

LEGEND



DEVELOPMENT LINK
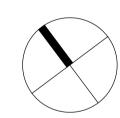
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Landscape Architects

DEVELOPMENT APPLICATION

Drawing Name: Landscape Details

**AS SHOWN** Job Number:

SS19-4170

501 D

# Proposed Development - Stormwater 351 Barrenjoey Road NEWPORT

#### STORMWATER DRAINAGE NOTES:

#### **GENERAL NOTES:**

- D1. All levels are to Australian Height Datum (AHD), unless noted
- D2. Dimensions shall not be scaled from drawings.
- D3. The Contractor must verify all dimensions on site prior to commencement of the works.
- D4. These plans shall be read in conjunction with the approved Architectural, Structural, Mechanical, Hydraulic, Electrical, Landscape & other Consultants drawings.
- D5. Where new work abuts existing, the Contractor shall ensure a smooth even profile free from abrupt changes.
- D6. The Contractor shall arrange for all survey setout & as-built to be performed by a Registered Surveyor.
- D7. Invert levels are given at critical locations. The Contractor/Drainer shall determine levels on minor drainage lines and confirm design
- D8. Stormwater drains min. fall 1:100, unless noted otherwise.
- D9. Advise Engineer for Inspection of all Stormwater works, pipes & pits, prior to covering. Provide as-built survey upon completion.
- D10. Construction of Drainage to conform with the requirements of the relevant Authority or Council.
- D11. Connections to new & existing drainage shall be neatly trimmed & cement rendered to a smooth finish.
- D12. All work shall be in accordance with AS3500 'National Plumbing & Drainage Code', unless noted otherwise.
- D13. The Contractor shall expose the full drainage route and point of discharge from the site and confirm levels prior to commencing

#### EXISTING SERVICES

- D14. The Contractor shall excavate for, locate and co-ordinate with all services within & beyond the property line prior to the commencement of the Works.
- D15. Existing services which are to remain shall be adjusted as necessary to suit the new Works.
- D16. Existing services no longer required shall be capped off and removed out of sight to the relevant authorities requirements.
- D17. Care is to be taken when excavating near existing services. Obtain services setout prior to works. Hand excavate as required to avoid
- D18. Construct temporary services as required.

#### DRAINAGE PIPES:

- D19. UPVC type pipes shall be used for pipes not greater than 300mm diameter, unless noted otherwise. UPVC pipes shall have solvent welded watertight joints.
- D20. Pipe diameter greater than 300mm shall be FRC type pipe Class '3', unless noted otherwise.
- D21. Pipe laying, bedding & backfill to be in accordance with the specification and the pipe manufacturer's requirements.
- D22. Where UPVC drainage pipes pass under slabs, sewer grade pipes shall
- D23. Contractor shall supply & install all proprietary fittings for connections & junctions.
- D24. Additional subsoil drainage may be required where site conditions & groundwater dictate. Refer to Engineer for site inspection.
- D25. Pipes to be  $100\phi$  unless noted otherwise.
- D26. Outlet pipes from pits shall have invert level at least 30mm lower than the invert level of the lowest pipe entering the pit.
- D27. Inspection openings or stormwater pits shall be located where shown on the drawings and at the following locations:
- a. Each point of connection b. Even spacing not more than 30m apart. c. Each end of any inclined jump-up which exceeds 6m in length. d. Each connection to an existing stormwater drain. e. Any change of direction greater than 45°.
- D28. Inspection openings shall be min 150 $\phi$  and shall be plugged or capped in accordance with AS3500.
- D29. Planter boxes bases to be lined with 'Atlantis Drainage Cell' or approved equivalent wrapped in geotextile and draining to subsoil drainage pipes connected to the main stormwater system. Co-ordinate with requirements of Landscape Architect.
- D30. Junctions in stormwater drains shall be made by means of a proprietary coupler or for pipes of at least 350 $\phi$  opening cut as detailed on the drawings.

#### DRAINAGE PITS:

- D31. All pits and arrestors shall be constructed to the relevant authorities requirements. Provide local falls to pits.
- D32. Minimum cover to all reinforcement in concrete to be 40mm.
- D33. Minimum Drainage pit size shall be as follows:

| Depth to Invert ( | Minimum Internal Dimensions (mm) |        |          |  |  |
|-------------------|----------------------------------|--------|----------|--|--|
|                   | Recta                            | ngular | Circular |  |  |
| <b>,</b> ,,,,,    | Width                            | Length | Diameter |  |  |
| ≪600              | 450                              | 450    | 600      |  |  |
| >600 ≤ 900        | 600                              | 600    | 900      |  |  |
| >900 ≤1200        | 600                              | 900    | 1000     |  |  |
| >1200             | 900                              | 900    | 1000     |  |  |

- D34. All pits to have galvanised hinged lockable gratings equivalent to "Grate Drainage Products Pty Ltd" heelguard type. Use Class B in general areas and Class D in areas subject to
- D35. Drainage pit size may need to be increased over minimum to suit pipe size. Pit internal dimensions shall be of least 300mm greater than external diameter of corresponding pipe.
- D36. Pits deeper than 1000mm are to be fitted with step irons at 300mm centres. Contact Engineer for typical detail.
- D37. All exposed pit edges shall be rounded with 20mm radius or 20 x 20
- D38. Walls of cast insitu pits shall be 200mm (min.) thick concrete, grade N32, unless noted otherwise.
- D39. Pits shall be reinforced with SL81 fabric, central in walls & base slab U.N.O. Mesh to be lapped 400mm. Lap mesh at corners or use N12-200 "L" bars lapping 400 each way.
- D40. Approved precast pits may be used.
- D41. Bases of drainage pits shall be grouted to prevent ponding of water, unless noted otherwise.


|                  | LEGEND  |
|------------------|---|
|                  | Denotes stormwater pipe. Denotes subsoil drain.   |
| 100∅<br>EP       | Denotes pipe diameter in mm.  |
| 1:100            | Denotes existing pipe Pipe grade as a percentage (min)  |
| I.L.139.50       | Denotes invert level.   |
| G.L.139.50       | Denotes ground level.   |
| R.L.139.50       | Denotes reduced level.  |
| <b>—</b> —       | Denotes stormwater pit.   |
| <b>—</b>         | Denotes grated stormwater pit.  |
| K.I.             | Denotes kerb entry & roadway pit system (900 x 600)   |
|                  | Denotes 100 wide x 100 min. depth grated drain type "ACO KS100" with Class A antislip stainless steel heelguard grates U.N.O. Grated drains in areas subject to vehicle loads to be K100 and have Class D "ACO" perforated steel grating. |
| o <sup>D.P</sup> | Denotes downpipes.  |
| <del>-0</del>    | Denotes downpipe with spreader  |
| <b>⊜</b> RWO     | Represents 100mm round outlet, modelTIA100/90F<br>by speciality plumbing supplier. Cast iron RWO with<br>galvanised heavy duty flat grate.  |
| <b>⊜</b> BD      | Represents smart drain with ø65 outlet pipe cast in slab and connected to surface drainage  |
| <b>⊜</b> PD      | Planter drain. 'Specialty Plumbing Supplies' 100mm<br>RWO (TIA 100/90PB) with planter box insert  |

—EXISTING SURFACE


- FINISHED SURFACE

TYPICAL PIPE LAYING

ADJACENT TO FOOTINGS

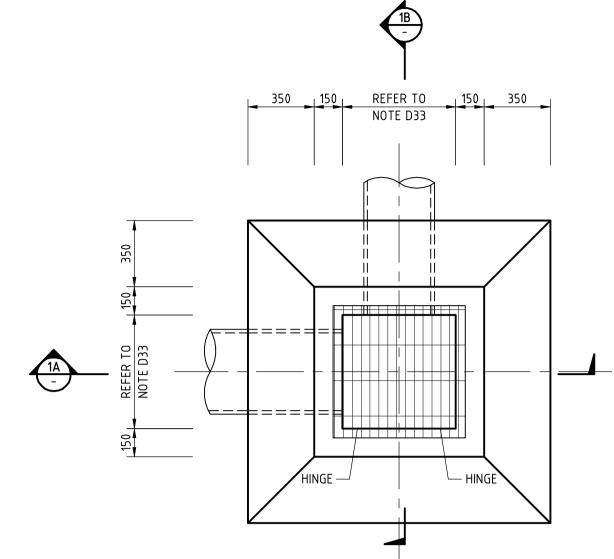



#### GRATED PIT PLAN

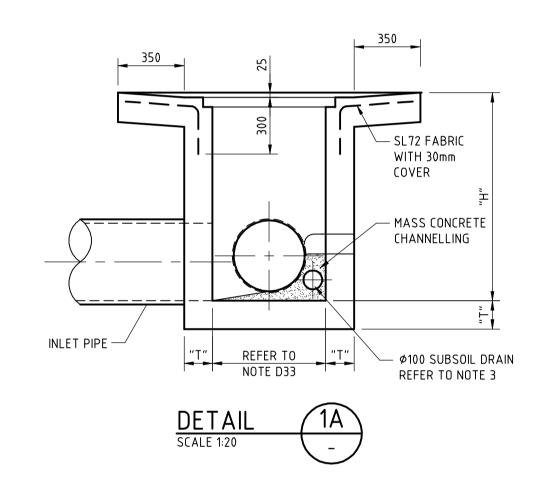


#### SAG INLET PIT NOTES:

- COMPRESSIVE STRENGTH OF CONCRETE TO BE A MINIMUM OF 20MPa AT 28 DAYS.
- 2. TOP OF BENCHING SHALL BE 1/2 OF OUTLET PIPE DIAMETER.
- Ø100 SUBSOIL DRAINAGE PIPE 3m LONG WRAPPED IN FABRIC SOCK TO BE PROVIDED AT INVERT LEVEL EITHER SIDE OF INLET
- 4. PIT GRATE TO BE 'WELDLOK' OR APPROVED EQUIVALENT.
- 5. PROVIDE STEP IRONS WHERE PIT IS DEEPER THAN 1200

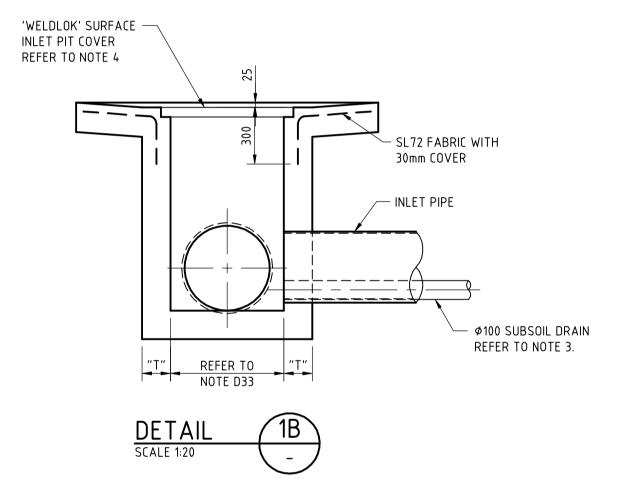

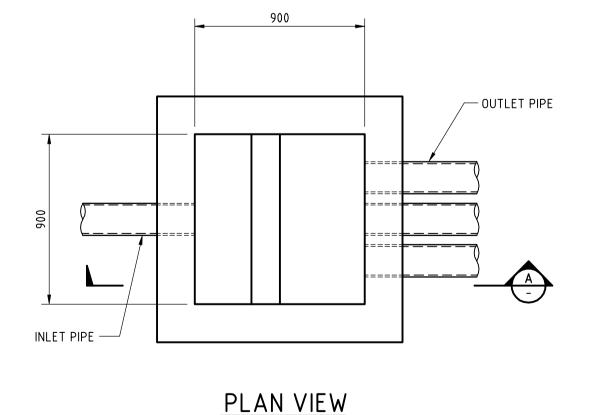

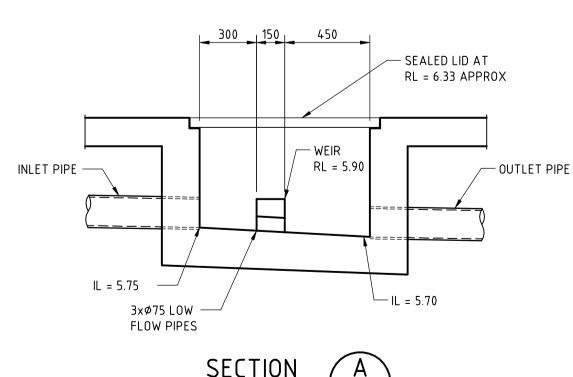

FLOW EQUALISATION PIT

**ARCHITECT:** 

CLIENT:

# DRAWING SCHEDULE

Demlakian Engineers Pty Limited

ABN 27 928 564 091

+61 (0)2 9955 4485 Demlakian.com.au

T/A Demlakian Consulting Engineers


SW00 STORMWATER NOTES & DRAWING SCHEDULE

SW01 BASEMENT LEVEL 2 DRAINAGE CONCEPT PLAN


SW02 GROUND FLOOR DRAINAGE CONCEPT PLAN

SW03 SEDIMENT CONTROL PLAN

SW04 SEDIMENT AND EROSION CONTROL DETAILS

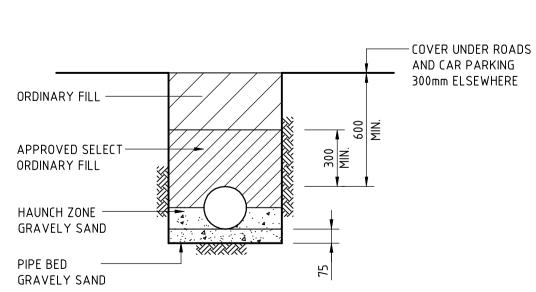



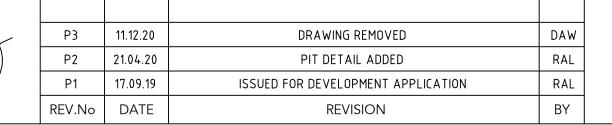



This drawing MUST be read in conjunction with ALL other drawings for this project including but not limited to all construction notes.

| FOR DEVELOPMENT |  |
|-----------------|--|
| APPLICATION     |  |

| : | CRAWFORD ARCHITECTS | PROJECT: | Proposed Development<br>351 Barrenjoey Road NEWPOR |
|---|---------------------|----------|--|
|   | DEVELOPMENT LINK    | TITLE:   | STORMWATER NOTES OF DRAWING SCHEDULE               |

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Demlakian.com.au
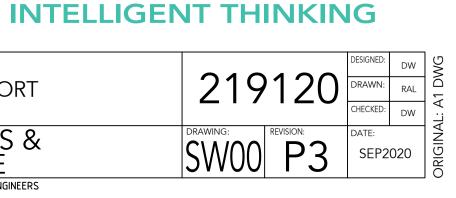
# BASEMENT LEVEL 2 DRAINAGE CONCEPT PLAN

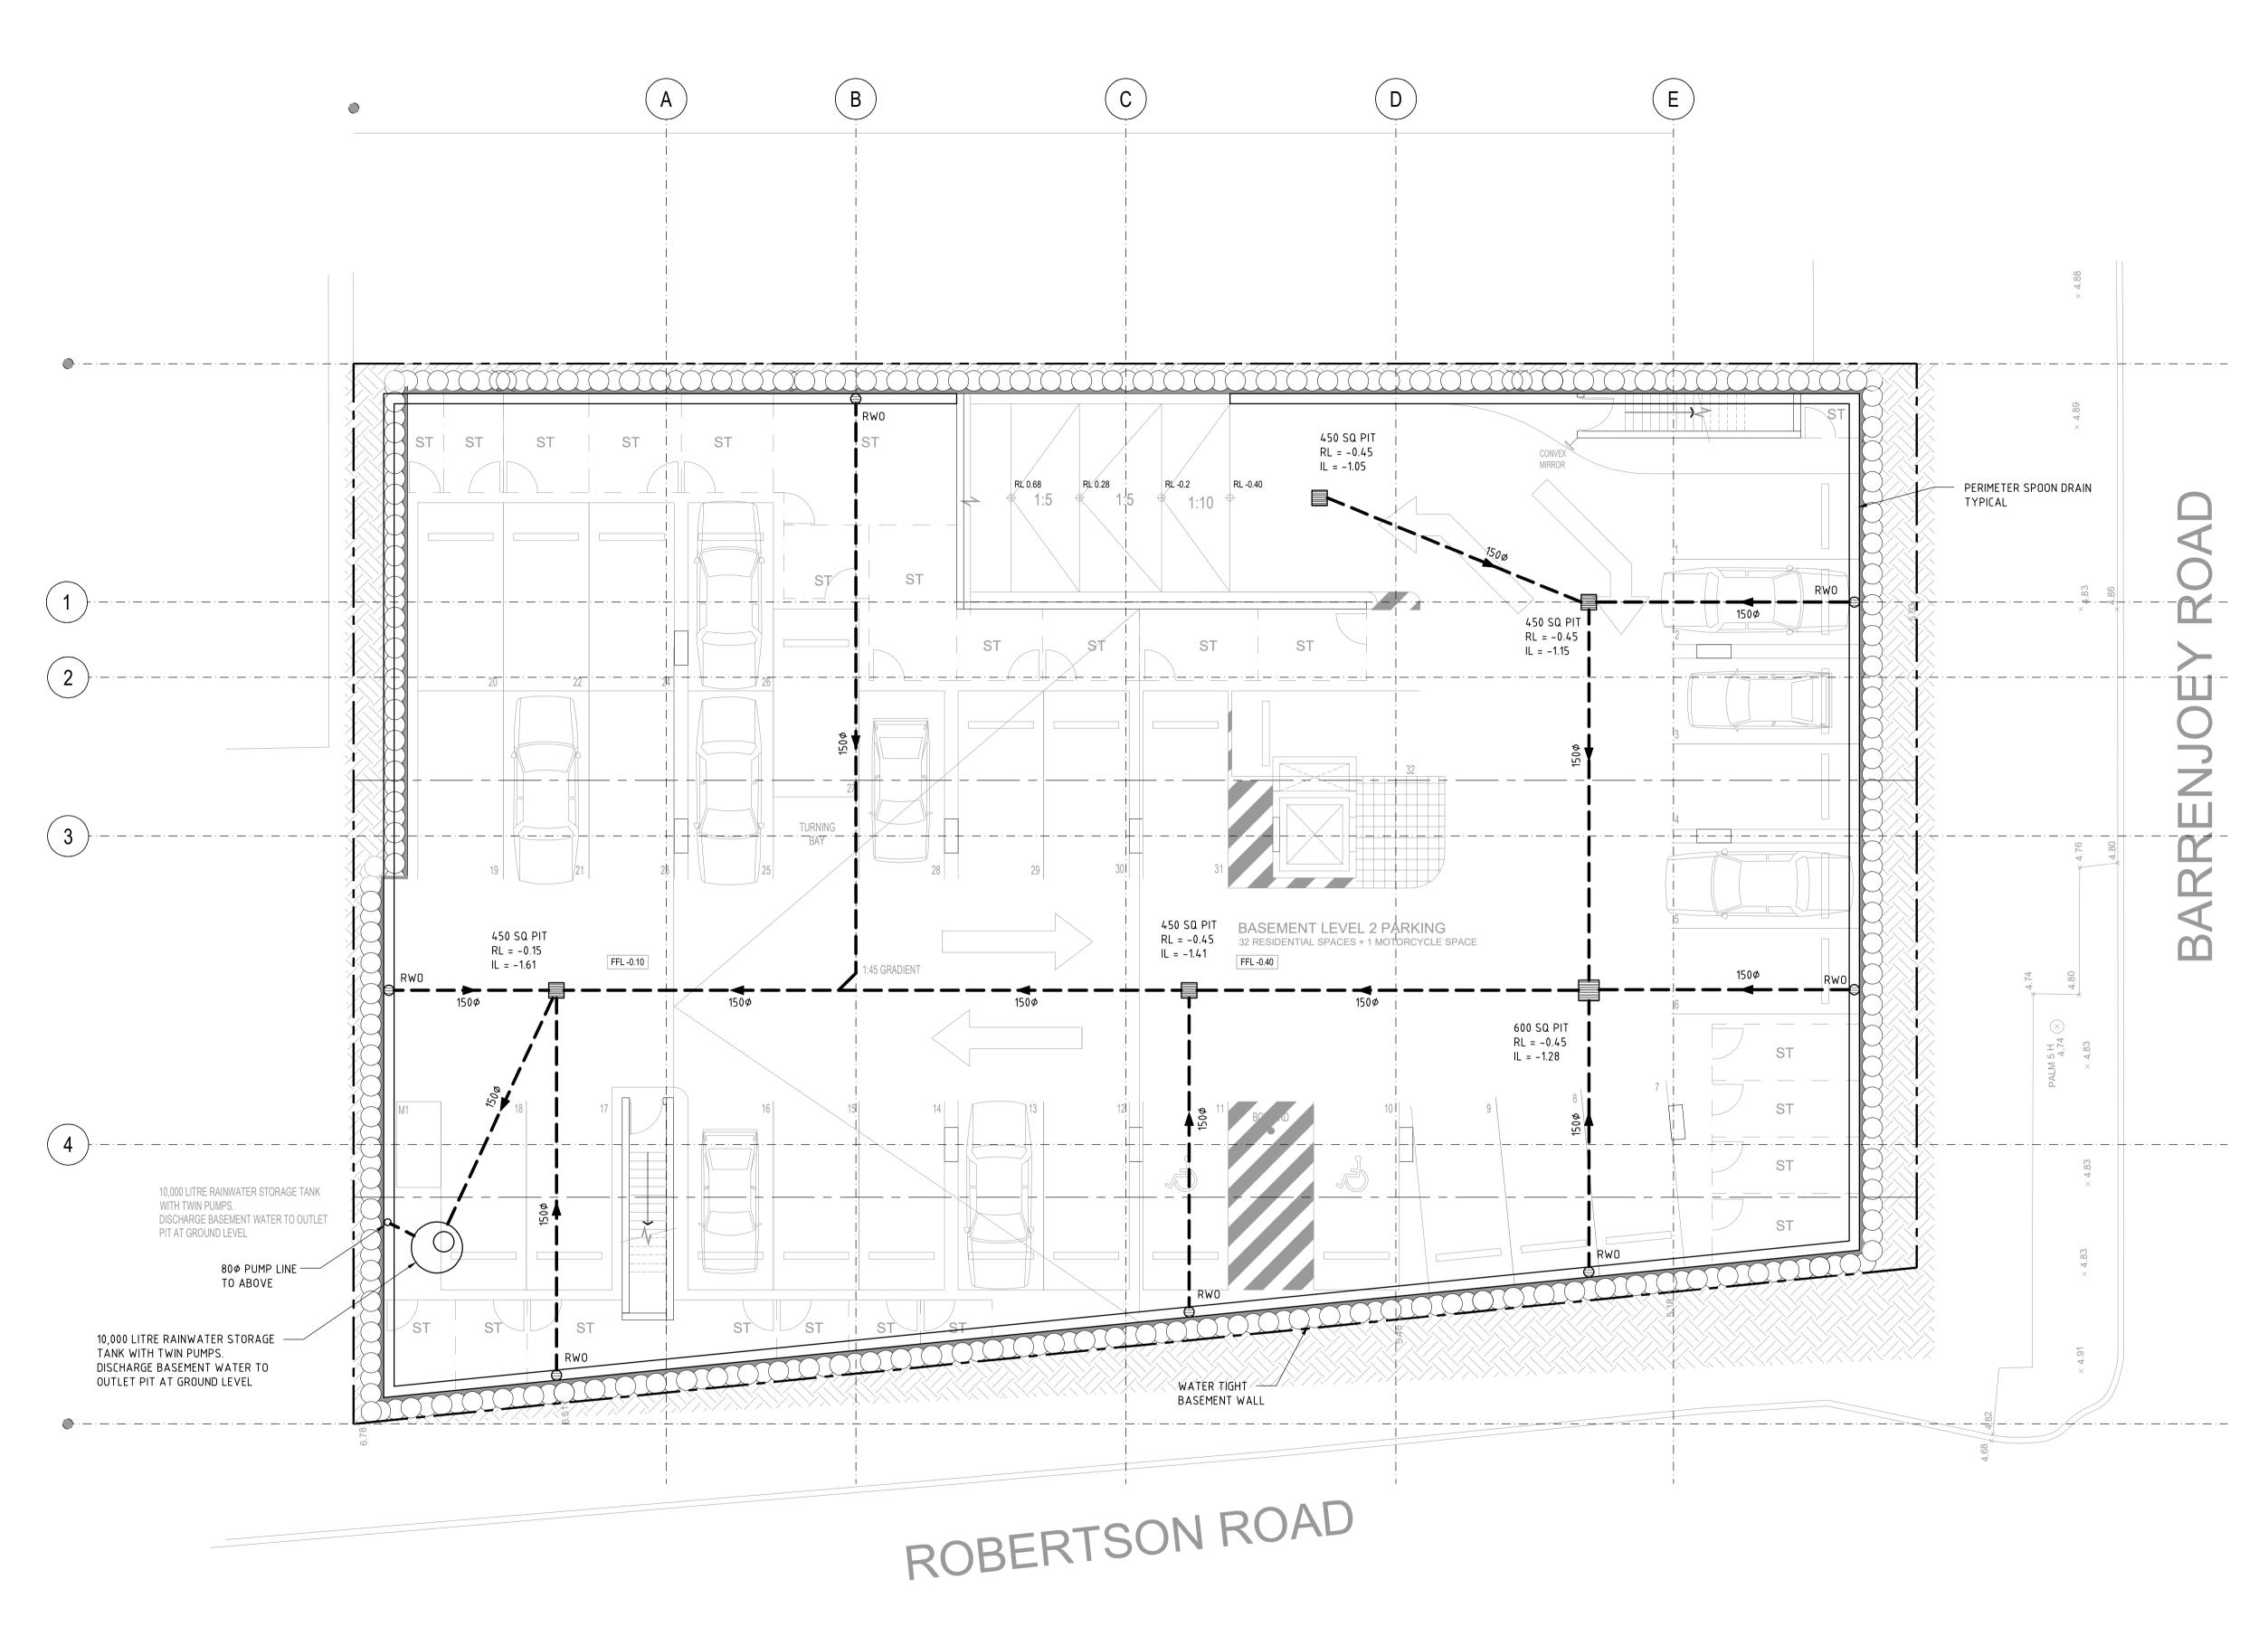ALL PIPES TO BE Ø100 UPVC @ 1% FALL, TYPICAL U.N.O.

SCALE 1:100

CLIENT:

→ → DENOTES STORMWATER PIPE

DENOTES SUBSOIL DRAIN

DENOTES PIPE DIAMETER IN MM

| \ _ | P5     | 11.12.20 | ARCH LAYOUT UPDATED       |
|-----|--------|----------|---------------------------|
|     | P4     | 20.04.20 | STORMWATER LAYOUT REVISED |
|     | P3     | 02.03.20 | ARCH LAYOUT UPDATED       |
|     | P2     | 30.09.19 | ARCH LAYOUT UPDATED       |
|     | REV.No | DATE     | REVISION                  |

This drawing MUST be read in conjunction with ALL other drawings for this project including but not limited to all construction notes.

DAW

RAL RAL RAL

| FOR DEVELOPMENT    |
|--------------------|
| <b>APPLICATION</b> |


| ECT: | CRAWFORD ARCHITECTS | PROJECT: | Proposed Development<br>351 Barrenjoey Road NEWPORT |
|------|---------------------|----------|---|
| :    | DEVELOPMENT LINK    | TITLE:   | BASEMENT LEVEL 2 DRAINAGE<br>CONCEPT PLAN           |

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219120

DRAWN: RAL
CHECKED: DW

DRAWING: SEP2020

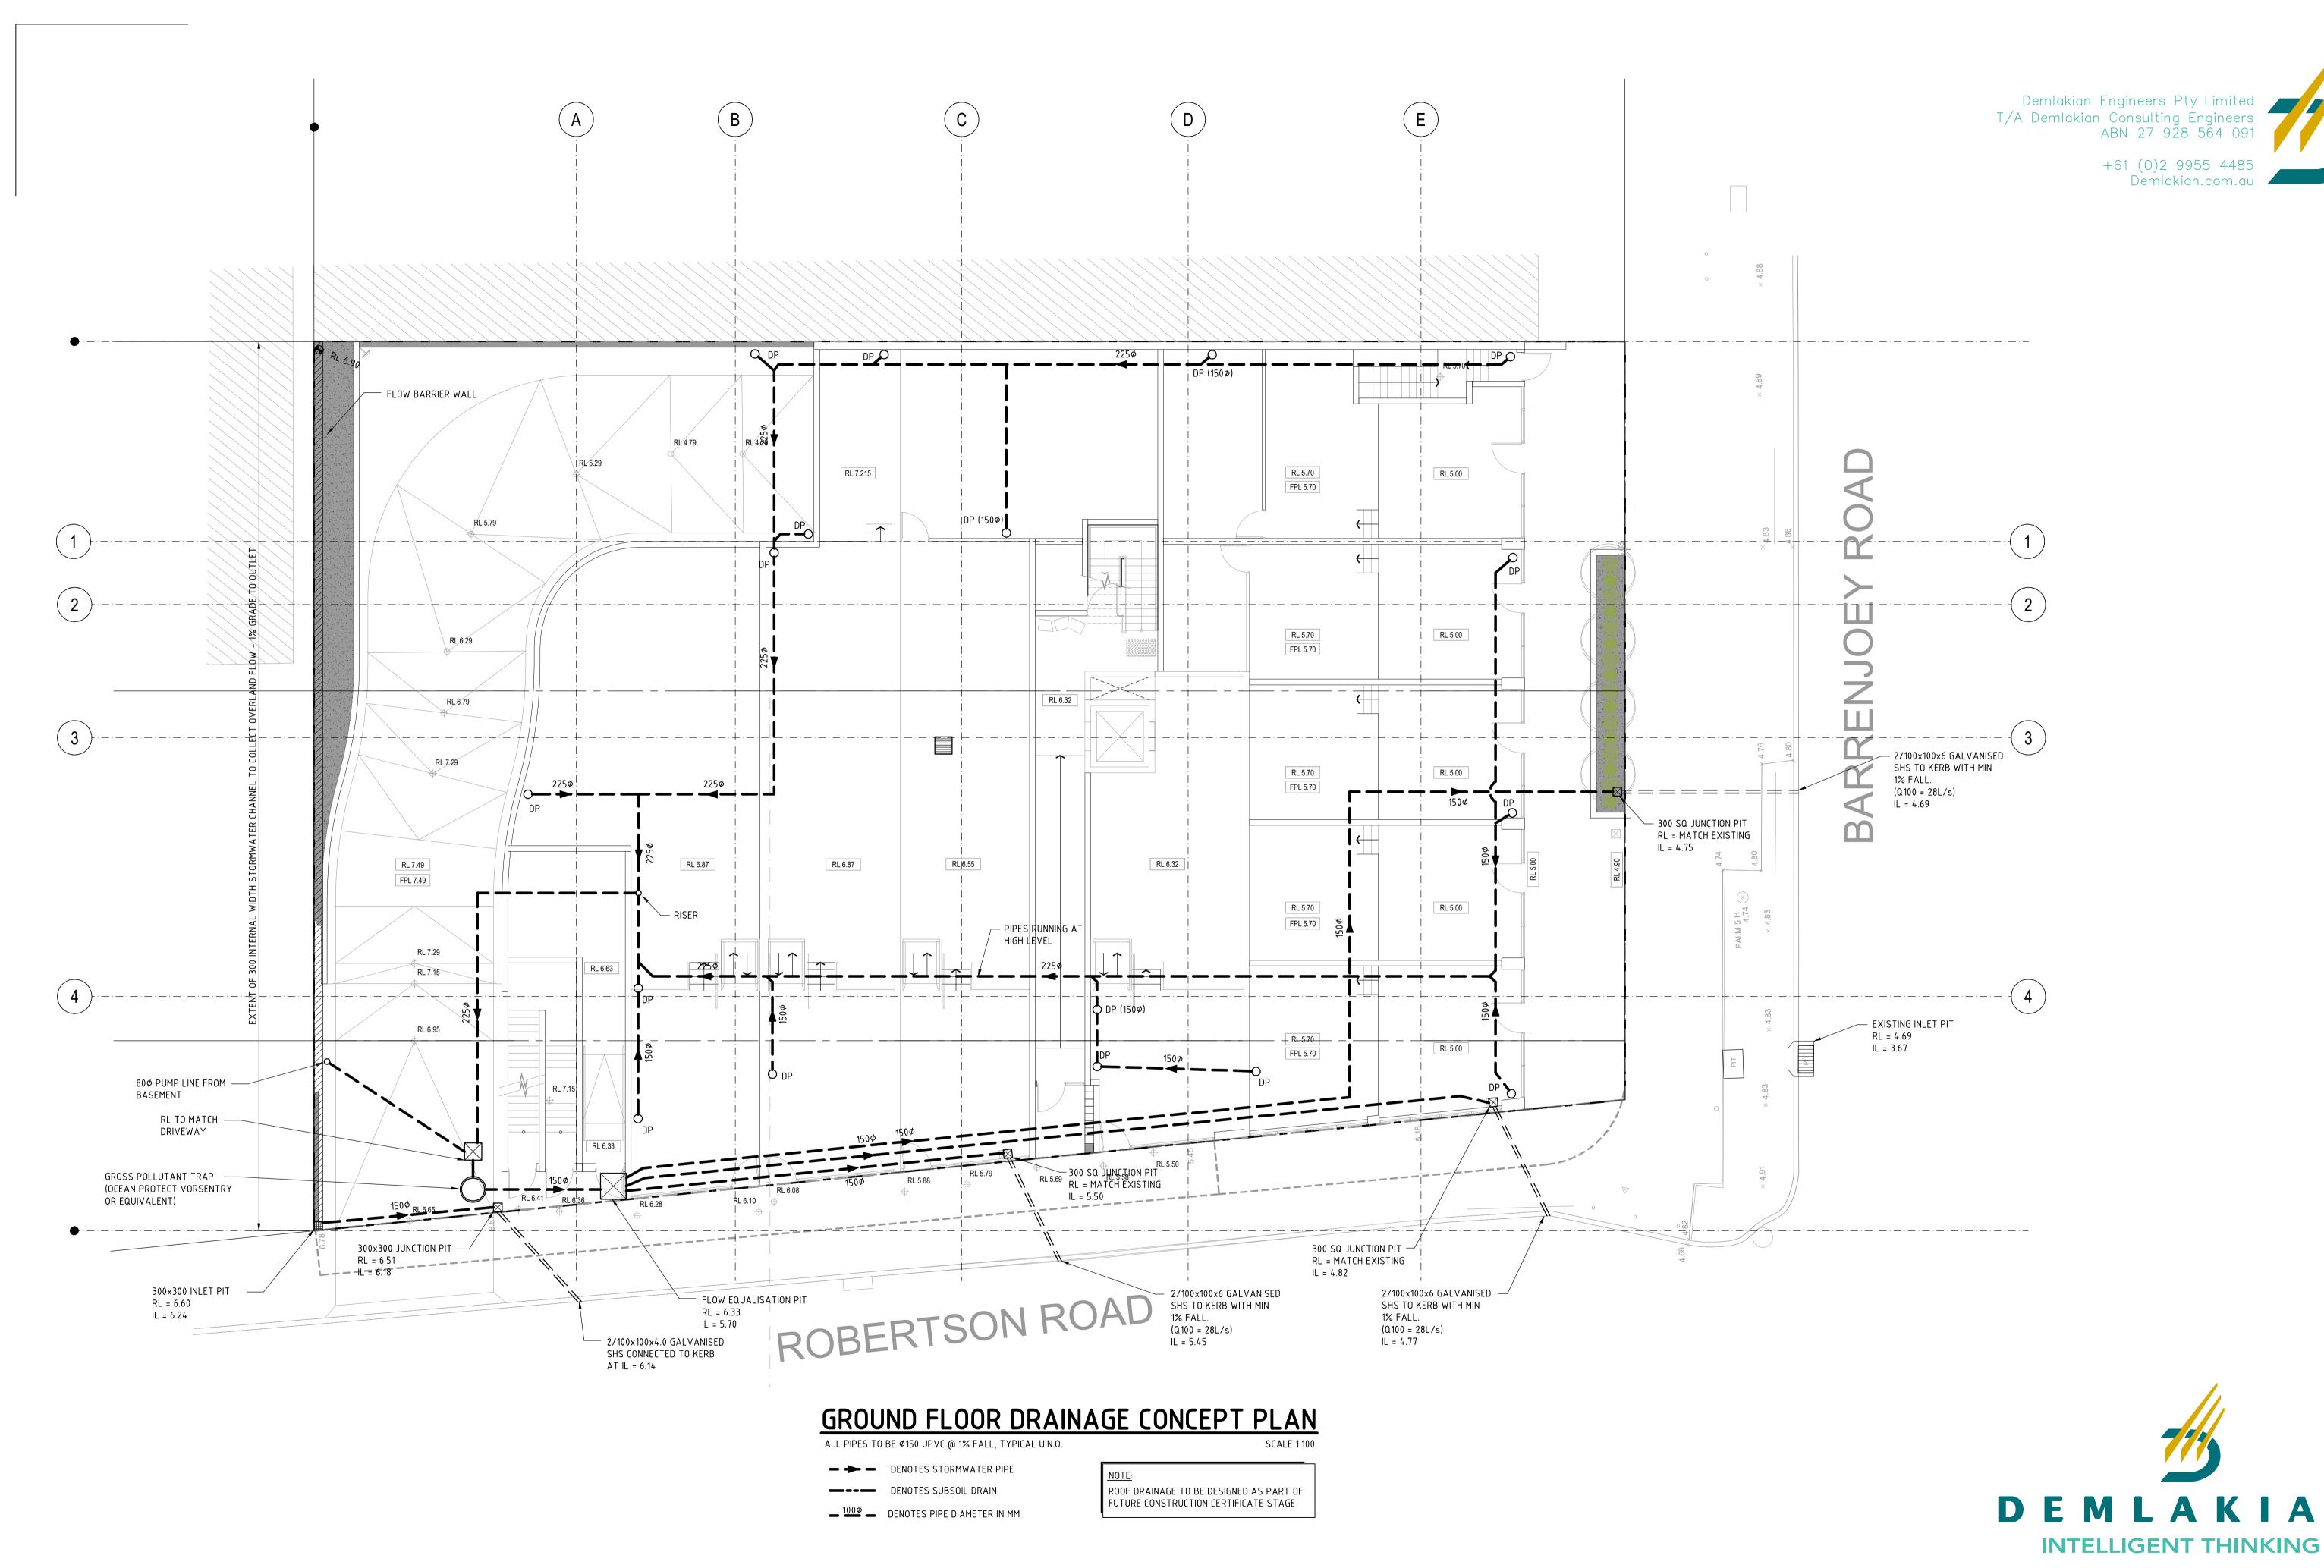

**FOR DEVELOPMENT** 

**APPLICATION** 

P6 11.12.20

P5 20.04.20

P4 06.03.20

P3 02.03.20

REV.No DATE

DAW

This drawing MUST be read in conjunction with

ALL other drawings for this project including

but not limited to all construction notes.

RAL RAL RAL BY


ARCH LAYOUT UPDATED


STORMWATER LAYOUT REVISED

LEVEL AMENDED

ARCH LAYOUT UPDATED

REVISION

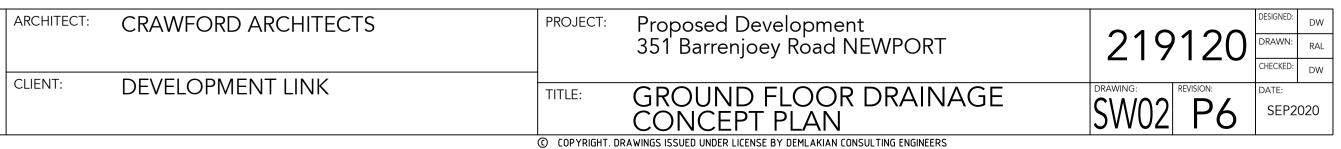


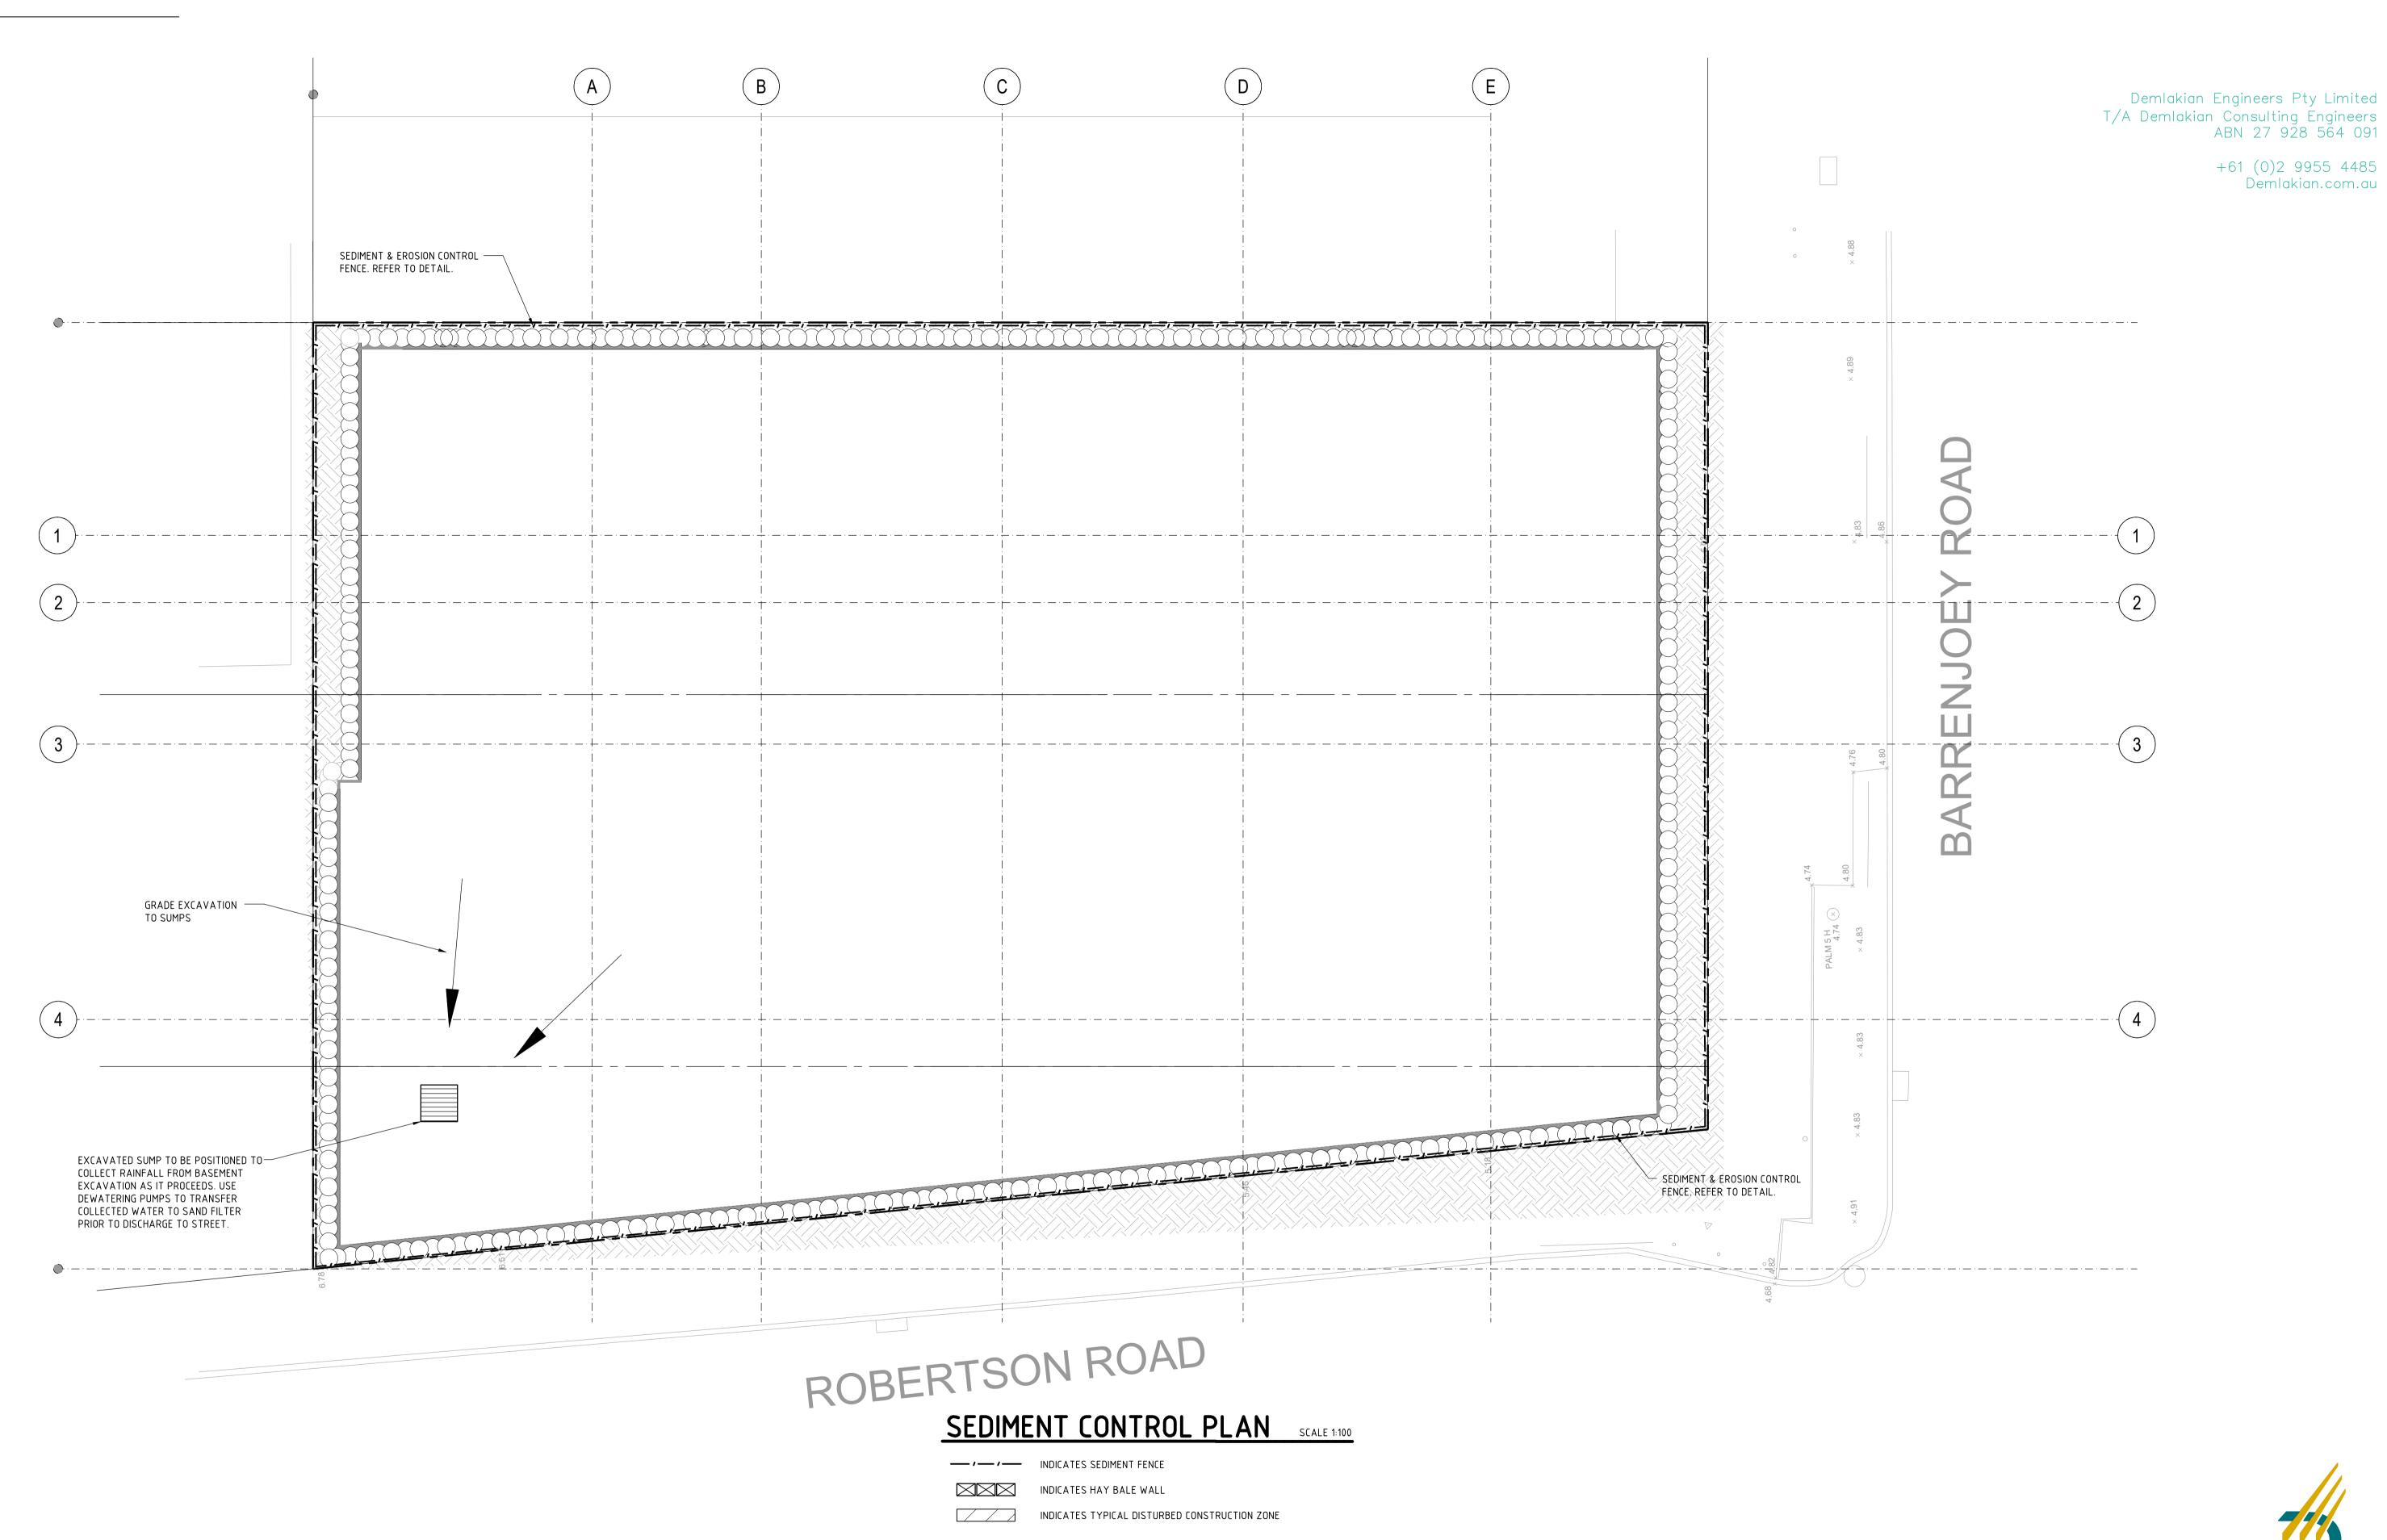



**INTELLIGENT THINKING** 

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This drawing MUST be read in conjunction with ALL other drawings for this project including but not limited to all construction notes.

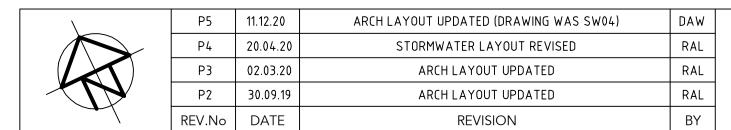FOR DEVELOPMENT **APPLICATION** 

**EROSION & SEDIMENT CONTROL NOTES** 

ALL EROSION & SEDIMENT CONTROL MEASURES SHALL BE MAINTAINED AS


DUST SHALL BE CONTROLLED BY REGULAR MOISTENING OF EXCAVATED

SHOWN ON THE DRAWINGS.

SERVICES AND STOCKPILES.

Proposed Development 351 Barrenjoey Road NEWPORT CRAWFORD ARCHITECTS DEVELOPMENT LINK CLIENT: SEDIMENT CONTROL PLAN

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# FLOW TO THE DESIGNATED OUTLET PIT.

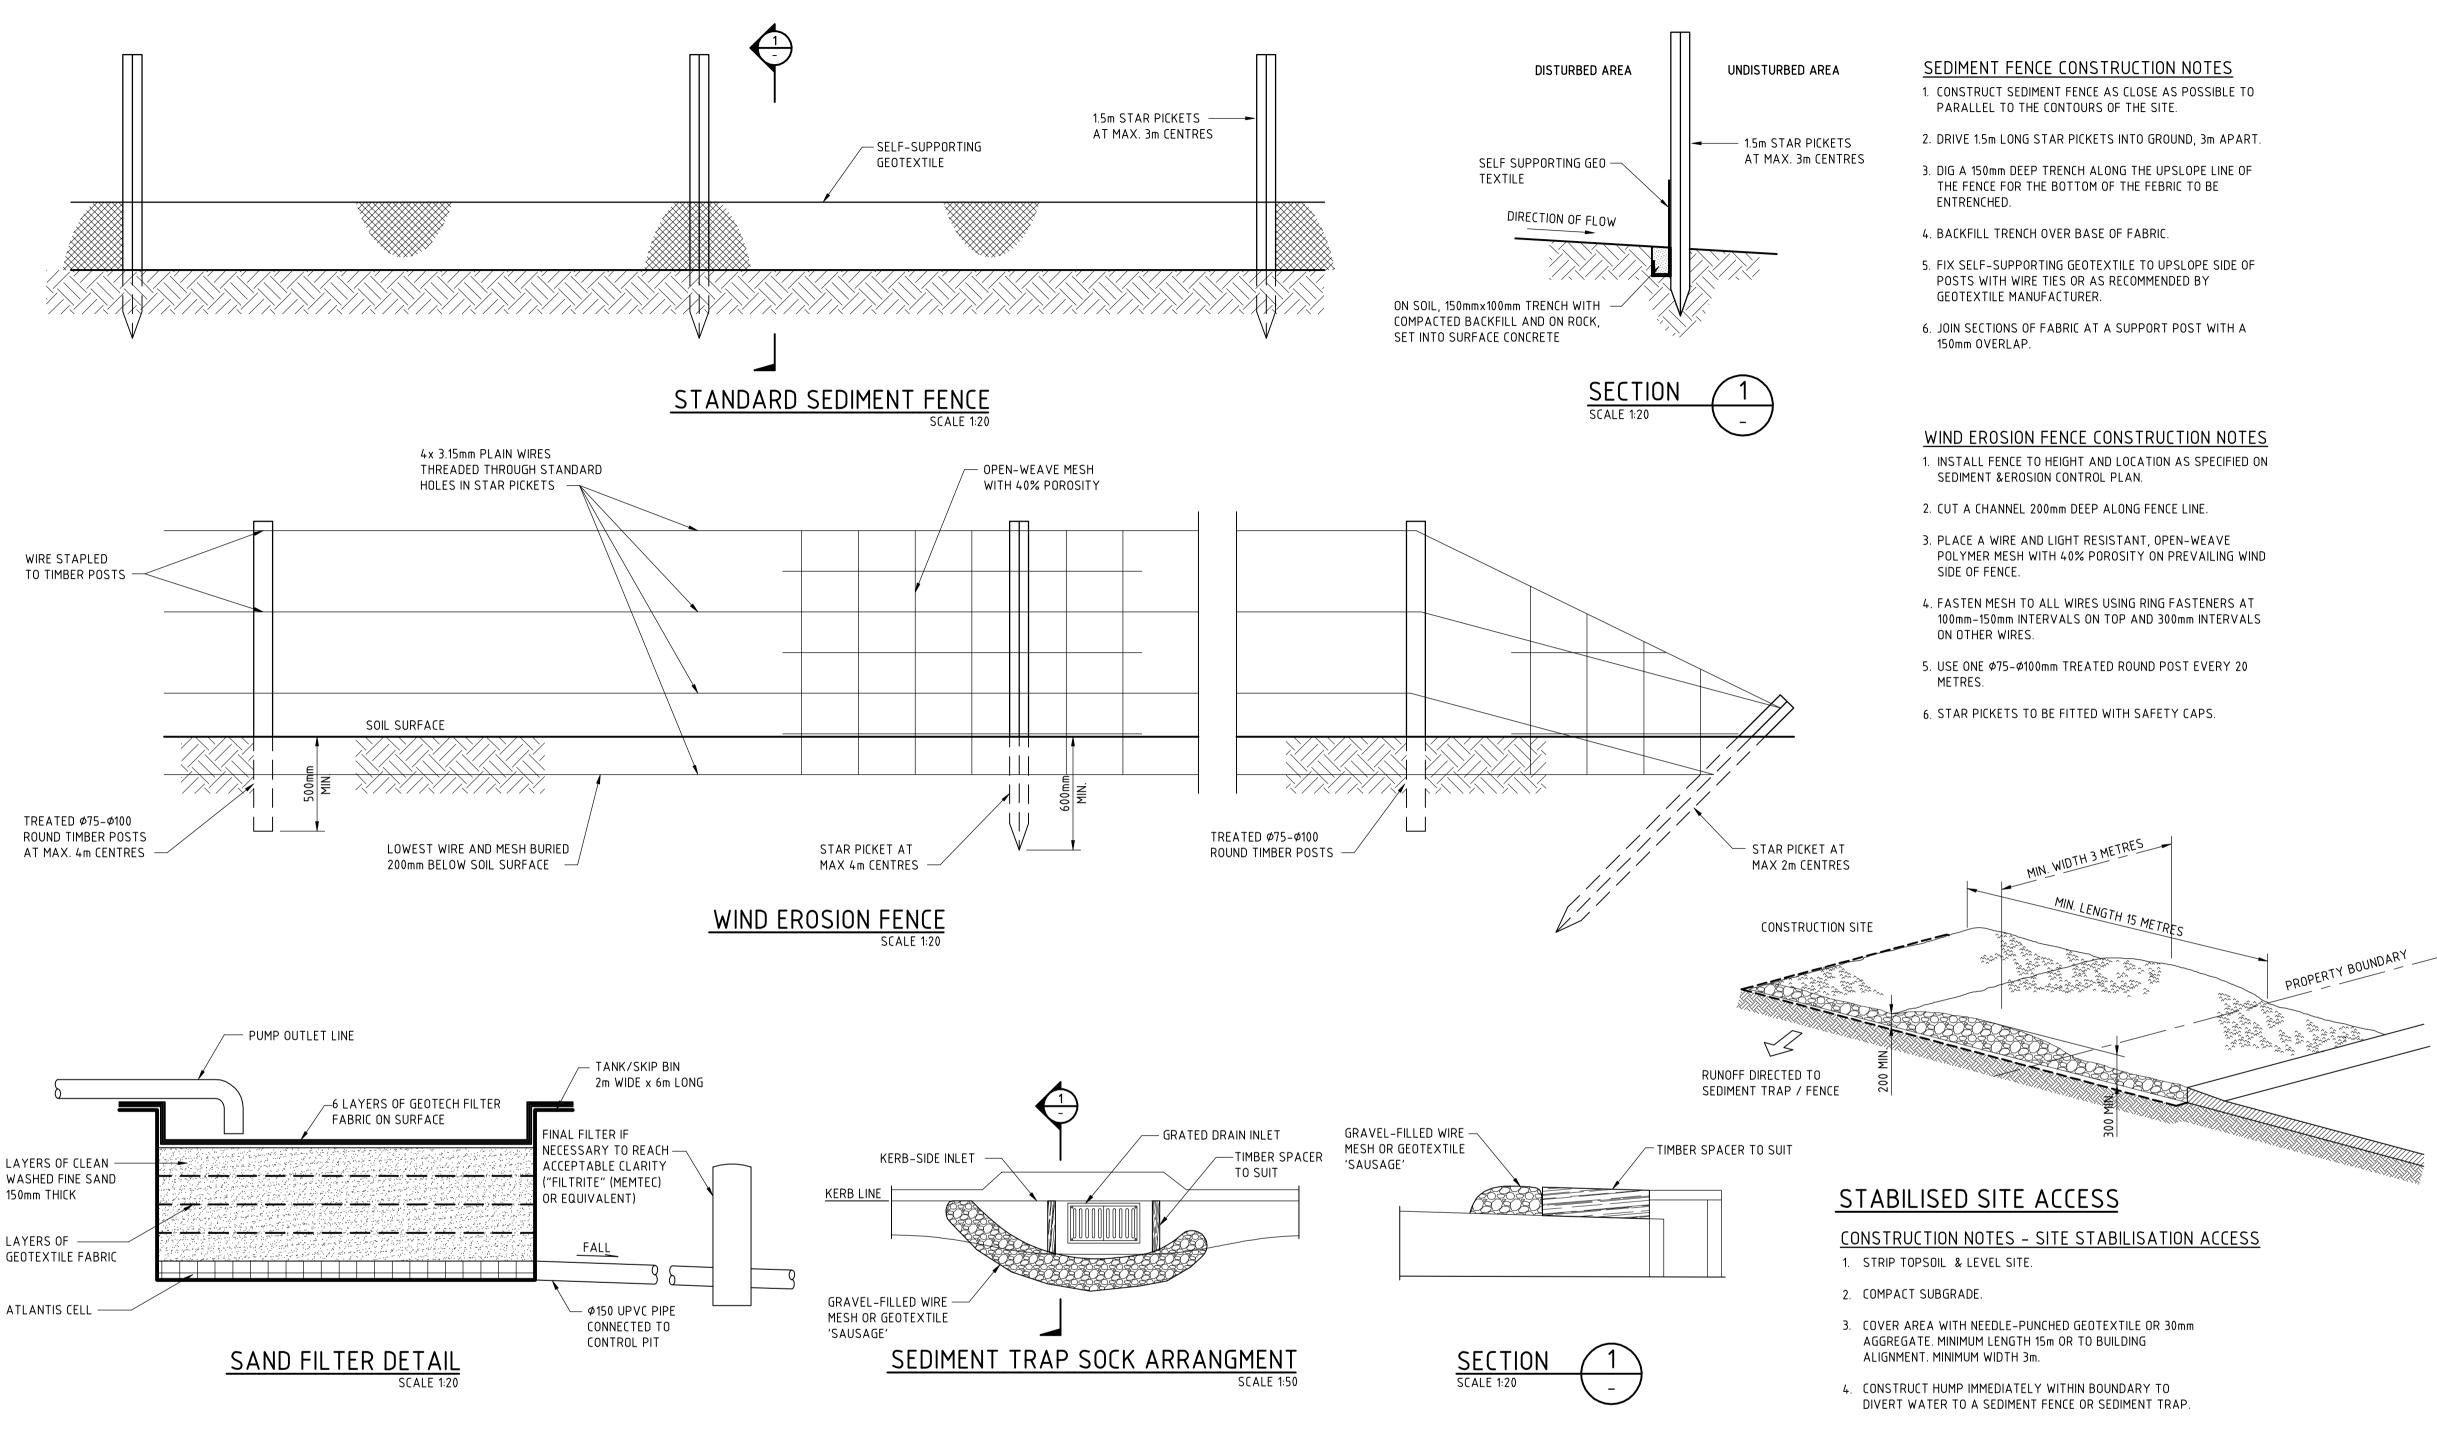3. CONSTRUCT EARTH BANKS AND CUT-OFF DRAINS TO DIRECT OVERLAND

4. CONSTRUCT EARTH BANKS & CUT-OFF DRAINS TO DIRECT OVERLAND

**EROSION & SEDIMENT CONTROL NOTES** 

. ALL EROSION & SEDIMENT CONTROL MEASURES SHALL BE MAINTAINED AS

3. THE TEMPORARY SEDIMENT TRAP PIT SHALL BE CLEANED REGULARLY. IN

DEWATERING OF THE EXCAVATION, PUMPING SHALL BE STOPPED AND THE

4. DUST SHALL BE CONTROLLED BY REGULAR MOISTENING OF EXCAVATED

THE EVENT THE GEOTEXTILE FILTER BECOMES CLOGGED DURING

SOIL & WATER MANAGEMENT PLAN NOTES

2. INSTALL ALL BARRIER FENCING TO EXCLUDE ACCESS TO THE

2. THE TRUCK SHAKER SHALL BE REGULARLY CLEANED BY LIFTING, DISLODGING &

SHOWN ON THE DRAWINGS.

FILTER CLEANED OR RENEWED.

SERVICES AND STOCKPILES.

A. CONSTRUCTION SEQUENCE

FLOW BEYOND THE SITE.

1. CONSTRUCT STABILISED SITE ACCESSES.

NOMINATED RESTRICTED AREAS.

REMOVING SPOIL.

- 5. STRIP AND STOCKPILE TOPSOIL FROM THOSE LANDS TO BE EXPOSED TO CONSTRUCTION ACTIVITIES.
- 6. UNDERTAKE WORKS ACCORDING TO THE ENGINEERING PLANS.

#### B. SITE INSPECTION MAINTENANCE CONDITIONS

- 1. WASTE BINS WILL BE EMPTIED AS NECESSARY. DISPOSAL OF WASTE WILL BE IN A MANNER APPROVED BY THE SITE SUPERINTENDENT.
- 2. THE SITE SUPERINTENDENT WILL INSPECT THE SITE AT LEAST WEEKLY AND WILL:
- a) ENSURE THAT DRAINS OPERATE PROPERLY AND TO EFFECT ANY NECESSARY REPAIRS;
- b) REMOVE SPILLED SAND OR OTHER MATERIALS FROM HAZARD AREAS, INCLUDING LANDS CLOSER THAN FIVE METRES FROM AREAS OF LIKELY CONCENTRATED OR HIGH VELOCITY FLOWS ESPECIALLY WATERWAYS AND PAVED AREAS;
- c) REMOVE TRAPPED SEDIMENT WHENEVER LESS THAN DESIGN CAPACITY REMAINS WITHIN THE STRUCTURE;
- d) ENSURE REHABILITATED LANDS HAVE EFFECTIVELY REDUCED THE EROSION HAZARD AND TO INITIATE UPGRADING OR REPAIR AS
- e) MAINTAIN EROSION AND SEDIMENT CONTROL MEASURES IN A FULLY FUNCTIONING CONDITION UNTIL ALL EARTHWORK ACTIVITIES ARE COMPLETED AND THE SITE IS REHABILITATED; AND
- f) REMOVE TEMPORARY SOIL CONSERVATION STRUCTURES AS THE LAST ACTIVITY IN THE REHABILITATION PROGRAM.
- 3. AS A PART OF THE STATUTORY "DILIGENCE AND CARE" RESPONSIBILITIES, THE SITE SUPERINTENDENT WILL KEEP A LOG BOOK, MAKING ENTRIES AT LEAST WEEKLY, IMMEDIATELY BEFORE FORECAST RAIN AND AFTER RAINFALL. ENTRIES WILL INCLUDE:
- a) THE VOLUME AND INTENSITY OF ANY RAINFALL EVENTS;
- b) THE CONDITION OF ANY SOIL AND WATER MANAGEMENT WORKS;
- c) THE CONDITION OF VEGETATION AND ANY NEED TO IRRIGATE;
- d) THE NEED FOR DUST PREVENTION STRATEGIES; AND
- e) ANY REMEDIAL WORKS TO BE UNDERTAKEN.

THE BOOK WILL BE KEPT ON-SITE AND MADE AVAILABLE TO ANY AUTHORISED PERSON ON REQUEST. IT WILL BE GIVEN TO THE PROJECT MANAGER AT THE CONCLUSION OF WORKS.

| 100 x 100 x 6 ANGLES,<br>TYPICAL   |                               |  |  |  |
|--|-------------------------------|--|--|--|
|  |                               |  |  |  |
| <br>   |                               |  |  |  |
| NOTE:<br>EQUIVALENT PROPRIETARY SYSTEMS MAY BE<br>USED AS AN ALTERNATIVE | 150 x 75 x 6 RHS AT 2000 CTS. |  |  |  |

TYPICAL TRUCK SHAKER

FOR DEVELOPMENT **APPLICATION** 

CRAWFORD ARCHITECTS CLIENT: DEVELOPMENT LINK

Proposed Development 351 Barrenjoey Road NEWPORT

SW04 P2

DEMLAKIAN

**INTELLIGENT THINKING** 

|        |          |  |     | This drawing MUST be read in conjunction with |
|--------|----------|--|-----|---|
| P2     | 11.12.20 | ARCH LAYOUT UPDATED (DRAWING WAS SW05) | DAW | ALL other drawings for this project including |
| P1     | 17.09.19 | ISSUED FOR DEVELOPMENT APPLICATION     | RAL | but not limited to all construction notes.    |
| REV.No | DATE     | REVISION                               | BY  |   |