23 WOLLOMBI ROAD, BILGOLA PLATEAU


JEAN-FRANCOIS & MARIA DYONIZIAK

PROPOSED ALRTERATIONS & ADDITIONS TO EXISTING RESIDENTIAL DWELLING.

23 WOLLOMBI ROAD, BILGOLA PLATEAU, NSW.

DA DOCUMENTATION SCHEDULE

DWG NO.	TITLE	SCALE	REV.	DATE:	DESCRIPTION:
. DA 000	Cover Page & Drawing Schedule	NTS	-	25.02.2019	DA SUBMISSION
DA 001	Site Plan	1:100 @ A1 / 1:200 @ A3	-	25.02.2019	DA SUBMISSION
DA 100	Lower Ground General Arrangement Floor Plan	1:50 @ A1 / 1:100 @ A3	-	25.02.2019	DA SUBMISSION
DA 101	Ground Floor General Arrangement Floor Plan	1:50 @ A1 / 1:100 @ A3	-	25.02.2019	DA SUBMISSION
. DA_102	First Floor General Arrangement Floor Plan	1:50 @ A1 / 1:100 @ A3	-	25.02.2019	DA SUBMISSION
· DA_300	Elevations Sheet 01	1:50 @ A1 / 1:100 @ A3	-	25.02.2019	DA SUBMISSION
DA_301	Elevations Sheet 02	1:50 @ A1 / 1:100 @ A3	-	25.02.2019	DA SUBMISSION
DA_302	Elevations Sheet 03	1:50 @ A1 / 1:100 @ A3	-	25.02.2019	DA SUBMISSION
DA_400	Section Sheet 01	1:50 @ A1 / 1:100 @ A3	-	25.02.2019	DA SUBMISSION
DA_401	Section Sheet 02	1:50 @ A1 / 1:100 @ A3	-	25.02.2019	DA SUBMISSION
DA_500	Landscape Concept Plan	1:100 @ A1 / 1:200 @ A3	-	25.02.2019	DA SUBMISSION
DA_501	Site Analysis Plan	1:100 @ A1 / 1:200 @ A3	-	25.02.2019	DA SUBMISSION
DA_502	Waste Management, Erosion & Sediment				
. –	Control Plan	1:100 @ A1 / 1:200 @ A3	-	25.02.2019	DA SUBMISSION
DA_900	Shadow Diagram 9am	1:100 @ A1 / 1:200 @ A3	-	25.02.2019	DA SUBMISSION
DA_901	Shadow Diagram 12pm	1:100 @ A1 / 1:200 @ A3	-	25.02.2019	DA SUBMISSION
DA_902	Shadow Diagram 3pm	1:100 @ A1 / 1:200 @ A3	-	25.02.2019	DA SUBMISSION

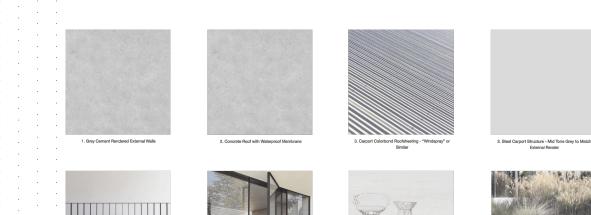

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EXTERNAL FINISHES IS & ADDITIONS TO EXISTIN DING ASSOCIATED LANDSO IMBI BOAD BIGOLA PLATE

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23 WOLLOMBI 23 WOLLOMBI ROAD BILGOLA PLATEAU 2107 NORTHERN BEACHES COUNCIL DEPOSITED PLAN 27540 LOT NUMBER 1 SECTION NUMBER 0 SEPARATE DWELLING HOUSE ALTERATION AND ADDITION MY RENOVATION WORK IS VALUED AT \$50,000 OR MORE, AND DOES NOT INCLUDE A POOL (AND/OR SPA). NAME / COMPANY NAME: DANIEL RAYMOND ARCHITECT ABN (IF APPLICABLE): 612713425 FIXTURES AND SYSTEMS

SCHEDULE OF BASIX COMMITTMENTS

TAT URES AND STSTEMS HOT WATER THE APPLICANT MUST INSTALL THE FOLLOWING HOT WATER SYSTEM IN THE DEVELOPMENT: GAS INSTANTANEOUS.

LIGHTING THE APPLICANT MUST ENSURE A MINIMUM OF 40% OF NEW OR ALTERED LIGHT FIXTURES ARE FITTED WITH FLUORESCENT, COMPACT FLUORESCENT, OR LIGHT-EMITTING-DIODE (LED) LAMPS.

LIGHT-EMITTING-DIODE (LED) LAMPS. <u>FIXTURES</u> THE APPLICANT MUST ENSURE NEW OR ALTERED SHOWERHEADS HAVE A FLOW RATE NO GREATER THAN 9 LITRES PER MINUTE OR A 3 STAR WATER RATING. THE APPLICANT MUST ENSURE NEW OR ALTERED TOILETS HAVE A FLOW RATE NO GREATER THAN 4 LITRES PER AVERAGE FLUSH OR A MINIMUM 3 STAR WATER RATING. THE APPLICANT MUST ENSURE NEW OR ALTERED TARS HAVE A FLOW RATE NO

RATING. THE APPLICANT MUST ENSURE NEW OR ALTERED TAPS HAVE A FLOW RATE NO GREATER THAN 9 LITRES PER MINUTE OR MINIMUM 3 STAR WATER RATING.

CONSTRUCTION INSULATION REQUIREMENTS CONCRETE SLAB ON GROUND FLOOR. NIL FLOOR ABOVE EXISTING OWELLING OR BUILDING. NIL EXTERNAL WALL: CAVITY BRICK NIL FLAT CELLING, FLAT ROOF: CONCRETE/PLASTERBOARD INTERNAL

INTERNAL CEILING: R2.50 (UP), ROOF: NONE LIGHT (SOLAR ABSORPTANCE < 0.475)

GLAZING REQUIRMENTS WINDOWS AND GLAZED DOOR

WINDOW/DOOR NO. WINDOW/JOOR NO. ORIENTATION AREA OF GLASS INC. FRAME (M2) OVERSHADOWING HEIGHT (M2) OVERSHADOWING DISTANCE (M2) SHADING DEVICE FRAME AND GLASS TYPE

W01

1.25 5 4.5 EXTERNAL LOUVRE/BLIND (ADJUSTABLE) STANDARD ALUMINIUM, SINGLE CLEAR, (OR U-VALUE: 7.63, SHGC: 0.75)

W02

1.7

EAVE/VERANDAH/PERGOLA/BALCONY >=900 MM STANDARD ALUMINIUM, SINGLE CLEAR, (OR U-VALUE: 7.63, SHGC: 0.75)

<u>W03</u> N 1.85 2.5

5 EXTERNAL LOUVRE/BLIND (ADJUSTABLE) STANDARD ALUMINIUM, SINGLE CLEAR, (OR U-VALUE: 7.63, SHGC: 0.75) W04 S 0.85 4.4 2.5 NONE STANDARD ALUMINIUM, SINGLE CLEAR, (OR U-VALUE: 7.63, SHGC: 0.75) W05 SW

0.66

NONE STANDARD ALUMINIUM, SINGLE CLEAR, (OR U-VALUE: 7.63, SHGC: 0.75)


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/ <u>06</u> W		IMPROVED ALUMINIUM, SINGLE PYROLYTIC LOW-E, (U-VALUE: 4.48, SHGC: 0.46)	
3 6		D11 S	· · · ·
5	GLE CLEAR, (ORU-VALUE: 7.63, SHGC: 0.75)	3.1 0	
/ <u>07</u>		0 EAVE/VERANDAH/PERGOLA/BALCONY>=900 MM	
66		STANDARD ALUMINIUM, SINGLE CLEAR, (OR U-VALUE: 7.63, SHGC: 0.75)	
XTERNAL LOUVRE/BLIND (ADJUS	TABLE) STANDARD ALUMINIUM, SINGLE CLEAR,	<u>D12</u> W	· · · ·
DR U-VALUE: 7.63, SHGC: 0.75) /08		3.1 0	
66		0 EAVE/VERANDAH/PERGOLA/BALCONY>=900 MM	
		STANDARD ALUMINIUM, SINGLE CLEAR, (OR U-VALUE: 7.63, SHGC: 0.75)	
(TERNAL LOUVRE/BLIND (ADJUS R U-VALUE: 7.63, SHGC: 0.75)	TABLE) STANDARD ALUMINIUM, SINGLE CLEAR,	D13,D14 W	
<u>)1</u>		6.2 0	
64		0 EXTERNAL LOUVRE/BLIND (ADJUSTABLE) STANDARD ALUMINIU	M, SINGLE CLEAR,
		(OR U-VALUE: 7.63, SHGC: 0.75) <u>D15,16</u>	· · · ·
VALUE: 7.63, SHGC: 0.75)	STANDARD ALUMINIUM, SINGLE CLEAR, (OR	W 6.2	
2		0 0	· · · ·
3		EXTERNAL LOUVRE/BLIND (ADJUSTABLE) STANDARD ALUMINIU (OR U-VALUE: 7.63, SHGC: 0.75)	M, SINGLE CLEAR,
VE/VERANDAH/PERGOLA/BALCO		<u>D17</u> E	· · · ·
ANDARD ALUMINIUM, SINGLE CI VALUE: 7.63, SHGC: 0.75)	LEAR, (OR	5.88 0	
<u>13</u>		0 EAVE/VERANDAH/PERGOLA/BALCONY >=900 MM	
1		STANDARD ALUMINIUM, SINGLE CLEAR, (OR U-VALUE: 7.63, SHGC: 0.75)	
VE/VERANDAH/PERGOLA/BALCO		<u>D18</u> NE	
ANDARD ALUMINIUM, SINGLE CI VALUE: 7.63, SHGC: 0.75)	LEAR, (OR	7.35 0	
<u>14</u>		0 EAVE/VERANDAH/PERGOLA/BALCONY>=900 MM	
1		STANDARD ALUMINIUM, SINGLE CLEAR, (OR U-VALUE: 7.63, SHGC: 0.75)	
VE/VERANDAH/PERGOLA/BALCO	DNY >=900 MM	<u>D19</u> E	
ANDARD ALUMINIUM, SINGLE CI VALUE: 7.63, SHGC: 0.75)	LEAR, (OR	9.4 0	· · · · ·
05		0 EAVE/VERANDAH/PERGOLA/BALCONY>=900 MM	
4		STANDARD ALUMINIUM, SINGLE CLEAR, (OR U-VALUE: 7.63, SHGC: 0.75)	
ERGOLA (ADJUSTABLE SHADE) >	=900	<u>D20</u> N	
M STANDARD ALUMINIUM, SINGL VALUE: 7.63, SHGC: 0.75)	E CLEAR, (OR	4.4 2.6	
<u>06</u>		2.3 AWNING (ADJUSTABLE) >=900 MM STANDARD ALUMINIUM, SING	JLE CLEAR, (OR
9		U-VALUE: 7.63, SHGC: 0.75) D21	
4 DNE		N 3.5	· · · ·
ANDARD ALUMINIUM, SINGLE CI VALUE: 7.63, SHGC: 0.75)	LEAR, (OR	2.6 1.7	
<u>07</u>		AWNING (ADJUSTABLE) >=900 MM STANDARD ALUMINIUM, SING U-VALUE: 7.63, SHGC: 0.75)	JLE CLEAR, (OR
4 3		SKYLIGHTS	· · · · ·
5 DNE		<u>S1</u> 1.77	
ANDARD ALUMINIUM, SINGLE CI VALUE: 7.63, SHGC: 0.75)	LEAR, (OR	EXTERNAL ADJUSTABLE AWNING OR BLIND ALUMINIUM, MOULE CLEAR, (OR U-VALUE:	DED PLASTIC SINGLE
9		6.21, SHGC: 0.808)	
.4			
VE/VERANDAH/PERGOLA/BALCO	DNY>=600 MM		· · · · ·
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DJECT: NS & ADDITIONS	PROJECT STAGE:	DATE OF ISSUE:	
NG DWELLING	DA	25.02.2019	
		[DANIEL RAYMOND ARCHITECT B. ARCHITECTURE USYD NSW REG. #0788
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		[e. info@danielraymond.co
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PLATEAU, NSW.	1		IN ANY FORM WITHOUT CONSENT. DO NOT SCALE EPON THIS DRAWING

8. Native Garden:

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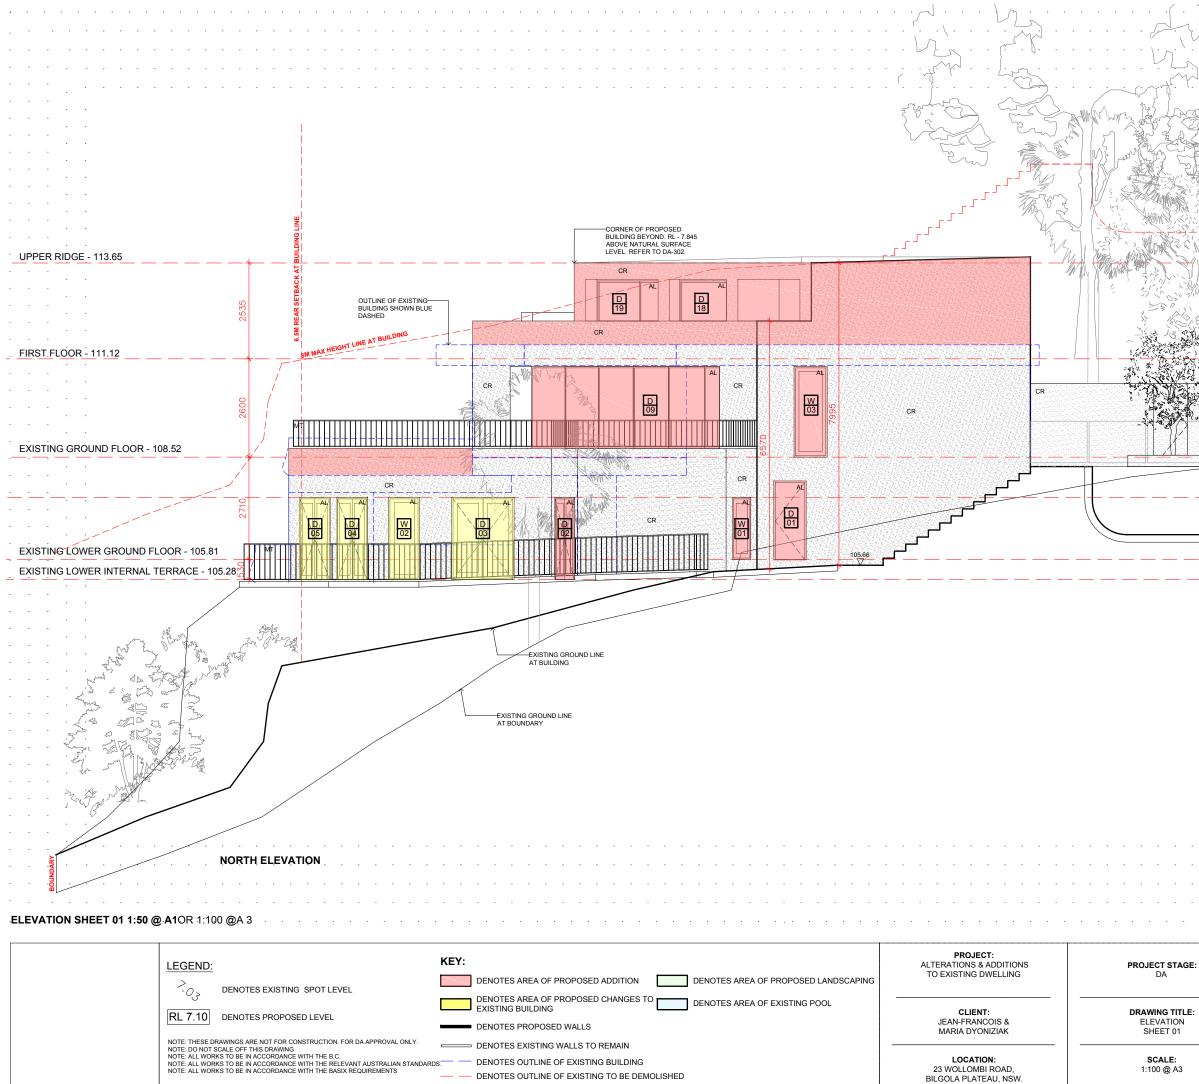
7. Concrete Topping Pool Copin Proposed Teerace Areas

NORTH	LEGEND:	KEY: DENOTES AREA OF PROPOSED ADDITION DENOTES AREA OF PROPOSED LANDSCAPING	PROJECT: ALTERATIONS & ADDITIONS TO EXISTING DWELLING	PROJECT ST DA
	RL 7.10 DENOTES PROPOSED LEVEL	DENOTES AREA OF PROPOSED CHANGES TO DENOTES AREA OF EXISTING POOL EXISTING BUILDING DENOTES PROPOSED WALLS	CLIENT: JEAN-FRANCOIS & MARIA DYONIZIAK	DRAWING T COVER PAGE & DR/
	NOTE: I HESE DRAWINGS ARE NOT FOR CONSTRUCTION. FOR DA APPROVAL ONLY. NOTE: DO NOT SCALE OFF THIS DRAWING NOTE: ALL WORKS TO BE IN ACCORDANCE WITH THE B.C. NOTE: ALL WORKS TO BE IN ACCORDANCE WITH THE RELEVANT AUSTRALIAN STANDAF NOTE: ALL WORKS TO BE IN ACCORDANCE WITH THE BASIX REQUIREMENTS	DENOTES EXISTING WALLS TO REMAIN DENOTES OUTLINE OF EXISTING BUILDING DENOTES OUTLINE OF EXISTING TO BE DEMOLISHED	LOCATION: 23 WOLLOMBI ROAD, BILGOLA PLATEAU, NSW.	SCALE: 1:100 @ A

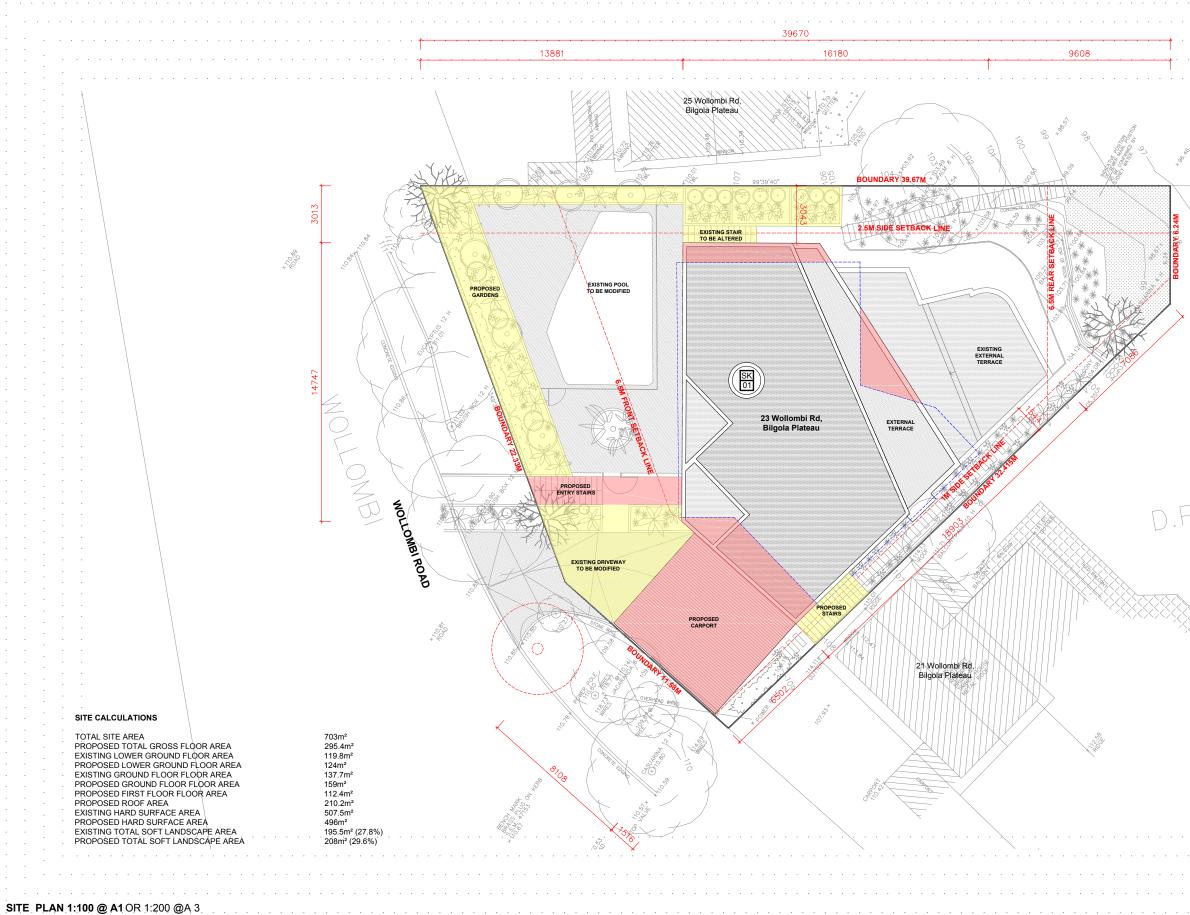

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	RL 7.10 DENOTES PROPOSED LEVEL	DENOTES AREA OF PROPOSED CHANGES TO DENOTES AREA OF EXISTING POOL EXISTING BUILDING DENOTES PROPOSED WALLS	CLIENT: JEAN-FRANCOIS & MARIA DYONIZIAK	DRAWING TITLE SITE PLAN
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	 	SCHEDULE OF FIN AL - ALUMINIUM	IISHES:	
		MT - METAL BWK - BRICKWORK CR - CEMENT RENDER DP - DOWN PIPE RC - REINFORCED CONG WB - WEATHER BOARD W - WINDOW D - DOOR		
· · · · ·	 · · · ·	FC - FIBROUS CEMENT T - TIMBER SS - SANDSTONE .		· · · ·

DATE OF ISSUE: 25.02.2019


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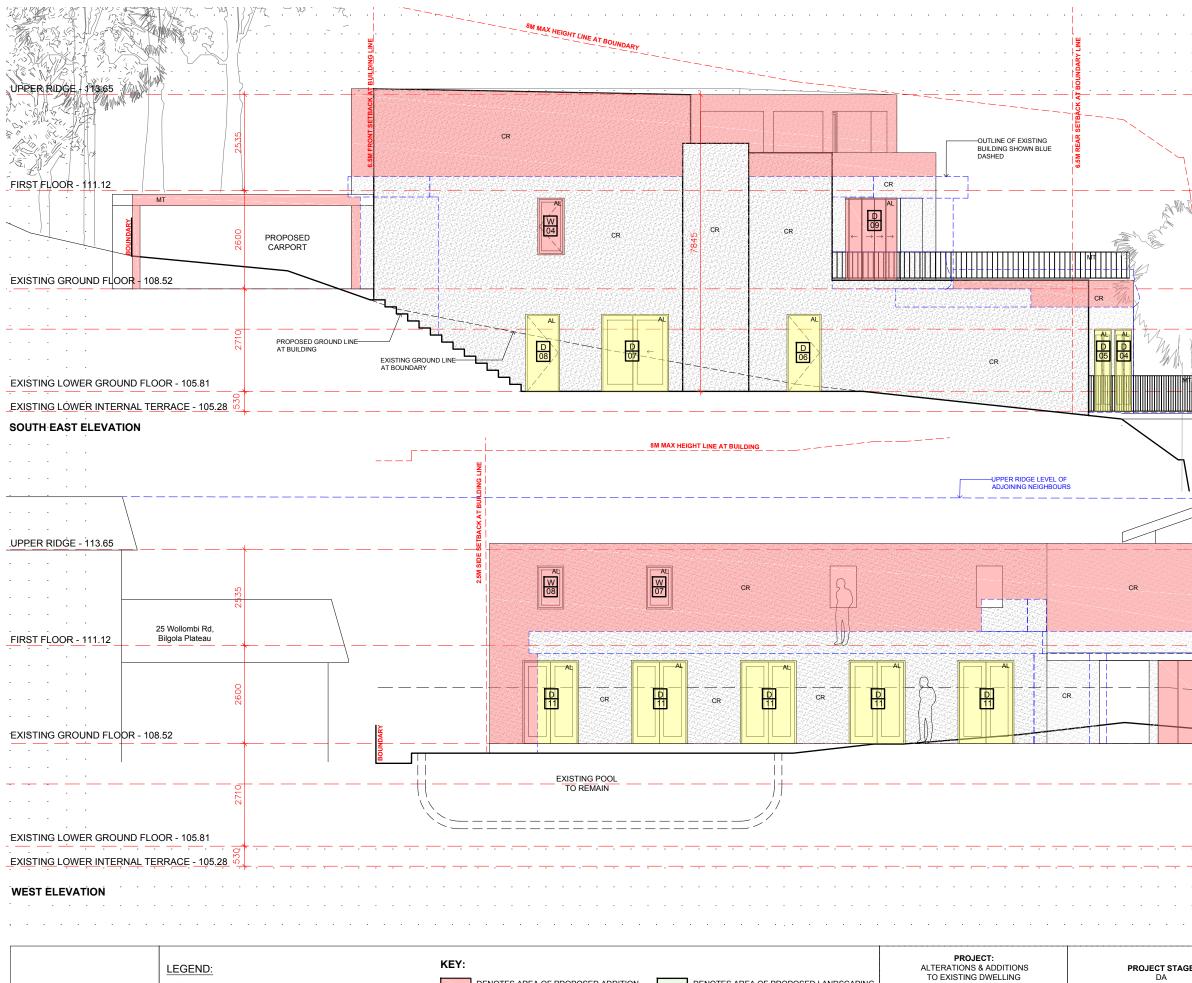
1 / 6 WARATAH ST, MONA VALE. NSW. 2103 www.danielraymond.co e. info@danielraymond.cr

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		MT - METAL	•	•			
		BWK - BRICKWORK	•	•			
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RL 7.10 DENOTES PROPOSED LEVEL	DENOTES AREA OF PROPOSED CHANGES TO DENOTES AREA OF EXISTING POOL EXISTING BUILDING	CLIENT:	DRAWING TITLE
RL 7.10 DENOTES PROPOSED LEVEL	DENOTES PROPOSED WALLS	JEAN-FRANCOIS & MARIA DYONIZIAK	ELEVATION SHEET 03
NOTE: THESE DRAWINGS ARE NOT FOR CONSTRUCTION. FOR DA APPROVAL ONLY. NOTE: DO NOT SCALE OFF THIS DRAWING	DENOTES EXISTING WALLS TO REMAIN		
NOTE: ALL WORKS TO BE IN ACCORDANCE WITH THE B.C. NOTE: ALL WORKS TO BE IN ACCORDANCE WITH THE RELEVANT AUSTRALIAN STANDAR	DS DENOTES OUTLINE OF EXISTING BUILDING	LOCATION: 23 WOLLOMBI ROAD.	SCALE: 1:100 @ A3
NOTE: ALL WORKS TO BE IN ACCORDANCE WITH THE BASIX REQUIREMENTS	DENOTES OUTLINE OF EXISTING TO BE DEMOLISHED	BILGOLA PLATEAU, NSW.	1.100 @ A3

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		AL - ALUMINIUM MT - METAL	NI <u>STES.</u>
-,		BWK - BRICKWORK CR - CEMENT RENDER DP - DOWN PIPE	
ward		RC - REINFORCED CON WB - WEATHER BOARD W - WINDOW	• •
The second		D - DOOR FC - FIBROUS CEMENT	· · · · · · · · · · · · · · · · · · ·
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 	Contra and		· · · · · · · · · · · · · · · · · · ·
		21 Wollombi Rd, Bilgola Plateau	BOUNDARY
	PROPOSED CARPORT	BOUNDARY	
		EXISTING GROUND LINE AT BOUNDARY EXISTING GROUND LINE AT BUILDING	
		AT BUILDING	· · · · · · · · · · · · · · · · · · ·
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:	DATE OF ISSU 25.02.2019	E:	D DANIEL RAYMOND ARCHTECTI BLARCHTECTUBELBYD New REGLAWPAS
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KEY: DENOTES CALCU		T DENOTES PROPOSED						25 Wollombi Rd, Bilgola Plateau	
L'ANDSCAPE AREA		SCREENING HEDGE							
DENOTES EXISTIN	G POOL AREA	DENOTES PROPOSED SHRU	JBS						
DENOTES GRASS	LAWN AREA	DENOTES PROPOSED FEAT	URE			x VrX4		Lift I I I I I I MINROW. I	
DENOTES OUTLIN	E OF EXISTING BUILDING ****	DENOTES PROPOSED GRAS GROUND COVER	SSES &		7	B DP WF			99°39'40"
denotes tree		DENOTES TERRACE AREA						EXISTING STAR TO BE ALTERED	
		DENOTES CONCRETE DRIVE AREA	EWAY	** ***	entre and the second	T- WF			
Contraction Contra	G TREE TO BE			+ 4	x ⁰ , 10	SA			
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	SED FEATURE					PROPOSED . GARDENS	EXISTING POOL TO BE MODIFIED		
DENOTES PROPO TREE	SED FEATURE					GARDENS	YEXISTING POOL TO BE MODIFIED		
	BOTANICAL NAME	COMMON NAME	SCHEDULED SIZE]		PROPOSED - GARDENO -	EXISTING POOL TO BE MODIFIED		
ID QUANTITY TREES LC ER DR	BOTANICAL NAME Lophostemon confertus Elaeocarpus reticulatus Dracaena Draco	Brush Box Blueberry Ash Dragon Tree	SCHEDULED SIZE 75Lt 45Lt			PROPOSED GROPHS GROPHS CONTRACTOR SALE SALE SALE SALE SALE	EXISTING POOL TO BE MODIFIED		KE
ID QUANTITY TREES LC - ER -	BOTANICAL NAME	Brush Box Blueberry Ash	75Lt			PROPOSED - GARDENS -	EXISTING POOL TO BE MODIFIED		23 Wollombi Ro
ID QUANTITY TREES LC - ER - TYU - GC -	BOTANICAL NAME Lophostemon confertus Elaeocarpus reticulatus Dracaena Draco Yucca Brevifolia Dypsis Lutescens	Brush Box Blueberry Ash Dragon Tree Yucca Golden Cane Palm	75Lt		Samont Based	PROPOSED P. GARDENO P. GARDE	EXISTING POOL TO BE MODIFIED		Ð
TREE CONTREE C	BOTANICAL NAME Lophostemon confertus Elaeocarpus reticulatus Dracaena Draco Yucca Brevifolia Dypsis Lutescens Plumeria Pandanus amaryllifolius Banksia Integrifolia Sysygium australe	Brush Box Blueberry Ash Dragon Tree Yucca Golden Cane Palm Frangipani Tree Pandanus Coastal Banksia	75Lt 45Lt 75Lt		P (PROPOSED P.GARDENS P	EXISTING POOL TO BE MODIFIED		23 Wollombi Ro
ID QUANTITY TREES IC - ER - ER - ID R	BOTANICAL NAME Lophostemon confertus Elaeocarpus reticulatus Dracaena Draco Yucca Brevifolia Dypsis Lutescens Plumeria Pandanus amaryllifolius Banksia Integrifolia	Brush Box Blueberry Ash Dragon Tree Yucca Golden Cane Palm Frangipani Tree Pandanus	75Lt 45Lt		P C		EXISTING POOL TO BE MODIFIED		23 Wollombi Ro
TREE D QUANTITY TREES LC FR C F	BOTANICAL NAME Lophostemon confertus Elaeocarpus reticulatus Dracaena Draco Yucca Brevifolia Dypsis Lutescens Plumeria Pandanus amaryllifolius Banksia Integrifolia Sysygium australe 'Resilience' Viburrum odoratissmum	Brush Box Blueberry Ash Dragon Tree Yucca Golden Cane Palm Frangipani Tree Pandanus Coastal Banksia Lilly Pilly	75Lt 45Lt 75Lt 300mm		P C				23 Wollombi Ro
TREES TREES C	BOTANICAL NAME Lophostemon confertus Elaeocarpus reticulatus Dracaena Draco Yucca Brevifolia Dypsis Lutescens Plumeria Pandanus amaryllifolius Banksia Integrifolia Sysygium australe 'Resilience' Viburnum odoratissmum 'Emerald Lustre' Grevillea 'Robyn Gordon'	Brush Box Blueberry Ash Dragon Tree Yucca Golden Cane Palm Frangipani Tree Pandanus Coastal Banksia Lilly Pilly Viburnum Grevillea	75Lt 45Lt 75Lt 300mm 300mm 300mm 300mm 300mm		P C	ALL AND ALL AN			23 Wollombi Ro

GRASSES/ GROUNDCOVERS LT 30 VH 40 LM -

FERNS AA CC BSL

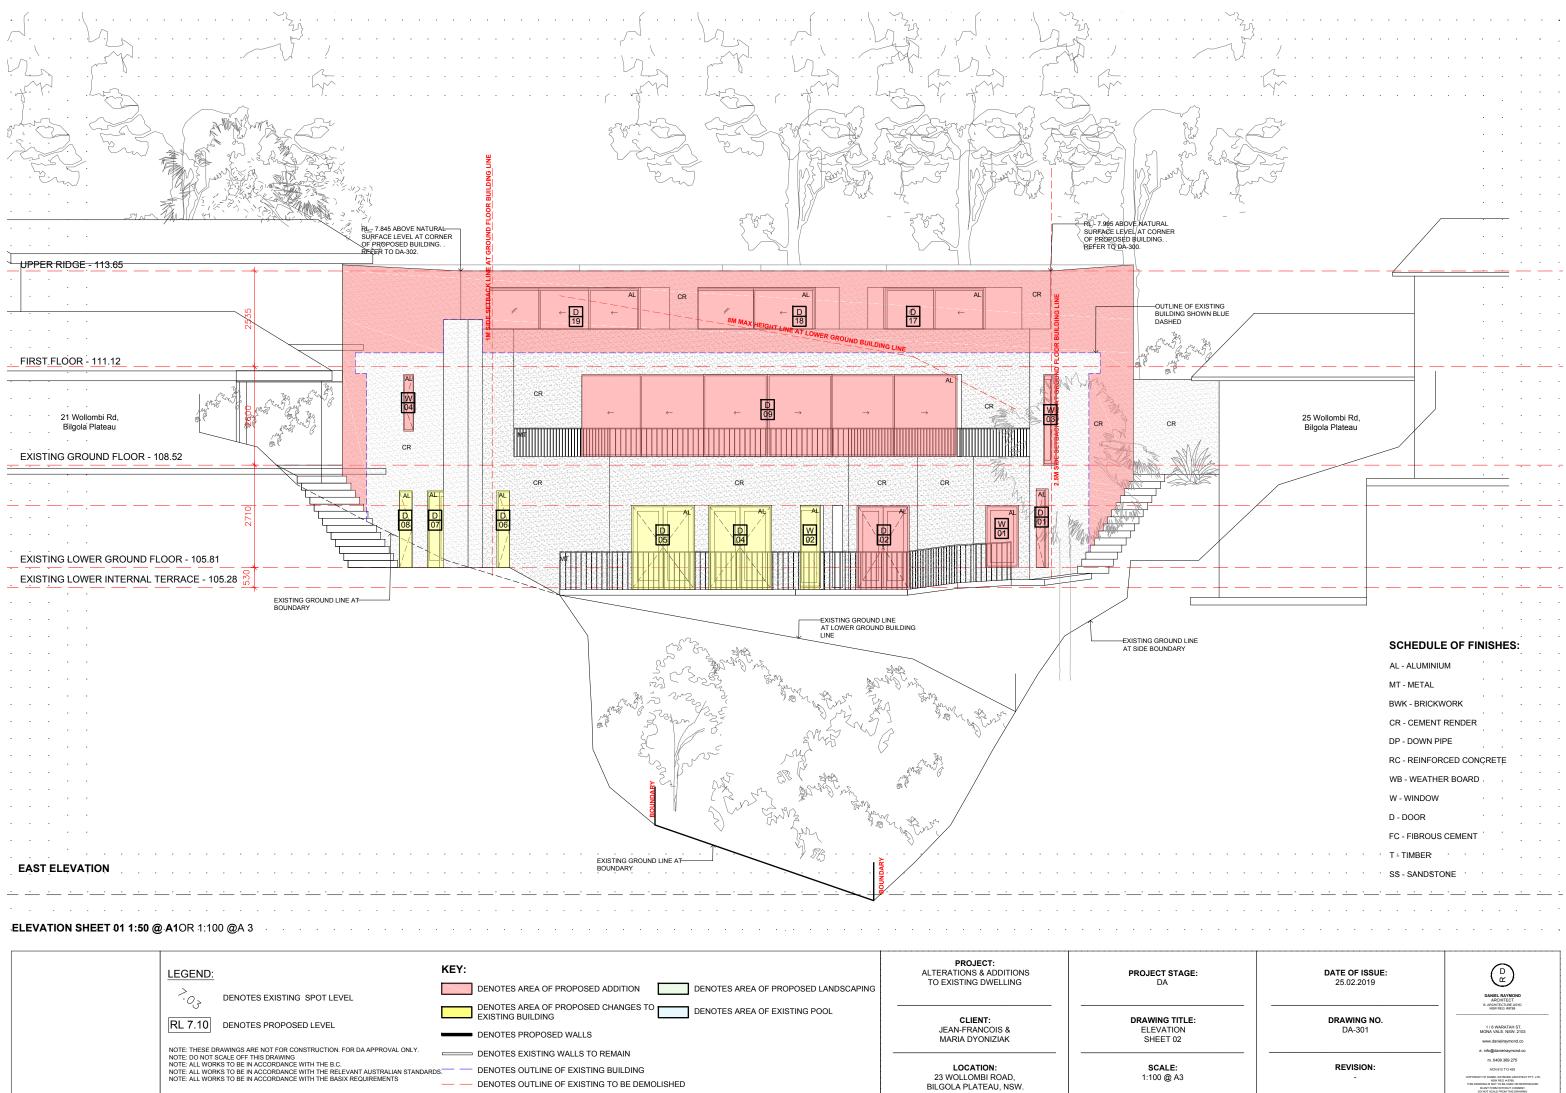LANDSCAPE CONSTRUCTION NOTES

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30 40

Asplenium australascum Cyathea cooperi Blechnum 'Silver Lady'

Lomandra longifolia Viola hederacea Lirope 'Evergreen Giant'

Birds Nest Fern Scaly Tree Fern

Silver Lady Fern

Spiny-headed mat Rush Native Violet

Giant Mondo Grass

200mm 25Lt

300mm

100mm 150mm

	TREE PROTECTION	
	All trees nominated to be retained are to be protected throughout the duration of the demolition and construction periods. All tree protection enclosures must be established prior to commencement of demolition works and shall comprise a	3 OF THE SURROUNDING SOIL, OR 75MM BELOW PAVING LEVEL TO ALLOW PLACEMENT OF MULCH. BACKFILL, WITH TOPSOIL MAXTURE. LIGHTLY TAMP AND WATER TO ELIMINATE AIR POCKETS. ENSURE THAT TOPSOIL
		IS NOT PLACED OVER THE TOP OF THE ROOTBALL, SO THAT THE PLANT STEM IS THE SAME HEIGHT AS IN THE CONTAINER.
•	material and debris. Do not place bulk materials and harmful materials under or near trees. Do not place spoil from excavations against tree trunks. Prevent wind- blown materials such as cement from harming trees and plants.	THOROUGHLY WATER PLANTIS BEFORE PLANTING AND IMMEDIATELY AFTER PLANTING.
		IN PLANTING BEDS AND INDIVIDUAL PLANTINGS, PLACE SLOW RELEASE FERTILISER PELLETS AROUND PLANTS AT THE TIME OF PLANTING AT THE RATE RECOMMENDED BY THE MANUFACTURER.
		MULCHING
	SUBSOIL	All garden bed areas are to be mulched to 75mm depth with same or similar to Forest Blend. Provide mulch/gravel which is free of deleterious and extraneous matter such as stones, soil, weeds and sticks.
	Excavate to bring the subsoil to a minimum of 300mm below finished design levels, to allow for infilling with topsoil mix. Break up the soil to a further depth of 100mm.	Place mulch/gravel clear of plant stems, and rake to an even surface flush with the surrounding finished levels.
	Remove all building rubble, waste oil, cement and other material harmful to plant groWFh from planting beds prior to placement of topsoil.	DECORATIVE GRAVEL
	Cultivate to a minimum depth of 100mm over areas to be planted or grassed. Do not disturb services or tree roots; if necessary, cultivate these areas by hand. During cultivation, thoroughly mix in materials required to be incorporated into	All areas nominated as Decorative Gravel are to be finished as detailed with sandstone pebbles 10mm-20mm average diameter, same or similar to that supplied by Australian Native Landscapes.
	the subsoil. Remove stones exceeding 25mm, clods of earth exceeding 50mm, and weeds, rubbish or other deleterious material brought to the surface during cultivation. Trim the surface to the required design levels after cultivation.	Selected pebbles are to be free of deleterious and extraneous matter such as stones, cement, soil, weeds and sticks.
	Confirm that the planting beds are free draining. If not install sub-soil drainage lines and connect to stormwater system.	Tamo pebbles to an even surface flush with the surrounding finished levels.
·	Apply additives after ripping or cultivation and incorporate into the upper 100mm layer of the subsoil.	DECORATIVE ROCK MULCH
	TOPSOIL	All areas nominated as Decorative Rock Mulch are to be finished with sandstone soalls, average diameter 80mm-120mm, same or similar to those supplied by Benedicts Sand and Gravel.
	Where possible use site toosoil and compost mixed at a rate of 4 soil : 1 compost, thoroughly mixed before placement. If imported soil is required soil shall be same or similar to Australian Native Landscapes Premium garden mix or similar	INDECOMPOSED GRANITE PAVEMENT
	for carden bed areas or Turf Underlav mix for turf areas.	Decomposed granite is to be fine-crushed river gravel (5mm-7mm), to a depth of 50mm, Daced on a 50mm bed of coarse gravel on 100mm consolidated hardcore. Gravel/is to be compacted and trimmed to provide falls and a free draining
•	Spread topsoil on the prepared subsoil and grade evenly, making the necessary allowances so that required finished levels and contours are achieved after light compaction.	surface
	Compact lightly and uniformly in 150mm layers. Avoid differential subsidence and excess compaction and produce a finished topsoil surface which is ready for planting.	INSTALLATION OF BRICK GARDEN FDGE
	Soread topsoil to the following typical depths:	A stretcher or single paver brick edge is to be installed to separate turf and garden beds, Secure pavers on rough mortar footing 100mm thick and ensure uniform 10mm joints between each brick to create flush struck joints. Refer to edging
	Planting beds: 300mm	and turfino detail.
	Grass areas: 100mm	FERTILISER + 62
		Fertiliser is to be slow release fertiliser equivalent to "Osmocote" and is to be applied at manufacturer's specified rates.
		INDRAINAGE
	for garden bed areas or Turf Underlav mix for turf areas.	Ensure adequate drainage to all garden beds, gravel and lawn areas. Install 100mm agricultural pipe with sock as required in garden beds and behind all retaining walls. Agricultural pipes to drain to junction pits and connect to stormwater
	Spread topsoil on the prepared subsoil and grade evenly, making the necessary allowances so that required finished levels and contours are achieved after light compaction.	system. Ensure paved areas are free draining. Install pits if required. (Refer to Hydraulic Engineering).
•	Compact lightly and uniformly in 150mm layers. Avoid differential subsidence and excess compaction and produce a finished topsoil surface which is ready for planting.	RETAINING WALLS
	Spread topsoil to the following typical depths:	Retaining walls to be constructed as per Engineer's details.
	Planting-beds: 300mm	CONCRETE WORKS
	Grass areas: 100mm	All paths, steps, slabs and footings shall be to Engineer's specification.
	PLANTING	Materials and construction to AS3600 and AS3610.
	TRES: EXCAVATE A PLANT HOLE TO TWICE THE DIAMETER OF THE ROOT BALL AND AT LEAST 100MM DEEPER THAN THE ROOT BALL, BREAK UP THE BASE OF THE HOLE TO A FURTHER DEPTH OF 100MM, AND	Supply and install ready mixed expected to AS1270 with extended aggregate
	LOOSEN THE COMPACTED SIDES OF THE HOLE.	Supply and mislan reary timed concrete to AS or 9 with selected aggregate. Ensure all appropriate PVC conduits for granten liphting and irritation systems are placed before concrete and paving installation.
•		MAINTENANCE
	RESTRICTION OR DAMAGE, ARE VIGOROUS, WELL ESTABLISHED, FREE FROM DISEASE AND PESTS, OF GOOD FORM CONSISTENT WITH THE SPECIES OR VARIETY; AND ARE HARDENED OFF, NOT SOFT OR FORCE	
	AND SUITABLE FOR PLANTING IN THE NATURAL CLIMATIC CONDITIONS PREVAILING AT THE SITE.	cultivating, pruning, hedges clipping, aerating, reinstatement of mulch, renovating, top dressing and keeping the site neat and tidy. Continue to replace failed, damaged or stolen plants.
	TREES: PROVIDE TREES WHICH LINESS REQUIRED TO BE MULTI-STEMMED. HAVE A SINGLE LEADING SHOOT, TREES SHOULD BE STAKED AS SPECIFIED.	GENERAL NOTES
	LABEL AT LEAST ONE PLANT OF EACH SPECIES OR VARIETY IN A BATCH USING A DURABLE. READABLE TAG, DO NOT PLANT IN UNSUITABLE WEATHER CONDITIONS SUCH AS EXTREME HEAT. COLD, WIND OR RAIN	
	OTHER THAN SANDY SOLD. SUSPEND	2. Lighting and irrigation to be designed and installed by specialist.
	EXCAVATION WHEN THE SOIL IS WET, OR DURING FROST PERIODS, WHEN THE HOLD IS OF THE CORRECT SIZE, REMOVE THE PLANT FROM THE CONTAINER WITH MINIMUM DISTURBANCE TO THE ROOT BALL.	3. All dimensions and levels shall be verified by Contractor on site prior to commencement of work.
	ENSURE THAT THE ROOT BALL IS MOIST AND PLACE IN THE FINAL POSITION, IN THE HOLE AND PLUMB, WITH THE TOP SOIL LEVEL OF THE PLANT ROOT BALL LEVEL WITH THE FINISHED SURFACE	4 Do not scale from drawings
		5. Detailing of all structural components of design shall be by Consulting Structural Engineer.
		6 Existing levels refer survey by others
		6. Existing levels refer survey by others. 7. All landscare components of this design require Council Approval prior to construction.
۱۵	NDSCAPE CONCEPT PLAN 1:100 @ A1 OR 1:200 @A 3	Existing levels refer survey by others. All landscape components of this design require Cpuncil Approval prior to construction.

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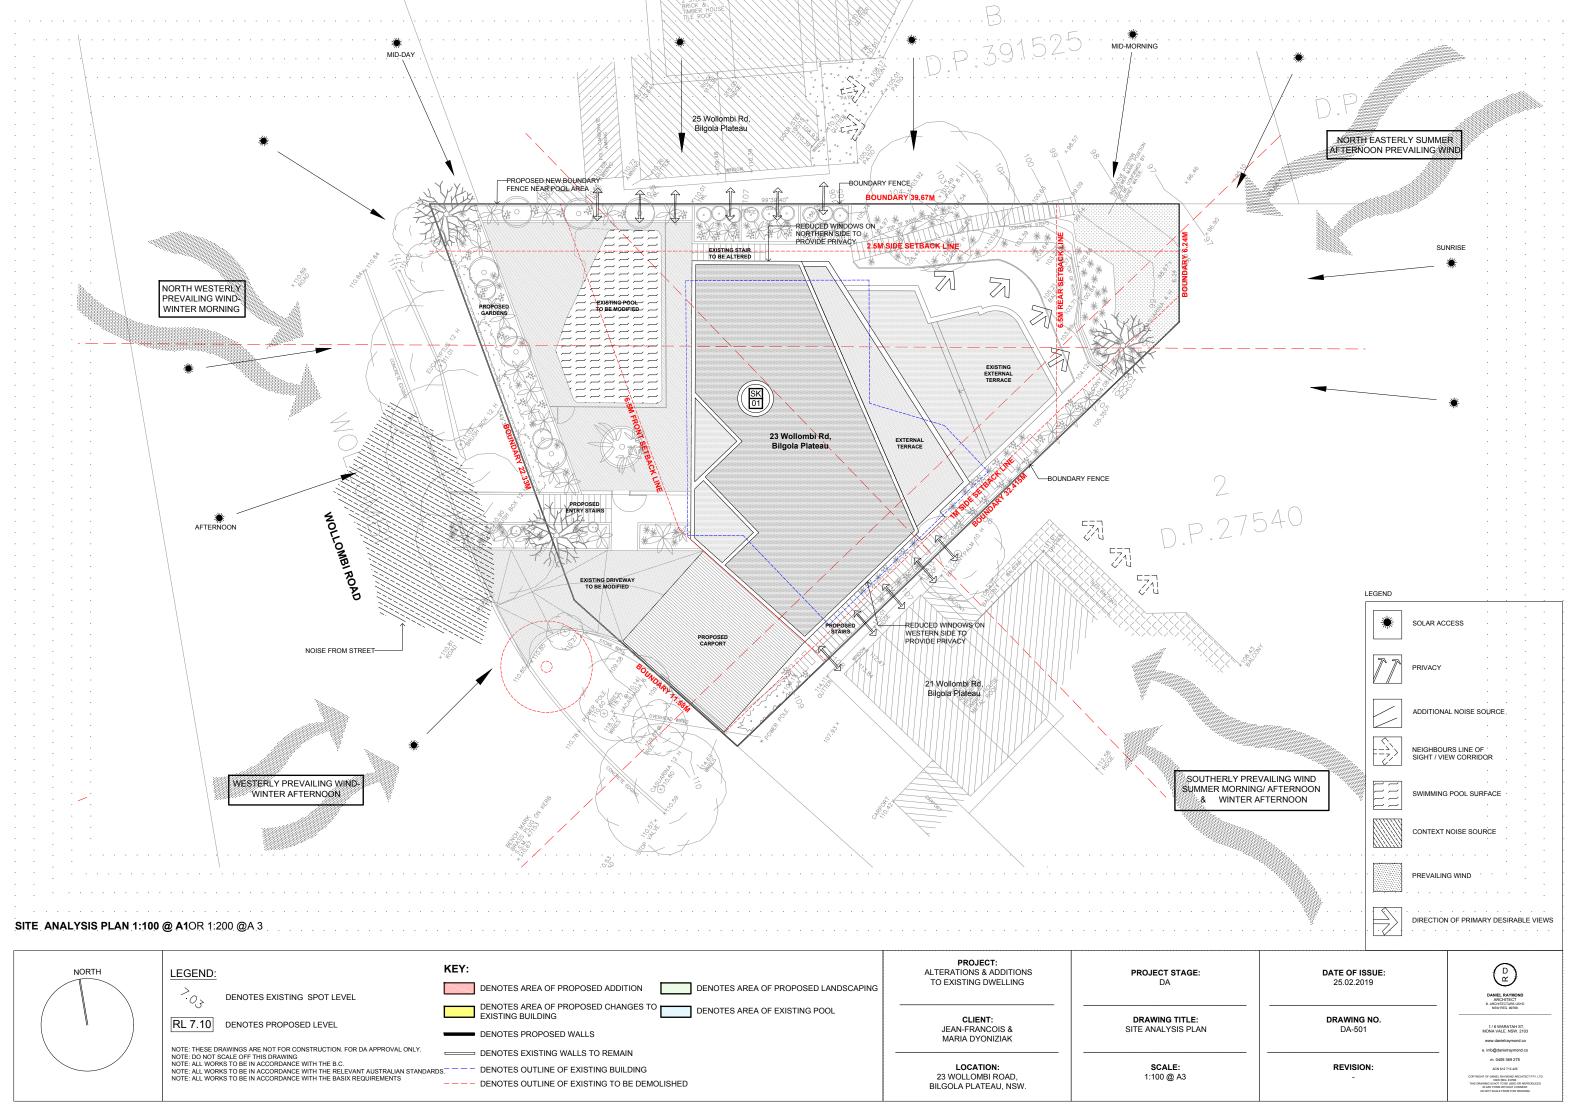
NORTH	LEGEND:	KEY: DENOTES AREA OF PROPOSED ADDITION DENOTES AREA OF PROPOSED LANDSCAPING	PROJECT: ALTERATIONS & ADDITIONS TO EXISTING DWELLING	PROJECT STAG
	RL 7.10 DENOTES PROPOSED LEVEL	DENOTES AREA OF PROPOSED CHANGES TO DENOTES AREA OF EXISTING POOL EXISTING BUILDING DENOTES PROPOSED WALLS DENOTES EXISTING WALLS TO REMAIN	CLIENT: JEAN-FRANCOIS & MARIA DYONIZIAK	DRAWING TITLE LANDSCAPE PLA
	NOTE: DO NOT SCALE OFF THIS DRAWING NOTE: ALL WORKS TO BE IN ACCORDANCE WITH THE B.C. NOTE: ALL WORKS TO BE IN ACCORDANCE WITH THE RELEVANT AUSTRALIAN STANDARD NOTE: ALL WORKS TO BE IN ACCORDANCE WITH THE BASIX REQUIREMENTS		LOCATION: 23 WOLLOMBI ROAD, BILGOLA PLATEAU, NSW.	SCALE: 1:100 @ A3

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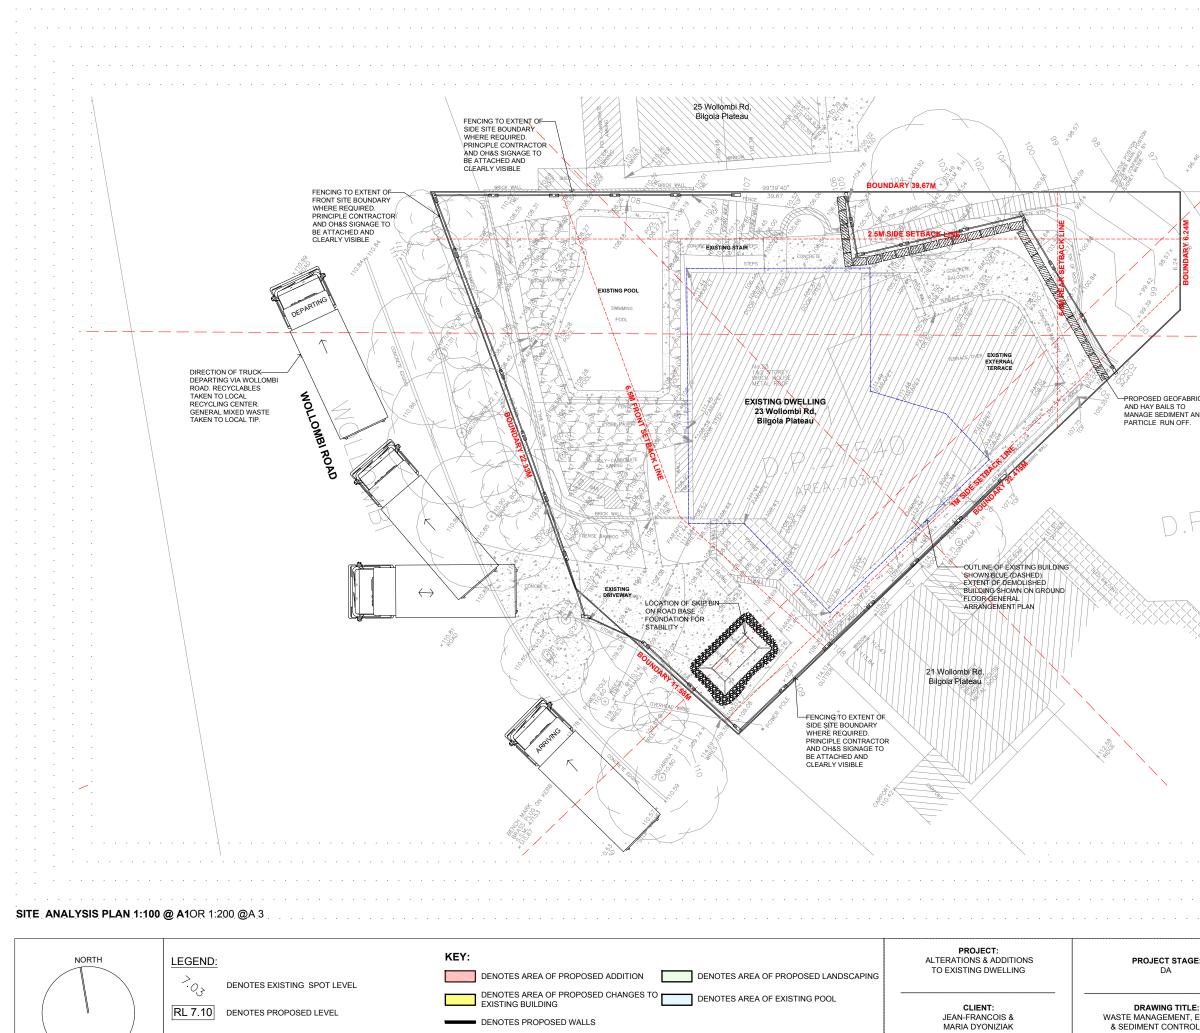
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PROPOSED CARPORT



NORTH	LEGEND:	KEY:	PROJECT: ALTERATIONS & ADDITIONS TO EXISTING DWELLING	PROJECT STA DA
	RL 7.10 DENOTES PROPOSED LEVEL	DENOTES AREA OF PROPOSED CHANGES TO DENOTES AREA OF EXISTING POOL EXISTING BUILDING	CLIENT: JEAN-FRANCOIS &	DRAWING TI SITE ANALYSIS
	NOTE: THESE DRAWINGS ARE NOT FOR CONSTRUCTION. FOR DA APPROVAL ONLY. NOTE: DO NOT SCALE OFF THIS DRAWING NOTE: ALL WORKS TO BE IN ACCORDANCE WITH THE B.C.	DENOTES PROPOSED WALLS DENOTES EXISTING WALLS TO REMAIN	MARIA DYONIZIAK	
	NOTE: ALL WORKS TO BE IN ACCORDANCE WITH THE BL. NOTE: ALL WORKS TO BE IN ACCORDANCE WITH THE RELEVANT AUSTRALIAN STANDAF NOTE: ALL WORKS TO BE IN ACCORDANCE WITH THE BASIX REQUIREMENTS	NDS DENOTES OUTLINE OF EXISTING BUILDING DENOTES OUTLINE OF EXISTING TO BE DEMOLISHED	LOCATION: 23 WOLLOMBI ROAD, BILGOLA PLATEAU, NSW.	SCALE: 1:100 @ A3



DENOTES EXISTING WALLS TO REMAIN

DENOTES OUTLINE OF EXISTING BUILDING

DENOTES OUTLINE OF EXISTING TO BE DEMOLISHED

NOTE: THESE DRAWINGS ARE NOT FOR CONSTRUCTION. FOR DA APPROVAL ONLY. NOTE: DO NOT SCALE OFF THIS DRAWING NOTE: ALL WORKS TO BE IN ACCORDANCE WITH THE B.C. NOTE: ALL WORKS TO BE IN ACCORDANCE WITH THE RELEVANT AUSTRALIAN STANDARDS.[—] — — NOTE: ALL WORKS TO BE IN ACCORDANCE WITH THE BASIX REQUIREMENTS

LOCATION:	
23 WOLLOMBI ROAD,	
BILGOLA PLATEAU, NSW.	

SCALE:

1:100 @ A3

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1. Grey Cement Rendered External Walls



2. Concrete Roof with Waterproof Membrane



3. Carport Colorbond Roofsheeting - "Windspray" or Similar



5. Steel Balustrading



6. Aluminium Framed Windows and Doors with Fire Shutters where required



7. Concrete Topping Pool Coping and Proposed Teerace Areas

EXTERNAL FINISHES

ALTERATIONS & ADDITIONS TO EXISTING DWELLING INCLUDING ASSOCIATED LANDSCAPING 23 WOLLIMBI ROAD, BIGOLA PLATEAU,, NSW.



3. Steel Carport Structure - Mid Tone Grey to Match External Render



8. Native Gardens