


RK DESIGNS

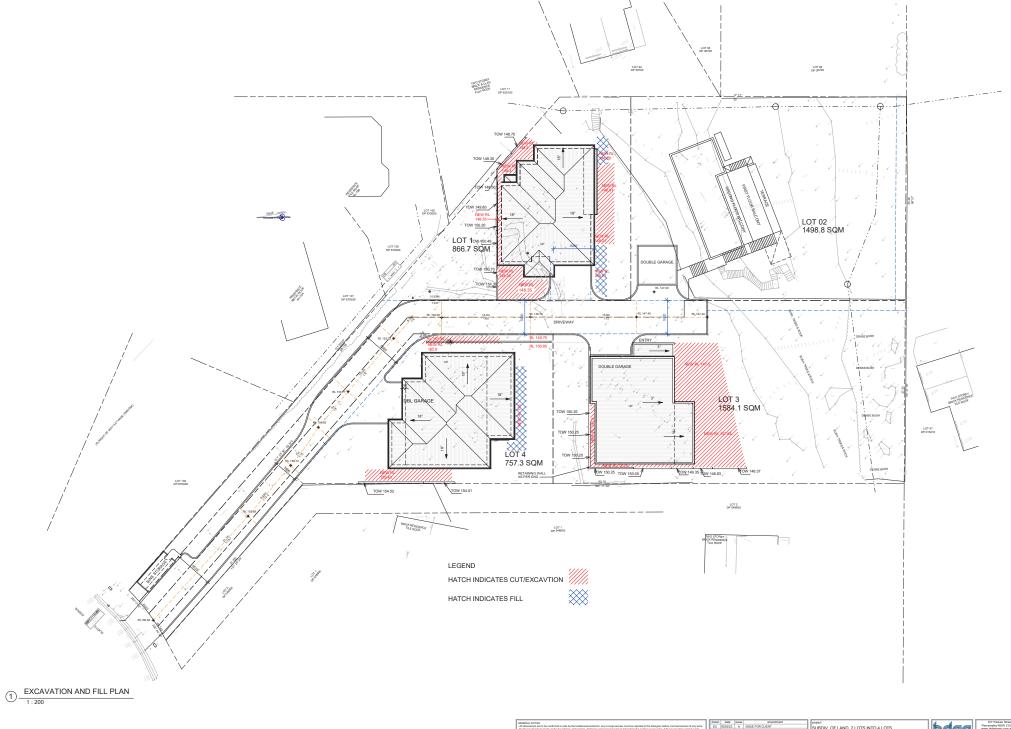

GEREAL ACTION AS ASSESSMENT OF THE ASSESSMENT OF


project
SUBDIV. OF LAND, 2 LOTS INTO 4 LOTS.
PROOP CONSTRUCT. OF 3 X 2 STRY DWELLINGS AT
12-14 GLADYS AVENUE, FRENCHS FOREST, NSW, 2088


Light CY 745AMS.

67 Pales Street,
Personalis Now 2150
A C C R E D IT E D
BULDING DESIGNER

Examing Street,
Stre

com and com an

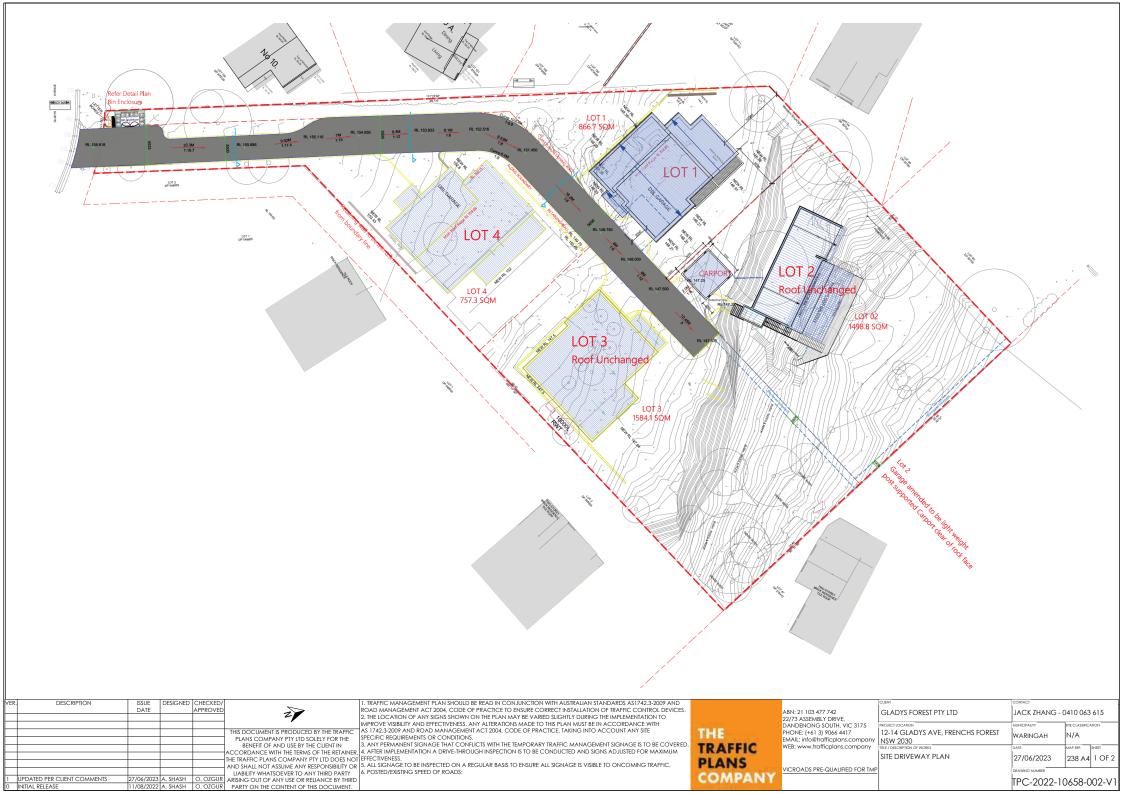

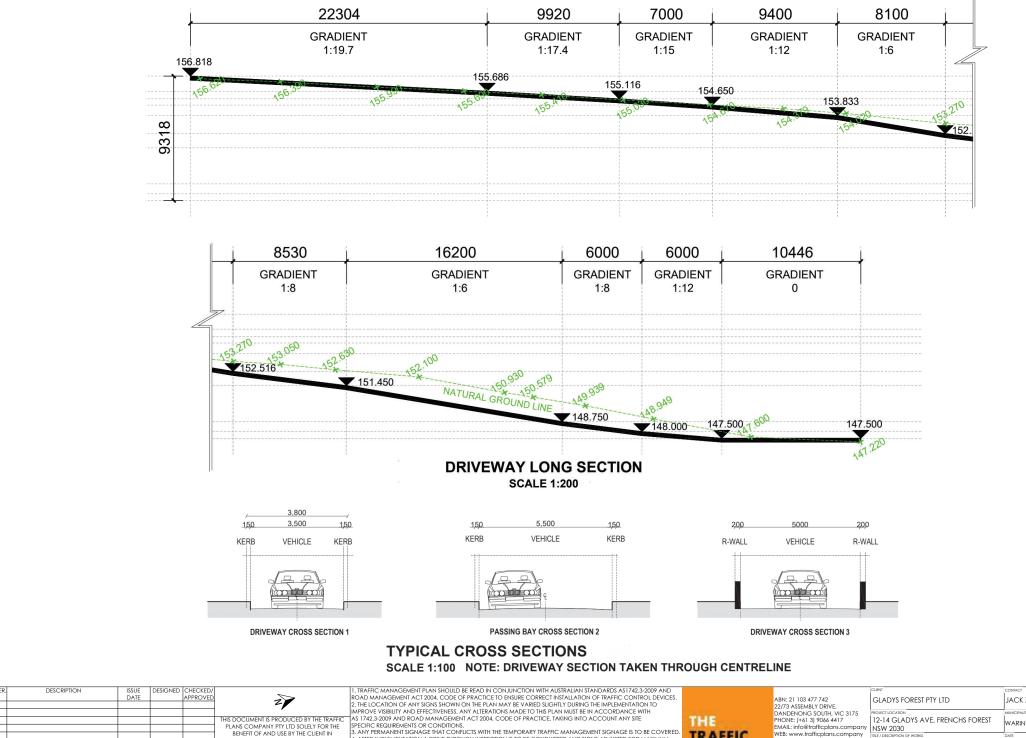



JACK ZHANG - 0410 063 615 WARINGAH N/A ENSETTO AND USE BY THE CUENT IN:

S. ANY PERMANENT SIGNAGE THAT CONFLICTS WITH THE TEMPORARY TRAFFIC MANAGEMENT SIGNAGE IS TO BE COVERED.

A FIRE MIPLEMENTATION A DRIVE-THROUGH INSPECTION IS TO BE CONDUCTED AND SIGNS ADJUSTED FOR MAXIMUM THAT THE TRAFFIC PLANS COMPANY PY LID DOES NOT EFFECTIVENESS. TRAFFIC SITE DRIVEWAY SECTION 27/06/2023 238 A4 2 OF 2 PLANS AND SHALL NOT ASSUME ANY RESPONSIBILITY OR S. ALL SIGNAGE TO BE INSPECTED ON A REGULAR BASIS TO ENSURE ALL SIGNAGE IS VISIBLE TO ONCOMING TRAFFIC.

LIABILITY WHATSOEVER TO ANY THIRD PARTY 6. POSTED/EXISTING SPEED OF ROADS: VICROADS PRE-QUALIFIED FOR TMI COMPANY ARISING OUT OF ANY USE OR RELIANCE BY THIRD TPC-2022-10658-002-V 11/08/2022 A. SHASH O. OZGUR PARTY ON THE CONTENT OF THIS DOCUMENT.

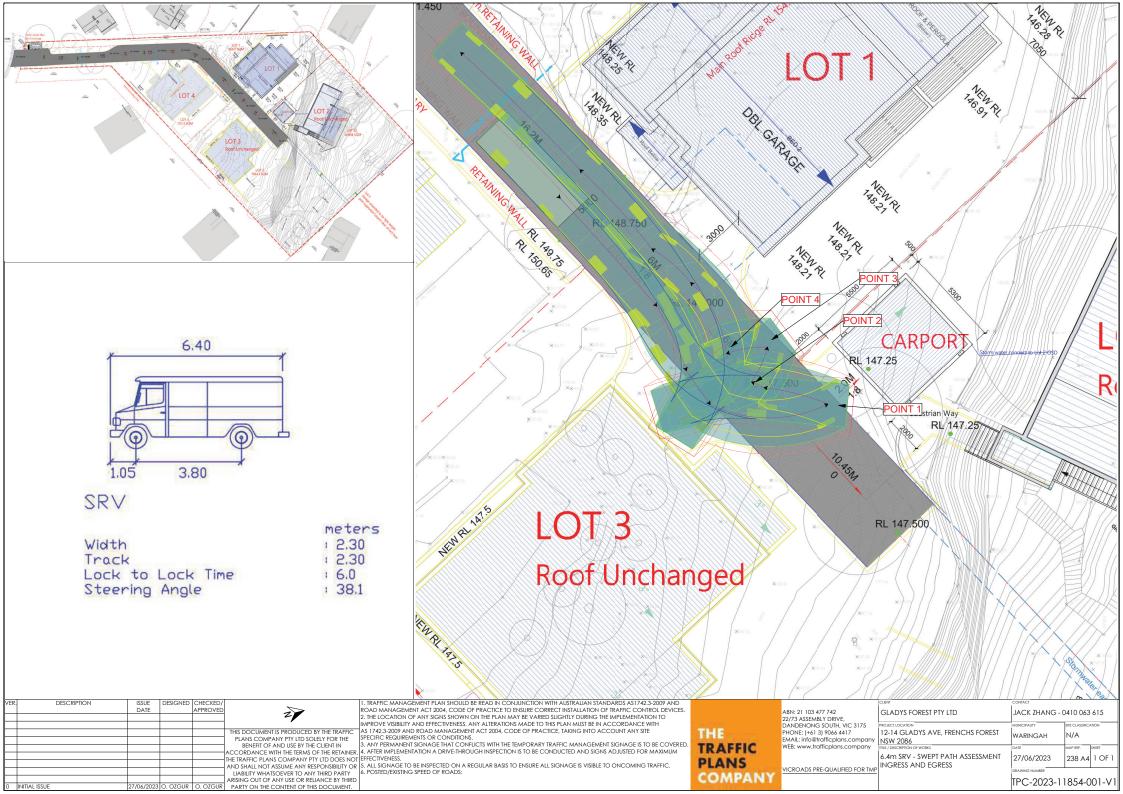

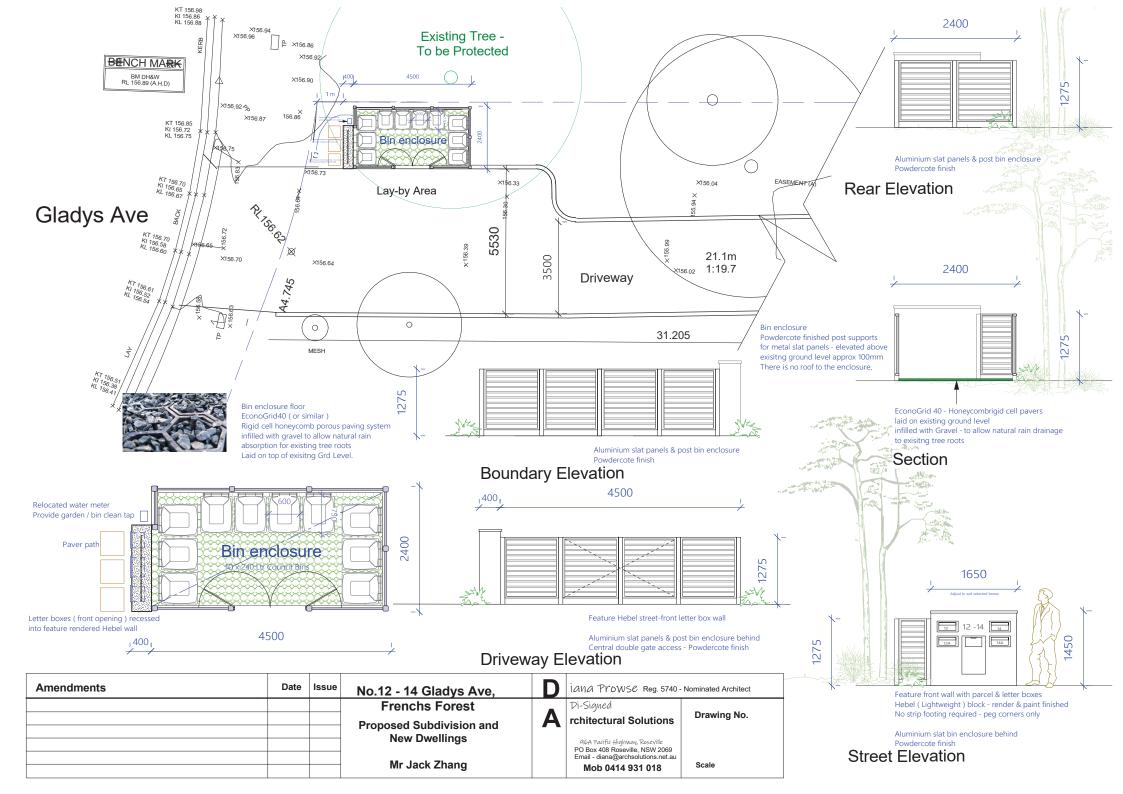




to meet the demands and loadings imposed across a wide range of end requirements and site conditions path. EconoGrid 40 plastic paving grids have been designed using carefully selected recycled plastics, especially in providing a stable, free draining pavement surface that retains gravel in situ. The application might be a gravel car park, an emergency access route or wheel chair / disabled access EconoGrid 40 is a porous paver that can provide a solution to a wide range of trafficking needs,


POROUS PAVER GRAVEL FINISH

Applications:

- Gravel car parking
- Overflow car parks
- Wheelchair / disabled access paths
- Free draining pedestrian paths
- Fire access roads / lanes
- Cycle paths
- Access routes and roads
- Drives and driveways

EconoGrid 40 porous plastic pavers can be filled with a 5mm to 20mm mixed sharp angular aggregate/ gravel to give a very stable, hardworking and free draining working surface. The design of EconoGrid 40 plastic porous pavers allows excellent interlock with the gravel resisting and negating dynamic and lateral loadings so the gravel and paver remains in situ with little or no maintenance requirements.

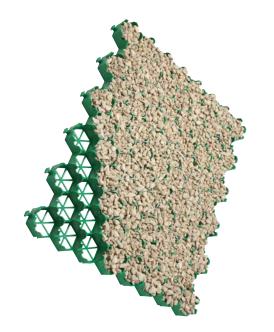

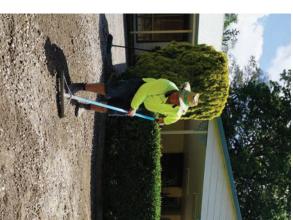







For technical and installation information visit: www.grassreinforcement.com.au/econogrid-40




The retained gravel finish, when installed correctly, will provide a hard-wearing, robust and permeable free draining surface that would have an expected lifetime of many years. Please see our installation and design guidance documents for further information.

EconoGrid 40 porous pavers are supplied in easy to handle square grids which interlock with adjacent paving grids to create a stable and robust surface. The plastic pavers have a 40mm deep open honeycomb structure which promotes and allows excellent interlock between angular stone/gravel particles where a gravel pavement is required.

EconoGrid 40 paving grids have been manufactured using specially selected 100% recycled plastics that have the qualities that are required for a strong, long-lasting, stable product suitable for the designed traffic load. These include:

- UV stabilisation to stop degradation by sunlight.
- Tested to 150T/m², capable of withstanding cars, vans, trucks and lorries
- Paver profile allows expansion on warmer days or in direct sunlight when required to stop lifting
- Plastic selection to allow use in cold temperatures – some plastic will become fragile when cold
- Open structure to allow unhindered water permeability
- Paver design maximises support and stability from either a gravel or a grass root structure
- All plastics used are stable, chemically inert and are not toxic so are suitable for normal soil conditions

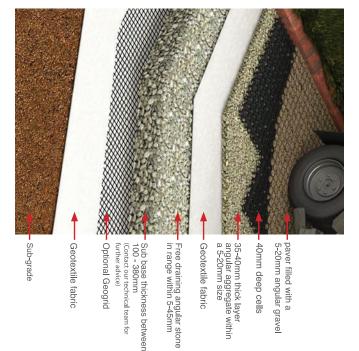

EconoGrid 40 porous plastic paving grids have been designed to meet the demands laid down by local government regarding flood alleviation and WSUD requirements (Water Sensitive Urban Design). EconoGrid 40 pavers provide a porous / permeable pavement surface that allows rainwater / flood water to infiltrate through the paver surface and fill material into the subgrade below. EconoGrid 40 can be used as part of a source control layer within a WSUD design.



Product Range

Laid size for 4 grids cover 1m²

Econogrid 40	Product
638mmx532mm	Size (outer)
ω	Grid per m² laid
40mm	Paver Cell Depth
150T/m²	Load bearing Strength Capacity
100% Recycled PP/PE	Material
Green	Colour





1 SITE LOCATION PLAN


NOTE SITE ANALYSIS PLAN IS TO BE READ IN CONJUNCTION WITH THE ARCHITECTURAL DRAWINGS. THE SHADOW DIAGRAM PLANS AND THE STATEMENT OF ENVIRONMENTAL EFFECTS, INCLUSIVE OF THE PHOTOGRAPHS & THE STREETSCAPE ELEVATION.


GENERAL NOTES	
. All dimensions are to be confirmed on site by the builder leubcontractor, any incongruencies must be reported to the Designer before commencement of any	work.
. No Survey has been made on the boundaries, all bearings, distances and areas have been taken from the contour survey plan. A Survey must be carried out confirm the exact boundary locations.	110
content the exact boundary occasions. No construction work shall commence until a site survey confirming the site boundaries has been completed. The contractor is to ensure that the boundary	
No construction work that commence unit is are survey comming the see ocurrences as peer complete. The contractor is to ensure that the boundary establish are confirmed and used, the boundary establish are recorded on over all other determined. The Survey work must be senformed by a recisitered by	
In the event of encountering any discrepancies on these drawings, specification or subsequent instructions issued, the Builder Subcontractor shall contact	reepon.
designer before proceeding further with any work.	
All construction, control loints and expansion loints in the wall, floors, other locations shall be in strict accordance with the Structural Engineering details. No	stnioi o
or breaks other than specified, are allowed without written permission from the Engineer.	
. Measurements for the fabrication of secondary components such as, windows, doors, internal frames, structural steel components and the like, are not to be	e taken
from these documents. Measurements must be taken on site to suit the work as constructed.	

date 05/22 05/22 05/22 05/22	A B C D	armendment ISSUE FOR CLENT REVISION B ISSUE FOR PIE DA ISSUE FOR DA	project SUBDIV. OF LAND, 2 LOTS INTO 4 LOTS, PROP.CONSTRUCT. OF 3 X 2 STRY DWELLING 12-14 GLADYS AVENUE, FRENCHS FOREST, N	BOULDING DESIGNER 6.07 Parkers Dresst, Personal Street,	
			client JACK ZHANG	true nort	th drawing SITE LOCATION PLAN project no date sheet no. scale @ A1 issue checked 22.46 a 23.05(2) 1 of 2 1 1 2000 D. PK

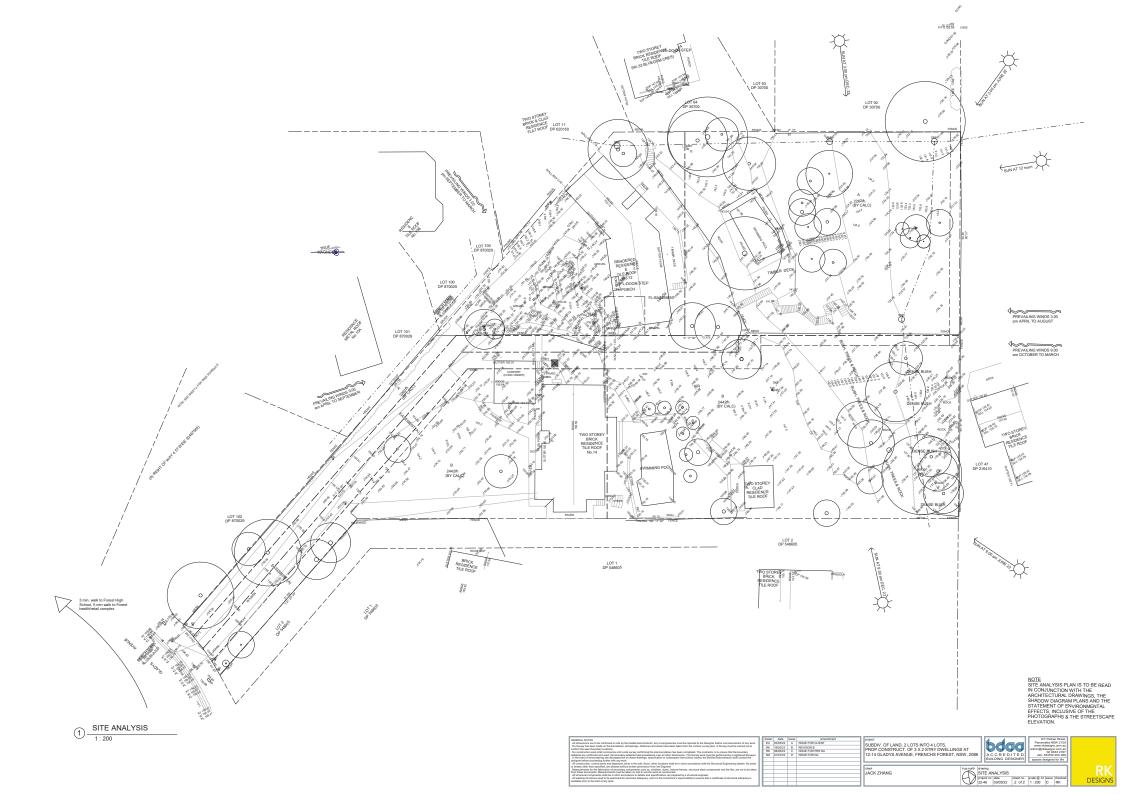


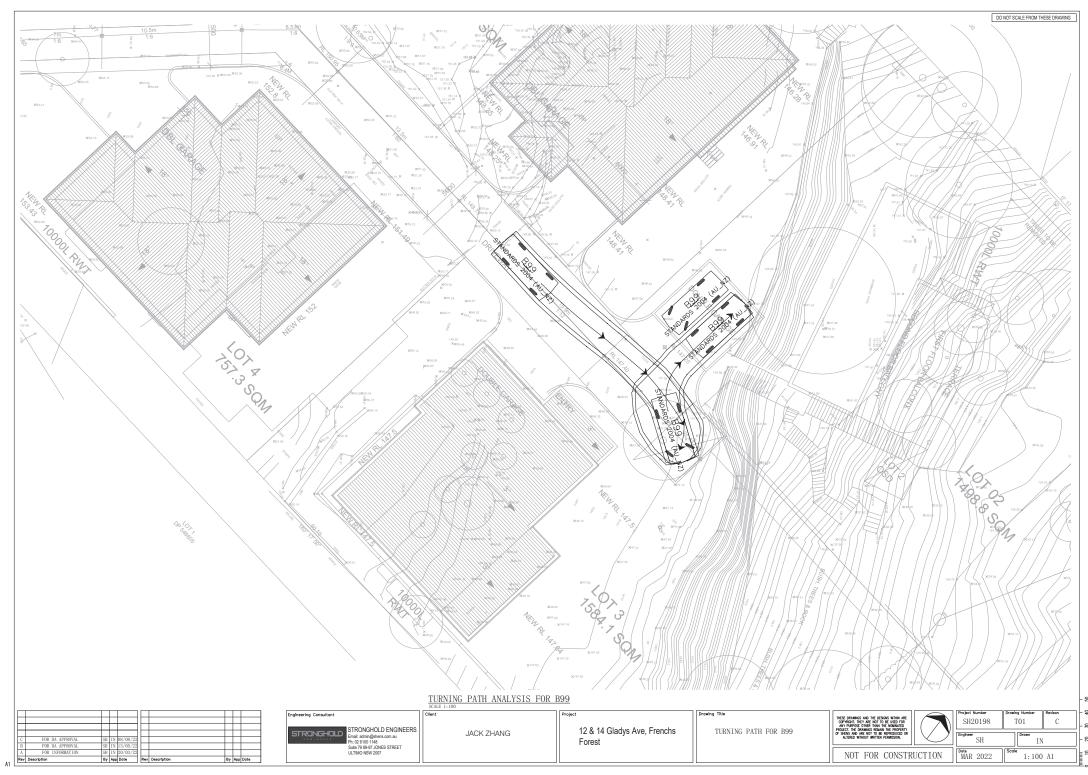

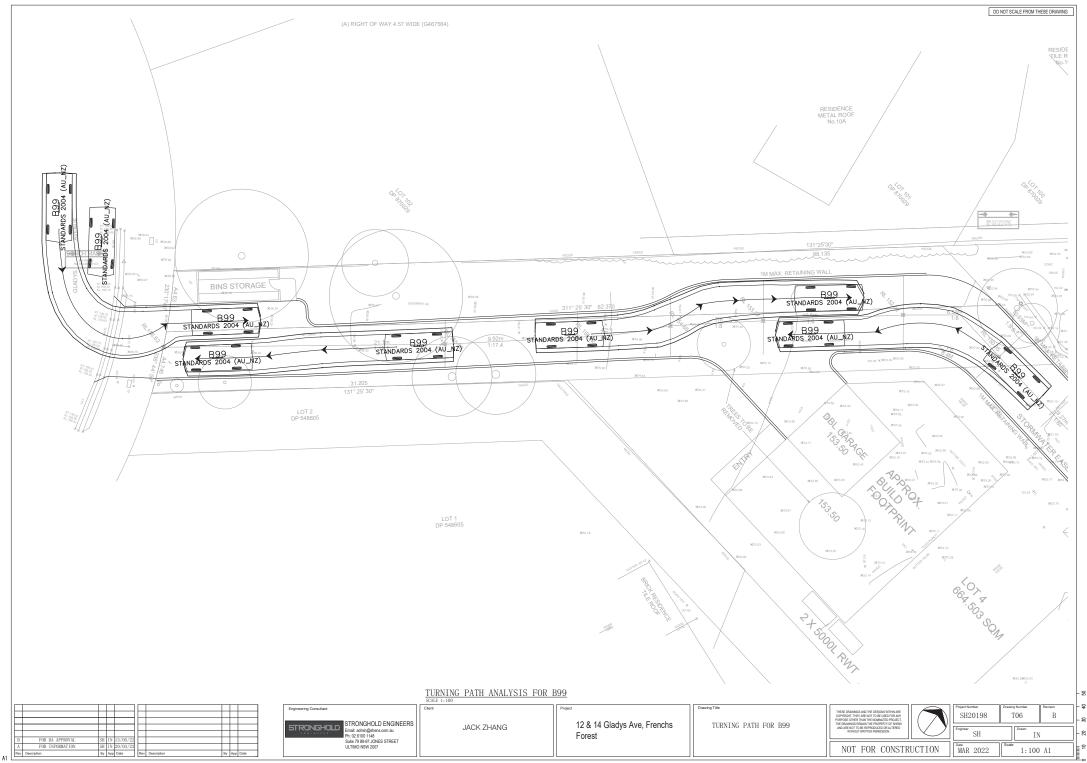


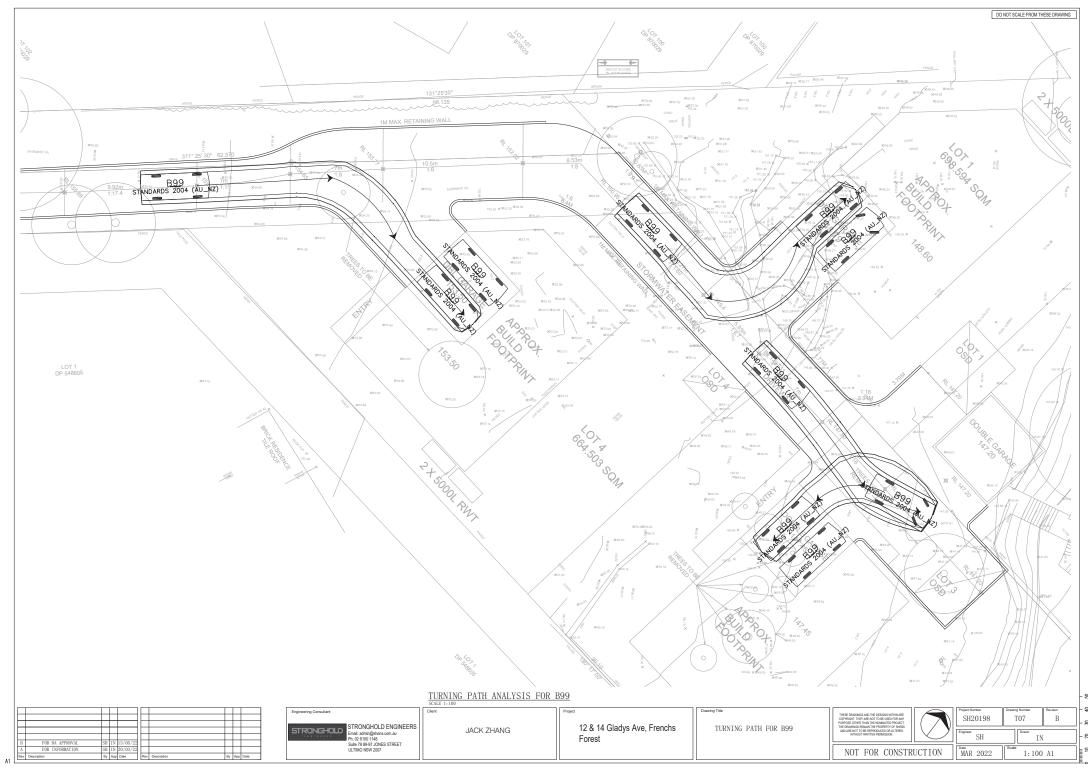


,

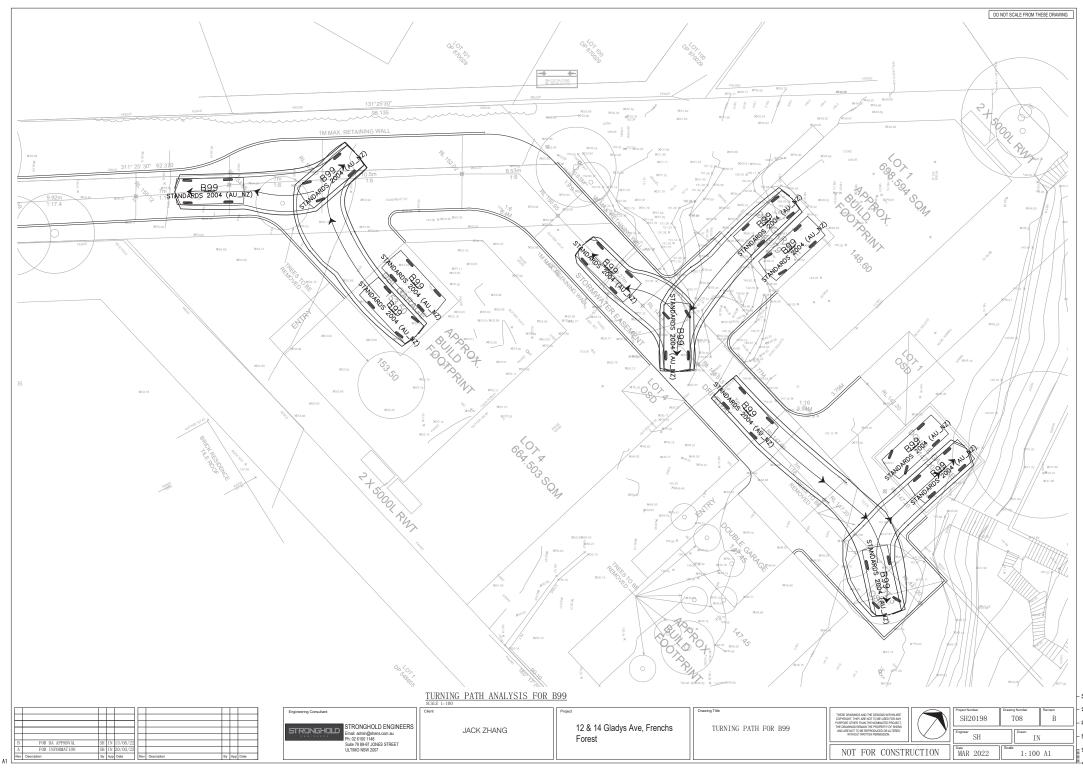

,

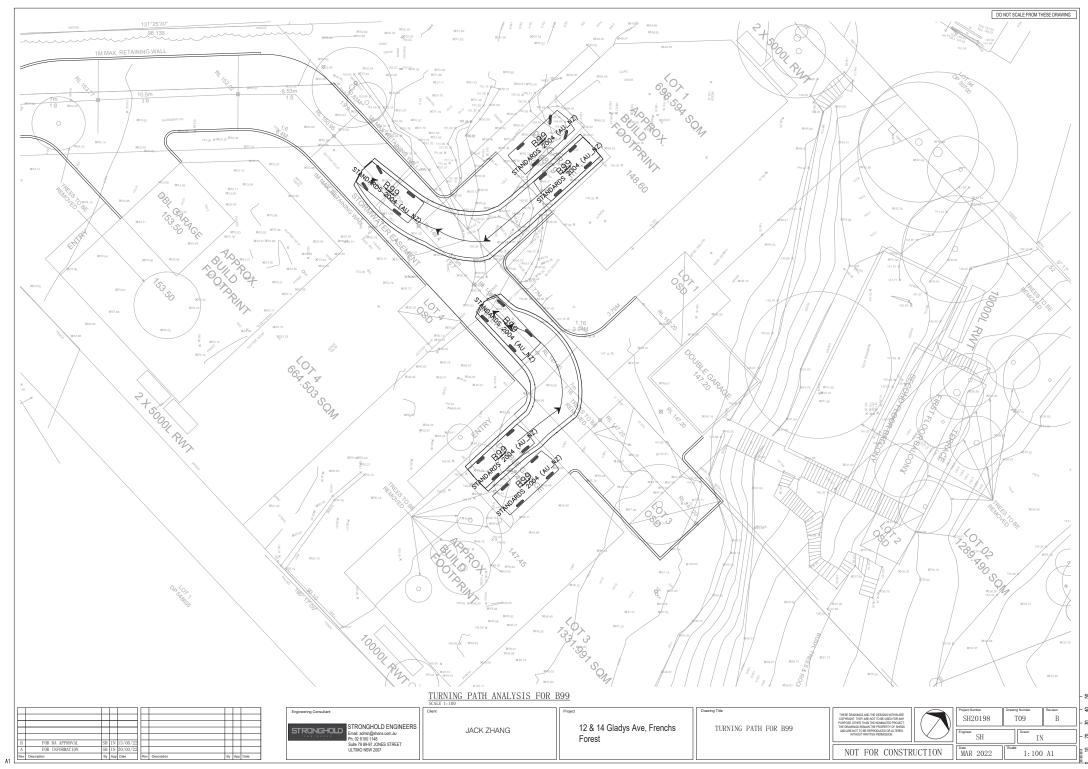

.

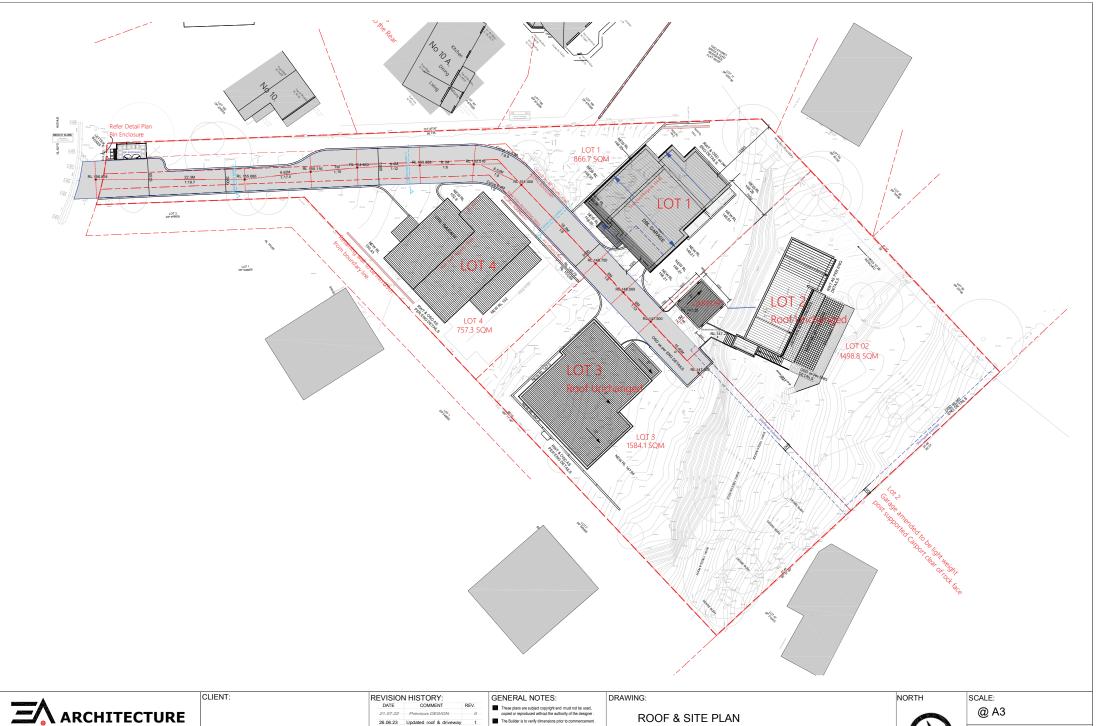



Eric Architecture Pty Ltd ABN:46 664 932 245 ACN: 664 932 245 Nominated Architect: Yuan Tao (NSW 12177)

Architecture | Development | Interior | Landscape | Consultancy COPYRIGHT: Eric Architecture Pty Ltd 2023


PROJECT ADDRESS: No. 12-14 GLADYS AVENUE, FRENCHS FOREST NSW 2086


- If any discrepancies arise they are to be reported to the designer prior to the commencement of the works.
- Do not scale, use figured dimensions only. If a dimension is not shown or is required consult with the designer.


 Do not after the design either architecturally or structurally without prior consultation with the designer or engineer.


DRAWING NO.


DA301

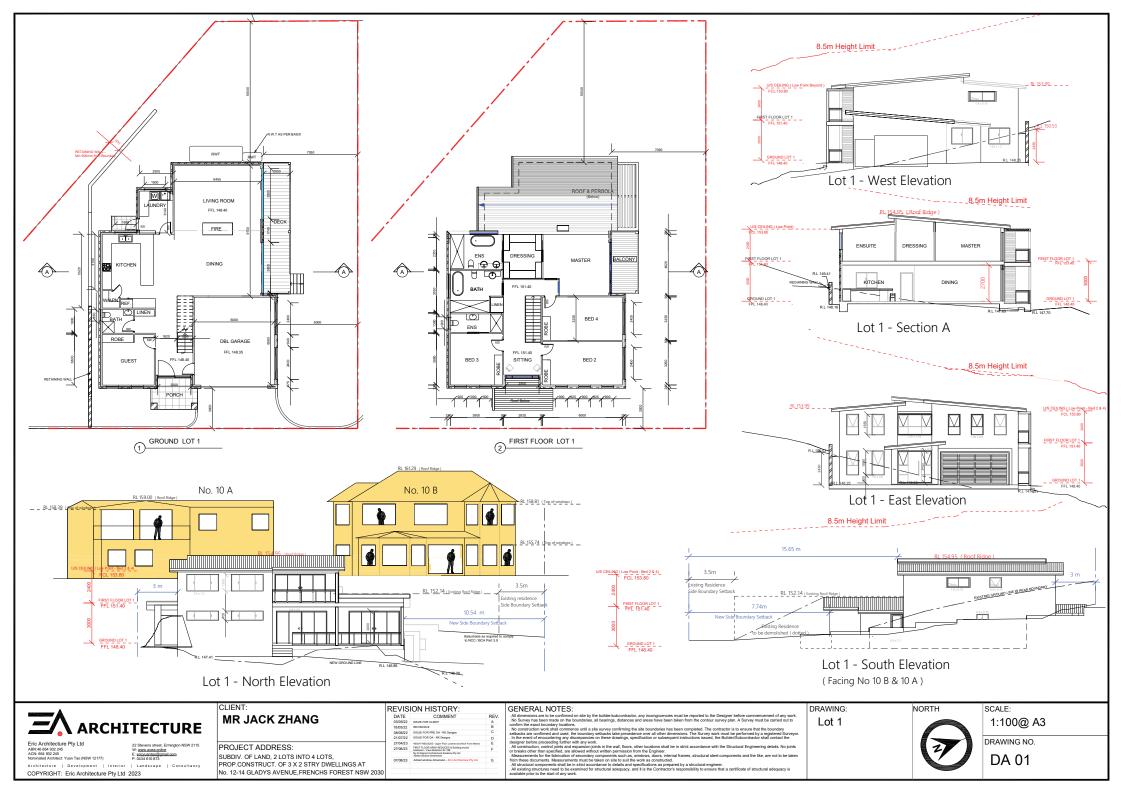

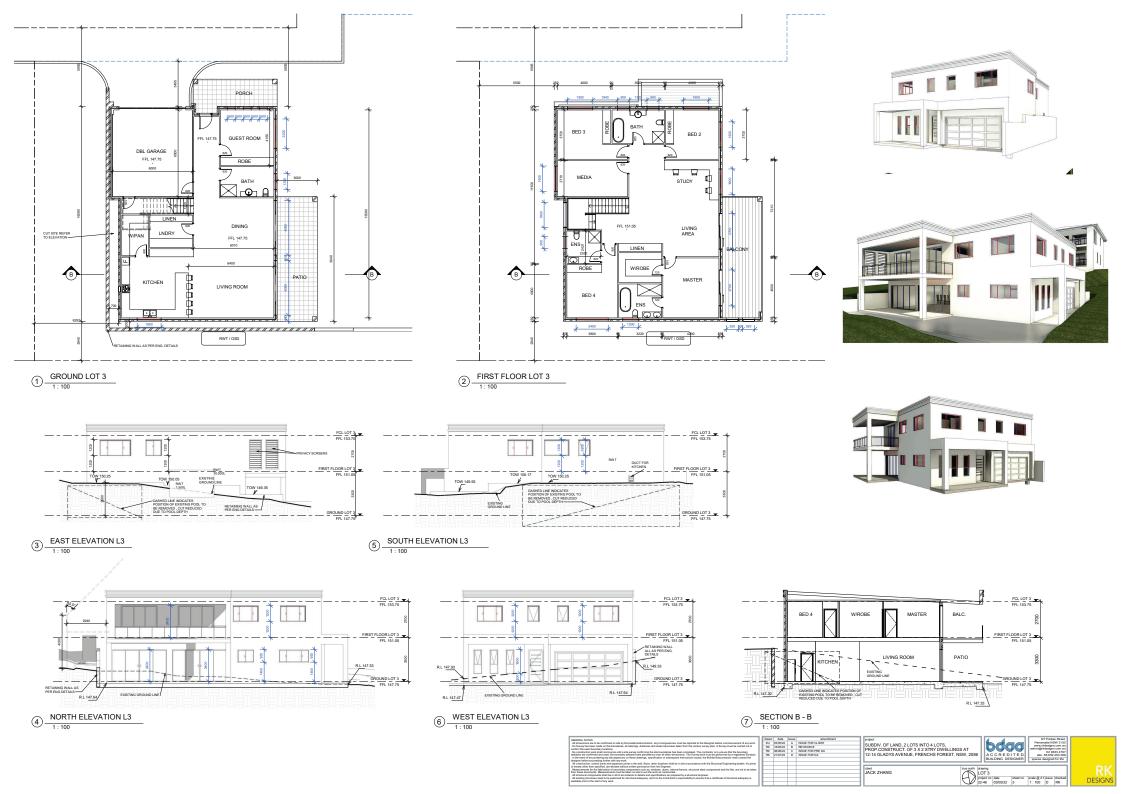

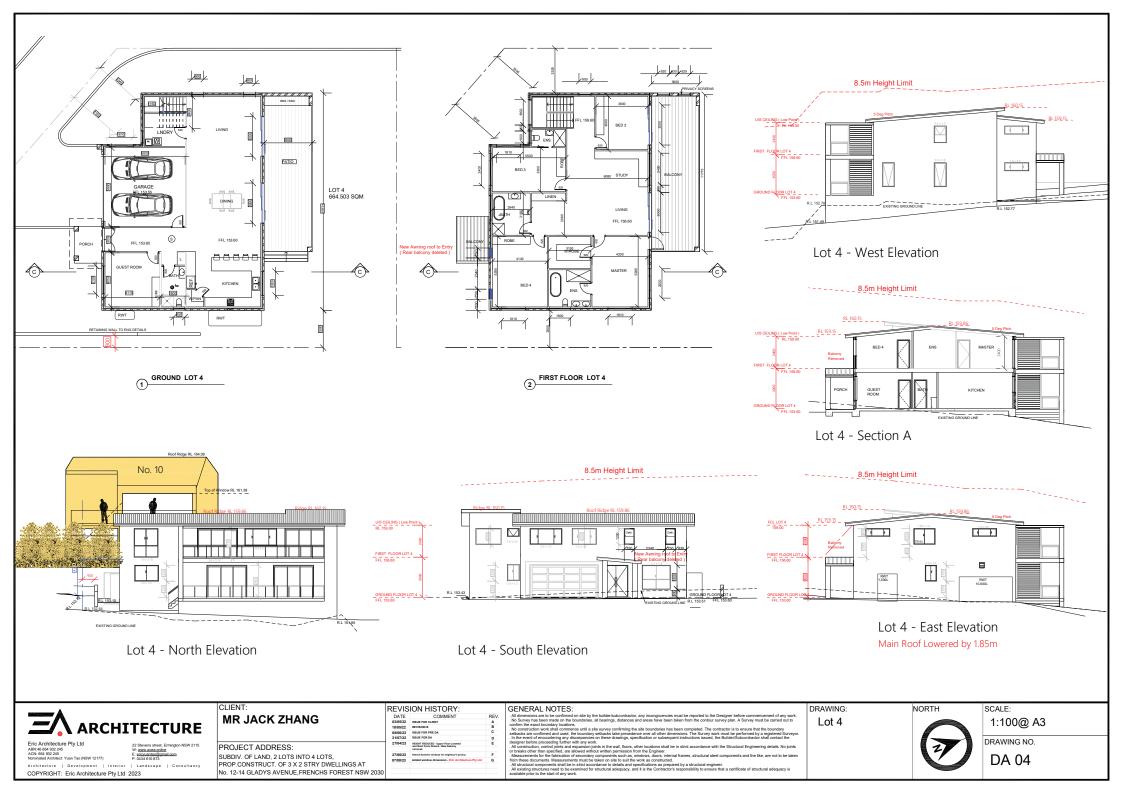


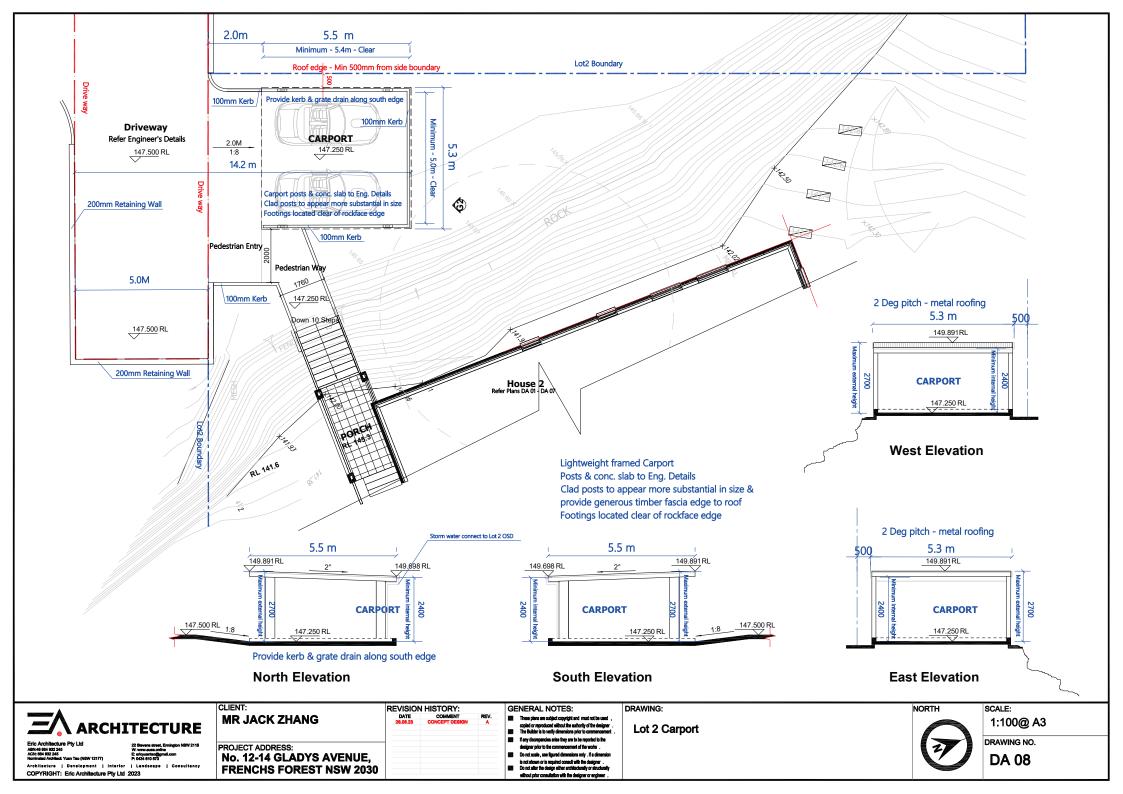

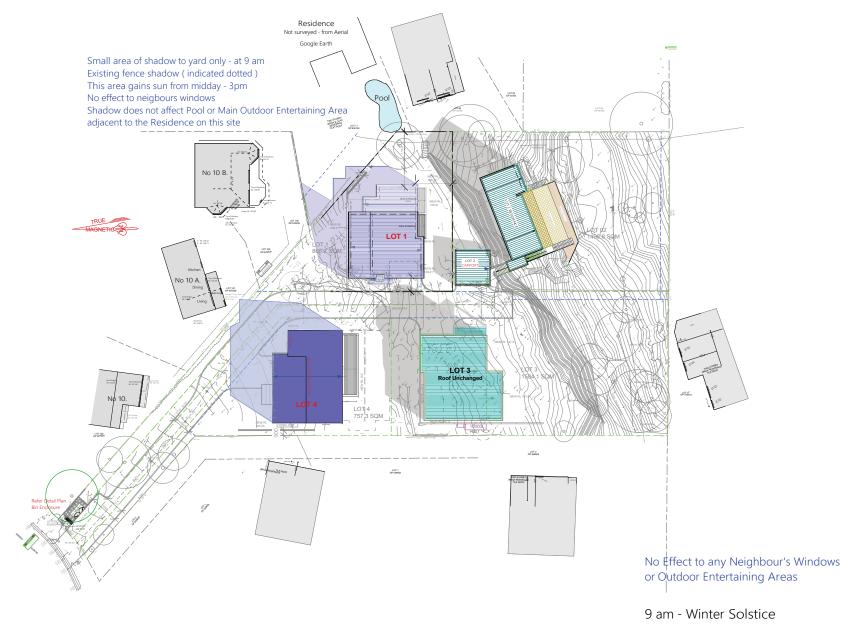


Shadow Diagram

	- Indonesia	- data	1		amendment	project
GENERAL NOTES	CO APPR	- 440				project
. All dimensions are to be confirmed on site by the builden's boontractor, any incongruencies must be reported to the Designer before commencement of any work.					ISSUE FOR CLIENT	SUBDIV. OF LAND, 2 LOTS INTO 4 LOTS, DIANA Prowse Reg. 5740 964 Tabife Hajiman, Roseville
. No Survey has been made on the boundaries, all bearings, distances and areas have been taken from the contour survey plan. A Survey must be carried out to	RK	18/05/2	2 1	8	REVISION B	
confirm the exact boundary locations. No construction work shall commence until a site survey confirming the site boundaries has been completed. The contractor is to ensure that the boundary	RK	08/05/2	2 0	С	ISSUE FOR PRE DA	
setbacks are confirmed and used, the boundary setbacks take precedence over all other dimensions. The Survey work must be performed by a registered Surveyo		21/07/2		D	ISSUE FOR DA	
. In the event of encountering any discrepancies on these drawings, specification or subsequent instructions issued, the Builder/Subcontractor shall contact the designer before properties further with any work.	DP	27/04/2	3 8	2	Lot 1 & 4 - HEIGHT REDUCED -	A rchitectural Solutions Mob 0414 931 018
All construction, control joints and expansion joints in the wall, floors, other locations shall be in strict accordance with the Structural Engineering details. No joints					- By Di-Signed Architectural Solutions Pty Ltd	
or breaks other than specified, are allowed without written permission from the Engineer. Measurements for the fabrication of secondary components such as, windows, doors, internal formes, structural steel components and the like, are not to be taken						client true north drawing
 Measurements for the speciation of secondary components such as, wholever, doors, internal traines, structure sizes components and the see, are not to be taken from these documents. Measurements must be taken on size in a suit the sent as constituted. 	DP	27/06/3	12 1	F	Lot 1 - First Floor Area Reduced & Building moved	JACK ZHANG LOT 4
. All structural components shall be in strict accordance to details and specifications as prepared by a structural engineer.			\neg	П	Eastward - View retention for 105	
. All existing structures need to be examined for structural adequacy, and it is the Contractor's responsibility to ensure that a certificate of structural adequacy is available prior to the start of any work.				\neg	- By Di-Signed Architectural Solutions Pty Ltd	project no I date sheet no. looke (§ A1 issue looke (§ A3 issue lo
available process and all years.				\Box		22-46 24/06/23 1 1:100 F 1:200

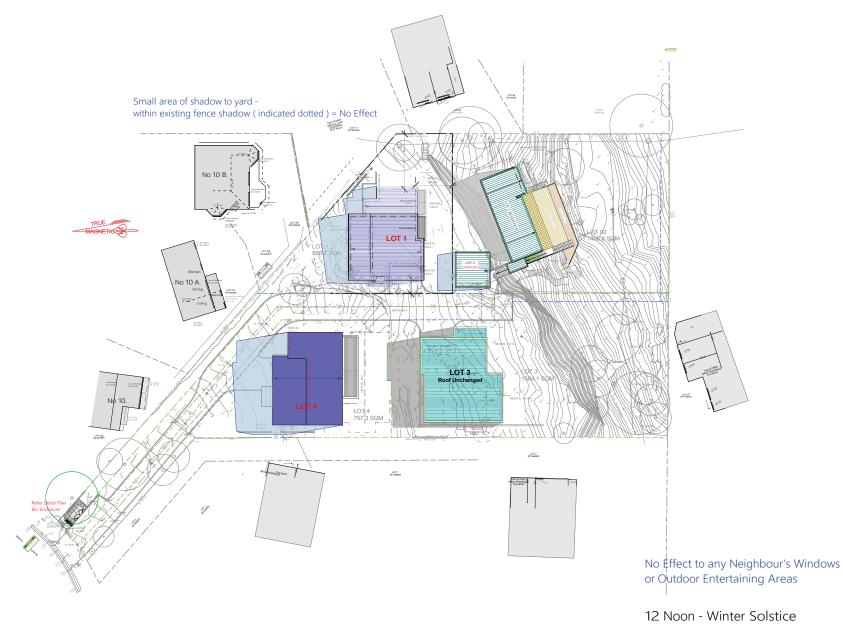

12 Noon - Winter Solstice Shadow Diagram

GENERAL NOTES	drawn	clate	inn	amendment	project		_1	
. All dimensions are to be confirmed on site by the builden'subcontractor, any incongruencies must be reported to the Designer before commencement of any work.				ISSUE FOR CLIENT	SUBDIV. OF LAND, 2 LOTS INTO 4 LOTS.	ш	liana Prowse Reg. 5740	96A Tacific Highway Roseville
No Survey has been made on the boundaries, all bearings, distances and areas have been taken from the contour survey plan. A Survey must be carried out to	RK	18/05/22	2 8	REVISION B		- 15		PO Box 408 Roseville, NSW 2069
confirm the exact boundary locations. No construction work shall commence until a site survey confirming the site boundaries has been completed. The contractor is to ensure that the boundary		08/05/22		ISSUE FOR PRE DA	PROP.CONSTRUCT. OF 3 X 2 STRY DWELLINGS AT		. Di-Sianed	Email - diana@archsolutions.net.au
setbacks are confirmed and used, the boundary setbacks take precidence over all other dimensions. The Survey work must be performed by a registered Surveyor.		21/07/22		ISSUE FOR DA	12-14 GLADYS AVENUE, FRENCHS FOREST, NSW, 2081	56 7	rchitectural Solutions	
. In the event of encountering any discrepancies on these drawings, specification or subsequent instructions issued, the Builder-Subcontractor shall contact the designer before proceeding further with any work.	DP	27/04/23	3 6	Lot 1 & 4 - HEIGHT REDUCED -	1		renitectural Solutions	Mob 0414 931 018
All construction, control joints and expansion joints in the wall, floors, other locations shall be in strict accordance with the Structural Engineering details. No joints				- By Dt-Signed Architectural Solutions Pty Ltd				
or breaks other than specified, are allowed without written permission from the Engineer. Measurements for the fabrication of secondary components such as, windows, doors, internal farmes, structural steel components and the like, are not to be taken					client true nor	with Irlan	wing.	
 Measurements for the resolution of secondary components such as, windows, coorse, mental trainers, structure sizes components and the sixe, are not to be taken from these documents. Measurements must be taken on all it is used the specific air constructed. 	DP	27/06/2	3 F	Lot 1 - First Floor Area Reduced & Building move		LO		
All structural components shall be in strict accordance to details and specifications as prepared by a structural engineer.			\neg	Eastward - View retention for 100	JACK ZITANG	1		
All existing structures need to be examined for structural adequacy, and it is the Contractor's responsibility to ensure that a certificate of structural adequacy is available prior to the start of any work.			\top	- By Di-Signed Architectural Solutions Pty Ltd	1 111.	/ proj	ect no date sheet no. scale @ A1 saue	icale @ A3
available prior to the start of any work.						1 22.	46 24/06/23 1 1:100 F	1:200

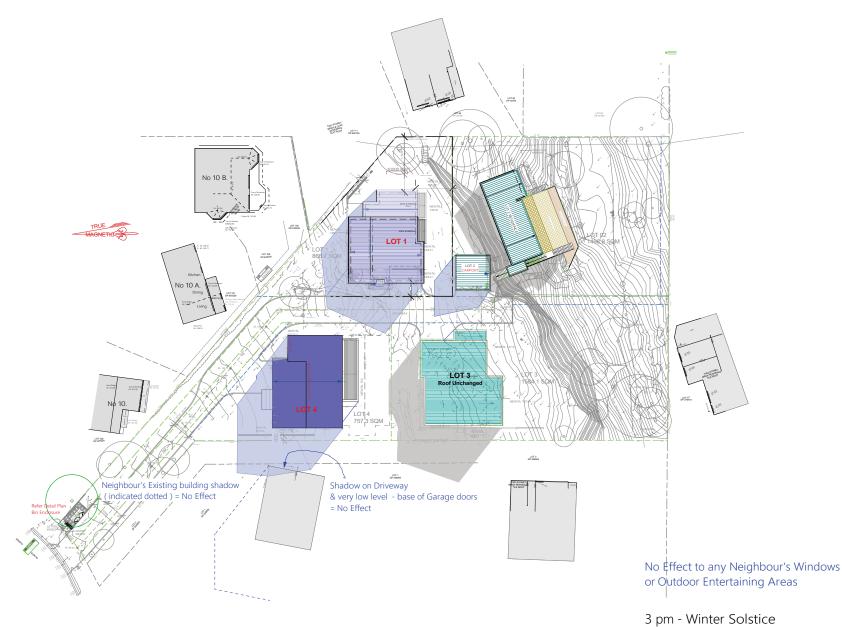

3 pm - Winter Solstice Shadow Diagram

GENERAL NOTES	drawn	clate	innu	rue	amendment	project		_1	
. All dimensions are to be confirmed on site by the builden'subcontractor, any incongruencies must be reported to the Designer before commencement of any work.					SUE FOR CLIENT	SUBDIV. OF LAND, 2 LOTS INTO 4 LOTS.	- 16	I iana Prowse Reg. 5740	96A Tacific Highway Roseville
No Survey has been made on the boundaries, all bearings, distances and areas have been taken from the contour survey plan. A Survey must be carried out to	RK	18/05/22	2 5	B REV	EVISION B		15		PO Box 408 Roseville, NSW 2069
confirm the exact boundary locations. No construction works shall commence until a site survey confirming the site boundaries has been completed. The contractor is to ensure that the boundary		08/05/22			SUE FOR PRE DA	PROP.CONSTRUCT. OF 3 X 2 STRY DWELLINGS AT		_ Di-Sianed	Email - diana@archsolutions.net.au
setbacks are confirmed and used, the boundary setbacks take precidence over all other dimensions. The Survey work must be performed by a registered Surveyor.	RK	21/07/22	2 D	0 1550	SUE FOR DA	12-14 GLADYS AVENUE, FRENCHS FOREST, NSW, 208	186 /		
In the event of encountering any discrepancies on these drawings, specification or subsequent instructions issued, the Builder Subcontractor shall contact the designer before proceeding further with any work.	DP	27/04/23	3 E	Lat 1	1 & 4 - HEIGHT REDUCED -		- 1	rchitectural Solutions	Mob 0414 931 018
All construction, control loints and expansion joints in the wall, floors, other locations shall be in strict accordance with the Structural Engineering details. No joints				- By D	y Di-Signed Architectural Solutions Pty Ltd				
or breaks other than specified, are allowed without written permission from the Engineer. Measurements for the fabrication of secondary components such as, windows, doors, internal frames, structural steel components and the like, are not to be taken			\neg			rient true pe	north dna	winn	
 Measurements for the sponsion of secondary components such as, windows, doors, mental trainers, structure sizes components and the axe, are not to be taken from these documents. Measurements must be taken on size to an observation and on the secondary training. 	DP	27/06/2	13 F	F Lot 1	1 - First Floor Area Reduced & Building moved		/ LC		
All structural components shall be in strict accordance to details and specifications as prepared by a structural engineer.			\neg	East	stward - View retention for 100				
. All existing structures need to be examined for structural adequacy, and it is the Contractor's responsibility to ensure that a certificate of structural adequacy is			\neg	- Dy 0	y Di-Signed Architectural Solutions Pty Ltd	I IH	// pro	ect no date sheet no. scale @ A1 issue 46 24/05/23 1 1:100 F	
available prior to the start of any work.	-		-				V 22	-46 24/06/23 1 1:100 F	1:200
	•	_							



admin@rkdesigns.com.au www.rkdesigns.com.au

1/08/2022

PROPOSED EXTERNAL MATERIAL AND COLOUR FINISHES SCHEDULE FOR THE CONSTRUCTION OF 2 STOREY DWELLING AT LOT 1, 12-14 GLADYS AVENUE, FRENCHS FOREST, NSW, 2086

EXTERNAL WALLS

Finish

Paint Finish

Colour Manufacturer Puppy Dulux

ROOF

Type

Manufacturer Tiles Monier concrete **Pitched Roof**

Caraway

Colour

Finish

Colour **Paint Finish**

GUTTERS, DOWNPIPES AND FASCIA

Finish Colour Dark Metal

Dulux

ALUMINIUM FRAME WINDOWS & SLIDING DOOR

Paint Finish

Colour Paint manufacturer **Dark Metal** Dulux

POST AND RAILING

Finish **Paint Finish**

Manufacturer Dulux

Dark Metal

Colour



admin@rkdesigns.com.au www.rkdesigns.com.au

1/08/2022

PROPOSED EXTERNAL MATERIAL AND COLOUR FINISHES SCHEDULE FOR THE CONSTRUCTION OF 2 STOREY DWELLING AT LOT 3, 12-14 GLADYS AVENUE, FRENCHS FOREST, NSW, 2086

- 1	
- 1)
-	
-	_
-	mi
-	
-	\mathbf{z}
-	~
-	Z
-	1
-	~
-	
-	•
-	V
-	~
-	-
-	~
-	
-	_
-	L.
-	S
-	

Finish

Paint Finish

Colour Manufacturer Dulux **Charter Grey**

ROOF

Type Colour Manufacturer Bablyon Colorbond Flat roof

Finish Metal

GUTTERS, DOWNPIPES AND FASCIA

Finish Colour **Paint Finish** Dulux

Colour Dark Metal

ALUMINIUM FRAME WINDOWS & SLIDING DOOR

Paint Finish

Paint manufacturer Dulux

Colour **Dark Metal**

Finish POST AND RAILING

Manufacturer **Paint Finish**

Dulux

Dark Metal

Colour









1/08/2022



PROPOSED EXTERNAL MATERIAL AND COLOUR FINISHES SCHEDULE FOR THE CONSTRUCTION OF 2 STOREY DWELLING AT LOT 4, 12-14 GLADYS AVENUE, FRENCHS FOREST, NSW, 2086

EXTERNAL WALLS

Finish
Manufacturer
Dulux
Colour
Subdue

ROOF

Type Pitched Roof

Manufacturer Tiles

Colour Monier concrete

Finish Bablyon



GUTTERS, DOWNPIPES AND FASCIA

Colour Paint Finish
Finish Dulux
Colour Dark Metal



ALUMINIUM FRAME WINDOWS & SLIDING DOOR

Finish
Paint Finish
Paint manufacturer
Dulux
Colour
Dark Metal




POST AND RAILING


Finish Paint Finish Manufacturer Dulux


Colour


Dark Metal




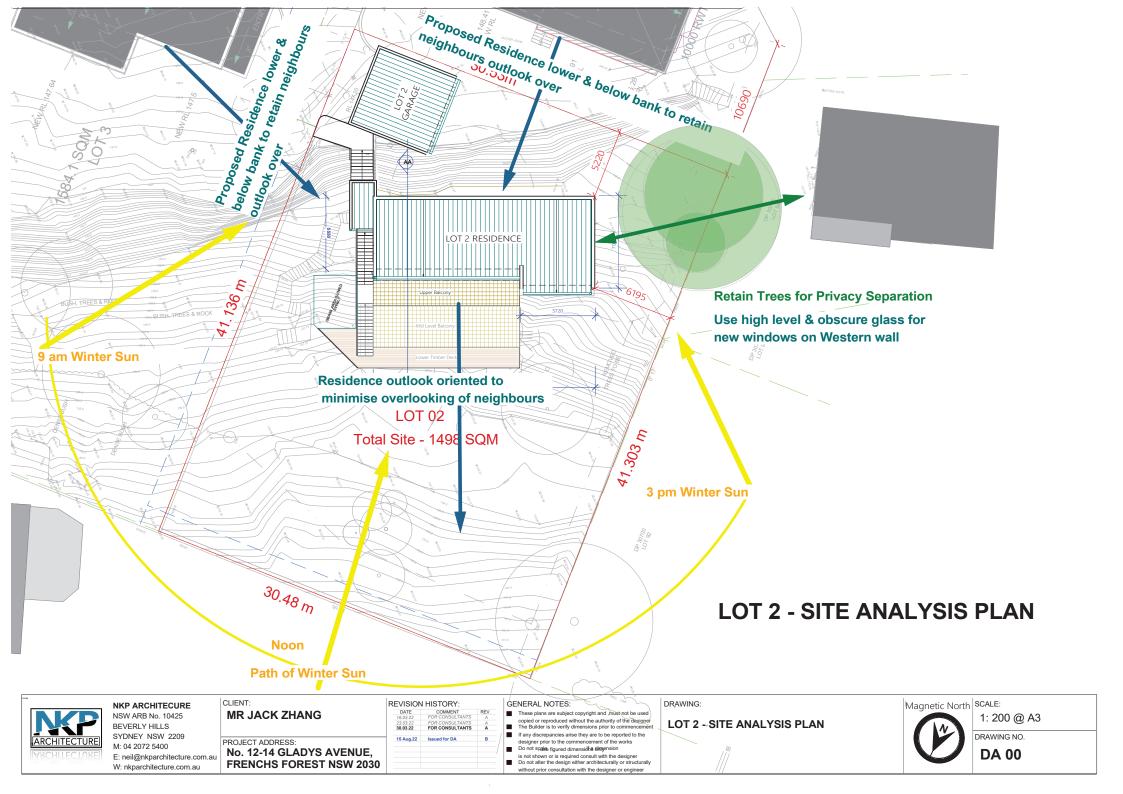


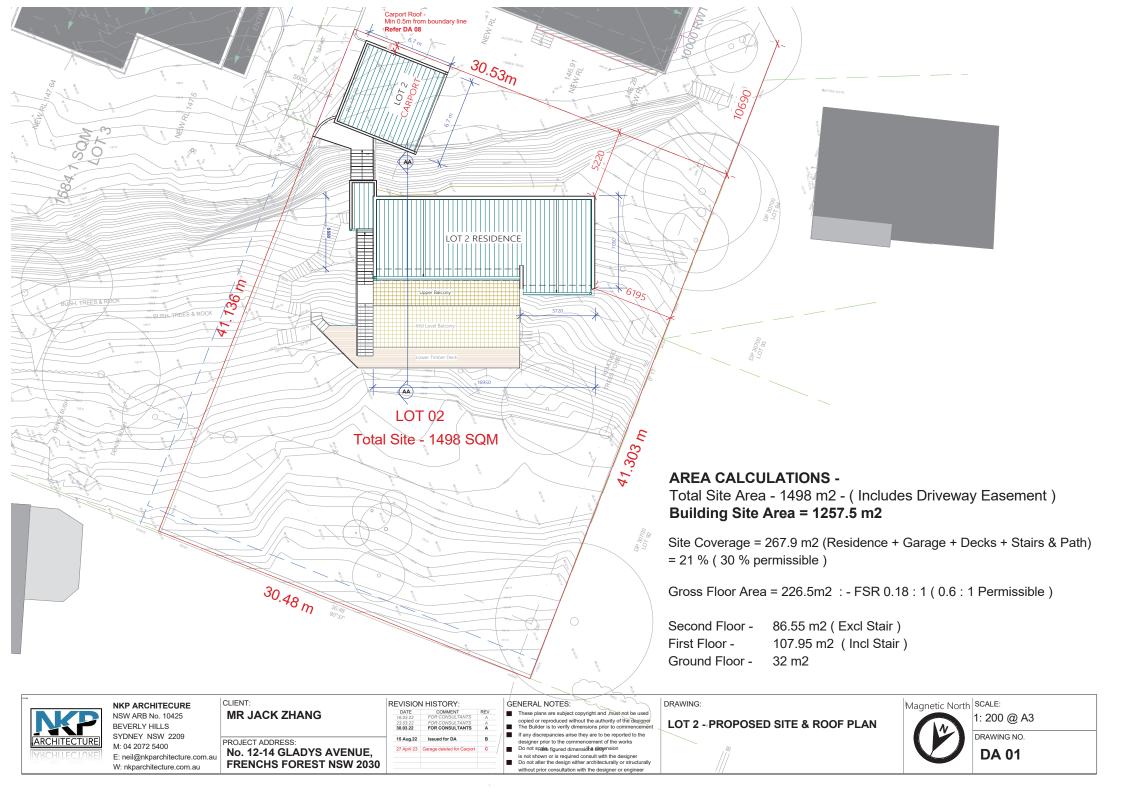

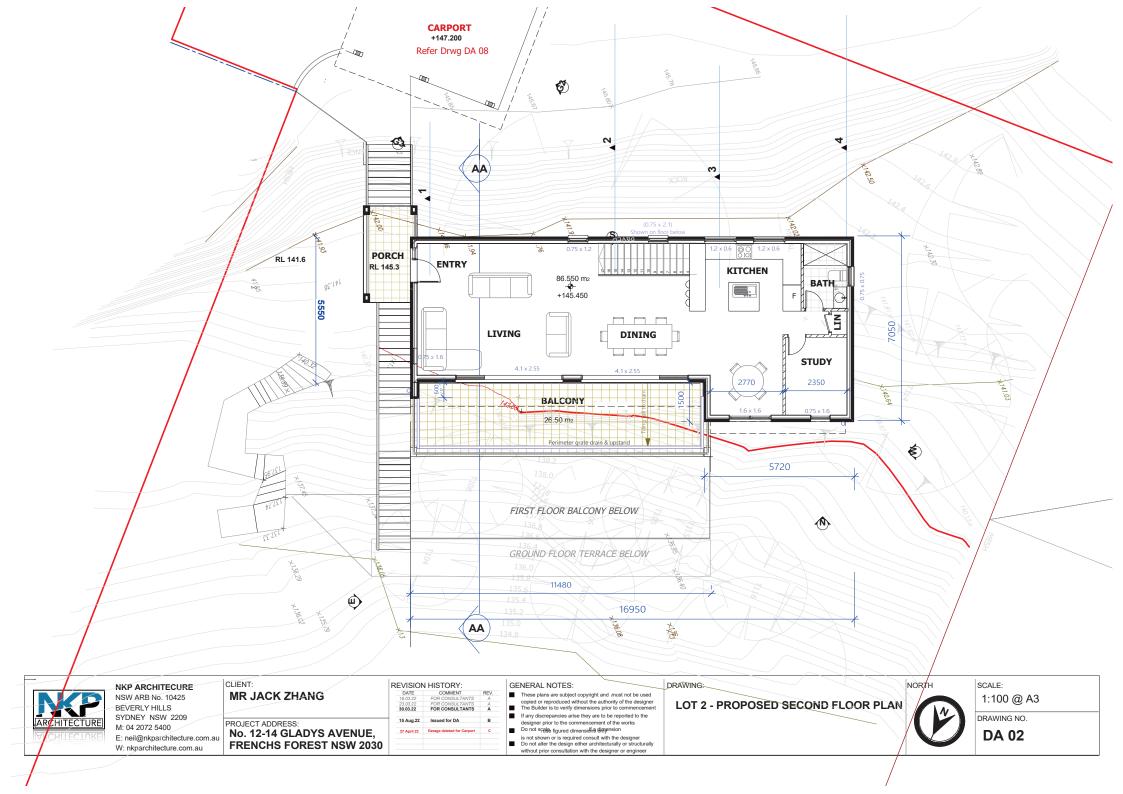

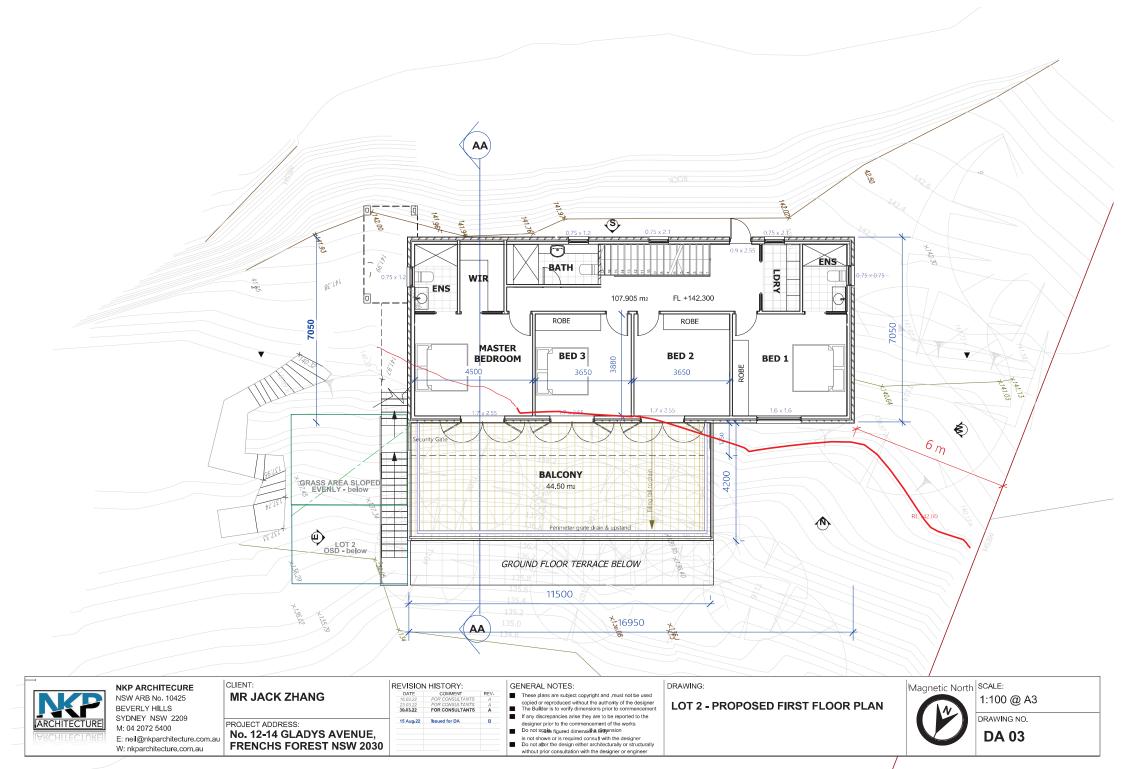

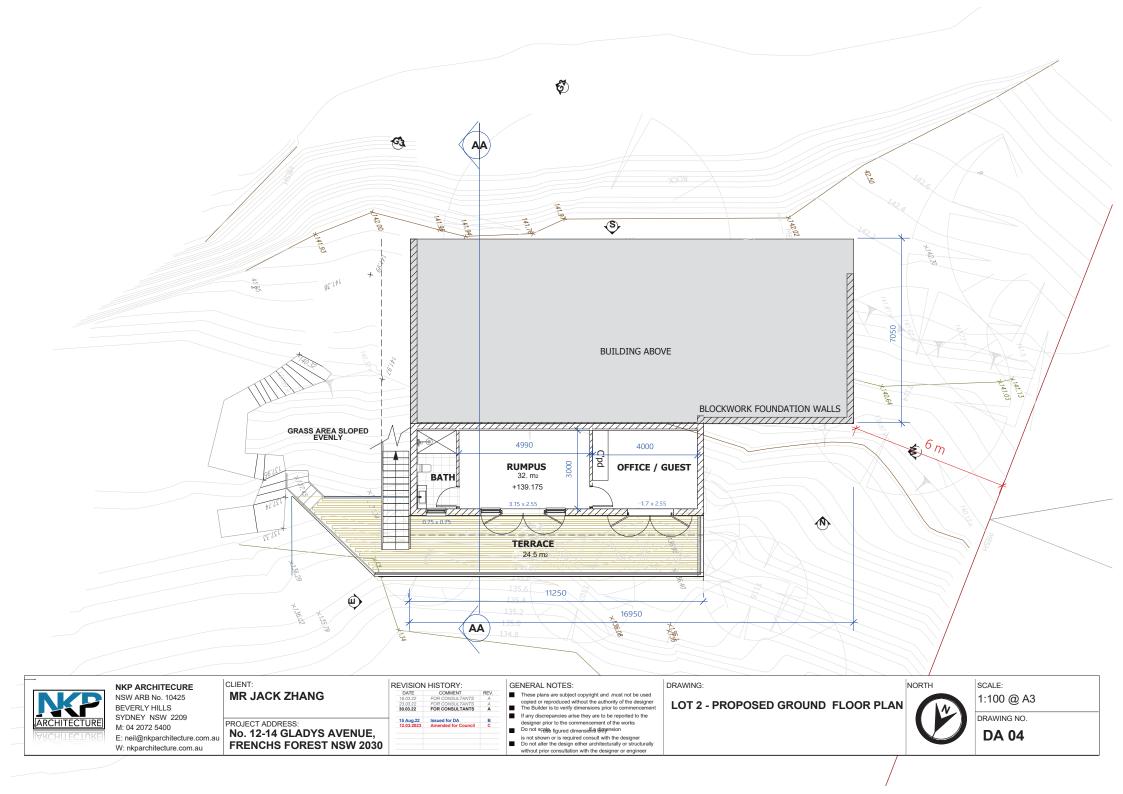

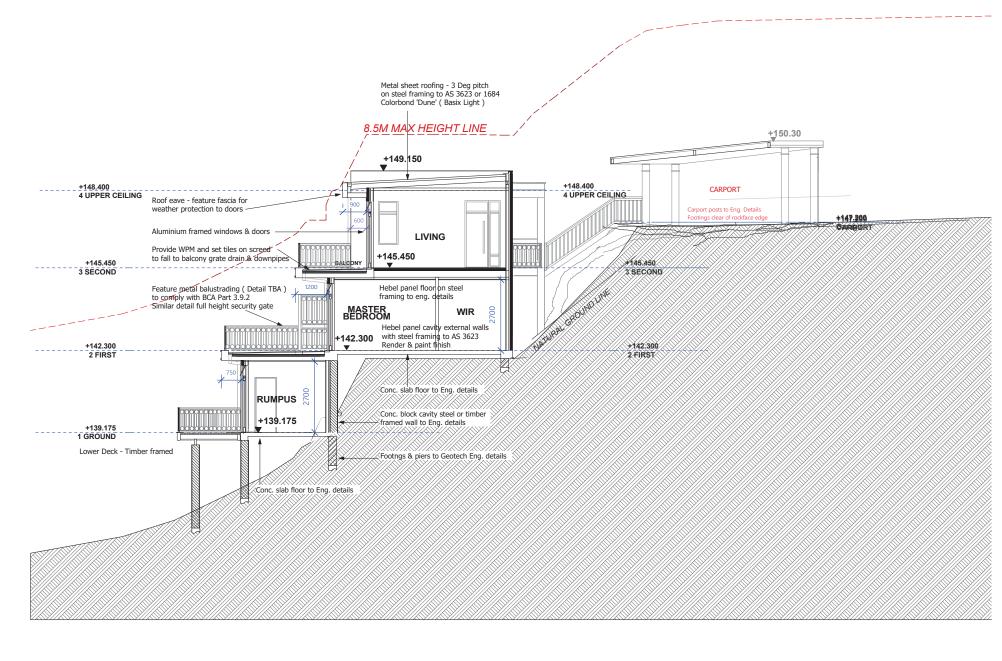



NKP ARCHITECURE NSW ARB No. 10425 BEVERLY HILLS SYDNEY NSW 2209 M: 04 2072 5400

E: neil@nkparchitecture.com.au W: nkparchitecture.com.au



| REVISION HISTORY: | COMMENT | REV. | FG 022 | FOR CONSULTAVITS | A | 20.0025 | FOR CONSULTAVITS |

GENERAL NOTES: These plans are subject copyright and .must not be used copied or reproduced without the authority of the designer The Builder is to verify dimensions prior to commencement If any discrepancies arise they are to be recorded to the

If any discrepancies arise they are to be reported to the designer prior to the commencement of the works

Do not scale figured dimensions dispension

is not shown or is required consult with the designer

Do not alter the design either architecturally or structurally without prior consultation with the designer or engineer


DRAWING:


LOT 2 - PROPOSED SECTION A-A

SCALE: 1:100 @ A3

DRAWING NO.

DA 05

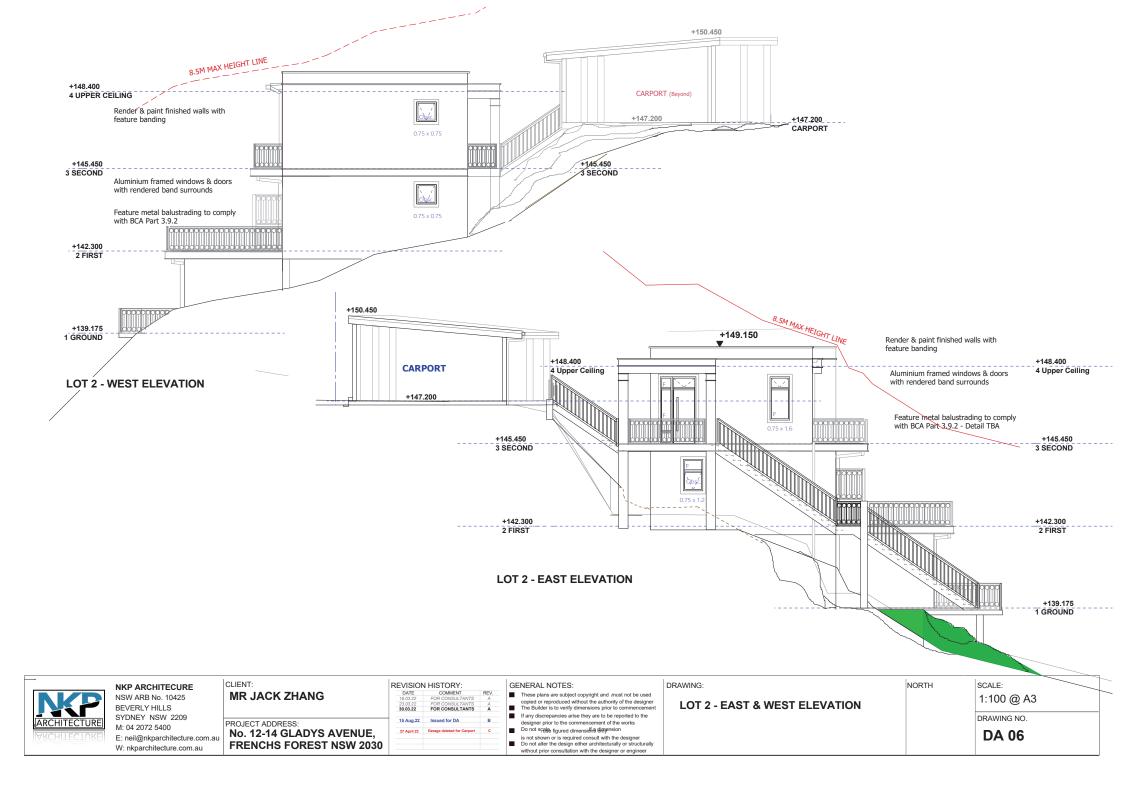

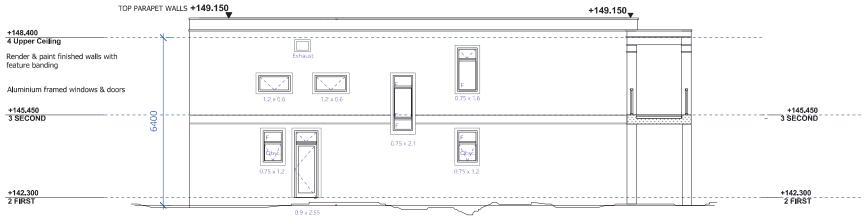

LOT 2 - SOUTH ELEVATION





NSW ARB No. 10425 BEVERLY HILLS SYDNEY NSW 2209 M: 04 2072 5400 E: neil@nkparchitecture.com.au W: nkparchitecture.com.au

REVISION HISTORY: **MR JACK ZHANG** 30.03.22 FOR CONSULTANTS 15 Aug. 22 PROJECT ADDRESS: Issued for DA No. 12-14 GLADYS AVENUE, **FRENCHS FOREST NSW 2030**

These plans are subject copyright and ,must not be used

copied or reproduced without the authority of the designer. The Builder is to verify dimensions prior to commencement If any discrepancies arise they are to be reported to the

designer prior to the commencement of the works Do not scale figured dimensioned dimension


is not shown or is required consult with the designer Do not after the design either architecturally or structurally without prior consultation with the designer or engineer

LOT 2 - NORTH & SOUTH ELEVATION

SCALE: 1:100 @ A3

DRAWING NO.

DA 07

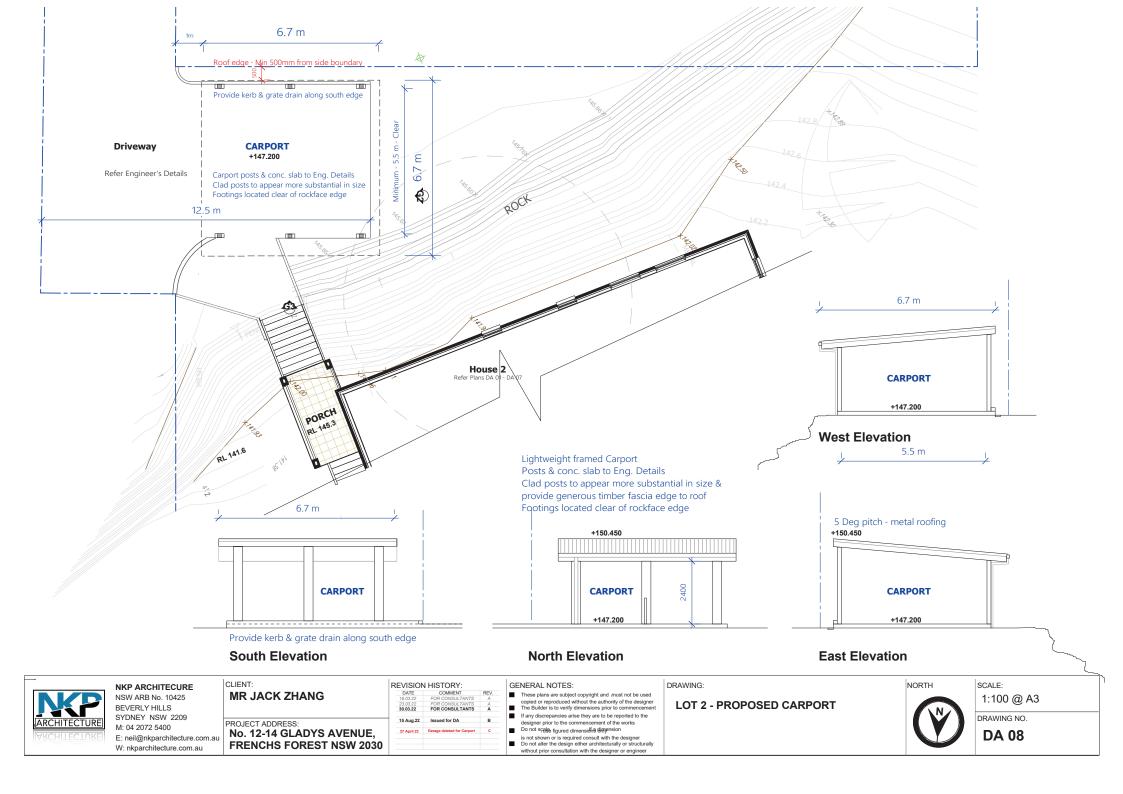

LOT 2 - PROPOSED FINISHES - DARK EARTH COLOURS





NKP ARCHITECURE NSW ARB No. 10425 BEVERLY HILLS SYDNEY NSW 2209 M: 04 2072 5400

E: neil@nkparchitecture.com.au W: nkparchitecture.com.au

CLIENT:

REVISION HISTORY: **MR JACK ZHANG** PROJECT ADDRESS: No. 12-14 GLADYS AVENUE, **FRENCHS FOREST NSW 2030**

GENERAL NOTES:

- These plans are subject copyright and must not be used copied or reproduced without the authority of the designer. The Builder is to verify dimensions prior to commencement.
- If any discrepancies arise they are to be reported to the designer prior to the commencement of the works
- Do not scale figured dimensions dimension
- is not shown or is required consult with the designer Do not alter the design either architecturally or structurally without prior consultation with the designer or engineer


DRAWING:


LOT 2 - PROPOSED COLOURS & FINISHES


SCALE: 1:100 @ A3


DRAWING NO.

Colours & Finishes Schedule

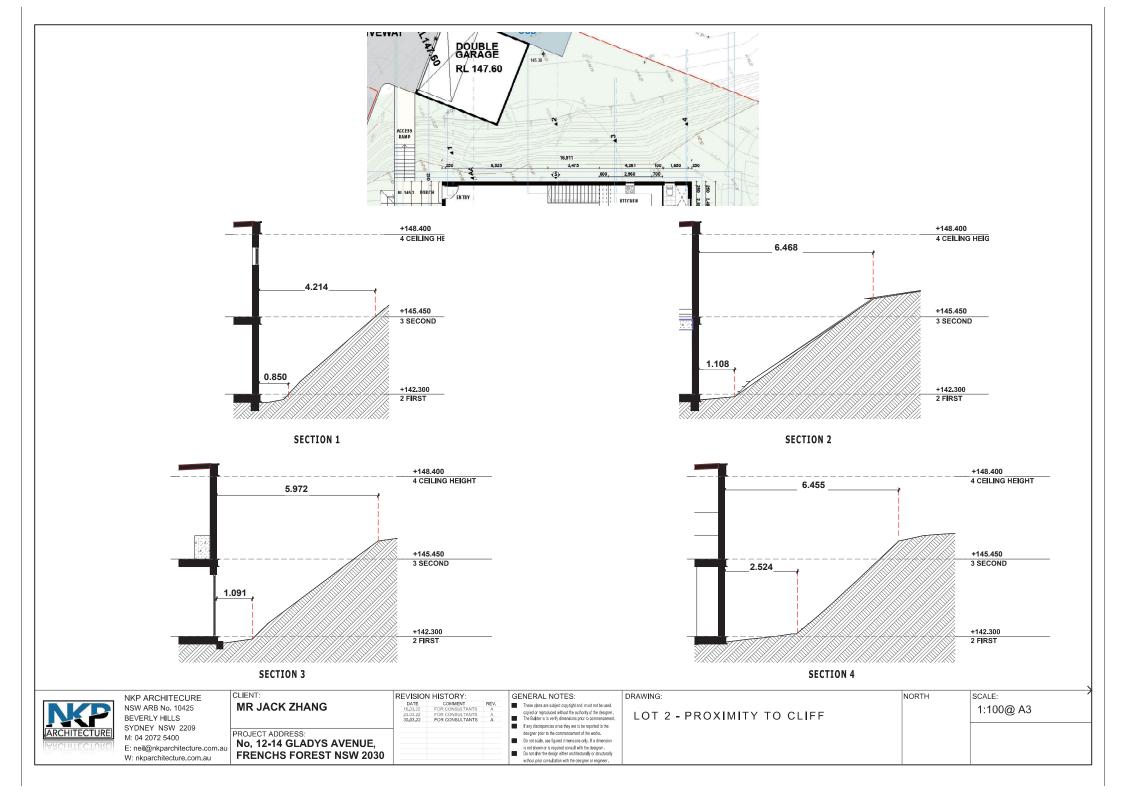


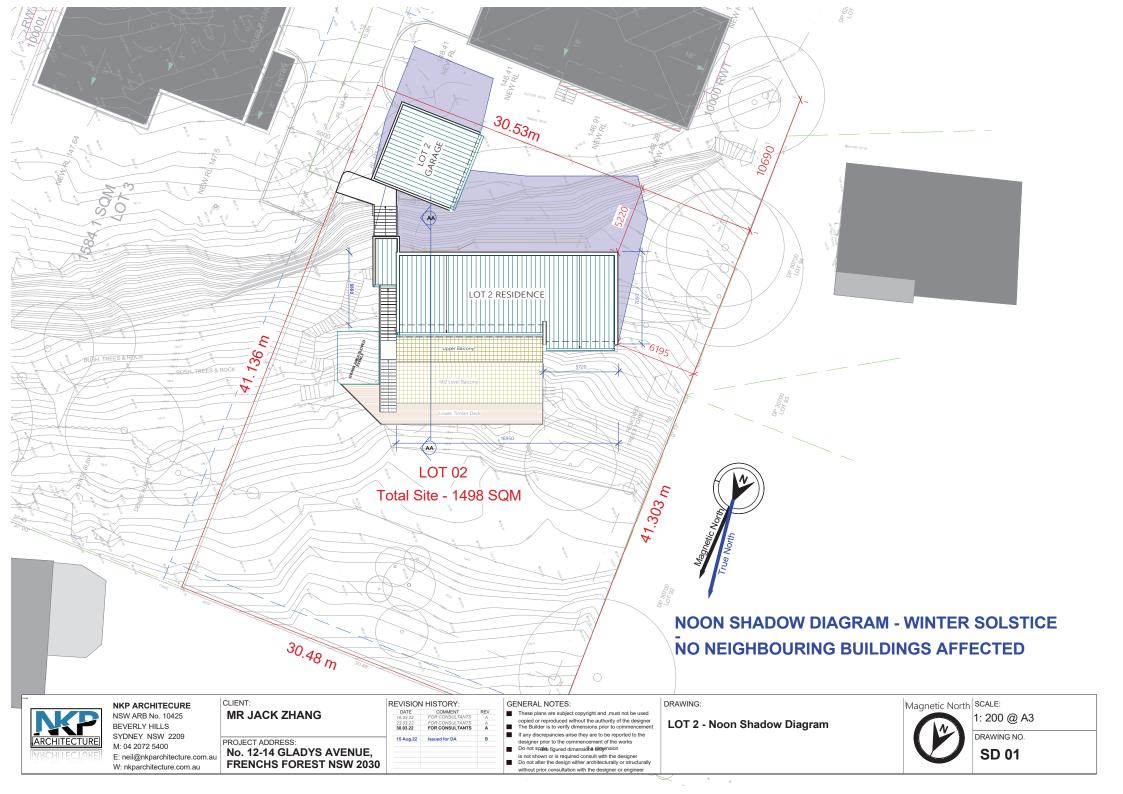

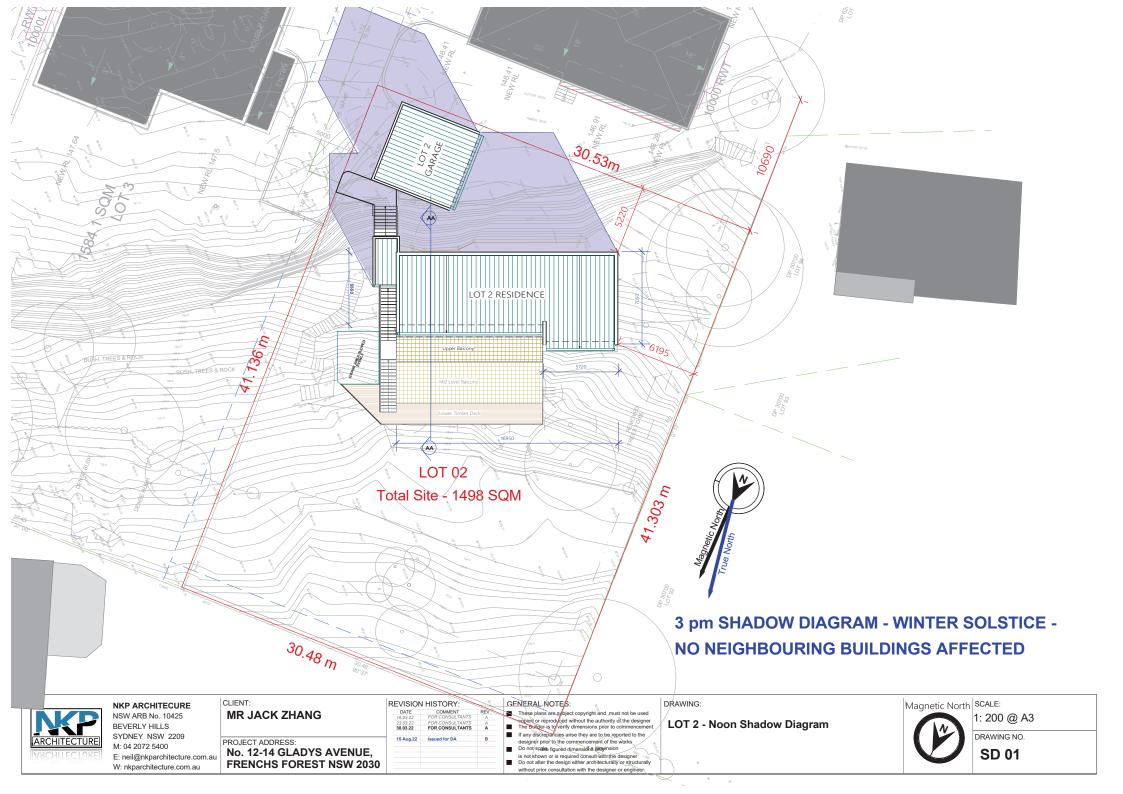


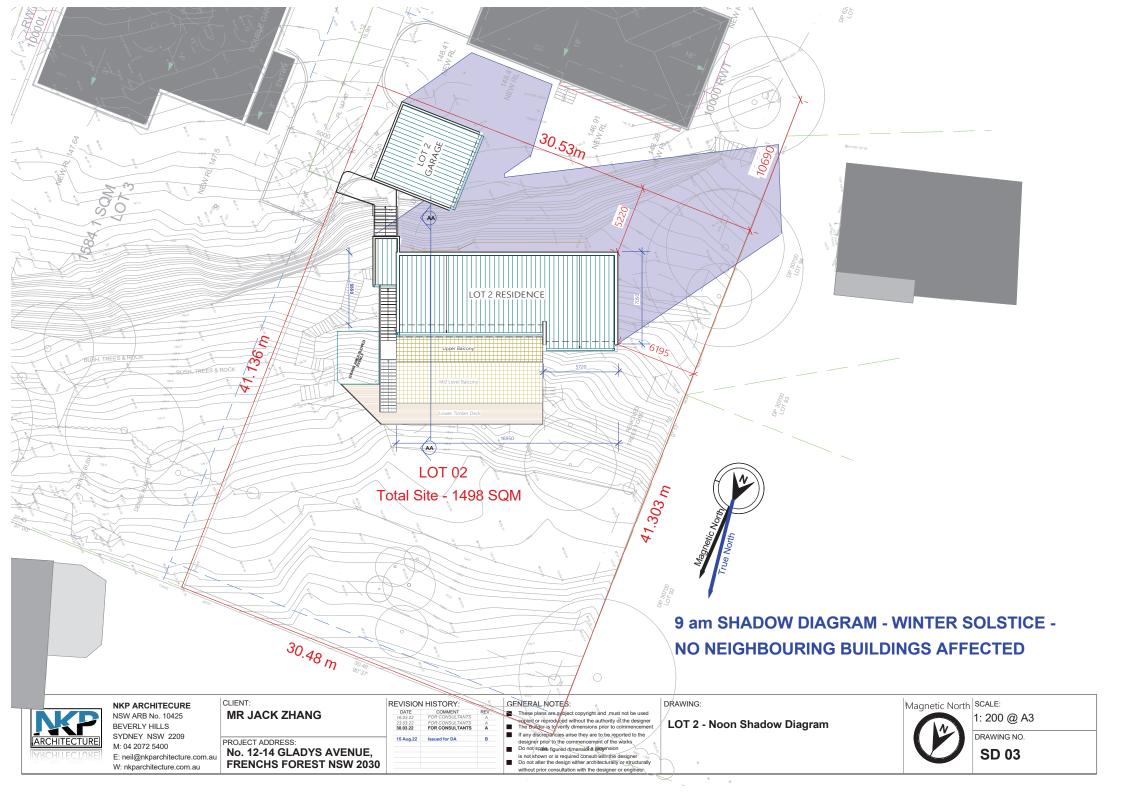




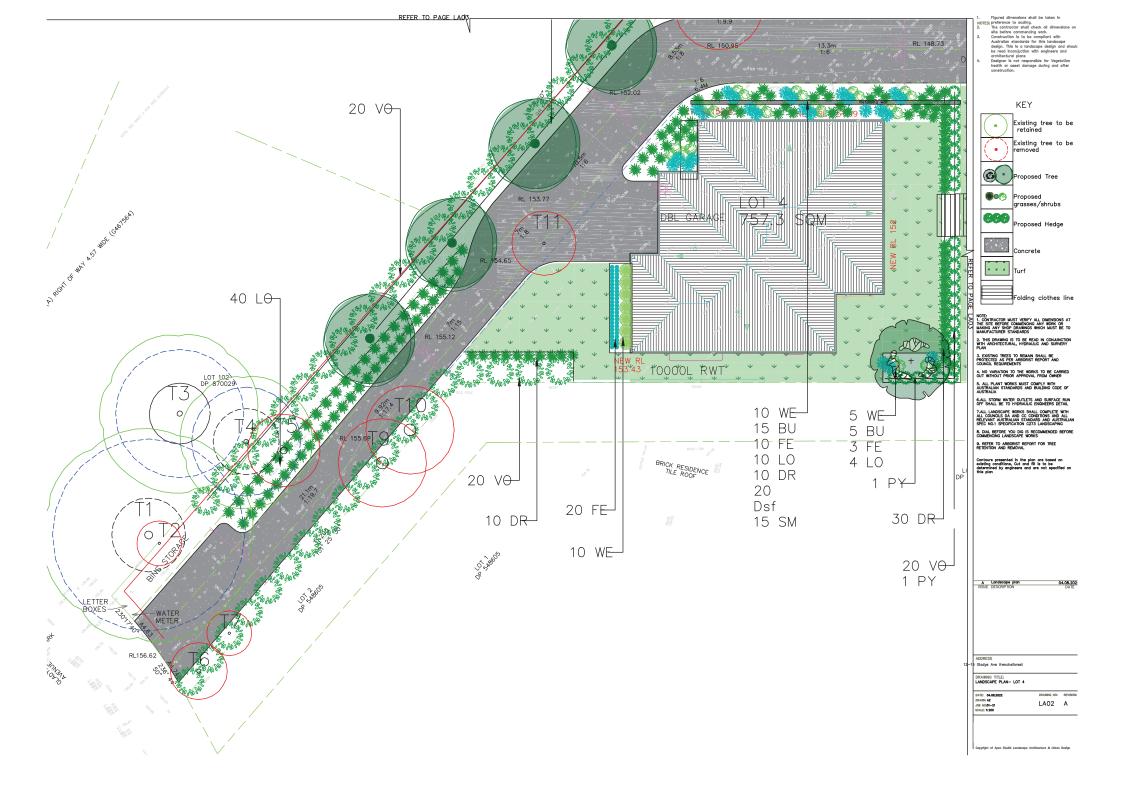



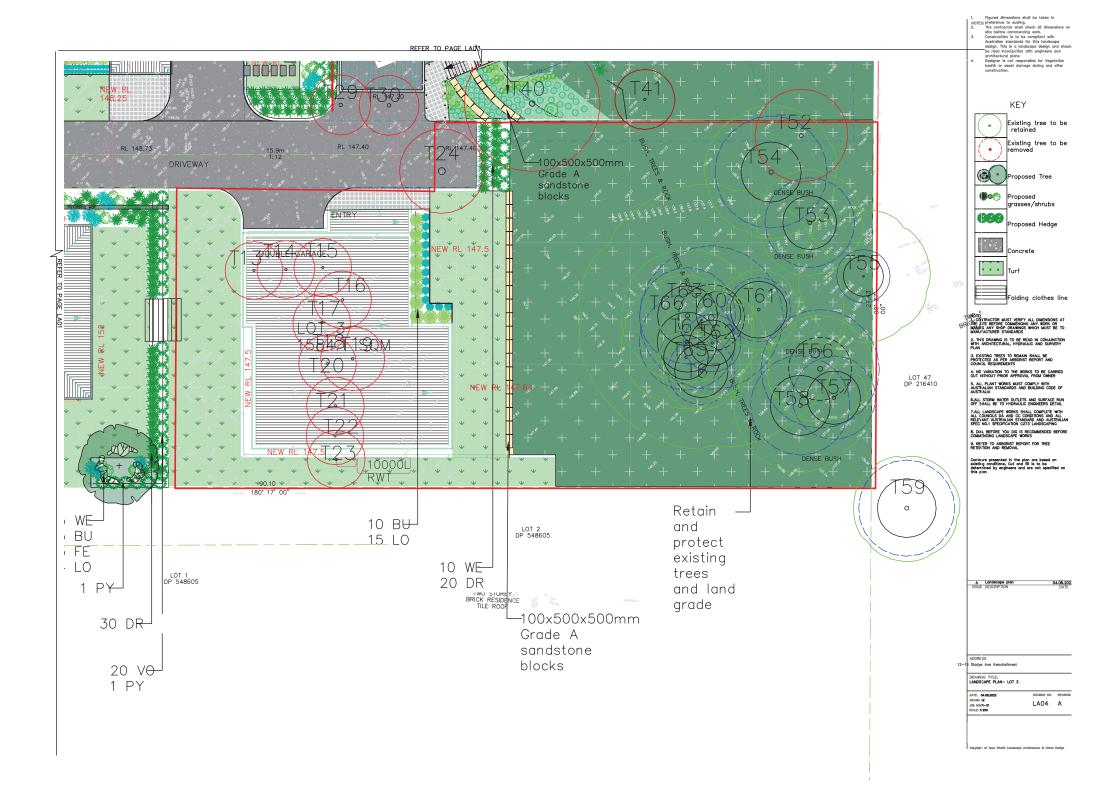

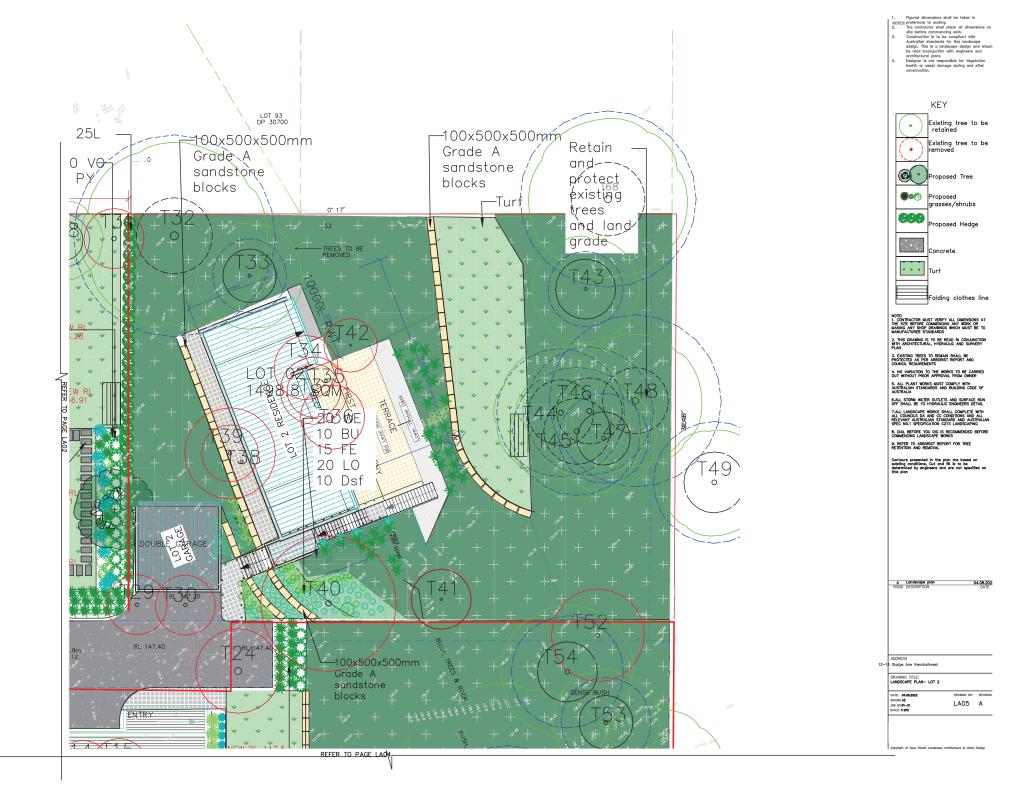

ALL BARTHMORK, DRIANAGE WORKS, RETAINNO WALLS, CONCRETE WORKS AND GRACING TO BE CONSTRUCTED IN ACCORDANCE WITH THE ENGINEERING PLANS, DETAILS AND SPECIFICATION REFER TO DISMOERING GRAWINGS FOR ALL PRISHED LIKELS.

ALL SET OUT TO BE ARPWORD ON SITE BY EMPRISHINGDOST FOR TO THE COMMENCEMENT OF GROUND WORKS.

VEGETATION TO BE REMOVED. REMOVED THE SEAD VEGETATION MARKED FOR REMOVAL ALL TREES AND NATIVE VEGETATION REQUIRED TO BE REMOVED AS PART OF THESE WORKS ARE TO BE MULCHED ON SITE AND AND STOCKPUED FOR REUSE IN PLANTING AREAS.

VEGETATION TO BE RETAINED:

WHERE TREES ARE MARKED FOR RETENTION THE FOLLOWING PROTECTION MEASURES ARE TO BE UNDERTAKEN;

WEED ERADICATION

NO CONTAINANTED SOIL IS TO BE USED ON SITE SHOULD SOIL SECOME CONTAINANTED BY ORSEL OIL, PHINT, CEILIST OR MY OTHER CONTAINANTS, EXCHAITE THE CONTAINANTED SOIL AND DISPOSE OF IT OFF SITE AND REPLACE IT WITH SOIL MIXTO PRINCED THE PREVAILED SITE SOIL AND OWNER EMBALY, ALLOWING THE FOLLOWING TO COCUR.

PLACE SOIL IN MAXIMUM LAYER DEPTHS OF 15MM LIGHTLY COMPACT AT EACH LAYER.
PLACE 2000 INSEPTIOR 50 DLM IN ALL LITIONAL, TERRESTRIPAL, RE-VEGETATION AND NATIVE GARDEN MIX PLAYTING ZONES.
PLACE 10000 INSEPTIOR 50 DLM IN ALL ALL ARRAST DE STURRED.
ON COMPLETION OF SOIL PLACEMENT THE SURFACE SHALL BE:

- FREE FROM STONES AND LUMPS OF SOIL,
 GRADED TO DRAIN FREELY WITHOUT TRAPPED LG
 GRADED EVENLY TO ALL SURROUNDING FINISHED
 READY FOR PLANT INSTALLATION.

INSTALL 100mm DEPTH OF 100% RECYCLED LEAF MULCH FREE OF DELETERIOUS AND EXTRANEOUS MATTER SUCH AS SOIL, WEEDS AND STICKS TO ALL PLANTING ZONES EXCLUDING BIO-RETENTION MIX A AND B. PLACE MULCH TO THE REQUIRED DEPTH. CLEAR OF OF PLANT STEMS AND PAKE TO AN EVEN SURFACE PLUSH WITH EXISTING FINISHED LEVELS.

DELIVER PLANT MATERIAL TO SITE ON A DAY TO DAY FASIS, AND PLANT MIMEDIATELY AFTER DELIVERY PROTECT FLANTS AT ALL TIMES FROM SUN OF DRIVING WINDS PLANTS THAT CAN NOT SE PLANTED IMMEDIATELY ON DELIVERY SHALL SE KEPT IN THE SHADE, WELL PROTECTED AND DESCRIPACE PLANTS SHALL SE HADDLED IN SUSH AN AMMERT OF AUTOMOTION OF MANINET OF AUTOMOTION OF AUTOMOTION

DO NOT PLANT IN UNSULTIFIELE WEATHER CONDITIONS SUCH AS EXTREME HEAT, COLD, WIND OR RAIN. IN OTHER THAN SANDY SOLES, SUSPEND EXCAVATION WHEN THE SOLL IS WET, OR DURING FROST PERIODS. NOTIFY SUPERINTENDENT OF ALL SOL OR DR

THOROUGHLY WATER THE PLANTS INMEDIATELY AFTER PLANTING, AND AS REQUIRED TO MAINTAIN GROWTH RATES FREE FROM STRESS, LESS FREQUENT HEAVY WATERING IS PREFERABLE TO LIGHT WATERING, THE SOLL MOISTURE NEEDS TO BE ASSESSED DAILY AND

ADJUSTED ACCIONNOW.

ADJUSTED ACCIONNOW.

THE SUPPLY AND INSTALL A TEMPORARY PROGRADIO SYSTEM TO REQUIRE ALL PLANT MATERIAL FOR THE DURATION OF THE MANTENANCE PERSOD. AT COMPLETION OF THE MANTENANCE PERSOD. THE CONTRACTOR IS RESPONSIBLE FOR THE OF THE EMPERSORY PROGRADIO SYSTEM AND THE REMOVAL OF ALL COMPLETION OF THE DURATION OF THE MANTENANCE PERSOD. THE CONTRACTOR IS RESPONSIBLE FOR THE OFFICE TEMPORARY PROGRADIO SYSTEM AND THE REMOVAL OF ALL COMPLETIONS FOR SITE OF THE DURATION OF THE MANTENANCE PERSON.

PLACING

DEMANTE NOT AN ROCULTO IN PLANTING DETAILS WEIGHINGTHALING PLANT, REVER PLANTING THERE DRIVED BE ARREL LOSE SOLI TO DISURE THAT TOOT SOL CONTACT IS COMPLETE AND THAT TO ARR GAPE DUST. A RAWED UP \$10.00 PRIED.

REVER THAT TO ARREST IN TRAVEL OF ARREST PLANTING THE PRIED.

REVER THAT THE ARREST PLANTING THE ARREST PLANTING THE PRIED.

REVER THAT THE ARREST PLANTING THE ARREST PLANTING THE PRIED.

REVER THAT THE ARREST PLANTING THE PLANTING THE PRIED.

REVER THAT THE ARREST PLANTING THE PLANTING THE PRIED.

REVER THAT THE ARREST PLANTING THE PLANTING THE PRIED.

REVER THAT THE ARREST PLANTING THE PLANTING THE PRIED.

REVER THAT THE ARREST PLANTING THE PLANTING THE PRIED.


REVER THAT THE ARREST PLANTING THE PRIED.


REVER THAT THE

REPLACEMENT

TURFING

- SECTION, INSTERN. OF PRIVATING OF PERSONS AS TO ADDRESS CONTROL, THEN DO NOT NOT, ENVIRON OF THE THREE ARREST AND CONSECTION OF THE THREE ARREST AND CONTROL TO THE ADDRESS CONTROL THE ADDRESS CONTROL TO THE

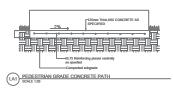


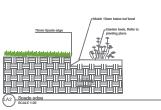


Plant Schedule


Symbol	Botanical Name	Common Name	Height at Maturity	Size	Qty
Trees					
PY	Pyrus calleryana	Callery pear	12m	45L	2
TL	Tristaniopsis laurina	Water gum	15m	25L	4
Shrubs					
Dsf	Dichondra argentea	Silver falls	200mm	140mm	30
LO	Lomandra confertifolia ssp rubiginosa	Mat Rush	0.7m	140mm	112
WE	Westringia fruticosa	Native Rosemary	1m	400mm	50
BU	Buxus microphylla	Littleleaf Box	1m	400mm	40
SM	Senecio Mandraliscae	Blue chalk sticks	0.2m	140mm	25
DR	Dianella revoluta	blue flax-lily	0.5m	140mm	80
VO	Viburnum odoratissimum	Sweet Viburnum	2m	400mm	80



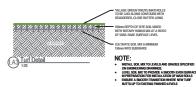

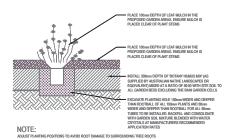

MASS PLANTING - 150mm POTS & 50mm TUBES IN MULCHED GARDEN AREAS

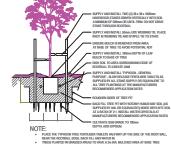

TREE PLANTING- SPADE EDGING

Viburnum odoratiss

Figured dimensions shall be taken in process.

The contractor shall check all dimensions on sil

2-14 Gladys Ave frenchsforesi

PLANT SCHEDULE & DETAILS

RAWN: AZ 30 NO: 01-21

LA06