

ACTION PLANS

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DEVELOPMENT APPLICATION

THESE PLANS ARE FOR DEVELOPMENT APPROVAL ONLY.

ITEM DETAILS	DEVELOPMENT APPLICATION			
ADDRESS	9 STEINTON STREET, MANLY, NSW, 2095			
LOT & DP/SP	LOT 102 DP 586416			
COUNCIL	NORTHERN BEACHES COUNCI	L (MANLY)		
SITE AREA	152.30m²			
FRONTAGE	4.97m			
CONTROLS	PERMISSIBLE / REQUIRED	EXISTING	PROPOSED	COMPLIANCE
CONTROLS	m / m² / %	m / m² / %	m / m² / %	
<u>LEP</u>				
LAND ZONING	R3 – MEDIUM DENSITY RESIDENTIAL	R3	R3	YES
MINIMUM LOT SIZE	250m²	152.30m ²	UNCHANGED	NO
FLOOR SPACE RATIO	0:75 : 1 (114.225m²)	0.53: 1 (80.19m²)	1.01 : 1 (154.42m²)	NO
MAXIMUM BUILDING HEIGHT	11m	6.36m	8.307m	YES
<u>HAZARDS</u>				
ACID SULFATE SOILS	IDENTIFIED - CLASS 4	N/A	N/A	N/A
FLOOD PLANNING	IDENTIFIED - MEDIUM RISK	N/A	N/A	N/A
HERITAGE CONSERVATION	IDENTIFIED	N/A	N/A	N/A
FORESHORE SCENIC PRO. AREA	INEVITEIEI)		N/A	N/A
DCP				
RESIDENTIAL OPEN SPACE	AREA OS2			
TOTAL OPEN SPACE (TOS)	50% (76.15m²)	63.66m² (42%)	UNCHANGED	NO
LANDSCAPE AREA	30% OF TOS (50%) : 22.85m ²	5.63m²	30.07 m ²	YES
OPEN SPACE ABOVE GROUND	MAX. 40% OF TOS (50%) : 30.46m ²	0.0m ²	2.53m ²	YES
PRINCIPAL PRIVATE OPEN SPACE	18m²	37.76m²	UNCHANGED	YES
FRONT SETBACK	PREVALING BULDING LINE: 1.39m	1.39m	UNCHANGED	YES
REAR SETBACK	8.0m	7.8m	UNCHANGED	NO
SIDE SETBACKS	1/3 WALL HEIGHT	E:0m W:0m	E: UNCHANGED W: UNCHANGED	NO NO
CAR PARKING SPACES	Required: 1	1	UNCHANGED	YES

SHEET NUMBER	SHEET NAME	DATE PUBLISHED
DA00	COVER	05-May-20
DA01	NOTATION	05-May-20
DA02	SITE ANALYSIS	05-May-20
DA03	SITE / ROOF / SEDIMENT EROSION / WASTE MANAGEMENT / STORMWATER CONCEPT PLAN	05-May-20
DA04	EXISTING GROUND FLOOR PLAN	05-May-20
DA05	PROPOSED GROUND FLOOR PLAN	05-May-20
DA06	PROPOSED FIRST FLOOR PLAN	05-May-20
DA07	NORTH / EAST ELEVATION	05-May-20
DA08	SOUTH / WEST ELEVATION	05-May-20
DA09	LONG / CROSS SECTION	05-May-20
DA10	AREA CALCULATIONS	05-May-20
DA11	SAMPLE BOARD	05-May-20
DA12	WINTER SOLSTICE 9 AM	05-May-20
DA13	WINTER SOLSTICE 12 PM	05-May-20
DA14	WINTER SOLSTICE 3 PM	05-May-20
DA15	3D WINTER SOLSTICE 9AM - 7 STEINTON STREET SUN SHADOW STUDY	05-May-20
DA16	3D WINTER SOLSTICE 12PM - 7 STEINTON STREET SUN SHADOW STUDY	05-May-20
DA17	3D WINTER SOLSTICE 3PM - 7 STEINTON STREET SUN SHADOW STUDY	05-May-20
DA18	3D WINTER SOLSTICE 9AM - 45 WHISTLER STREET SUN SHADOW STUDY	05-May-20
DA19	3D WINTER SOLSTICE 12PM - 45 WHISTLER STREET SUN SHADOW STUDY	05-May-20
DA20	3D WINTER SOLSTICE 3PM - 45 WHISTLER STREET SUN SHADOW STUDY	05-May-20
DA21	BASIX COMMITMENTS	05-May-20

9 STEINTON STREET, MANLY NSW 2095



NCC & AS COMPLIANCES SPECIFICATIONS

- EARTHWORKS: METHOD OF EXCAVATIONAND FILL - PART 3.1.1 OF NCC - SURFACE SUBSOIL-STORMWATER DRAINAGE - PART 3.1.2 OF NCC

- TERMITE-RISK MANAGEMENT - PART 3.1.3 OF NCC

- FOOTINGS & SLAB - PART 3.2 OF NCC INCLUDING AS2870

- MASONRY CONSTRUCTION - PART 3.3 OF NCC INCLUDING AS3700

- SUB FLOOR VENTILATION - PART 3.4.1 OF NCC

- FRAMING - PART 3.4 OF NCC

- ROOF, WALL-CLADDING, GUTTERS & DOWNPIPES - PART 3.5 OF NCC

- GLAZING - PART 3.6 OF NCC INCLUDING AS1288

- FIRE SEPARATION - PART 3.7.1 OF NCC

- SMOKE ALARMS - PART 3.7.2 OF NCC

- HEATING APPLIANCES - PART 3.7.3 OF NCC

- WET AREAS-PROTECTION OF WALLS & FLOORS - PART 3.8.1 OF NCC - MINIMUM ROOF HEIGHTS - PART 3.8.3 OF NCC

- FACILITIES REQUIRRED & SANITARY DOOR CONSTRUCTION - PART 3.8.3 OF NCC

- LIGHT: NATURAL AND ARTIFICIAL - PART 3.8.4 OF NCC

- VENTILATION & LOCATION OF TOILETS - PART 3.8.5 OF NCC

- SOUND INSULATION - PART 3.8.6 OF NCC

- STAIR CONSTRUCTION INCLUDING DIMENSIONS - PART 3.9.1 OF NCC

- BALUSTRADES & OTHER BARRIERS - PART 3.9.2 OF NCC

- FENCING & OTHER PROVISIONS - REGS & AS1926

- DEMOLITION WORKS - AS2601-1991 THE DEMOLITION OF STRUCTURES.

- ALL WATERPROOF MEMBRANES TO COMPLY WITH WITH AS 3740-2004

- ALL PLUMBING & DRAINAGE WORK TO COMPLY WITH AS 3500

- SITE CLASSIFICATION AS TO AS 2870

- ALL PLASTERBOARD WORK TO COMPLY WITH AS 2588-1998

- ALL STRUCTURAL STEEL WORK TO COMPLY WITH AS 4100 & AS 1554

- ALL CONCRETE WORK TO COMPLY WITH AS 3600

- ALL ROOF SHEETING WORK TO COMPLY WITH AS 1562-1992 - ALL SKYLIGHTS TO COMPLY WITH WITH AS 4285-2007

- ALL CERAMIC TILING TO COMPLY WITH AS 3958.1-2007 & 3958.2-1992

- ALL GLAZING ASSEMBLIES TO COMPLY WITH AS2047 & 1288 - ALL TIMBER RETAINING WALLS ARE TO COMPLY WITH AS 1720.1-2010,


AS 1720.2-2006, AS 1720.4-2006, AS 1170.1-1989 & AS 1170.4-1993

- ALL RETAINING WALLS ARE TO COMPLY WITH 3700 - 2011 & AS 3600 -2001

- ALL CONSTRUCTION TO COMPLY TO AS3959- 1991

NOTES

- APPROVED MEANS BY THE 'RELEVANT LOCAL AUTHORITY' OR COUNCIL
- THE OWNER WILL DIRECTLY PAYTHE FEES ASSOCIATED WITH THE FOLLOWING:
- BUILDING APPROVAL FROM COUNCIL, FOOTPATH AND KERB DEPOSITS WITH THE LOCAL COUNCIL, INSURANCE FEE TO BUILDING SERVICES CORPORATION, LONG SERVICE LEAVE SERVICE LEVY FEE AND APPROVAL FEE BY WATER AND SEWERAGE AUTHORITY. ALL OTHER FEES ARE TO BE PAID BY THE BUILDER. THE AMOUNT OF ANY LOCAL AUTHORITY DEPOSITS WHICH ARE FORFEITED DUE TO DAMAGE OR OTHER CAUSE WILL BE DEDUCTED FROM THE PAYMENTS DUE TO THE BUILDER.
- THE BUILDER IS TO PROVIDE AT HIS/HER OWN EXPENSE ADEQUATE PUBLIC RISK INSURANCE AND ARRANGE INDEMNIFICATION UNDER THE WORKERS COMPENSATION ACT. WORKS INSURANCE TO BE STATED IN THE CONTRACT CONDITIONS.
- ALL WORK TO BE CARRIED OUT IN A TRADESMEN LIKE MANNER AND IN ACCORDANCE WITH THE STANDARDS CODES AND REGULATIONS OF THE STANDARDS ASSOCIATION OF AUSTRALIA, BUILDING CODE OF AUSTRALIA AND ANY STATUTORY AUTHORITY HAVING JURISDICTION OVER THE WORK.
- ALL TENDERERS ARE TO VISIT THE SITE TO SATISFY THEMSELVES AS TO THE NATURE AND EXTENT OF THE WORKS, FACILITIES AVAILABLE AND DIFFICULTIES ENTAILED IN THE WORKS AS VARIATIONS WILL NOT BE ALLOWED DUE TO WORK ARISING OWING TO NEGLECT OF THIS CLAUSE.
- ALL WORK AND MATERIALS TO COMPLY WITH THE CURRENT AUSTRALIAN STANDARDS AT THE TIME OF COMMENCEMENT WERE APPLICABLE.
- THESE DRAWINGS SHALL BE READ IN CONJUNCTION WITH ALL STRUCTURAL AND OTHER CONSULTANTS DRAWINGS AND SPECIFICATIONS AND WITH ANY SUCH WRITTEN INSTRUCTIONS AS MAY BE ISSUED DURING THE COURSE OF THE CONTRACT.
- SET OUT DIMENSIONS SHOWN ON THIS DRAWING SHALL BE VARIFIED BY THE BUILDER ON SITE BEFORE COMMENCEMENT OF ANY WORK. DIMENSIONS SHOULD NOT BE OBTAINED BY SCALING THE DRAWINGS. USE ONLY FIGURED DIMENSIONS, ALL DIMENSIONS ARE IN MILLIMETRES.
- THE BUILDER IS TO ENSURE ALL CONSTRUCTION. LEVELS AND OTHER ITEMS COMPLY WITH THE CONDITIONS OF THE BUILDING APPROVAL.
- THE BUILDER IS TO COMPLY WITH ALL ORDINANCES, LOCAL AUTHORITY REGULATIONS AND THE REQUIREMENTS OF ALL SERVICES SUPPLY AUTHORITIES HAVING JURISDICTION OVER THE WORKS.
- ALL PLUMBING AND DRAINAGE WORK TO BE INSTALLED AND COMPLETED BY A LICENCED TRADESMAN AND IN ACCORDANCE WITH THE STATUTORY BODY HAVING AUTHORITY OVER THE WORKS. CONNECT ALL WASTE TO SYDNEY WATER SEWER LINE
- ALL NEW DOWNPIPES ARE TO BE CONNECTED TO THE EXISTING STORM WATER SYSTEM.
- ALL POWER AND STORMWATER OUTLET LOCATIONS SHALL BE DETERMINED ONSITE BY THE OWNER.
- SMOKE DETECTOR ALARM TO BE INSTALLED IN ACCORDANCE WITH AS3786 AND THE BUILDING CODE OF AUSTRALIA.
- ELECTRICAL WORK TO BE IN ACCORDANCE WITH SAA WIRING RULES AND BE DONE BY A LICENCED TRADESMAN
- ANY DETAILING IN ADDITION TO WHAT IS SUPPLIED SHALL BE RESOLVED BETWEEN THE OWNER AND THE BUILDER TO THE OWNERS APPROVAL, EXCEPT FOR ANY STRUCTURAL DETAILS OR DESIGN WHICH IS SUPPLIED BY THE ENGINEER.
- ALL TIMBER SIZES AND CONCRETE DETAILS TO BE CONFIRMED BY THE BUILDER PRIOR TO COMMENCEMENT OF ANY WORK.
- ALL STRUCTURAL WORK IS TO BE IN ACCORDANCE WITH THE STRUCTURAL DETAILS PREPARED BY A STRUCTURAL ENGINEER (i.e.) PIERS, FOOTINGS, CONCRETE SLABS, RETAINING WALLS, STEELWORK, FORMWORK, UNDERPINNING, ADDITIONAL STRUCTURAL LOADS, TIMBER FRAMING, WIND BRACING AND ASSOCIATED CONNECTIONS. BUILDER TO OBTAIN PRIOR TO FINALISING TENDER.
- ANY WORK INDICATED ON THE PLANS BUT NOT SPECIFIED, AND ANY ITEM NOT SHOWN ON THE PLAN WHICH IS OBVIOUSLY NECESSARY AS A PART OF CONSTRUCTION AND/OR FINISH IS TO BE CONSIDERED AS SHOWN AND SPECIFIED, AND IS TO BE DONE AS PART OF THE CONTRACT. VARIATIONS WILL NOT BE PERMITTED WITHOUT THE WRITTEN CONSENT OF THE OWNER.
- THE BUILDER SHALL PROVIDE SEDIMENT AND SILTRATION CONTROL MEASURES AS REQUIRED BY COUNCIL AND MAINTAIN THEM THROUGH THE DURATION OF THE WORKS.
- A LEGIBLE COPY OF THE PLANS BEARING APPROVAL STAMPS MUST BE MAINTAINED ON THE JOB AT ALL TIMES. HOURS OF CONSTRUCTION WILL BE RESTRICTED TO THE TIMES AS REQUIRED BY THE BUILDING APPROVAL.
- THE BUILDER IS TO ARRANGE FOR ALL INSPECTIONS REQUIRED BY THE AUTHORITIES AND LENDING INSTITUTIONS TO THEIR REQUIREMENTS.
- THE BUILDER IS TO OBTAIN APPROVAL FOR INTERUPTIONS TO EXISTING SERVICES AND MINIMISE THE DURATION AND NUMBER OF INTERUPTIONS. ANY INTERRUPTIONS WITH EXISTING SERVICES AND EQUIPMENT TO BE ATTENDED TO BY THE APPROPRIATELY SKILLED TRADESMEN.
- THE BUILDER SHALL RESTORE, REINSTATE OR REPLACE ANY DAMAGE CAUSED TO EXISTING STRUCTURES OR LANDSCAPING BY CONSTRUCTION WORK OR WORKMEN. PROVIDE PROTECTION TO EXISTING TREES TO REMAIN AS REQUIRED BY APPROVAL CONDITIONS.
- ALL BRICKWORK IS TO BE SELECTED BY OWNER AND IS TO COMPLY WITH AS1640
- ALL MASONRY TO COMPLY WITH AS3700
- ALL METALWORK AND FLASHING ITEMS NECESSARY TO SATISFACTORY COMLPETE WORK SHALL BE PROVIDED.
- ALL GUTTERS, DOWNPIPES TO BE COLORBOND.
- ALL TIMBER CONSTRUCTION TO BE IN ACCORDANCE WITH THE AUSTRALIAN STANDARD 1684 "TIMBER FRAMING CODE"
- ALL GLAZING INSTALLED TO COMPLY WITH AS1288, 2047 AND IN ACCORDANCE WITH MANUFACTURERS RECOMMENDATION
- ALL WALL AND CEILING LININGS TO BE PLASTERBOARD OR CEMENT RENDER AS SELECTED AND VILLA BOARD IN WET AREAS, TO COMPLY WITH THE RELEVANT AUSTRALIAN STANDARDS OR INSTALLED IN ACCORDANCE WITH MANUFACTURERS SPECIFICATION.
- ALL BATHROOMS AND WET AREAS TO BE ADEQUATELY WATERPROOFED TO MANUFACTURERS SPECIFATION AND AS3740 AND PART 3.8.1 OF THE BUILDING CODE OF AUSTRALIA HOUSING PROVISIONS
- STAIRS AND BALUSTRADES TO COMPLYWITH PART 3.9.1 & 3.9.2 OF THE BUILDING CODE OF AUSTRALIA HOUSING PROVISION.
- TERMITE PROTECTION MEASURES TO COMPLY WITH AS 3660 AND BE INSTALLED TO MANUFACTURERS SPECIFICATION.
- ANY DETAILING ADDITIONAL TO THAT SUPPLIED, SHALL BE RESOLVED BETWEEN THE OWNER AND THE BUILDER TO THE OWNERS APPROVAL. EXCEPT FOR ANY STRUCTURAL DETAILS OR DESIGN WHICH IS TO BE SUPPLIED BY THE STRUCTURAL ENGINEER.

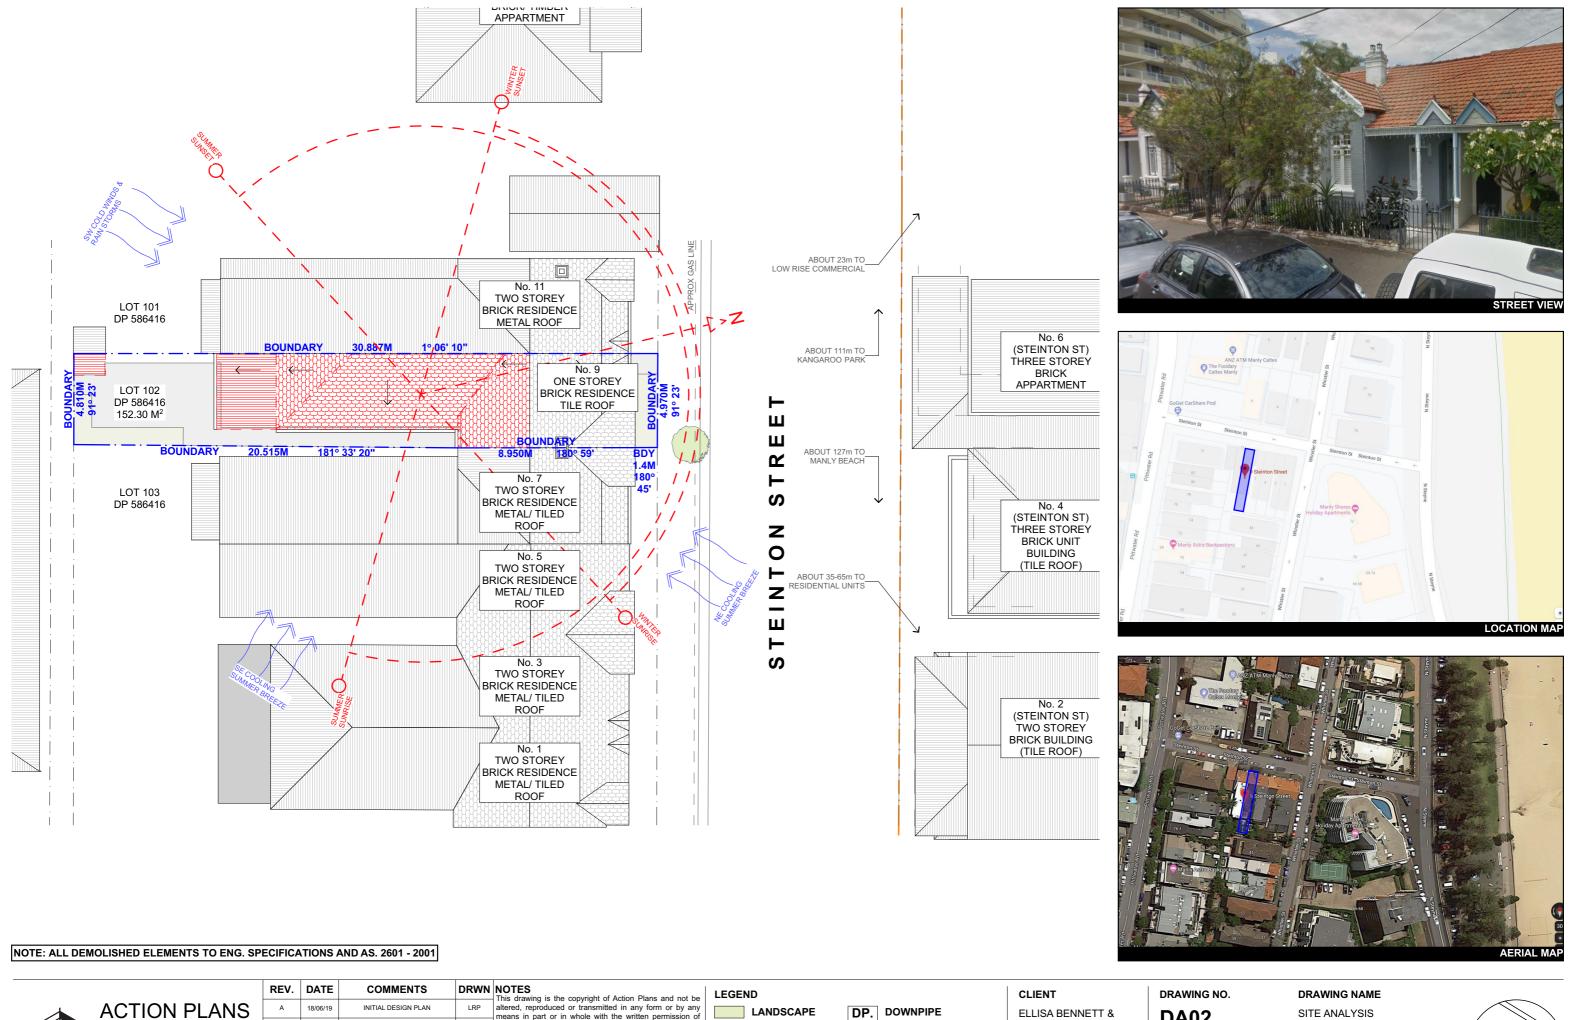

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All errors and omissions are to be verified by the Builder/Contractor and referred to the designer prior to the DESIGN AMENDMENT LRP

DP. DOWNPIPE LANDSCAPE HARD SURFACE **EARTH PROPOSED** — SETBACKS ─ · ─ BOUNDARY LINE **EXISTING**

DEMOLISHED

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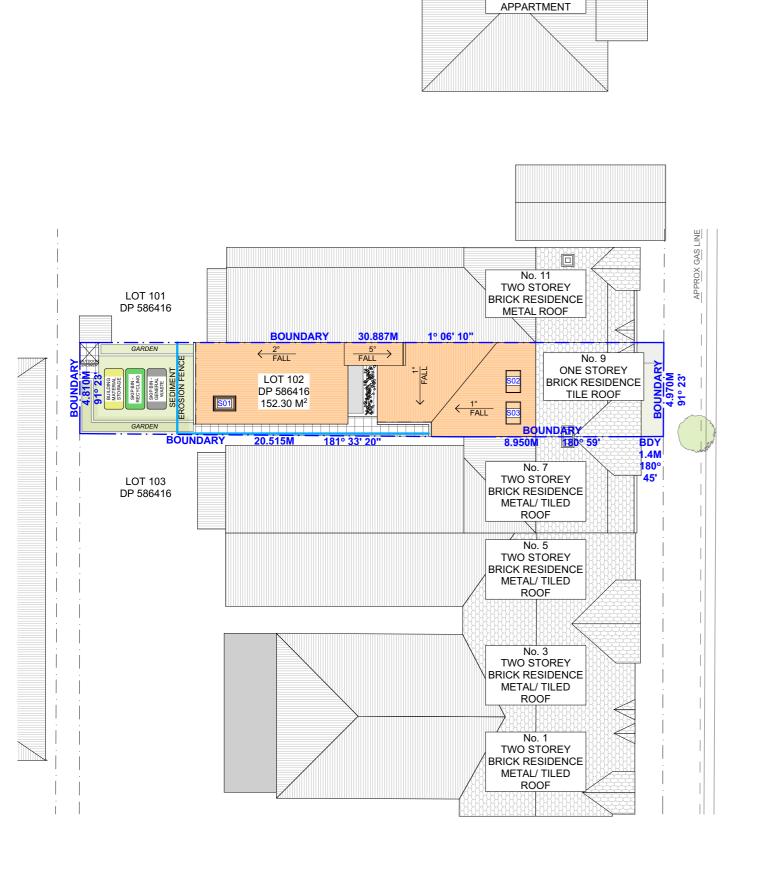
PROJECT ADDRESS 9 STEINTON STREET MANLY, NSW, 2095


DA02


SITE ANALYSIS

DATE SCALE 1:200 @A3 Tuesday, May 5, 2020





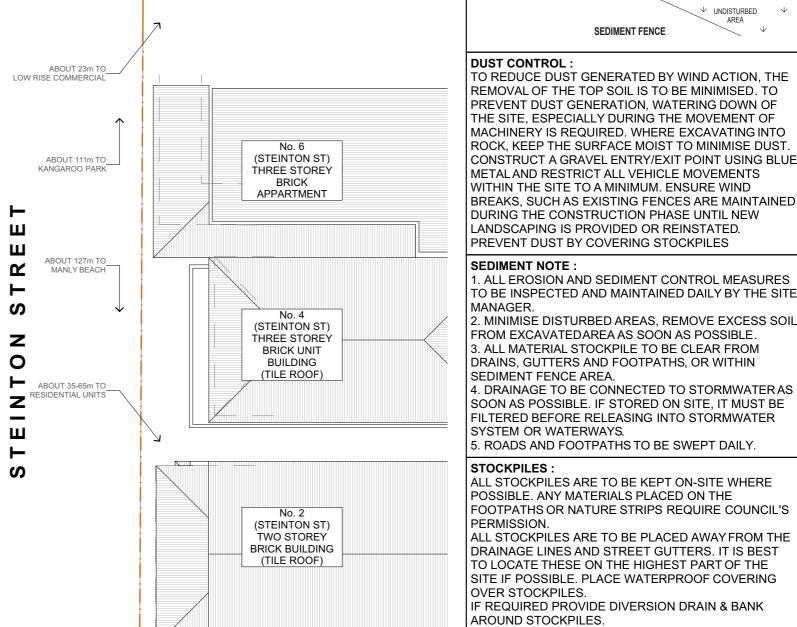

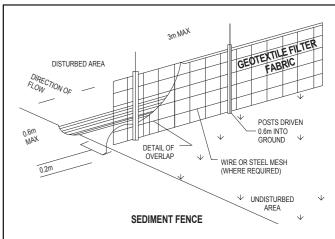

DUST CONTROL:

TO REDUCE DUST GENERATED BY WIND ACTION, THE REMOVAL OF THE TOP SOIL IS TO BE MINIMISED. TO PREVENT DUST GENERATION, WATERING DOWN OF THE SITE, ESPECIALLY DURING THE MOVEMENT OF MACHINERY IS REQUIRED. WHERE EXCAVATING INTO ROCK, KEEP THE SURFACE MOIST TO MINIMISE DUST. CONSTRUCT A GRAVEL ENTRY/EXIT POINT USING BLUE METAL AND RESTRICT ALL VEHICLE MOVEMENTS WITHIN THE SITE TO A MINIMUM. ENSURE WIND BREAKS, SUCH AS EXISTING FENCES ARE MAINTAINED DURING THE CONSTRUCTION PHASE UNTIL NEW LANDSCAPING IS PROVIDED OR REINSTATED. PREVENT DUST BY COVERING STOCKPILES

SEDIMENT NOTE:

- 1. ALL EROSION AND SEDIMENT CONTROL MEASURES TO BE INSPECTED AND MAINTAINED DAILY BY THE SITE MANAGER.
- FROM EXCAVATEDAREA AS SOON AS POSSIBLE. 3. ALL MATERIAL STOCKPILE TO BE CLEAR FROM DRAINS, GUTTERS AND FOOTPATHS, OR WITHIN SEDIMENT FENCE AREA
- 4. DRAINAGE TO BE CONNECTED TO STORMWATER AS SOON AS POSSIBLE. IF STORED ON SITE, IT MUST BE FILTERED BEFORE RELEASING INTO STORMWATER SYSTEM OR WATERWAYS.
- 5. ROADS AND FOOTPATHS TO BE SWEPT DAILY.

STOCKPILES:

ALL STOCKPILES ARE TO BE KEPT ON-SITE WHERE POSSIBLE. ANY MATERIALS PLACED ON THE FOOTPATHS OR NATURE STRIPS REQUIRE COUNCIL'S PERMISSION.

ALL STOCKPILES ARE TO BE PLACED AWAY FROM THE DRAINAGE LINES AND STREET GUTTERS. IT IS BEST TO LOCATE THESE ON THE HIGHEST PART OF THE SITE IF POSSIBLE. PLACE WATERPROOF COVERING OVER STOCKPILES.

IF REQUIRED PROVIDE DIVERSION DRAIN & BANK AROUND STOCKPILES.

GUTTER PROTECTION:


PROVIDE PROTECTION TO DOWNHILL GRATE IN GUTTER BY MEANS OF SAND BAGS OR BLUE METAL WRAPPED IN GEOTEXTILE FABRIC. WHEN SOIL OR SAND BUILDS UP AROUND THIS SEDIMENT BARRIER, THE MATERIAL SHOULD BE RELOCATED BACK TO THE SITE FOR DISPOSAL

NOTE: ALL PROPOSED STORMWATER TO CONNECT WITH EXISTING



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	А	18/06/19	INITIAL DESIGN PLAN	LRP
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u	С	24/10/19	PRE DA AMENDMENT	LRP
	D	21/02/2020	DESIGN PLAN	LRP
	E	26/02/2020	DESIGN AMENDMENT	LRP

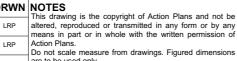

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MANLY, NSW, 2095

DRAWING NO.

DA03


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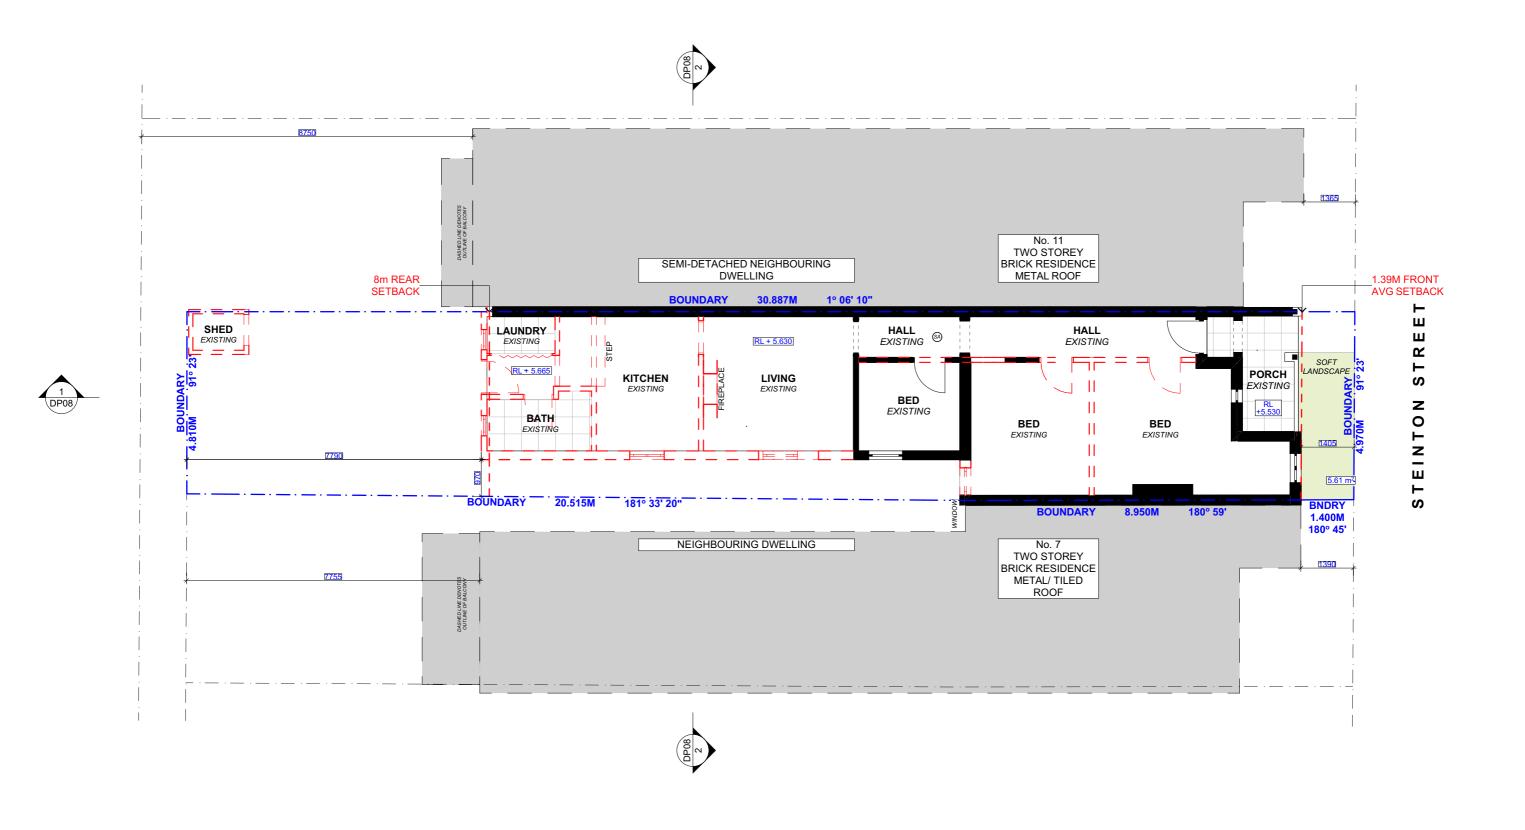
Tuesday, May 5, 2020

DRAWING NAME

SITE / ROOF / SEDIMENT EROSION / WASTE MANAGEMENT / STORMWATER SONGEPT PLAN

1:200 @A3



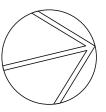


NOTE: ALL DEMOLISHED ELEMENTS TO ENG. SPECIFICATIONS AND AS. 2601 - 2001



ACTION PLANS

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u	В	19/07/19	PRE DA	LRP	Action Plans. Do not scale measure from drawings. Figured dimensions	
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	D	21/02/2020	DESIGN PLAN	LRP	dimensions on site prior to commencement of any work, creation of shop drawings, or fabrication of components.	
	E	26/02/2020	DESIGN AMENDMENT	LRP	All errors and omissions are to be verified by the Builder/Contractor and referred to the designer prior to the	
					commencement of works.	

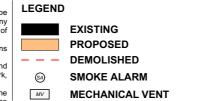

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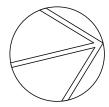
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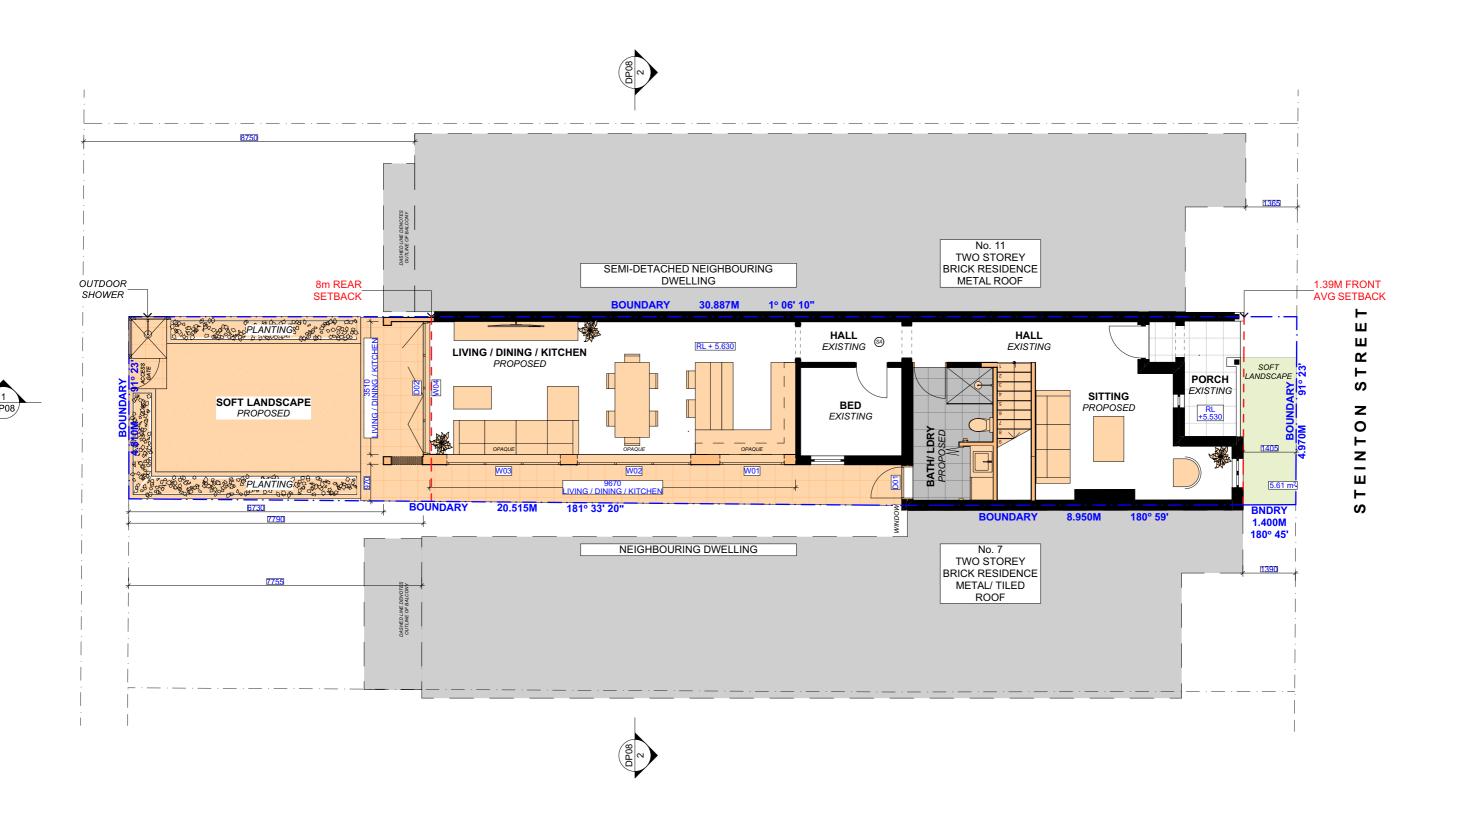
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EXISTING GROUND FLOOR PLAN

DRAWING NAME

SCALE 1:100 @A3 Tuesday, May 5, 2020








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D	21/02/2020	DESIGN PLAN	LRP	dimensions of creation of sh
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//Contractor shall check and verify all levels and



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DA05


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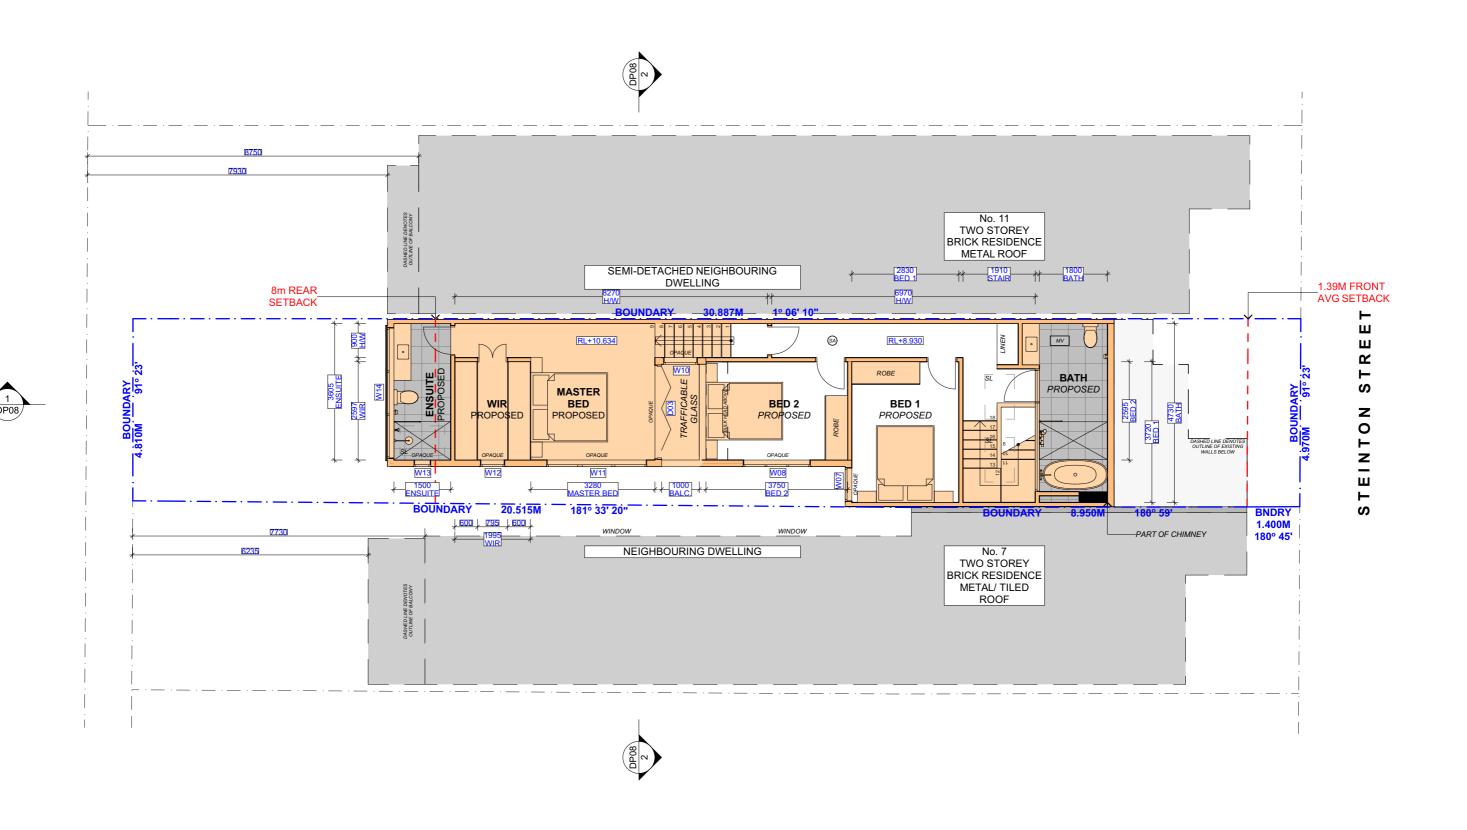
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1:100 @A3 Tuesday, May 5, 2020

PROPOSED GROUND FLOOR **SCALE**

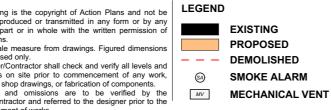DRAWING NAME






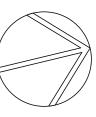

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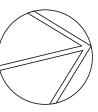
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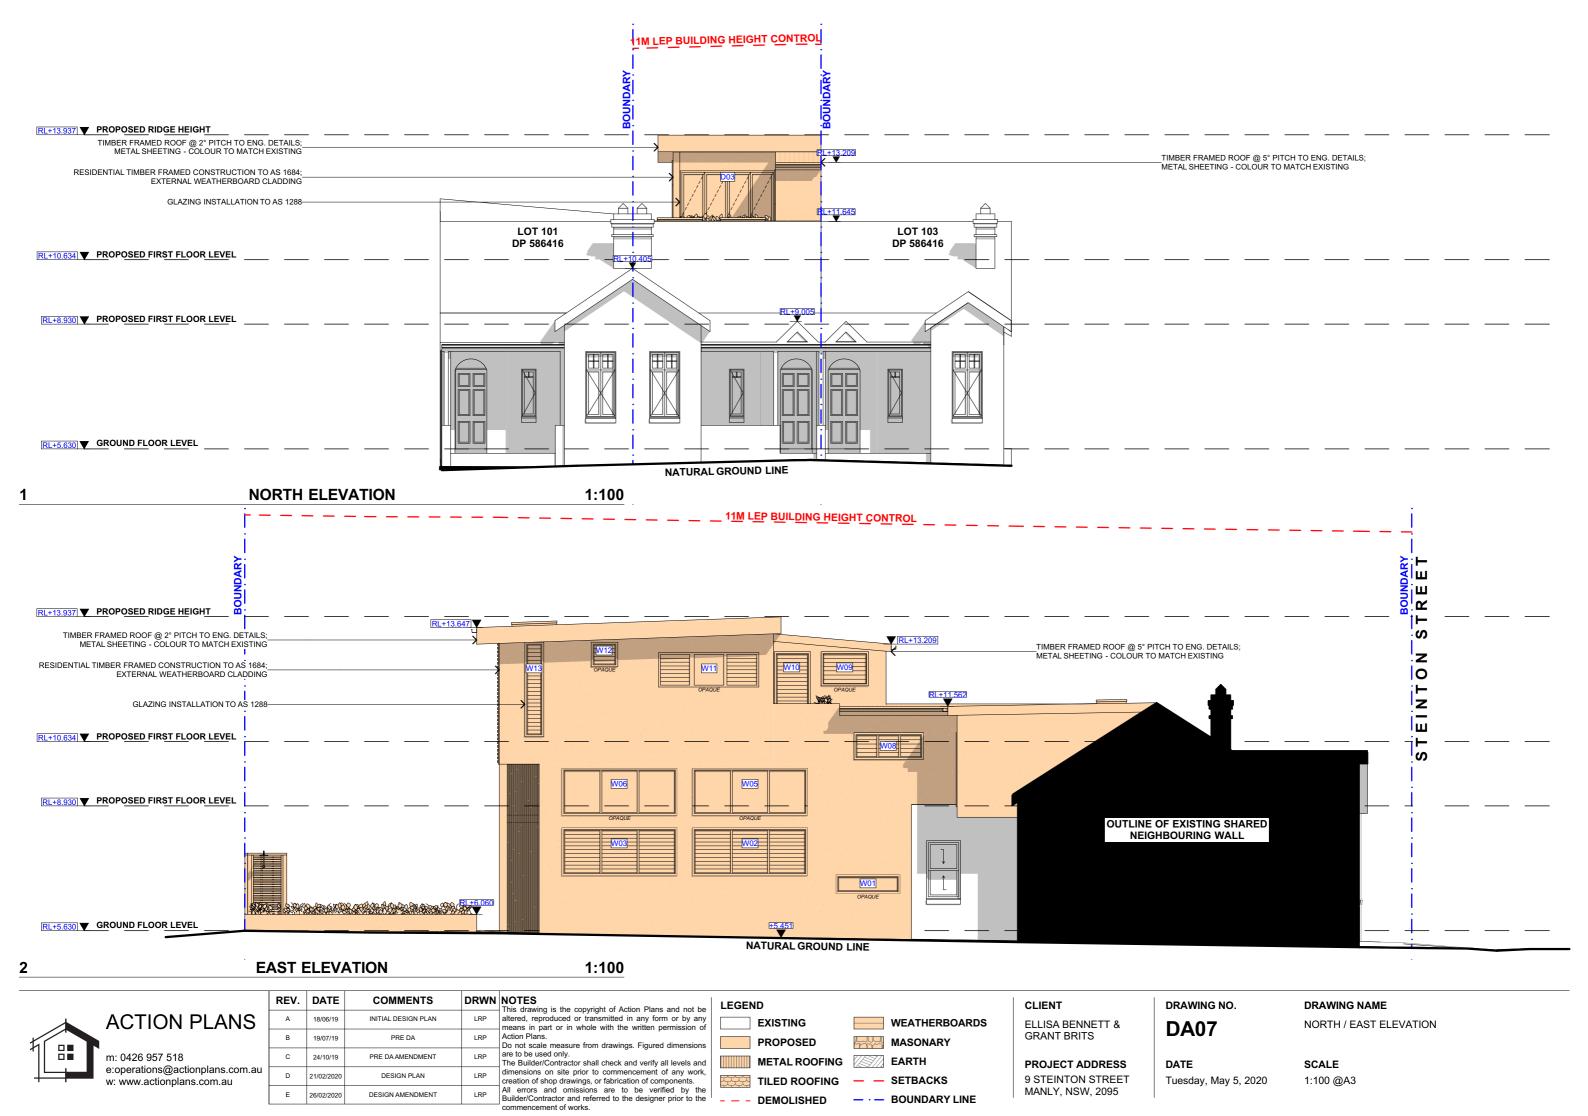
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DATE

DRAWING NAME
PROPOSED FIRST FLOOR
PLAN

SCALE 1:100 @A3

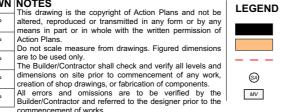







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	В	19/07/19	PRE DA	ι
ıu	С	24/10/19	PRE DA AMENDMENT	ι
	D	21/02/2020	DESIGN PLAN	ι
	E	26/02/2020	DESIGN AMENDMENT	l

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PRE DA AMENDMENT	LRP	are to be used only. The Builder/Contractor shall check and verify all levels are

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,	dimensions on site prior to commencement of any work, creation of shop drawings, or fabrication of components.	
,	All errors and omissions are to be verified by the Builder/Contractor and referred to the designer prior to the	
	commencement of works.	

LEGEND		
EXISTING	WEATHERBOARD	วร
PROPOSED	MASONARY	
METAL ROOFING	EARTH	
TILED ROOFING	— SETBACKS	
DEMOLISHED	- · - BOUNDARY LINE	

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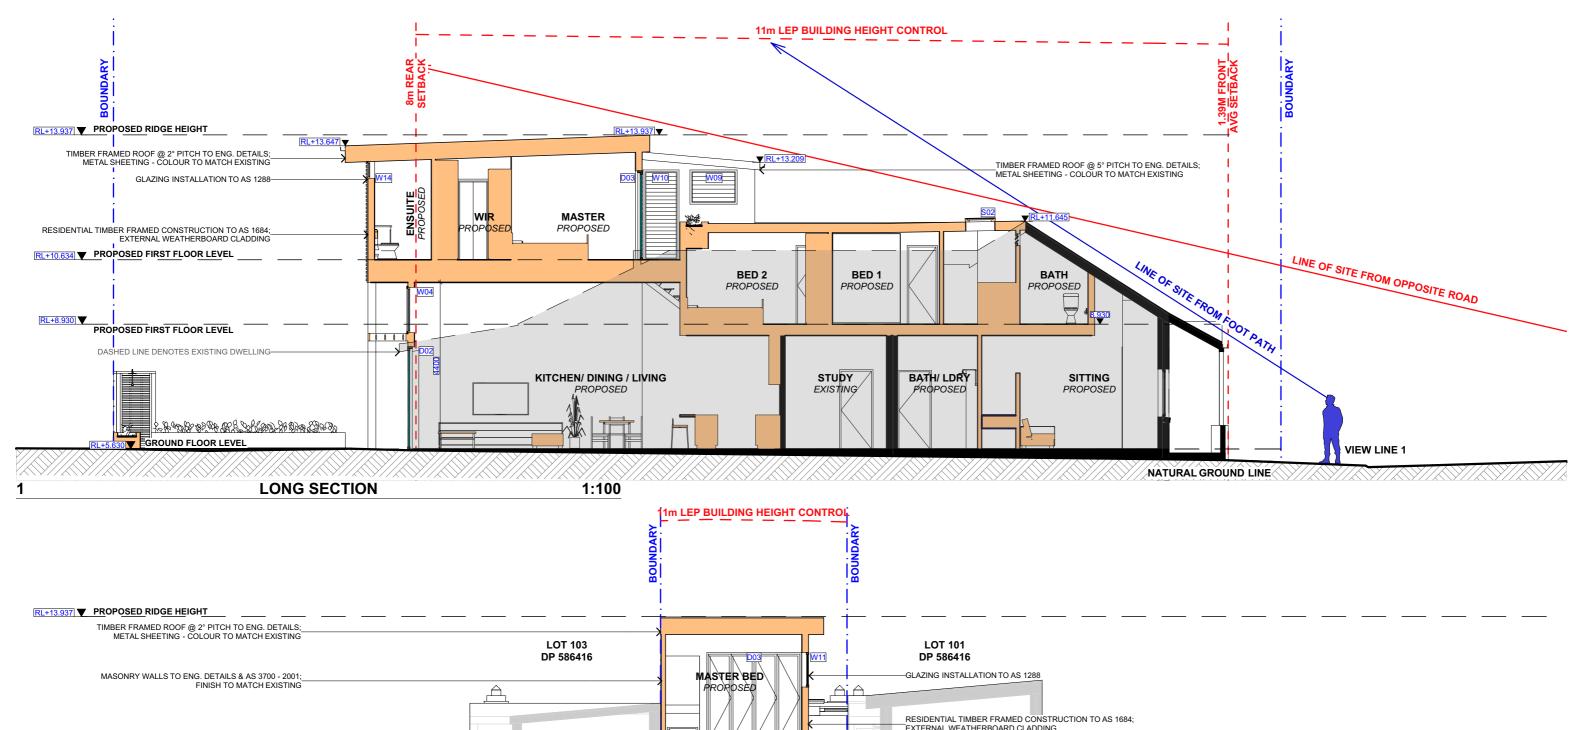
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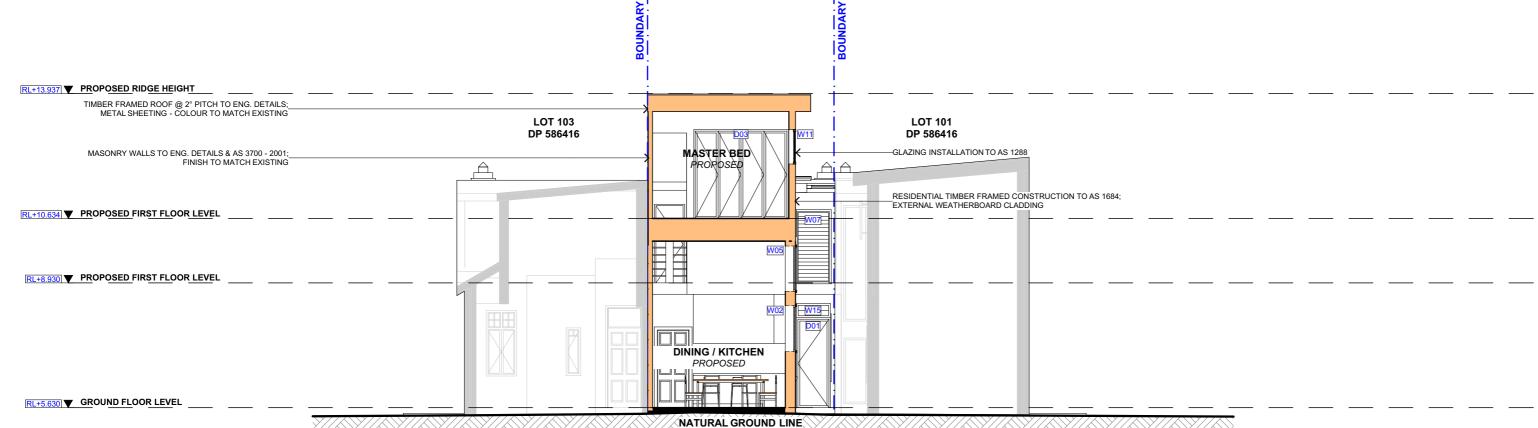
DRAWING NAME SOUTH / WEST ELEVATION

DATE

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SCALE 1:100 @A3





CROSS SECCTION 1:100



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	REV.	DATE	COMMENTS	DRWN	NO This
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18/06/19	INITIAL DESIGN PLAN	LRP	This drawing is the copyright of Action Plans and not be altered, reproduced or transmitted in any form or by any means in part or in whole with the written permission of
19/07/19	PRE DA	LRP	Action Plans. Do not scale measure from drawings. Figured dimensions
24/10/19	PRE DA AMENDMENT	LRP	are to be used only. The Builder/Contractor shall check and verify all levels and

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altered, reproduced or transmitted in any form or by any means in part or in whole with the written permission of	EXISTING	WEATHERBOARDS
Action Plans. On not scale measure from drawings. Figured dimensions	PROPOSED	MASONARY
are to be used only. The Builder/Contractor shall check and verify all levels and	METAL ROOFING	EARTH
dimensions on site prior to commencement of any work, creation of shop drawings, or fabrication of components. All errors and omissions are to be verified by the	TILED ROOFING	— SETBACKS
Builder/Contractor and referred to the designer prior to the	DEMOLISHED	— · — BOUNDARY LINE

CLIENT
ELLISA BENNETT & GRANT BRITS

PROJECT ADDRESS
9 STEINTON STREET
MANLY, NSW, 2095

DRAWING NO. **DA09**

DATE

DRAWING NAME LONG / CROSS SECTION

Tuesday, May 5, 2020

SCALE 1:100 @A3 SITE AREA: 152.30m²

FLOOR SPACE RATIO (FSR) 0.75 : 1 (114.23 m²) PERMISSIBLE **EXISTING** 0.55 : 1 (80.19m²) PROPOSED 1.01 : 1 (154.42m²)

OPEN SPACE AREA: REQUIRED 50 **EXISTING** PROPOSED

50.00% (76.15 m²) 42% (63.66m²) UNCHANGED

PROPOSED

LANDSCAPE AREA: % OF OPEN SPACEREQUIRED 30.00% (22.85m²) **EXISTING** $5.63 m^{2}$ 30.07m²




PRIVATE OPEN SPACE REQUIRED 18.00m² **EXISTING** 37.76m² PROPOSED UNCHANGED



EXISTING AREA CALCULATIONS

1:100

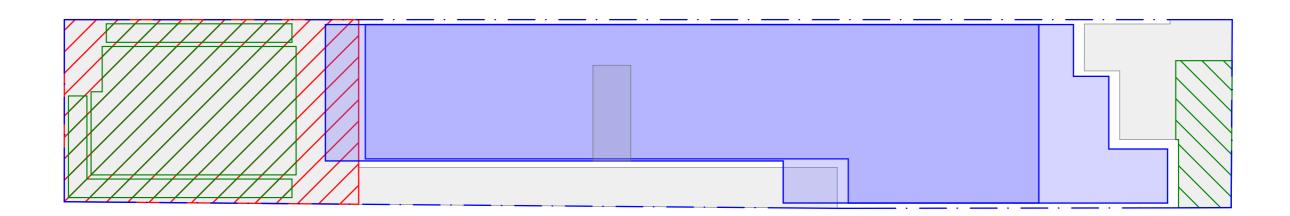

PROPOSED AREA CALCULATIONS

1:100



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В	19/07/19	PRE DA	LRP	Action Plans. Do not scale measure from drawings. Figured dimensions	Γ
С	24/10/19	PRE DA AMENDMENT	LRP	are to be used only. The Builder/Contractor shall check and verify all levels and	
D	21/02/2020	DESIGN PLAN	LRP	dimensions on site prior to commencement of any work, creation of shop drawings, or fabrication of components.	- -
Е	26/02/2020	DESIGN AMENDMENT	LRP	All errors and omissions are to be verified by the Builder/Contractor and referred to the designer prior to the	
		-		commencement of works.	



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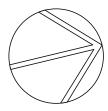
PROJECT ADDRESS 9 STEINTON STREET MANLY, NSW, 2095

DRAWING NO. **DA10**

DATE

DRAWING NAME AREA CALCULATIONS

SCALE 1:100 @A3 Tuesday, May 5, 2020





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D	21/02/2020	DESIGN PLAN	LRP	dimensions on site prior to commencement of any work, creation of shop drawings, or fabrication of components.
E	26/02/2020	DESIGN AMENDMENT	LRP	All errors and omissions are to be verified by the Builder/Contractor and referred to the designer prior to the
				commencement of works.

LEGEND

ELLISA BENNETT & GRANT BRITS

CLIENT


PROJECT ADDRESS 9 STEINTON STREET MANLY, NSW, 2095

DRAWING NO. **DA11**

DRAWING NAME SAMPLE BOARD


DATE Tuesday, May 5, 2020

SCALE @A3

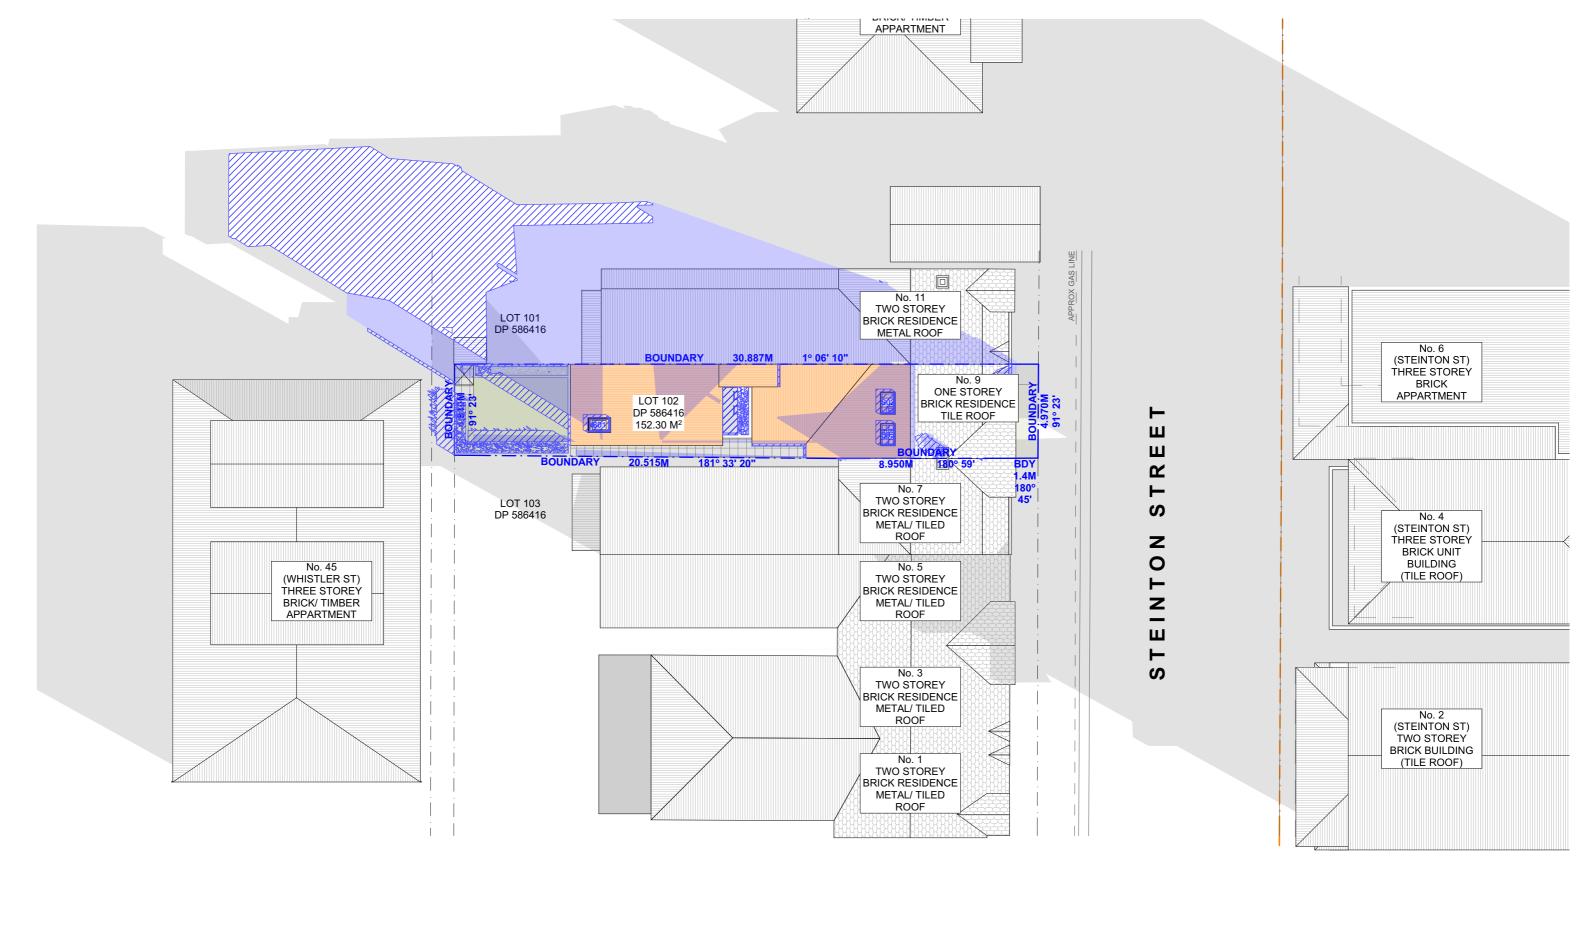



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ELLISA BENNETT & GRANT BRITS

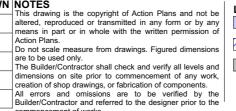PROJECT ADDRESS 9 STEINTON STREET MANLY, NSW, 2095 DRAWING NO.

Tuesday, May 5, 2020


DA12


DATE SCALE

WINTER SOLSTICE 9 AM

SCALE
1:200 @A3


DRAWING NAME

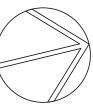

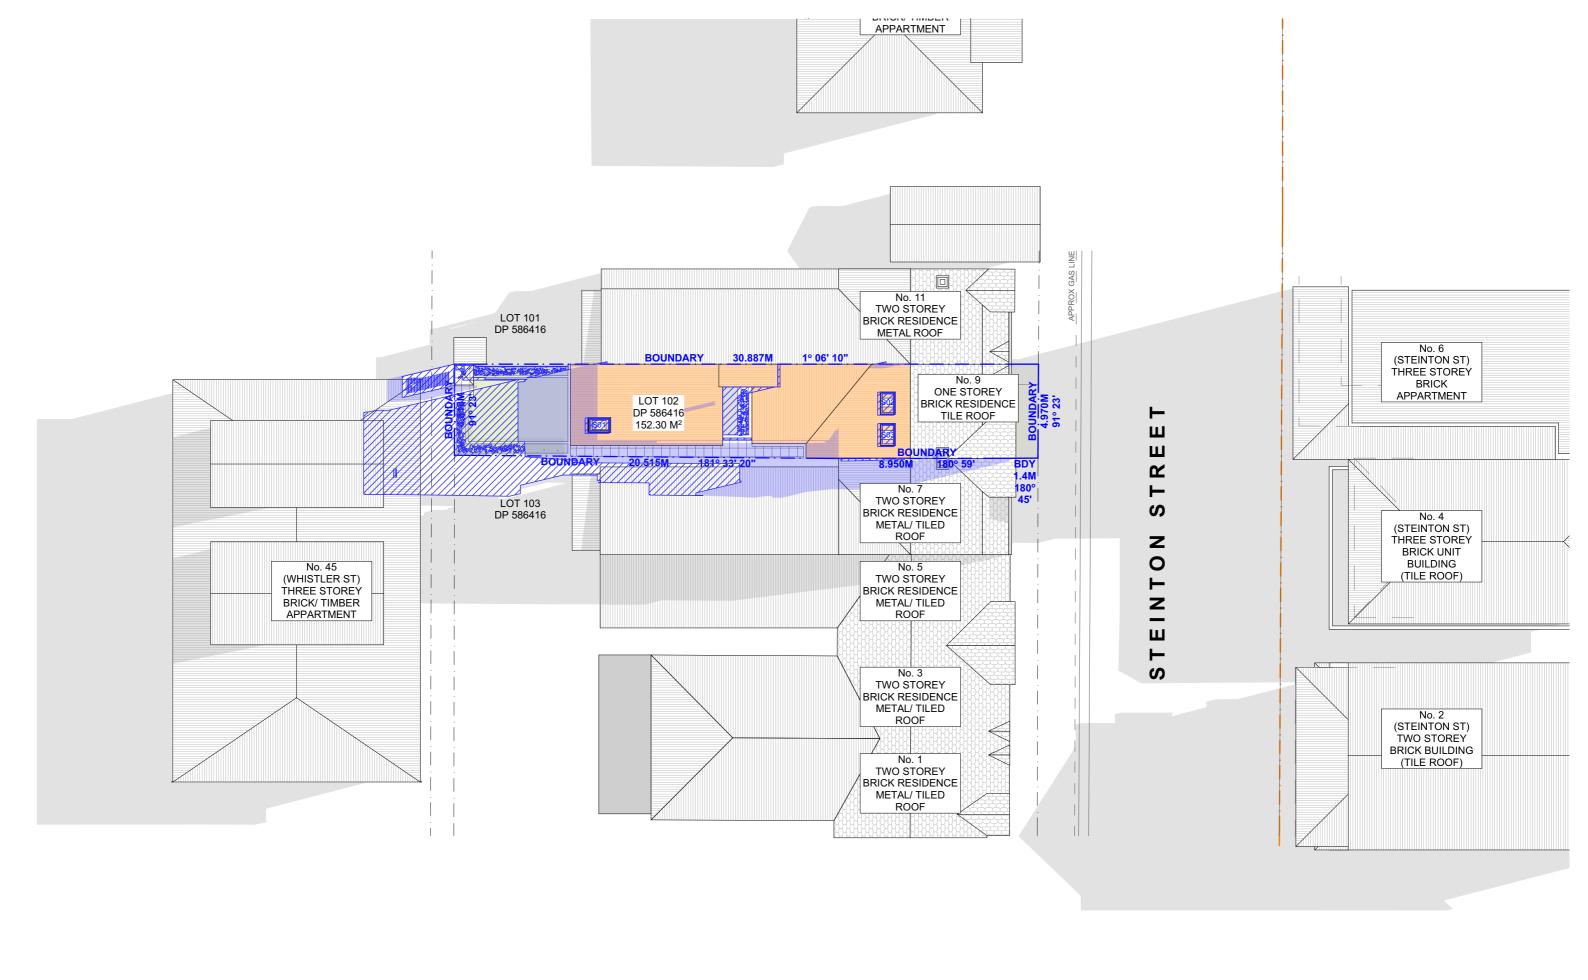




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PROJECT ADDRESS 9 STEINTON STREET MANLY, NSW, 2095

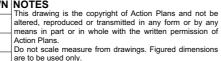
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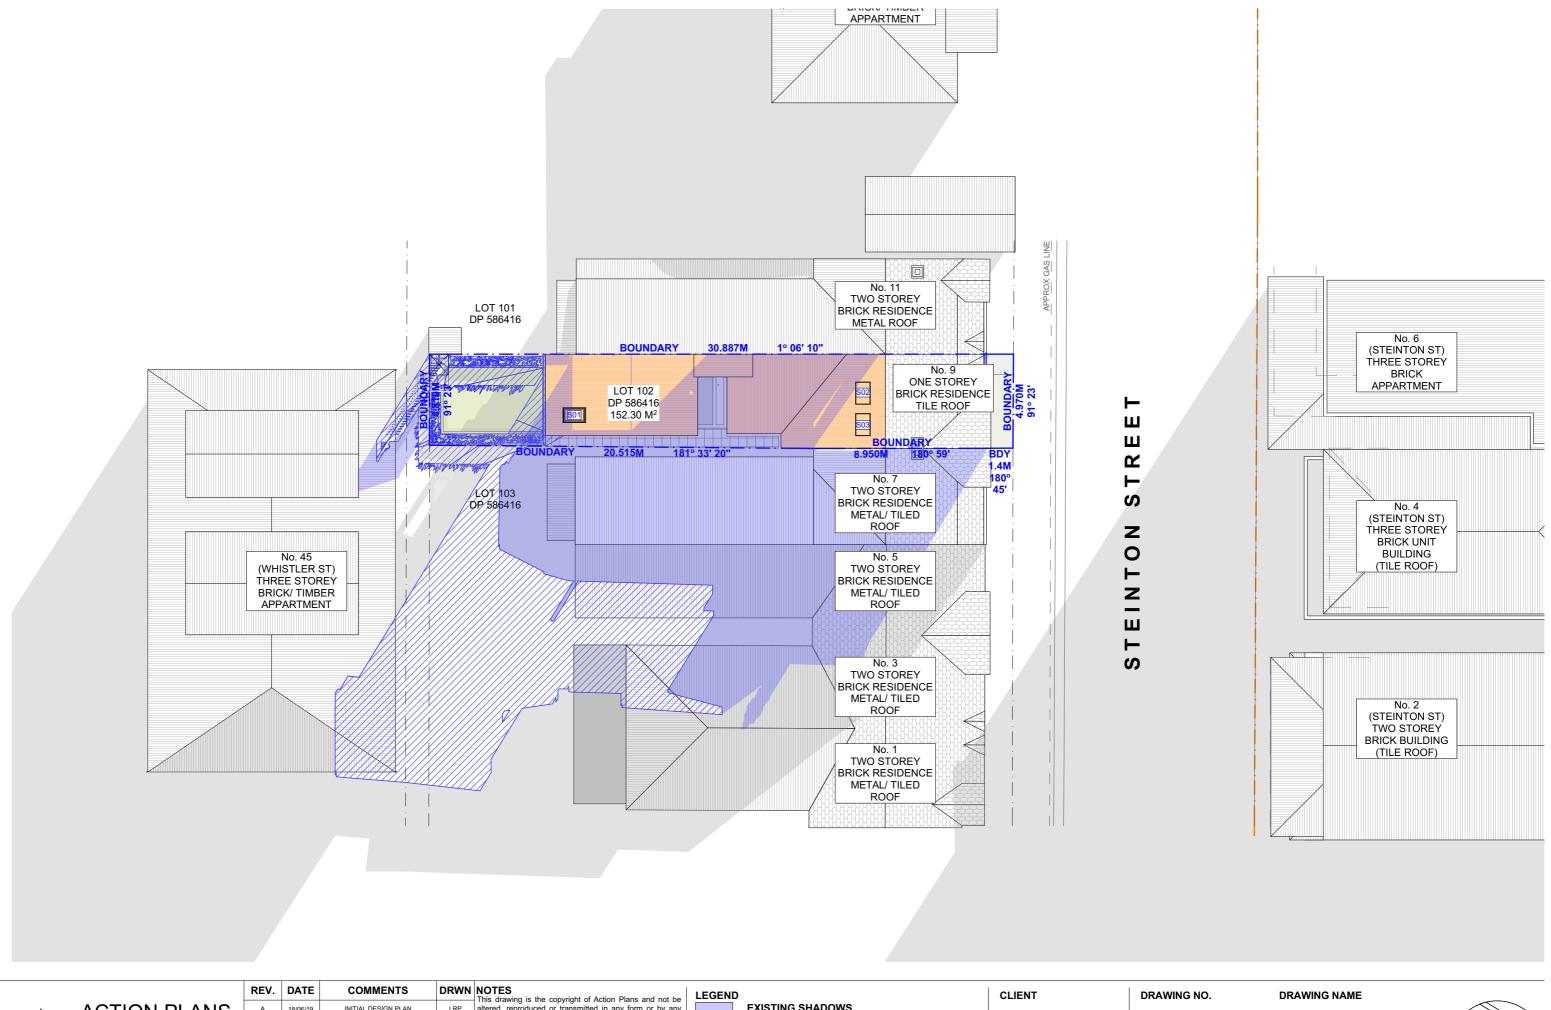
DA13

DATE Tuesday, May 5, 2020 DRAWING NAME

WINTER SOLSTICE 12 PM

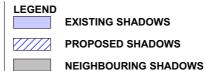SCALE 1:200 @A3



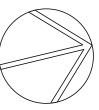



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В	19/07/19	PRE DA	LRP	Action Plans. Do not scale measure from
С	24/10/19	PRE DA AMENDMENT	LRP	are to be used only. The Builder/Contractor shal
D	21/02/2020	DESIGN PLAN	LRP	dimensions on site prior to creation of shop drawings, of
E	26/02/2020	DESIGN AMENDMENT	LRP	All errors and omissions Builder/Contractor and refer
				commencement of works.

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Do not scale measure from drawings. Figured dimension

Do not scale measure from drawings. Figured difficults are to be used only.

The Builder/Contractor shall check and verify all levels and dimensions on site prior to commencement of any work, creation of shop drawings, or fabrication of components.

All errors and omissions are to be verified by the Builder/Contractor and referred to the designer prior to the

EXISTING SHADOWS
PROPOSED SHADOWS
NEIGHBOURING SHADOWS

ELLISA BENNETT & **GRANT BRITS**

PROJECT ADDRESS
9 STEINTON STREET
MANLY, NSW, 2095

DA14

DATE Tuesday, May 5, 2020 WINTER SOLSTICE 3 PM

SCALE 1:200 @A3









NO IMPACT CREATED ON 7 STEINTON STREET BY **EXISTING OR PROPOSED DEVELOPMENT AT 9AM**

NOTE: SHADOW PERSPECTIVES NOT TO SCALE



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Α	18/06/19	INITIAL DESIGN PLAN	LRP	alt
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E	26/02/2020	DESIGN AMENDMENT	LRP	All Bu

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LEGEND

AREAS NOT IN SHADOW

AREAS IN SHADOW

NOTE: SHADOW PERSPECTIVES NOT TO SCALE

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ELLISA BENNETT & GRANT BRITS

PROJECT ADDRESS

9 STEINTON STREET MANLY, NSW, 2095

DRAWING NO.

DA15

DATE

Tuesday, May 5, 2020

DRAWING NAME

3D WINTER SOLSTICE 9AM - 7 STEINTON STREET SUN SHADOW STUDY

SCALE

1:100 @A3







NOTE: SHADOW PERSPECTIVES NOT TO SCALE



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LEGEND

AREAS NOT IN SHADOW

AREAS IN SHADOW

NOTE: SHADOW PERSPECTIVES NOT TO SCALE

CLIENT

ELLISA BENNETT & GRANT BRITS

PROJECT ADDRESS

9 STEINTON STREET MANLY, NSW, 2095

DRAWING NO.

DA16

Tuesday, May 5, 2020

DATE

SCALE

DRAWING NAME

3D WINTER SOLSTICE 12PM - 7 STEINTON STREET SUN SHADOW STUDY

1:100 @A3







NOTE: SHADOW PERSPECTIVES NOT TO SCALE



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LEGEND	
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NOTE: SHADOW PERSPECTIVES NOT TO SCALE

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PROJECT ADDRESS 9 STEINTON STREET

MANLY, NSW, 2095

DRAWING NO. **DA17**

DATE


Tuesday, May 5, 2020


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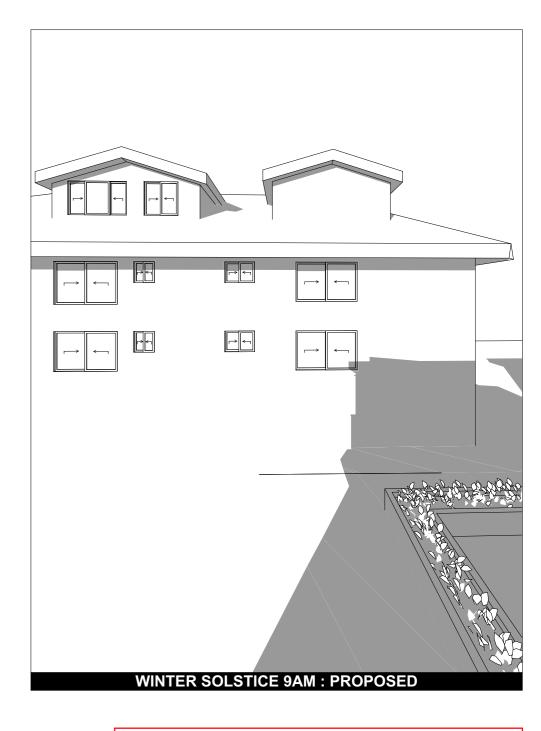
3D WINTER SOLSTICE 3PM - 7 STEINTON STREET SUN SHADOW STUDY

SCALE

1:100 @A3



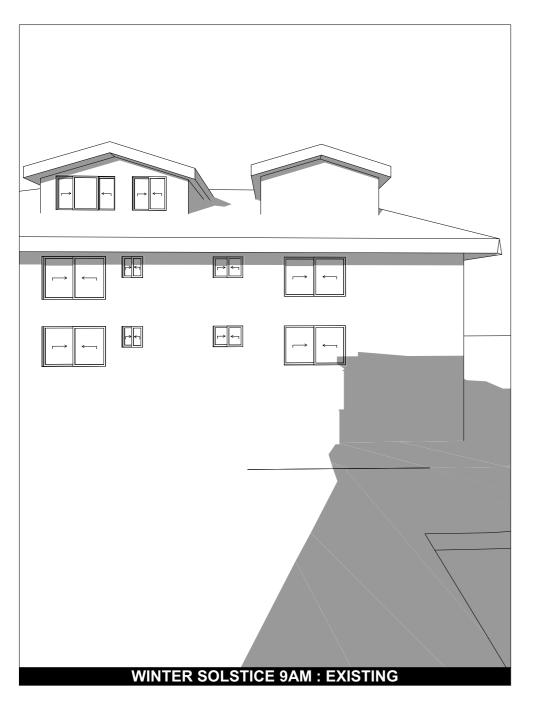

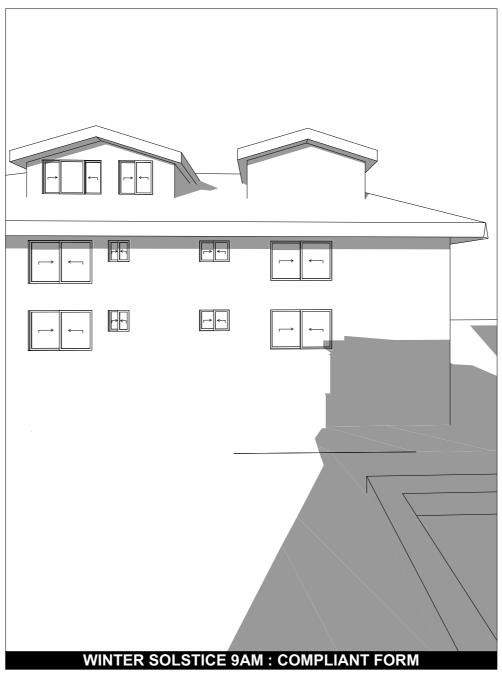

NO IMPACT CREATED ON 45 WHISTLER STREET BY **EXISTING OR PROPOSED DEVELOPMENT AT 9AM**

ACTION PLANS

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Α	18/06/19	INITIAL DESIGN PLAN	LRP	alt
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E	26/02/2020	DESIGN AMENDMENT	LRP	All Bu

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NOTE: SHADOW PERSPECTIVES NOT TO SCALE

CLIENT

ELLISA BENNETT & GRANT BRITS

PROJECT ADDRESS 9 STEINTON STREET MANLY, NSW, 2095


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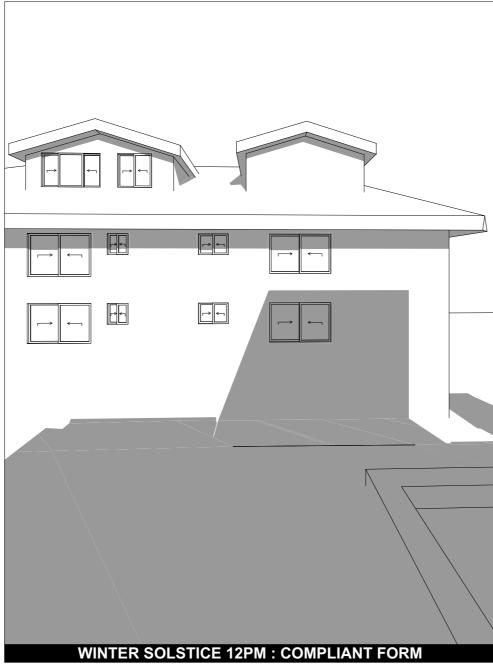
DA18


DATE Tuesday, May 5, 2020 DRAWING NAME


3D WINTER SOLSTICE 9AM - 45 WHISTLER STREET SUN SHADOW STUDY

SCALE 1:445 @A3



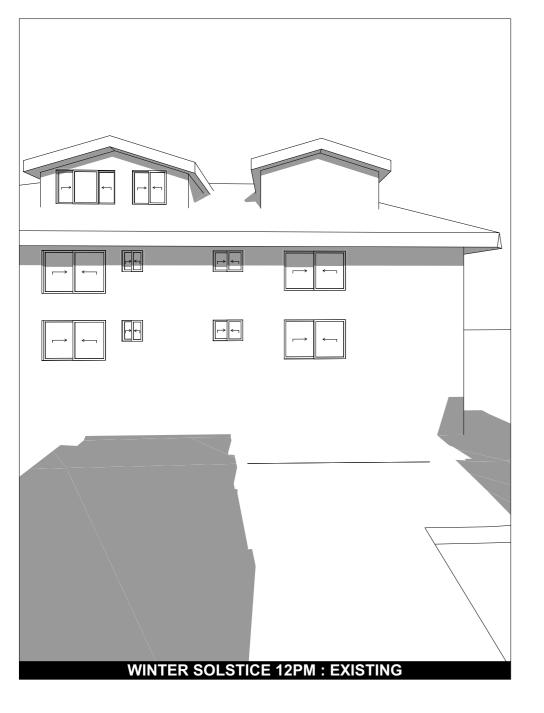

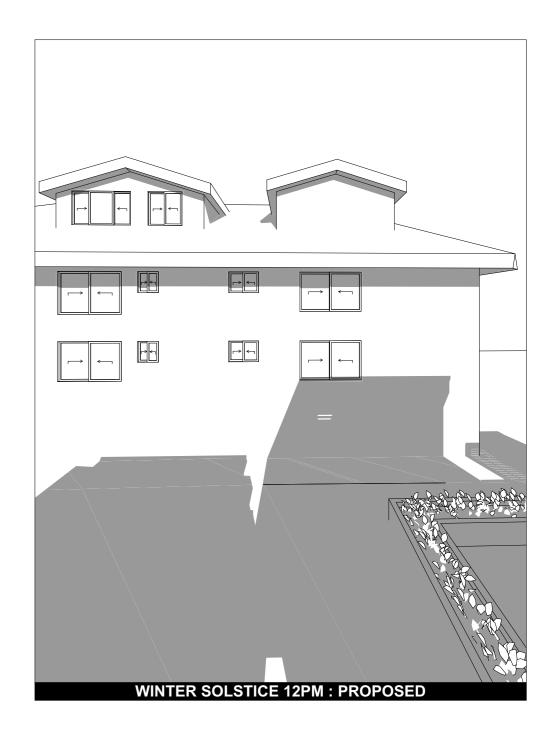

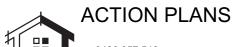

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E	26/02/2020	DESIGN AMENDMENT	LRP	All errors and omissions Builder/Contractor and refer
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AREAS NOT IN SHADOW AREAS IN SHADOW

LEGEND

NOTE: SHADOW PERSPECTIVES NOT TO SCALE

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PROJECT ADDRESS 9 STEINTON STREET MANLY, NSW, 2095

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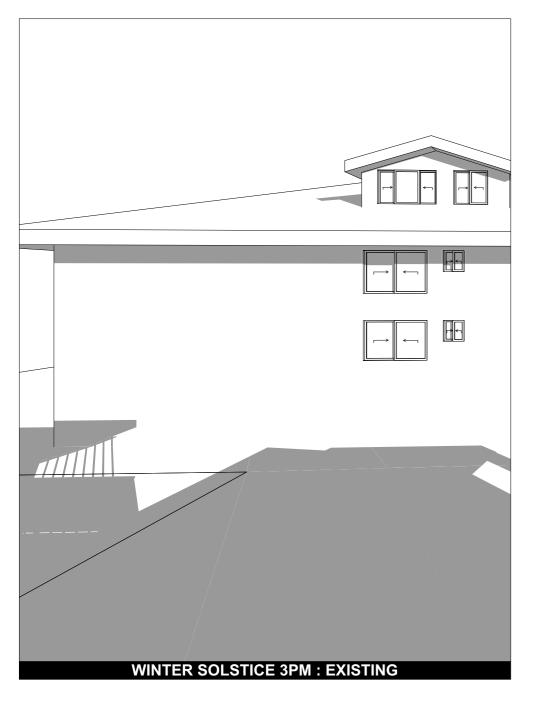
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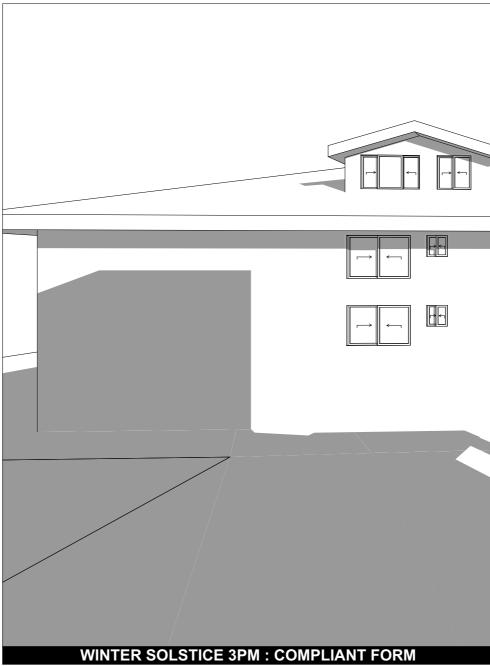
DATE Tuesday, May 5, 2020 DRAWING NAME


3D WINTER SOLSTICE 12PM -45 WHISTLER STREET SUN SHADOW STUDY

SCALE

1:445 @A3





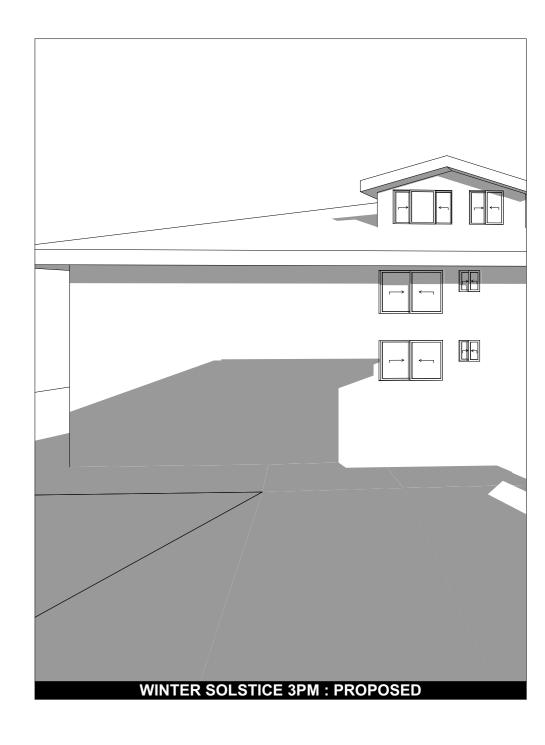



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LEGEND **AREAS NOT IN SHADOW** AREAS IN SHADOW

NOTE: SHADOW PERSPECTIVES NOT TO SCALE

CLIENT

ELLISA BENNETT & GRANT BRITS

PROJECT ADDRESS 9 STEINTON STREET MANLY, NSW, 2095

DRAWING NO.

DA20

DATE Tuesday, May 5, 2020 DRAWING NAME

3D WINTER SOLSTICE 3PM - 45 WHISTLER STREET SUN SHADOW STUDY

SCALE

1:445 @A3

Building Sustainability Index www.basix.nsw.gov.au

Alterations and Additions

Certificate number: A374662

This certificate confirms that the proposed development will meet the NSW government's requirements for sustainability, if it is built in accordance with the commitments set out below. Terms used in this certificate, or in the commitments, have the meaning given by the document entitled "BASIX Alterations and Additions Definitions" dated 06/10/2017 published by the Department. This document is available at www.basix.nsw.gov.au

Secretary
Date of issue: Thursday, 09, April 2020
To be valid, this certificate must be lodged within 3 months of the date of issue.



Project name	9 STEINTON STREET MANLY
Street address	9 STEINTON Street MANLY 2095
Local Government Area	Northern Beaches Council
Plan type and number	Deposited Plan 586416
Lot number	102
Section number	
Project type	
Dwelling type	Attached dwelling house
Type of alteration and addition	My renovation work is valued at \$50,000 or more and does not include a pool (and/or spa).

Certificate Prepared by (please complete before submitting to Council or PCA)
Name / Company Name: Action Plans
ABN (if applicable): 17118297587

BASIX Certificate number: A374662 page 2 / 7

Fixtures and systems	Show on DA Plans	Show on CC/CDC Plans & specs	Certifier Check
Lighting			
The applicant must ensure a minimum of 40% of new or altered light fixtures are fitted with fluorescent, compact fluorescent, or light-emitting-diode (LED) lamps.		✓	~
Fixtures	•		
The applicant must ensure new or altered showerheads have a flow rate no greater than 9 litres per minute or a 3 star water rating.		V	V
The applicant must ensure new or altered toilets have a flow rate no greater than 4 litres per average flush or a minimum 3 star water rating.		✓	V
The applicant must ensure new or altered taps have a flow rate no greater than 9 litres per minute or minimum 3 star water rating.		✓	

BASIX Certificate number: A374662 page 3 / 7

Construction			Show on DA Plans	Show on CC/CDC Plans & specs	Certifier Check
nsulation requirements					
	ation is not required where the area of new con-	 in accordance with the specifications listed in struction is less than 2m2, b) insulation specified 	✓	✓	~
Construction	Additional insulation required (R-value)	Other specifications			
concrete slab on ground floor.	nil				
floor above existing dwelling or building.	nil				
noor above ontolling awalling or building.					1
external wall: brick veneer	R1.16 (or R1.70 including construction)				
	R1.16 (or R1.70 including construction) R1.30 (or R1.70 including construction)				

Legend
In these commitments, "applicant" means the person carrying out the development.
Commitments identified with a "\sigma" in the "Show on DA plans" column must be shown on the plans accompanying the development application for the proposed development (if a development application is to be lodged for the proposed development).
Commitments identified with a *\sigma^* in the *Show on CC/CDC plans & specs* column must be shown in the plans and specifications accompanying the application for a construction certificate / complying development certificate for the proposed development.
Commitments identified with a "\sqrt^" in the "Certifier check" column must be certified by a certifying authority as having been fulfilled, before a final occupation certificate for the development may be issued.

ACTION PLANS
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REV.	DATE	COMMENTS	DRWN	NOTES
А	18/06/19	INITIAL DESIGN PLAN	LRP	This drawing is the copyright of Action Plans and not be altered, reproduced or transmitted in any form or by any means in part or whole with the written permission of Action Plans. Do not scale measure from drawings. Figured dimensions are to be used only.
В	19/07/19	PRE DA	LRP	The Builder/Contractor shall check and verify all levels and dimensions on site prior to commencement of any work, creation of shall check and verify all levels and dimensions on site prior to commencement of any work, creation of shall check and verify all levels and dimensions on site prior to commencement of any work, creation of shall check and verify all levels and dimensions on site prior to commencement of any work, creation of shall check and verify all levels and dimensions on site prior to commencement of any work, creation of shall check and verify all levels and dimensions on site prior to commencement of any work, creation of shall check and verify all levels and dimensions on site prior to commencement of any work, creation of shall check and verify all levels and dimensions on site prior to commencement of any work, creation of shall check and verify all levels and dimensions on site prior to commencement of any work, creation of shall check and verify all levels and dimensions on site prior to commence the shall check and verify all levels and dimensions on site prior to commence the shall check and the shall che
С	24/10/19	PRE DA AMENDMENT	LRP	All errors and omissions are to be verified by the Builder/Contractor and referred to the designer prior to the commencement of works. All window & door dimensions, orientation, glazing materials, opening types, frame types are to be confirmed by a suitably qualified
D	21/02/2020	DESIGN PLAN	LRP	person prior to the ordering of any such materials are to take place. U value takes precedence over glazing type/colour in all cases.
Е	26/02/2020	DESIGN AMENDMENT	LRP	all new glazing must meet the BASIX specified frame and glass type, <u>QR</u> meet the ecified U value and SHGC value.

Glazing requ	irements						Show on DA Plans	Show on CC/CDC Plans & specs	Certifier Check
Windows and	glazed do	ors				<u> </u>			
					hading devices, in accordance with r each window and glazed door.	the specifications listed in the table below.	✓	~	~
The following re	equirements i	must also	be satisf	ied in relatio	n to each window and glazed door:			✓	✓
have a U-value	and a Solar	Heat Gair	n Coeffici	ent (SHGC)		d glass may either match the description, or, le below. Total system U-values and SHGCs		✓	~
					f each eave, pergola, verandah, bal than 2400 mm above the sill.	cony or awning must be no more than 500 mm	✓	✓	~
Pergolas with p	olycarbonate	roof or s	imilar tra	nslucent mat	erial must have a shading coefficien	t of less than 0.35.		✓	✓
External louvres	s and blinds i	must fully	shade th	e window or	glazed door beside which they are	situated when fully drawn or closed.		~	✓
					e window or glazed door above whi ens must not be more than 50 mm.	ch they are situated, unless the pergola also		✓	✓
Overshadowing specified in the						the base of the window and glazed door, as	~	✓	~
Windows an	d glazed o	doors g	lazing ı	equireme	nts		-		
Window / door no.	Orientation	Area of glass inc. frame (m2)	Oversha Height (m)	Distance (m)	Shading device	Frame and glass type			
W01	E	0.85	5.2	1.9	eave/verandah/pergola/balcony >=600 mm	standard aluminium, single clear, (or U-value: 7.63, SHGC: 0.75)			
W02	Е	3.66	5.2	1.9	eave/verandah/pergola/balcony >=600 mm	standard aluminium, single clear, (or U-value: 7.63, SHGC: 0.75)			
W03	E	3.66	3.14	1.9	eave/verandah/pergola/balcony >=600 mm	standard aluminium, single clear, (or U-value: 7.63, SHGC: 0.75)			
W04	S	4.21	0	0	eave/verandah/pergola/balcony	standard aluminium, single clear, (or			

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Glazing requ	irements						Show on DA Plans	Show on CC/CDC Plans & specs	Certifier Check
Window / door	Orientation	Area of	Oversha	adowing	Shading device	Frame and glass type	1		
		glass inc. frame (m2)	Height (m)	Distance (m)					
					>=600 mm	U-value: 7.63, SHGC: 0.75)	11		
W05	E	3.6	3.14	1.9	eave/verandah/pergola/balcony >=600 mm	standard aluminium, single clear, (or U-value: 7.63, SHGC: 0.75)			
W06	E	3.6	3.14	1.9	eave/verandah/pergola/balcony >=600 mm	standard aluminium, single clear, (or U-value: 7.63, SHGC: 0.75)]		
W07	s	1.72	0	0	eave/verandah/pergola/balcony >=600 mm	standard aluminium, single clear, (or U-value: 7.63, SHGC: 0.75)]		
W08	E	1.18	1.6	1.9	eave/verandah/pergola/balcony >=600 mm	standard aluminium, single clear, (or U-value: 7.63, SHGC: 0.75)			
W09	E	1.02	0	0	awning (adjustable) >=900 mm	standard aluminium, single clear, (or U-value: 7.63, SHGC: 0.75)			
W10	E,	2.12	0	0	awning (adjustable) >=900 mm	standard aluminium, single clear, (or U-value: 7.63, SHGC: 0.75)			
W11	E	2.41	0	0	awning (adjustable) >=900 mm	standard aluminium, single clear, (or U-value: 7.63, SHGC: 0.75)			
W12	E	0.39	0	0	awning (adjustable) >=900 mm	standard aluminium, single clear, (or U-value: 7.63, SHGC: 0.75)			
W13	E,	1.1	0	0	awning (adjustable) >=900 mm	standard aluminium, single clear, (or U-value: 7.63, SHGC: 0.75)			
W14	s	1.56	0	0	external louvre/blind (fixed)	standard aluminium, single clear, (or U-value: 7.63, SHGC: 0.75)]		
W15	S	0.34	0	0	eave/verandah/pergola/balcony >=600 mm	standard aluminium, single clear, (or U-value: 7.63, SHGC: 0.75)	11		
D01	S	2.14	0	0	eave/verandah/pergola/balcony >=450 mm	standard aluminium, single clear, (or U-value: 7.63, SHGC: 0.75)]		
D02	S	9.48	0	0	eave/verandah/pergola/balcony	standard aluminium, single clear, (or	11		

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Glazing requi	rements								ow on Plans	Show on CC/CDC Plans & specs	Certifier Check
	Orientation	Area of	Overshadowing		Shading device		Frame and glass type				
		glass inc. frame (m2)	Height (m)	Distance (m)				ш			
					>=600 mm		U-value: 7.63, SHGC: 0.75)				
D03	N	5.88	0	0	eave/verandah/pergola >=600 mm	a/balcony	standard aluminium, single clear, (or U-value: 7.63, SHGC: 0.75)				
The applicant must install the skylights in accordance with the specifications listed in the table below. The following requirements must also be satisfied in relation to each skylight: Each skylight may either match the description, or, have a U-value and a Solar Heat Gain Coefficient (SHGC) no greater than that listed in									✓	> > >	✓ ✓
the table below. Skylights gla		iremen	ts								
Skylight numbe	r Area of g inc. fram		Shading	device		Frame and o	lass type				
S01	0.92		no shad	no shading timber, low-E internal/argon fill/clear external, (or U-value: 2.5, SHGC: 0.456)				71			
S02	0.92		no shading				internal/argon fill/clear external, (or SHGC: 0.456)				
S03	0.92		no shad	ng		timber, low-l	internal/argon fill/clear external, (or				

DRAWING NO. CLIENT

ELLISA BENNETT & GRANT BRITS

PROJECT ADDRESS 9 STEINTON STREET MANLY, NSW, 2095

DA21

DRAWING NAME BASIX COMMITMENTS

DATE

Tuesday, May 5, 2020