


SITE PLAN
SCALE 1:100

1. BUILDER TO CHECK AND CONFIRM ALL NECESSARY DIMENSIONS ON SITE PRIOR TO CONSTRUCTION . DO NOT SCALE THE DRAWING.	PROJE
2. ALL DIMENSIONS THAT RELATE TO SITE BOUNDARIES, SETBACKS AND EASEMENTS ARE SUBJECT TO VERIFICATION BY A SITE SURVEY. 3. ALL WORK TO BE IN ACCORDANCE WITH BUILDING CODE of AUSTRALIA & TO THE SATISFACTION OF LOCAL COUNCIL REQUIREMENTS.	4 PEI
4. ALL TIMBER CONSTRUCTION TO BE IN ACCORDANCE TO TIMBER FRAMING CODE. 5. ROOF WATER & SUB SOIL DRAINAGE TO BE DISPOSED OF IN THE APPROVED MANNER OR AS A DIRECTED BY LOCAL COUNCIL.	MONA
6. ALL ELECTRICAL POWER & LIGHT OUTLETS TO BE DETERMINED BY OWNER.	
7. MAKE GOOD AND REPAIR ALL EXISTING FINISHES DAMAGED BY NEW WORK. REUSE EXISTING MATERIAL WHERE POSSIBLE. 8. ALL NEW DOWN PIPES ARE TO BE CONNECTED TO THE EXISTING STORM WATER SYSTEM.	CLIEN
9. COPYRIGHT OF ALL PLANS BELONGS TO 'HIGH DESIGN' - Architectural Design	


		1-3 909 20	HD	
	CLIENT:	DRAWING No.		ISSUE
	MONA VALE	B. V.		
TS.	4 PEITA CRESCENT	DRAWN BY:	CHECKED	
RVEY.		Sep. 2020		
	PROJECT ADDRESS:	DATE		
	DBU IECT VUUDESS:	DATE		




"HIGH DESIGN" - ABN 51 476 054 183 architectural design and drafting service mobile: fax:
041 3389 036 9981 55 56
E-mail: hd@highdesign.com.au
Web: highdesign.com.au

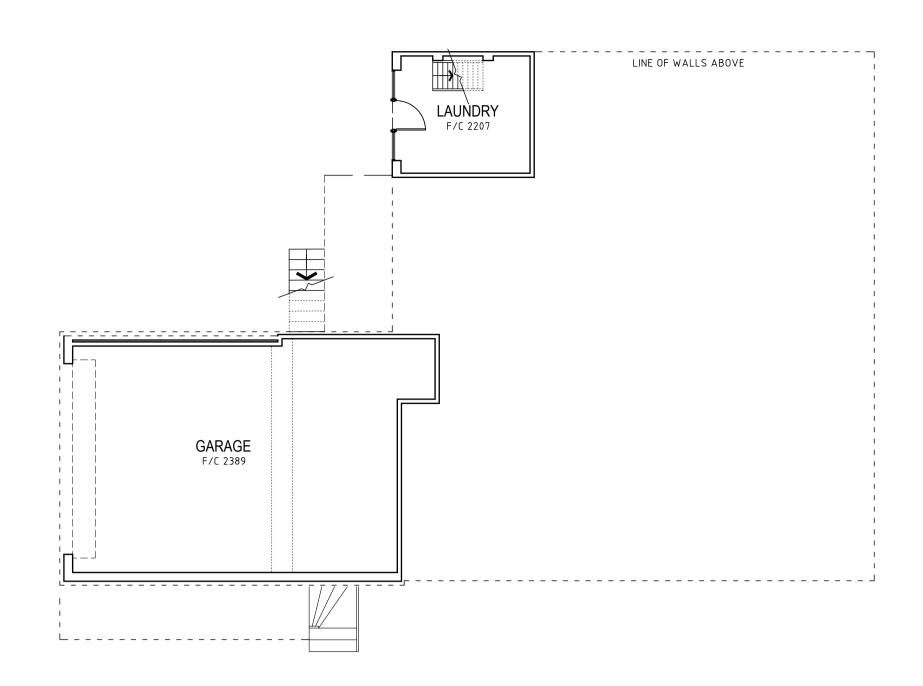



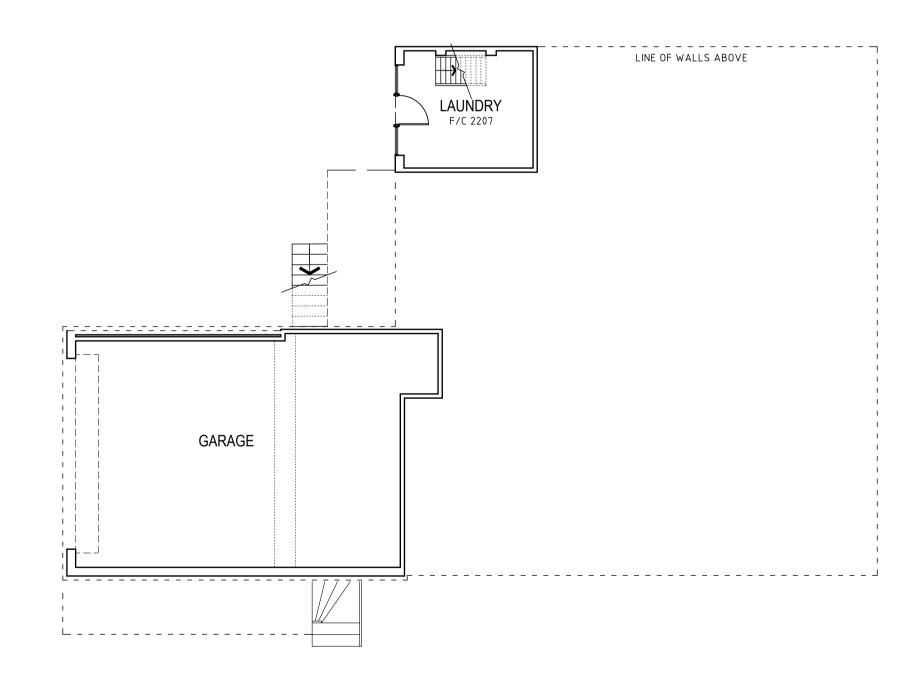


EXISTING LOWER GROUND FLOOR PLAN SCALE 1:100

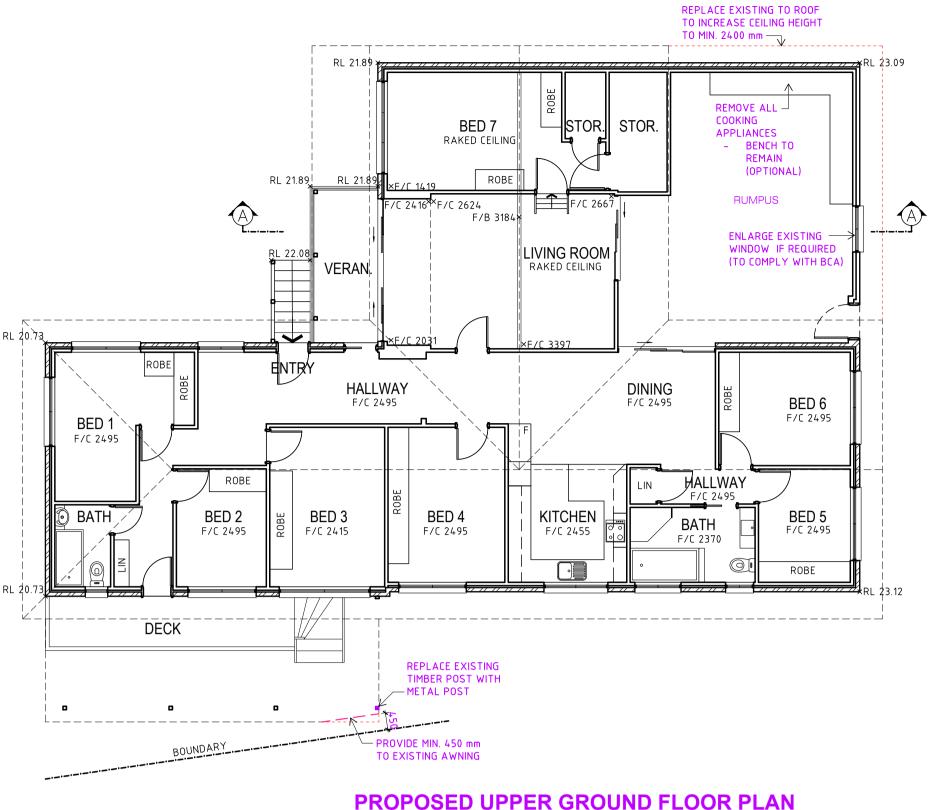



PROPOSED UPPER GROUND FLOOR PLAN

SCALE 1:100

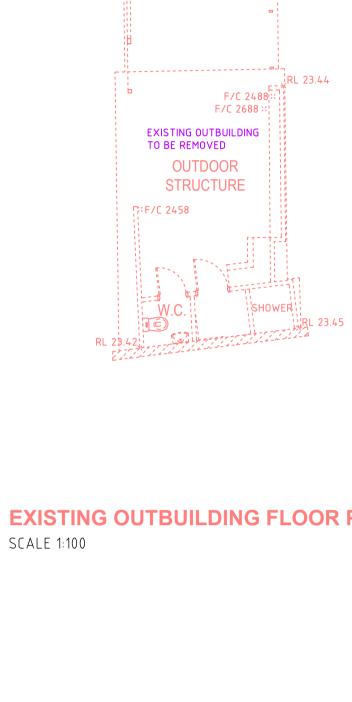

EXISTING OUTBUILDING FLOOR PLAN

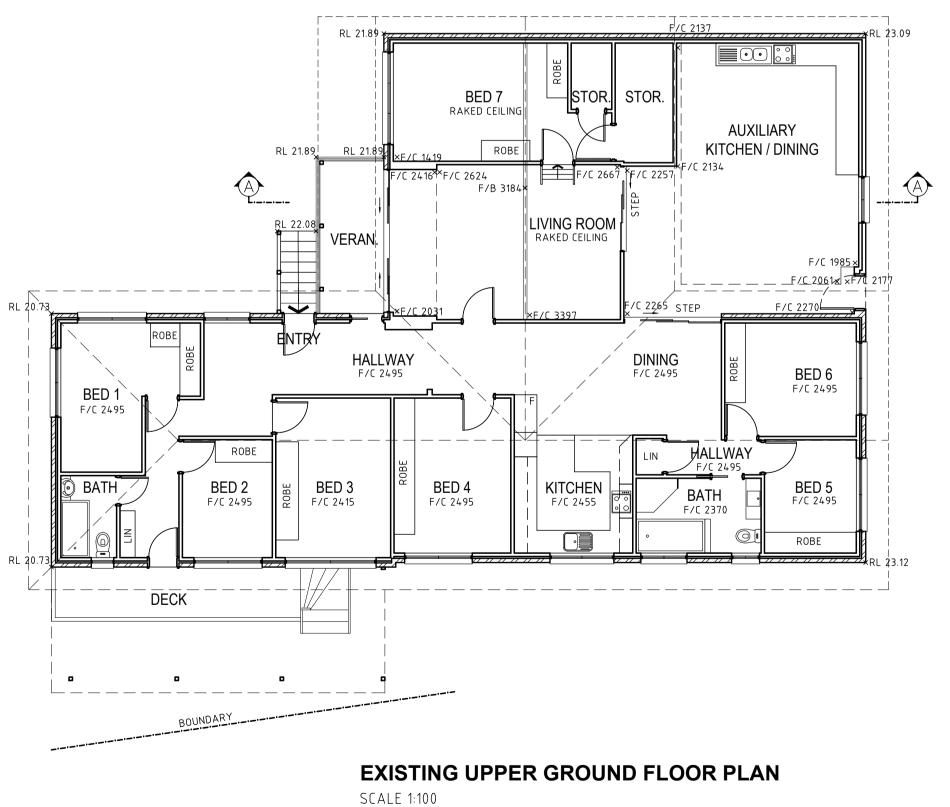

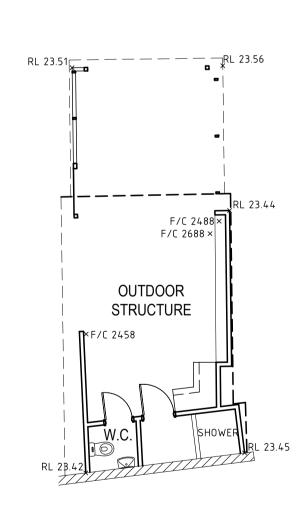

EXISTING OUTBUILDING FLOOR PLAN

SCALE 1:100


SITE AREA 696.7 sqm EXISTING LANDSCAPE AREA 154sqm OR 23% (INCLUDING 6 % PAVED AREA) PROPOSED LANDSCAPE AREA 207sqm OR 29.6% (INCLUDING 6 % PAVED AREA)

1. BUILDER TO CHECK AND CONFIRM ALL NECESSARY DIMENSIONS ON SITE PRIOR TO CONSTRUCTION . DO NOT SCALE THE DRAWING.	PROJEC [*]
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7. MAKE GOOD AND REPAIR ALL EXISTING FINISHES DAMAGED BY NEW WORK. REUSE EXISTING MATERIAL WHERE POSSIBLE.	CLIENT:
8. ALL NEW DOWN PIPES ARE TO BE CONNECTED TO THE EXISTING STORM WATER SYSTEM.	
9. COPYRIGHT OF ALL PLANS BELONGS TO 'HIGH DESIGN' - Architectural Design	

,	PROJECT ADDRESS:	DATE Sep. 2020		
•	4 PEITA CRESCENT MONA VALE	DRAWN BY: B. V.	CHECKED	
	CLIENT:	DRAWING No. 2-3 909 20		ISSUE




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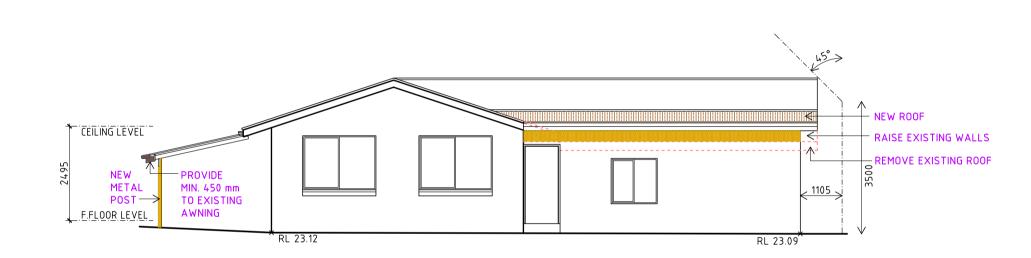
NORTH WEST ELEVATION

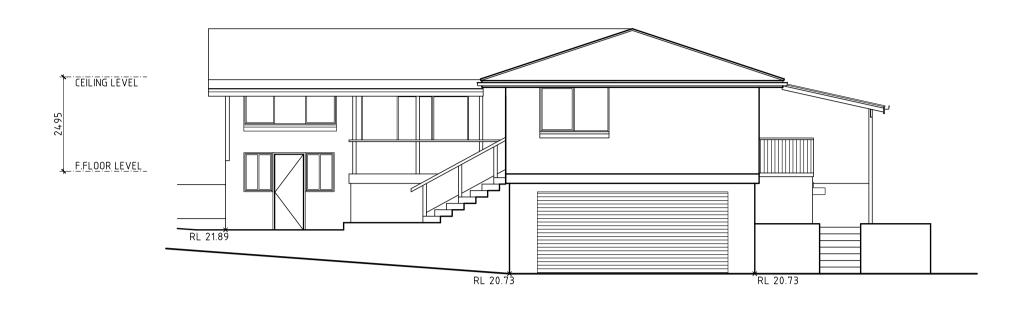
SCALE 1:100



SOUTH WEST ELEVATION

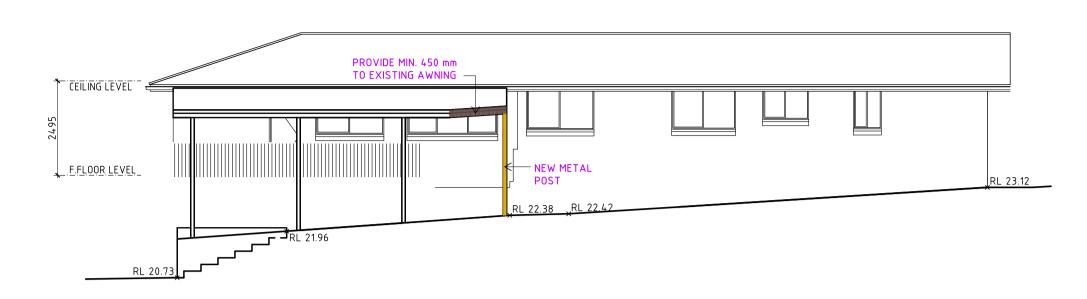SCALE 1:100



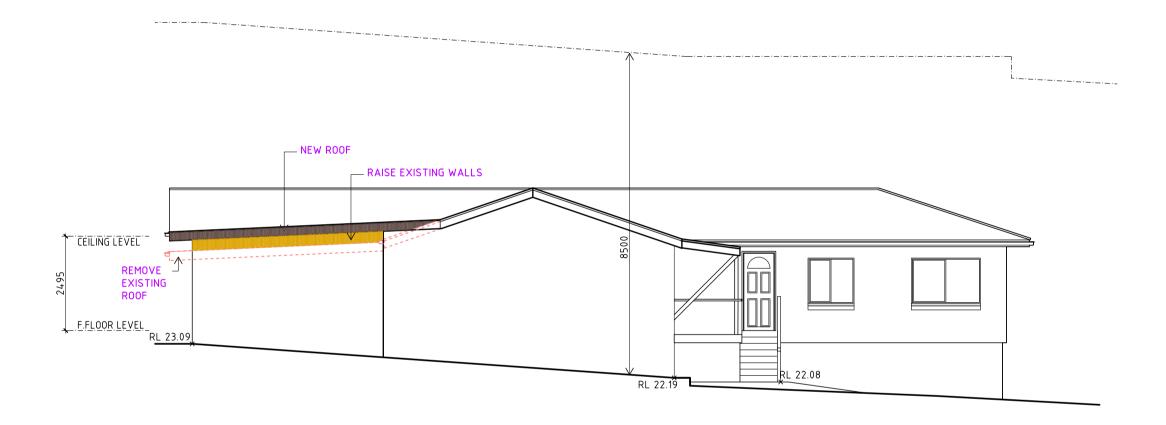


SOUTH EAST ELEVATION

SCALE 1:100

NORTH EAST ELEVATION

SCALE 1:100

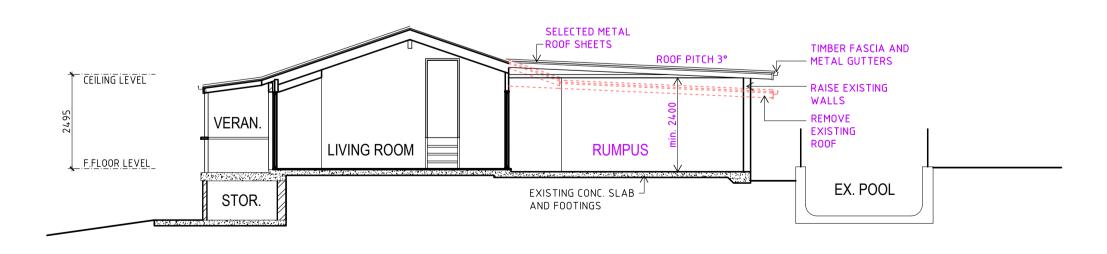

SECTION A-A

SCALE 1:100

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