

NOTES

WORKS.

SPECIFICATON.

CONTRACTORS EXPENSE.

1. THESE DRAWINGS ARE TO BE READ IN CONJUNCTION WITH THE ARCHITECTURAL DRAWINGS, STRUCTURAL DRAWINGS AND THE

2. PRIOR TO COMMENCEMENT OF WORKS THE CONTRACTOR SHALL

SATISFY HIMSELF OF THE CORRECT LOCATION OF EXISTING

SERVICES WHETHER INDICATED OR NOT ON THE PLANS. ANY

DAMAGE TO EXISTING SERVICES SHALL BE RECTIFIED AT THE

3. TRAFFIC MANAGEMENT MEASURES HAVE TO BE IMPLEMENTED

AND MAINTAINED DURING CONSTRUCTON, ALL IN ACCORDANCE

WITH COUNCIL'S REQUIREMENTS. THE CONTRACTOR SHALL

MAINTAIN SAFE PEDESTRIAN ACCESS ALONG THE FOOTPATH.

4. THE CONTRACTOR SHALL EFFECT TEMPORARY DRAINAGE

MEASURES TO AVOID LOCALISED PONDING OF SURFACE RUN-OFF

5. REFER TO ARCHITECT'S DRAWINGS FOR ALL DETAILS (LEVELS,

GRADING ETC.) OF DRIVEWAYS, CONCRETE AND PAVED AREAS,

6. REFER TO LANDSCAPE ARCHITECT'S DRAWINGS FOR DETAILS

7. ALL SWD PIPES ARE UPVC AT 1.0% MINIMUM GRADE (UNO).

9. ALL PITS LOCATED IN TRAFFICABLE AREAS, (IE, DRIVEWAYS)

10. PROVIDE STEP IRONS TO ALL PITS GREATER THAN 1.2m DEEP.

11. THE CONTRACTOR SHALL IMPLEMENT ALL SOIL EROSION AND

HAZARD AREAS SUCH AS DRAINAGE LINES. THIS TOPSOIL IS TO

13. THE CONTRACTOR SHALL REGULARLY MAINTAIN ALL SEDIMENT

AND EROSION CONTROL DEVICES AND REMOVE ACCUMULATED SILT FROM SUCH DEVICES. ALL SILT REMOVED SHALL BE DISPOSED OF

DISTURBED AREAS ARE REVEGETATED AND FURTHER AS MAY BE

LEGEND

NEW REDUCED LEVEL

GROUND FLOOR LEVEL

REFER TO PIPE SEHEDULE

FINISH FLOOR LEVEL

SURFACE INLET PIT

RAIN WATER HEAD

PIT: SIZE AS MARKED

W:200mm x D:200mm

GRATED DRAIN

GROUND FALL

OVERLAND FLOW

SEALED PIT: SIZE AS MARKED

UPVC PIPE TO RAIN WATER TANK

UPVC DRAINAGE PIPE IN GROUND

RWT OVERFLOW PIPE & OUTLET PIPE

PIPE LABEL

DOWNPIPE

14. THE CONTRACTOR SHALL MAINTAIN DUST CONTROL UNTIL

SEDIMENT CONTROL MEASURES PRIOR TO COMMENCEMENT OF

12. TOPSOIL SHALL BE STRIPPED DN STOCKPILED OUTSIDE

BE RESPREAD LATER ON AREAS TO BE REVEGETATED.

AS DIRECTED BY THE SUPERINTENDENT. THE PERIOD FOR MAINTAINING THESE DEVICES SHALL BE AT LEAST UNTIL ALL

DIRECTED BY THE SUPERINTENDENT OR COUNCIL.

FINAL COMPLETION OF WORKS.

RL 00.000

GFL. 00.00

FFL. 00.00

A,B,C,D, etc.

PIT P1

DP

 $\square$  RWH

8. SWD PITS CAN BE PRE-CAST SIZED AS FOLLOWS:

TO HAVE MEDIUM DUTY GRATED COVERS SUITABLE FOR

WITHSTANDING LOADS ASSOCIATED WITH SMALL TRUCKS.

AND RETAINING WALL TYPES AND LOCATIONS.


AND EXTENT OF ALL LANDSCAPED AREAS.

450mm SQ. UP TO 600mm DEEP

600mm SQ. UP TO 1000mm DEEP

## SECTION-TYPICAL SURFACE INLET PIT

TYPICAL FOR ALL PITS IN NON-TRAFFIC AREAS

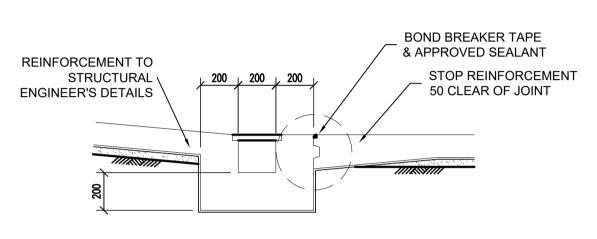

SECTION-TYPICAL GRATED DRAIN

# ROOF DRAINAGE PLAN

1:100 @ A1

ALL DRAINAGE LINES SHALL BE UPVC (CLASS SH) STORMWATER DRAINAGE PIPE, UNO.

ALL DRAINAGE LINES SHALL BE LAID @ 1% FALL MIN, UNO. FIRST FLUSH RAINWATER DEVICES TO BE FITTED TO DRAINAGE LINES TO BUILDER'S DETAIL, TYPICAL MINIMUM EFFECTIVE EAVES GUTTER  $SIZE = 6700 \text{ mm}^2$ 

MINIMUM EFFECTIVE EAVES GUTTER SLOPE = 1:500

THE FOLLOWING SYMBOLS & ABBREVIATIONS HAVE BEEN USED:

DP =  $\emptyset$ 100, UNO.

FD = FLOOR OUTLET, REFER TO DETAIL

SIP = SURFACE INLET PIT (NO LINTEL)

100Ø = Ø100 CHARGED LINE IP = Ø150 INSPECTION POINT

RWH = RAIN WATER HEAD

RWO = RAIN WATER OUTLET (300 x 300)

FG = FLOOR GULLY Ø150 = RAINWATER SPREADER


RL 16.85 = PROPOSED FINISHED SURFACE LEVEL **BOX GUTTER** OVERFLOW **ROOF SLOPE** SOLE OF BOX SOLE OF GUTTER BEYOND BOX GUTTER DRAINAGE SUMP FOR SIZES REFER TABLE SECTION **ELEVATION** 

TYPICAL BOX GUTTER DETAIL WITH SUMP OVERFLOW

BOX GUTTER, RAINWATER HEAD & SUMP SIZING SCHEDULE OVERFLOW TO SUMP | DOWNPIPE Ø mm NODE BOX GUTTER SIZE RAINWATER HEAD SIZE SUMP SIZE 200L X 150D 200W X 100H BG1 300W x 150D 150Lx300Wx200H

#### PLEASE NOTE - AS PER BASIX REPORT

- MINIMUM TANK SIZE TO BE 1000 LITRES - MINIMUM ROOF CATCHMENT AREA OF 100 SQUARE METRES TO BE COLLECTED BY RAINWATER TANK

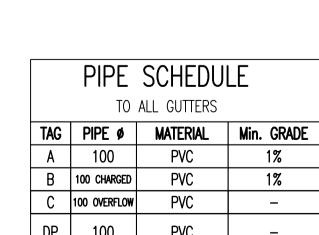

	חוחר	COLIEDIU	_	
	PIPE	SCHEDU	<u>_</u> L	
TO ALL GUTTERS				
TAG	PIPE Ø	MATERIAL	Min. GRADE	
Α	100	PVC	1%	
В	100 CHARGED	PVC	1%	
С	100 OVERFLOW	PVC	_	
DP	100	PVC	_	

D	MINOR AMENDMENTS	06/10/2022		
С	MINOR AMENDMENTS	05/10/2022		
В	MINOR AMENDMENTS	27/09/2022		

20/09/2022

ISSUE DATE

ISSUE

ISSUED TO

PRELIMINARY DESIGN

AMENDMENT

<sup>+</sup> 35.798



<sup>™</sup>DP+RWH

SUITE 303 / 29-31 LEXINGTON DRIVE NORWEST BUSINESS PARK, BELLA VISTA N.S.W. 2153

ALL CORRESPONDENCE TO: P.O. BOX 6080 BAULKHAM HILLS BC **BAULKHAM HILLS NSW 2153** 

PH. 8814 6191 FAX 8814 5301 MOB. 0425 270 333 EMAIL andrew@camconsulting.com.au

PROPOSED DEVELOPMENT LOT 9, 6 ORCHARD STREET WARRIEWOOD SKYCORP ARCHITECT / PROJECT MANAGER


PTI ARCHITECTURE


RAINWATER HEAD


SECTION NTS


DRAWING TITLE	
STORMWATER	LAYOU


SCALES A1 - 1:100		DESIGNED A.C.	DRAFTED M.W.	
DRAWING NO.	00000F CW 100	APPROVED		REVISION
	C22065 -SW 100	A.C.		D

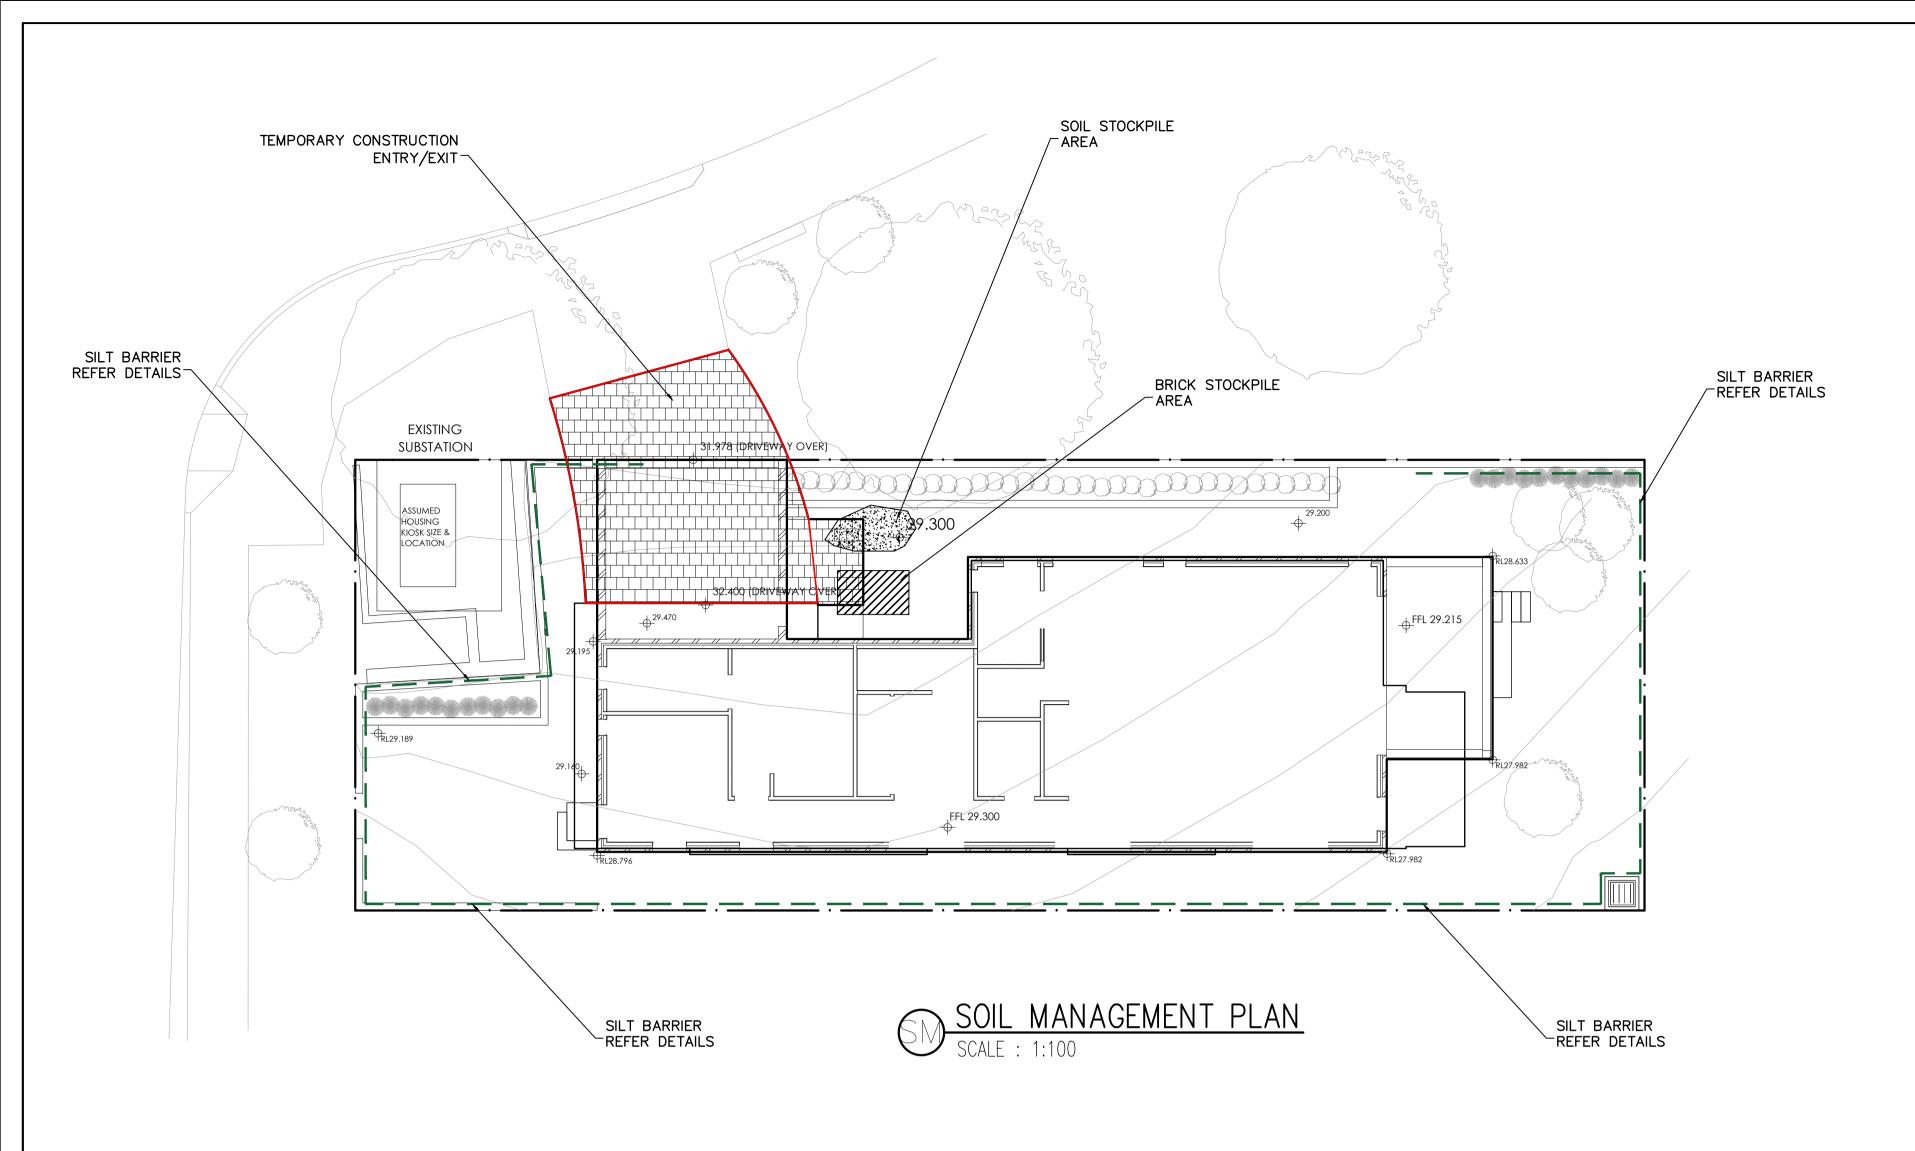


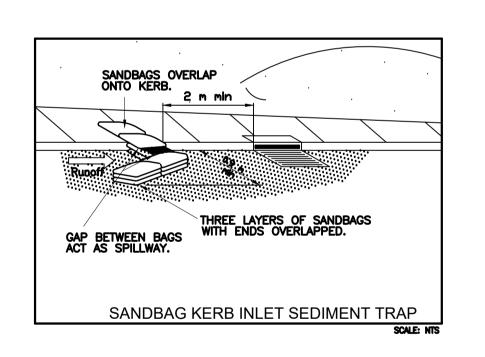

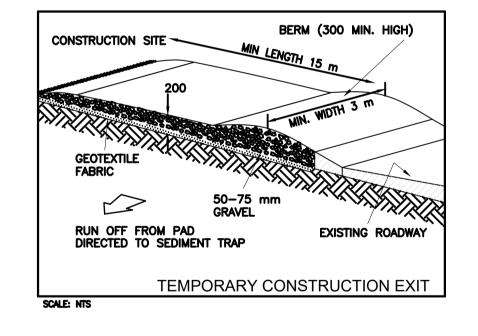

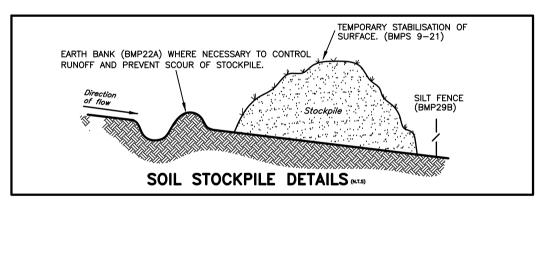

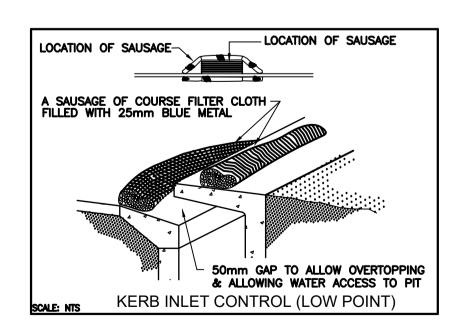

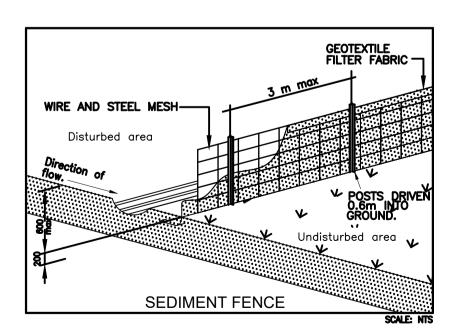




RAINWATER SIGN

#### SOIL EROSION CONTROL INSTRUCTIONS

- EARTH BATTERS WILL BE CONSTRUCTED WITH AS LOW AS A GRADIENT AS PRACTICABLE BUT NO STEEPER, UNLESS OTHERWISE NTOED, THAN:
- -2(H):1(V) WHERE SLOPE LENGTH LESS THAN 12 METRES -2.5(H):1(V) WHERE SLOPE LENGTH BETWEEN 12 & 16 METRES -3(H):1(V) WHERE SLOPE LENGTH BETWEEN 16 & 20 METRES -4(H):1(V) WHERE SLOPE LENGTH GREATER THAN 20 METRES
- ALL WATERWAYS, DRAINS, SPILLWAYS AND THEIR OUTLETS WILL BE CONSTRUCTED TO BE STABLE IN AT LEAST THE 1:20 YEAR ARI, TIME OF CONCENTRATION STORM EVENT.
- WATERWAYS AND OTHER AREAS SUBJECT TO CONCENTRATED FLOWS AFTER CONSTRUCTION ARE TO HAVE A MAXIMUM GROUNDCOVER C-FACTOR OF 0.05 (70% GROUND COVER) WITHIN 10 WORKING DAYS FROM COMPLETION OFFORMATION. FLOW VELOCITIES ARE TO BE LIMITED TO THOSE SHOWN INTABLE 5-1 OF "MANAGING URBAN STORMWATER - SOILS AND CONSTRUCTION DEPT OF HOUSING 1998 (BLUE BOOK). FOOT
- AND VEHICULAR TRAFFIC WILL BE PROHIBITED IN THÉSE AREAS. STOCKPILES AFTER CONSTRUCTION ARE TO HAVE A MAXIMUM GROUND COVER C-FATOR OF 0.1 (60% GROUND COVER) WITHIN 10 WORKING DAYS FROM COMPLETION OF FORMATION.
- ALL LANDS, INCLUDING WATERWAYS AND STOCKPILES, DURING CONSTRUCTION ARE TO HAVE A MAXIMUM GROUND COVER C-FACTOR OF 0.15 (50% GROUND COVER) WITHIN 20 WORKING DAYS FROM INACTIVITY EVEN THOUGH WORKS MAY CONTINUE
- FOR AREAS OF SHEET FLOW USE THE FOLLOWING GROUND COVER PLANT SPECIES FOR TEMPORARY COVER: JAPANESE MILLET 20KG/HA AND OATS.
- PERMANENT REHABILITATION OF LANDS AFTER CONSTRUCTION WILL ACHIEVE A GROUND COVER C-FACTOR OF LESS THAN 0.1 AND LESS THAN 0.05 WITHIN 60 DAYS. NEWLY PLANTED LANDS WILL BE WATERED REGULARLY UNTIL AN EFFECTIVE COVER IS ESTABLISHED AND PLANTS ARE GROWING VIGOROUSLY FOLLOW-UP SEED AND FERTILISER WILL BE APPLIED AS 20KG/HA
- REVEGATATION SHOULD BE AIMED AT RE-ESTABLISHING NATURAL SPECIES. NATURAL SURFACE SOILS SHOULD BE REPLACED AND NON-PERSISTANT ANNUAL COVER SROPS SHOULS BE USED.

#### **DUST CONTROL INSTRUCTIONS**

- ALL STOCKPILED MATERIAL OR SEDIMENT COLLECTION TO BE SPRAYED BY LIGHTLY WIDE ANGLED WATER
- THIS TEMPORARY MECHANICAL METHOD CONFINES AND SETTLES THE DUST FROM THE AIR BY DUST AND WATER PARTICLE ADHESION. WATER IS SPRAYED THROUGH NOZZELS OVER THE

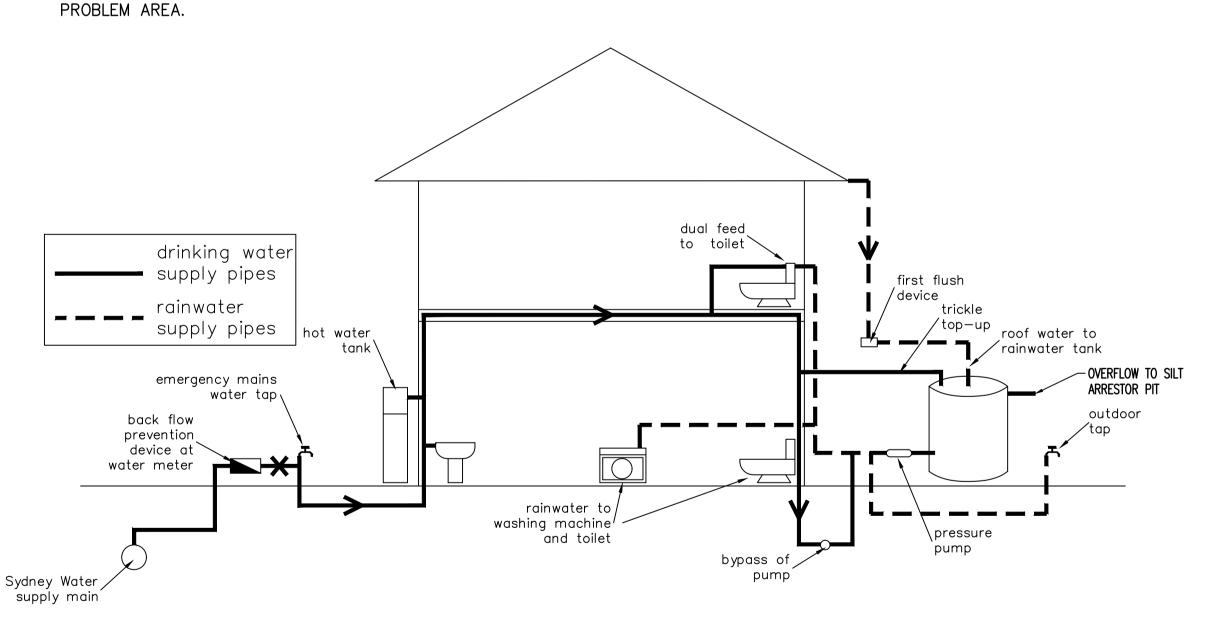

### RAINWATER TANK EXPLANATORY DIAGRAM

SCALE : NTS

NOTE:

1.TANK WATER IS NOT RECOMMENDED FOR HUMAN CONSUMPTION. 2.A SIGN STATING NOT FOR DRINKING MUST BE AFFIXED TO THE TANK AND OR TAP FIXTURE

3.ANY PUMP INSTALLED FOR THE RAINWATER TANKS IS TO BE NO LOUDER THAN 5dB(A) ABOVE

BACKGROUND NOISE LEVELS

					SUITE 303 / 29-31 LEXINGTON DRIVE NORWEST BUSINESS PARK, BELLA VISTA N.S.W. 2153	PROJECT PROPOSED DEVELOPMENT LOT 9, 6 ORCHARD STREET	SOIL MANAGEMENT PLAN		
D	MINOR AMENDMENTS	06/10/2022			ALL CORRESPONDENCE TO:	WARRIEWOOD			
С	MINOR AMENDMENTS	05/10/2022			P.O. BOX 6080 BAULKHAM HILLS BC	CLIENT	CONTR	DESIGNED	DRAFTED
В	MINOR AMENDMENTS	27/09/2022			BAULKHAM HILLS NSW 2153	SKYCORP	A1 - 1:100	A C	M W
A	PRELIMINARY DESIGN	20/09/2022		CONSULTING	PH. 8814 6191 FAX 8814 5301 MOB. 0425 270 333	ARCHITECT / PROJECT MANAGER	DRAWING NO.	APPROVED	REVISION
REVISION	AMENDMENT	ISSUE DATE ISSUE	ISSUED TO	ISSUE DATE STRUCTURAL & CIVIL ENGINEERS	EMAIL andrew@camconsulting.com.au	PTI ARCHITECTURE	C22065 -SW 101	A.C.	D