- Approved means by the 'The Relevant Local Authority'or 'Council'. - The Owner will directly pay the fees associated with the following: building approval from council, footpath and kerb deposits with the local council, insurance fee to Building Services Corporation, Long Service Leave levy fee and approval fee by water and sewerage authority. All other fees are to be paid by the builder. The amount of any local authority deposits which are forfeited due to damage or other cause will be deducted from the payments due to the builder.
- The Builder is to provide at his/her own expense adequate Public Risk Insurance and arrange indemnification under the Workers Compensation Act. Works insurance to be as stated in the contract conditions.
- All tenderers are to visit the site to satisfy themselves as to the nature and extent of the Works, facilities available and difficulties entailed in the works as Variations will not be allowed due to work arising owing to nealect of this clause.
- All work and materials to comply with the current Australian Standards at the time of commencement where applicable.
- at the time of commencement where applicable.

 These drawings shall be read in conjunction with all structural and other consultants drawings and specifications and with any such written instructios as may be issued during the course of the contract.

 Set out dimensions shown on this drawing shall be varified by the builder on site before commencement of any work. Dimensions shall not be obtained by scaling the drawings. Use only figured dimensions. All dimension are in millimetres.
- In millimetres.

 The Builder is to ensure all construction, levels and other items comply with the conditions of the Building Approval.

 The Builder is to comply with all Ordinances, Local Authority regulations and the requirements of all services supply authorities having jurisdiction over the works.
- All new downpipes are to be connected to the existing Stormwater system that discharges to an existing Council Stormwater system.
- All Power and Stormwater outlet locations shall be determined on site by the Owner.
- Any détailing in addition to what is supplied shall be resolved between the Owner and the Builder to the Owner approval, except for any structural details or design which is supplied by the engineer.
- All timber sizes and concrete details to be confirmed by the builder prior to commencement of any work.
- Any work indicated on the plans but not specified, and any item not shown on the plan which is obviously necessary as part of proper construction and/or finish is to be considered as shown and specified, and is to be done as part of the contract.
- Variations will not be permitted without the written consent of the Owner.
- The Builder shall provide sediment and siltration control measures as required by council and maintain them throughout the duration of the works. A legible copy of the plans bearing approval stamps must be maintained on the job at all times. Hours of construction shall be restricted to the
- times as required by the Building Approval.

 The Builder is to arrange for all inspections required by the authorities and lending institutions to their requirements.
- The Builder is to obtain approval for interruptions to existing services and
- Ine Builder is to obtain approval for interruptions to existing services and number of interruptions. Any interruptions with existing services and equipment to be to by appropriately skilled tradesmen.
 The Builder shall restore, reinstate or replace any damage caused to existing structures or landscaping by construction work or workmen.
 Provide protection to existing trees to remain as required by Approval Conditions.

FURLONG RESIDENCE


DEVELOPMENT APPLICATION 37 HEATHER STREET, WHEELER HEIGHTS

for A + L FURLONG

Sheet List

DA-00 DA-01 DA-02 DA-03 DA-04 DA-05 DA-06 DA-07 DA-08 DA-09 DA-10 DA-11 DA-11 DA-12 DA-13 DA-14	Title Sheet Site Plan + Analysis Ground Floor Plan First Floor Plan Roof Plan North Elevation East Elevation West Elevation Sections Shadow Diagram Sediment + Erosion Plan Stormwater Concept Plan Landscape Plan Driveway Longsection Notification Plan
C-01 C-02	Example of Finishes - Exterio Example of Finishes - Exterio



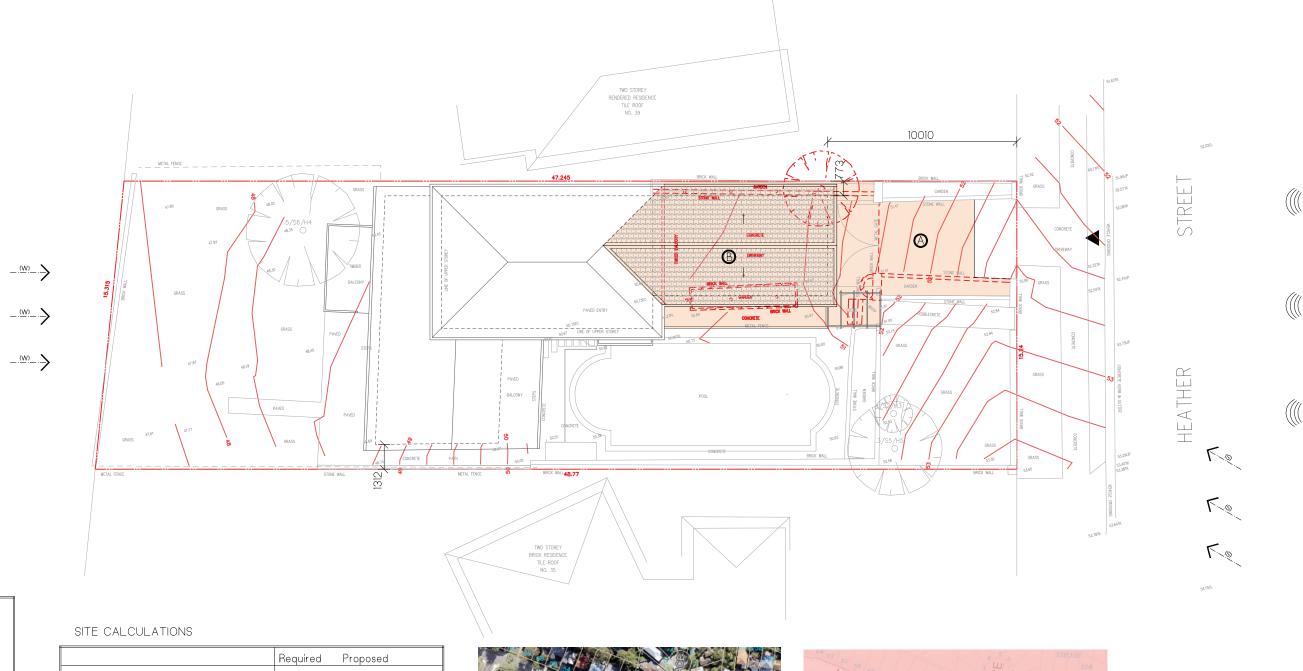

KEY CAR ENTRY POINT BOUNDARY ← .__(S) PREVAILING WINDS (summer) - PREVAILING WINDS (winter) WINDOW TO LIVING SPACE IN ADJACENT DWELLING EXISTING CONTOURS SLOPE OF LAND ROAD NOISE

EXISTING DRIVEWAY PROPOSED ROOF ALTERATIONS

	Required	Proposed	
Site Area	727.1m2		
Floor Space Ratio	N/A	N/A	
Setbacks (Ground) -East (side) -West (side) -South (rear) -North (front)	900mm 900mm 6000mm 6500mm	1312mm (existing) 773mm (existing) 10926mm 10010mm	
EXISTING RESIDENTIAL AREA PROPOSED RESIDENTIAL AREA EXISTING HARD SURFACE AREA PROPOSED HARD SURFACE AREA EXISTING LANDSCAPED AREA	140.lm2 188.8m2 461.0m2 412.0m2 266.lm2		
PROPOSED LANDSCAPED AREA	290.84m2 315.lm2		







Zoning Map of 37 Heather Street, Wheeler Heights






COPYRIGHT- THIS DOCUMENT IS AND SHALL REMAIN THE PROPERT OF PITTWATER DESIGN AND DRAFT.


PITTWATER DESIGN AND DRAFT CONDITIONS OF USE:
THIS DOCUMENT MAY ONLY BE USED FOR THE PURPOSE OF WHICH IT WAS COMMISIONED AND IN ACCORDANCE WITH THE TERMS OF ENGAGEMENT FOR COMMISSION.
ALL WORKS ARE TO BE IN ACCORDANCE WITH AUSTRALIAN STANDARDS, THE BUILDING CODE OF AUSTRALIA, OTHER RELEVANT CODES AND MANUFACTURERS' SPECIFICATIONS.
DO NOT SCALLE FROM DRAWINGS. BULDER/CONTRACTORS ARE TO VERIFYALL DIMENSIONS PRIOR TO COMMENCEMENT OF SITE WORK OR OFF-SITE FABRICATION.


ISSUE PRELIM 1 2	DATE 14.09.19 22.10.19 04.11.19	All C

AMENDMENT
Concept issue
Concept Design issue
Development Application issue

		0 1 2	T		
ADDRESS:	SHEET TITLE:	*****		DATE	
37 HEATHER STREET, WHEELER HEIGHTS	EIGHTS SITE PLAN + ANALYSIS			04.09.19	
A + L. FURLONG	scale: 1:200 @ A3	PROJECT No: 1825	DWG No: DA-01	ISSUE 1	

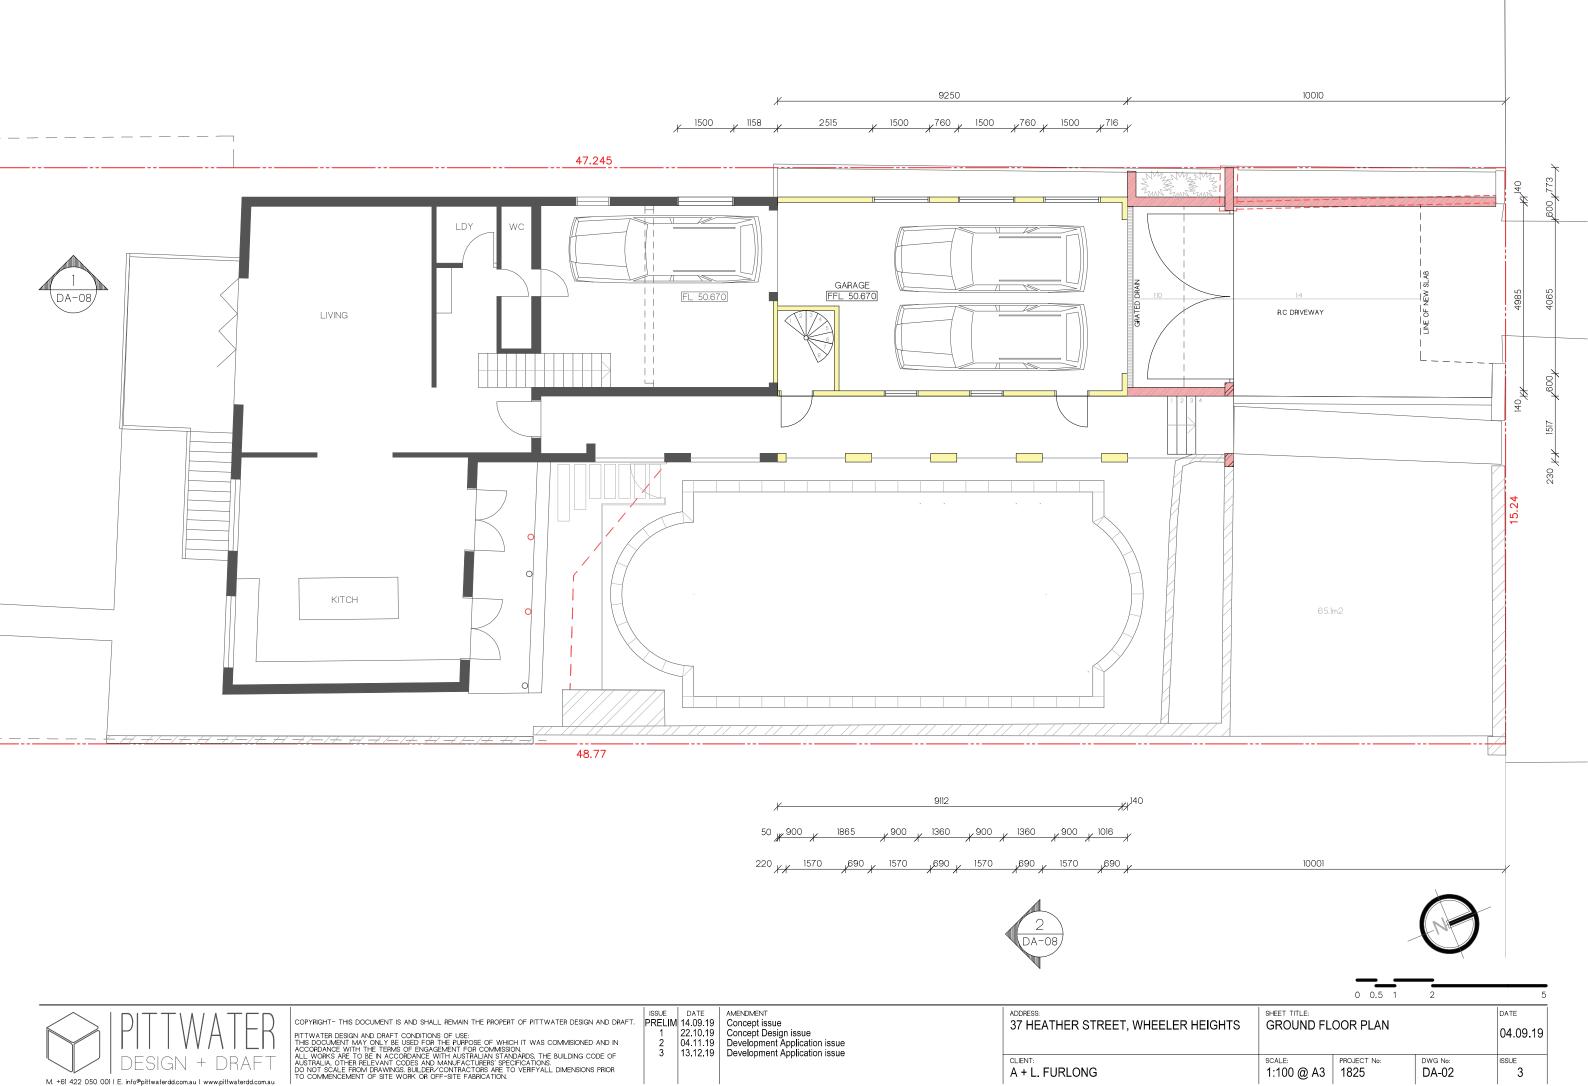

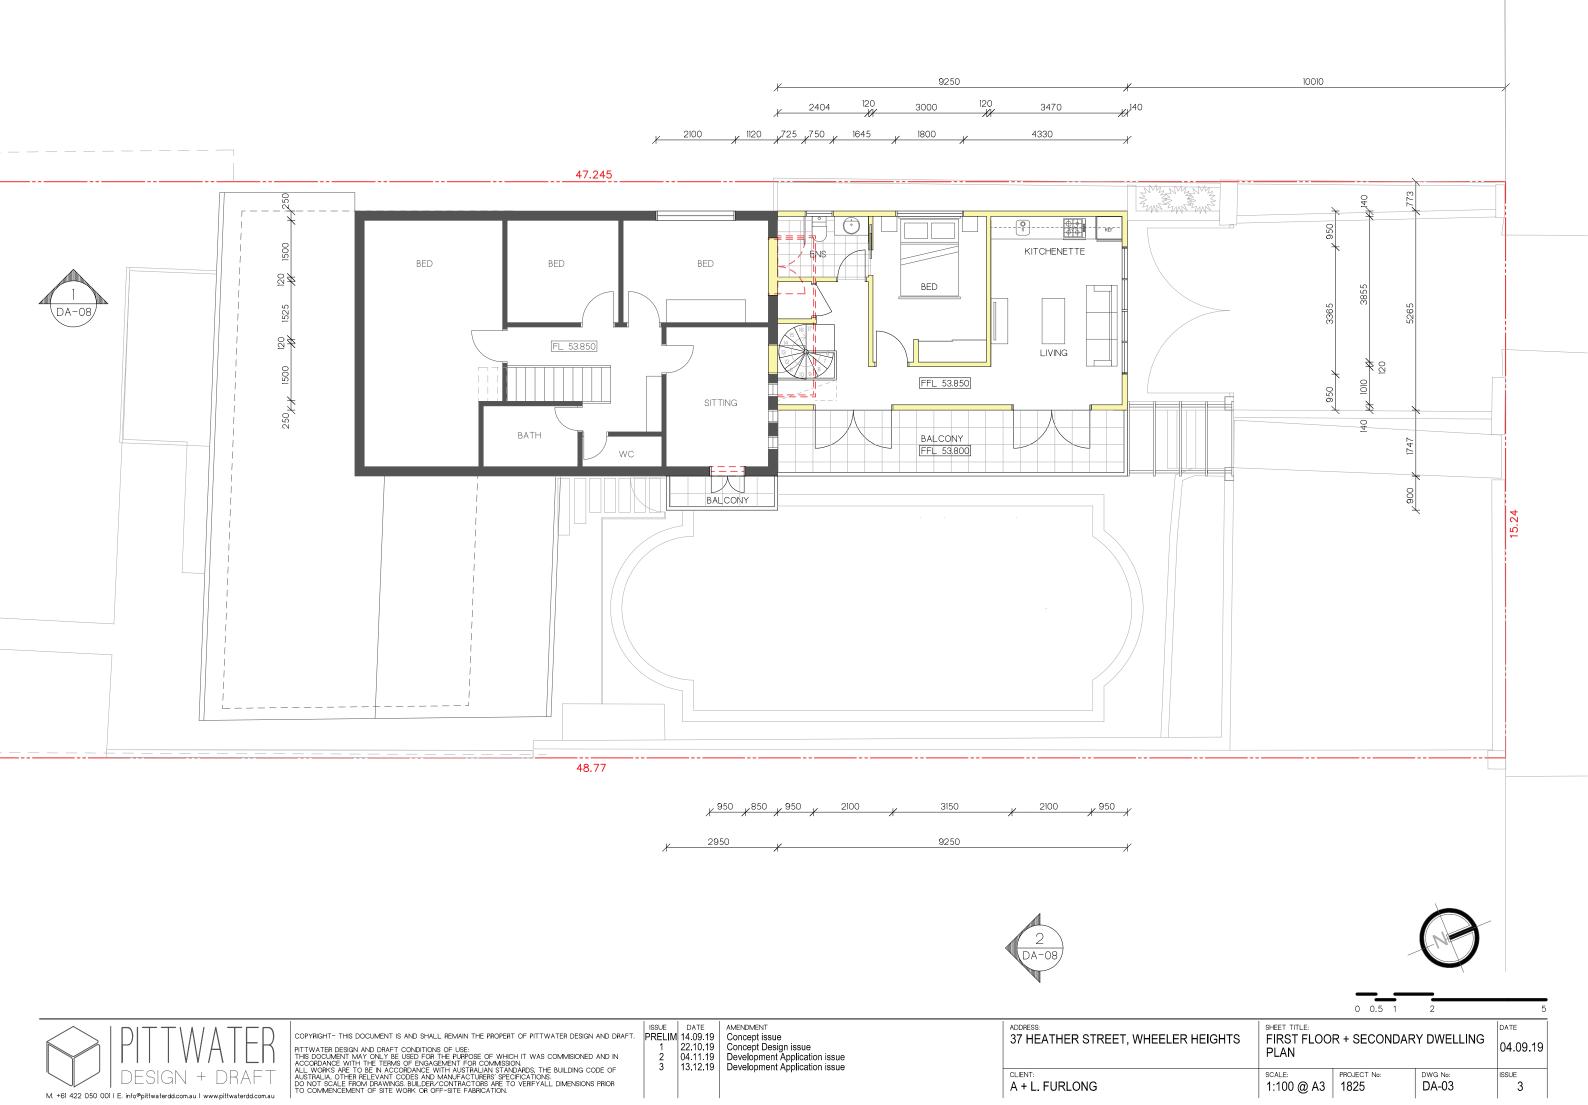

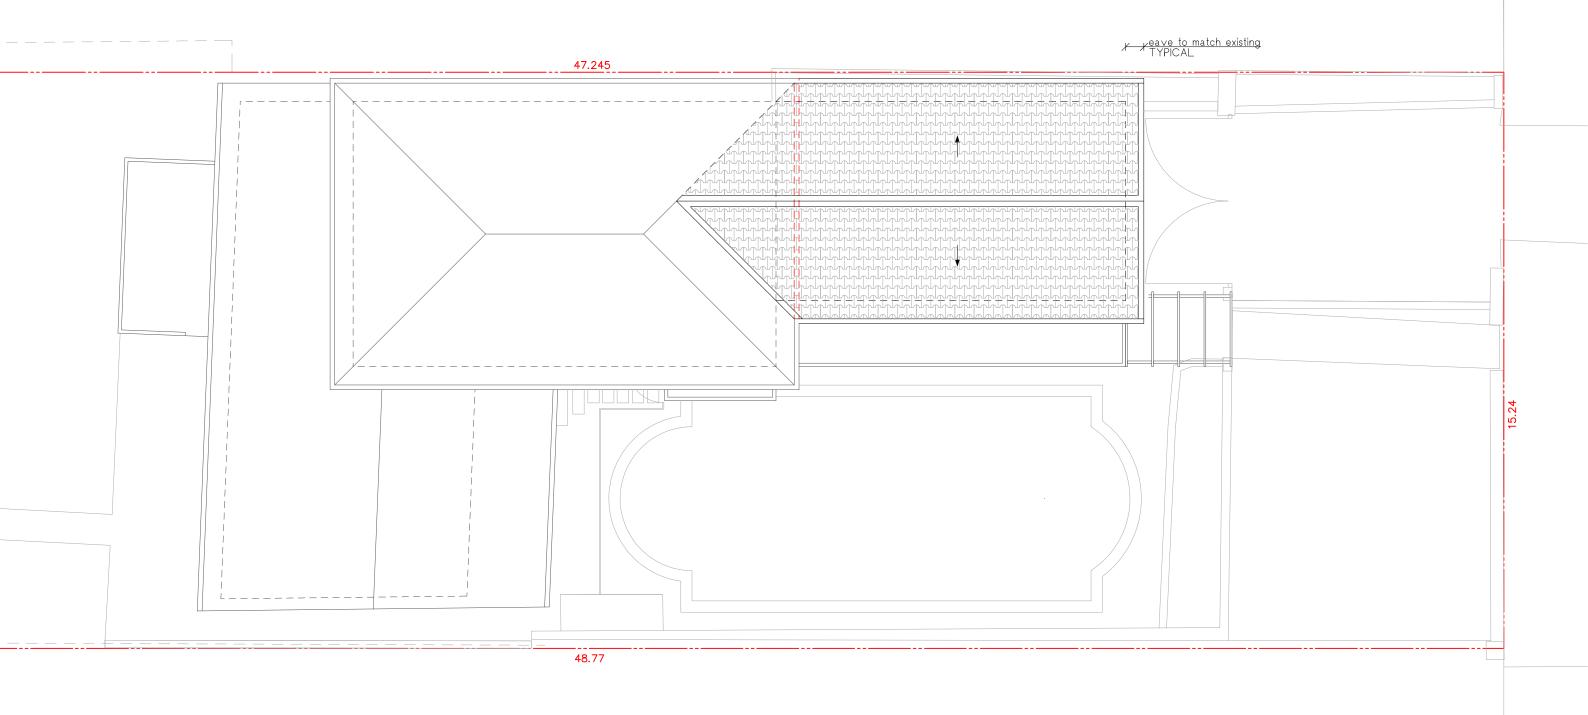





 $\hbox{\it COPYRIGHT- THIS DOCUMENT IS AND SHALL REMAIN THE PROPERT OF PITTWATER DESIGN AND DRAFT.}\\$

PITTWATER DESIGN AND DRAFT CONDITIONS OF USE:
THIS DOCUMENT MAY ONLY BE USED FOR THE PURPOSE OF WHICH IT WAS COMMISSIONED AND IN ACCORDANCE WITH THE TERMS OF ENGAGEMENT FOR COMMISSION.
ALL WORKS ARE TO BE IN ACCORDANCE WITH AUSTRALIAN STANDARDS, THE BUILDING CODE OF AUSTRALIA, OTHER RELEVANT CODES AND MANUFACTURERS' SPECIFICATIONS.
DO NOT SCALE FROM DRAWINGS. BUILDERY CONTRACTORS ARE TO VERIFYALL DIMENSIONS PRIOR TO COMMENCEMENT OF SITE WORK OR OFF-SITE FABRICATION.

ADDRESS: 37 HEATHER STREET, WHEELER HEIGHTS	SHEET TITLE: ROOF PLAN			04.09.19
CLIENT:	scale:	PROJECT No:	DWG No:	ISSUE 3
A + L. FURLONG	1:100 @ A3	1825	DA-04	






	PITTWATER design + draft
M. +61 422 050 001	I E. info@pittwaterdd.com.au I www.pittwaterdd.com.au

COPYRIGHT- THIS DOCUMENT IS AND SHALL REMAIN THE PROPERT OF PITTWATER DESIGN AND DRAFT.

PITTWATER DESIGN AND DRAFT CONDITIONS OF USE:
THIS DOCUMENT MAY ONLY BE USED FOR THE PURPOSE OF WHICH IT WAS COMMISIONED AND IN
ACCORDANCE WITH THE TERMS OF ENGAGEMENT FOR COMMISSION.
ALL WORKS ARE TO BE IN ACCORDANCE WITH A USTRALIAN STANDARDS, THE BUILDING CODE OF
AUSTRALIA, OTHER RELEVANT CODES AND MANUFACTURERS'S SECIFICATIONS.
DO NOT SCALE FROM DRAWINGS. BUILDER/CONTRACTORS ARE TO VERIFYALL DIMENSIONS PRIOR
TO COMMENCEMENT OF SITE WORK OR OFF-SITE FABRICATION.

ISSUE	DATE	AMENDMENT
RELIM	14.09.19	Concept issue
1	22.10.19	Concept Design issue
2	04.11.19	Development Application issue
3	13.12.19	Development Application issue

		0 0.5 1	2	5
37 HEATHER STREET, WHEEL	ER HEIGHTS SHEET TITLE: NORTH	ELEVATION		04.09.19
CLIENT: A + L. FURLONG	scale: 1:100 @	A3 PROJECT No: 1825	DWG No: DA-05	ISSUE 3

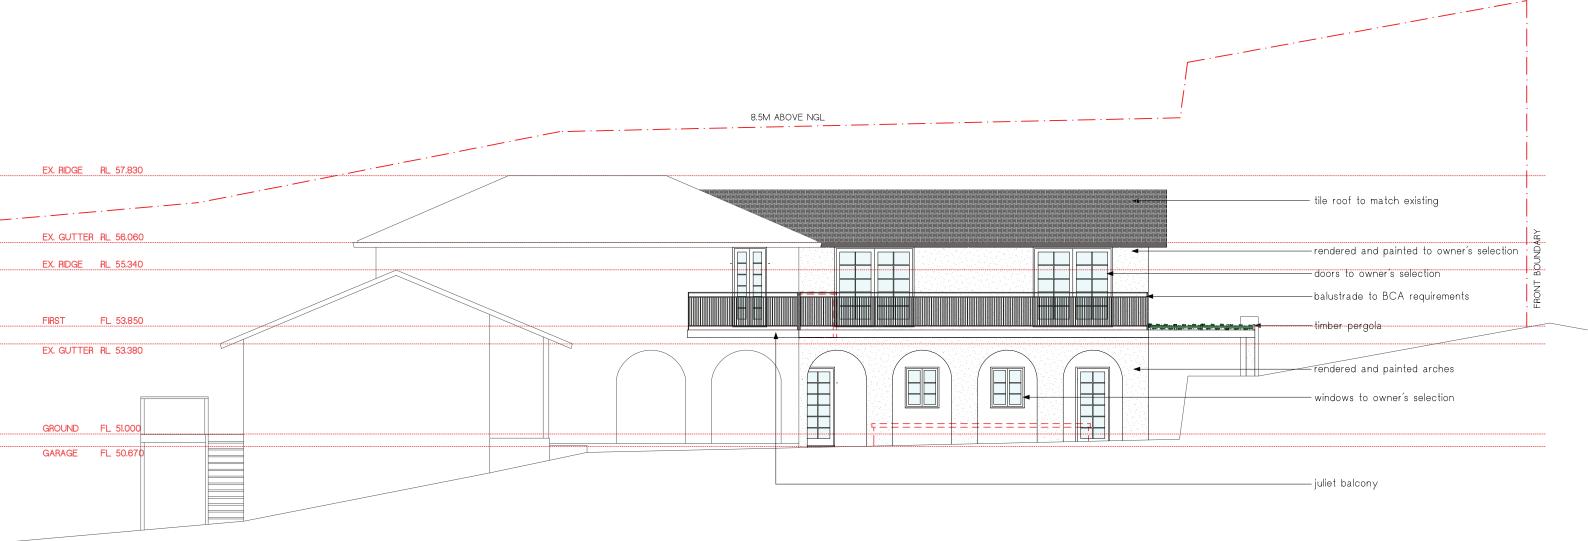

EAST ELEVATION
Scale 1:100

	PITTWATER design + draft
M. +61 422 050 001	I E. info@pittwaterdd.com.au I www.pittwaterdd.com.au

COPYRIGHT - THIS DOCUMENT IS AND SHALL REMAIN THE PROPERT OF PITTWATER DESIGN AND DRAFT.

PITTWATER DESIGN AND DRAFT CONDITIONS OF USE:


PITTWATER DESIGN AND DRAFT CONDITIONS OF USE:

DRAFT MAY ONLY BE USED FOR THE DESIGN OF WHICH IT WAS CONDITIONED AND IN

PITTWATER DESIGN AND DRAFT CONDITIONS OF USE:
THIS DOCUMENT MAY ONLY BE USED FOR THE PURPOSE OF WHICH IT WAS COMMISIONED AND IN
ACCORDANCE WITH THE TERMS OF ENGAGEMENT FOR COMMISSION.
ALL WORKS ARE TO BE IN ACCORDANCE WITH A USTRALIAN STANDARDS, THE BUILDING CODE OF
AUSTRALIA, OTHER RELEVANT CODES AND MANUFACTURERS'S SECIFICATIONS.
DO NOT SCALE FROM DRAWINGS. BUILDER/CONTRACTORS ARE TO VERIFYALL DIMENSIONS PRIOR
TO COMMENCEMENT OF SITE WORK OR OFF-SITE FABRICATION.

SUE	DATE	AMENDMENT
RELIM	14.09.19	Concept issue
1	22.10.19	Concept Design issue
2	04.11.19	Development Application issue
3	13.12.19	Development Application issue
		, ,,,,,,,,,,,,,,,,,,,,,,,,,,,,,,,,,,,,,

		0 0.5 1		
ADDRESS:	SHEET TITLE:	TION		DATE
37 HEATHER STREET, WHEELER HEIGHTS	EAST ELEVATION		04.09.19	
CLIENT: A + L. FURLONG	scale: 1:100 @ A3	PROJECT No: 1825	DWG No: DA-06	ISSUE 3

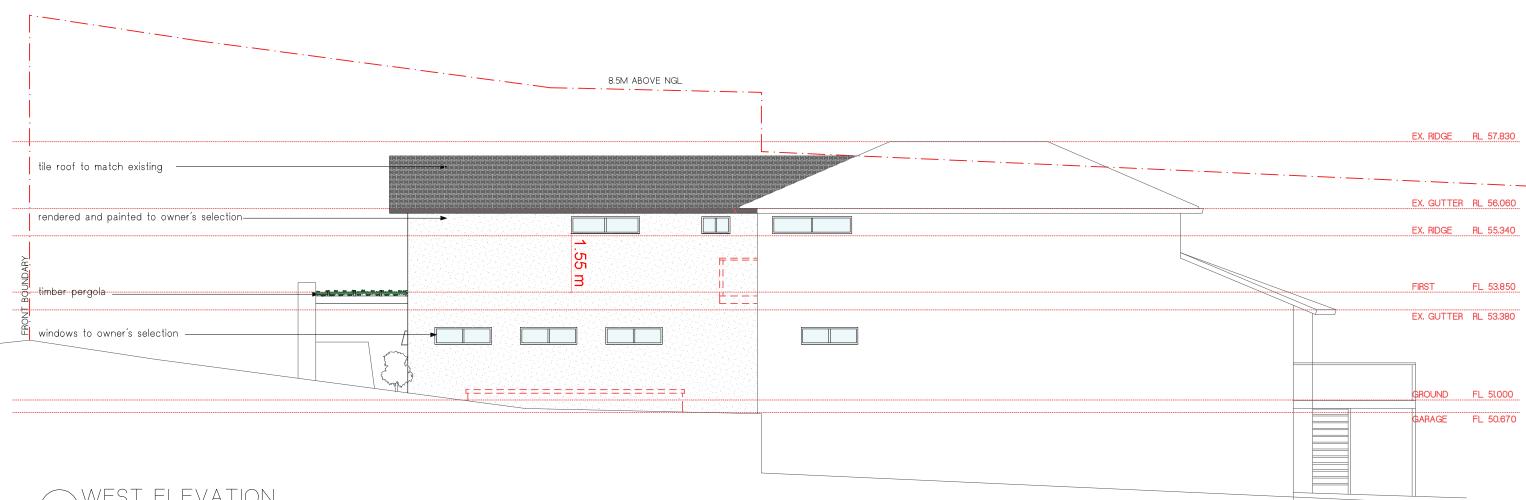

WEST ELEVATION
Scale 1:100


	PITTWATER design + draft
M. +61 422 050 001	I E. info@pittwaterdd.com.au I www.pittwaterdd.com.au

COPYRIGHT- THIS DOCUMENT IS AND SHALL REMAIN THE PROPERT OF PITTWATER DESIGN AND DRAFT.

PITTWATER DESIGN AND DRAFT CONDITIONS OF USE:
THIS DOCUMENT MAY ONLY BE USED FOR THE PURPOSE OF WHICH IT WAS COMMISIONED AND IN
ACCORDANCE WITH THE TERMS OF ENGAGEMENT FOR COMMISSION.
ALL WORKS ARE TO BE IN ACCORDANCE WITH AUSTRALIAN STANDARDS, THE BUILDING CODE OF
AUSTRALIA, OTHER RELEVANT CODES AND MANUFACTURERS' SPECIFICATIONS.
DO NOT SCALE FROM DRAWINGS. BUILDERY CONTRACTORS ARE TO VERIFYALL DIMENSIONS PRIOR
TO COMMENCEMENT OF SITE WORK OR OFF-SITE FABRICATION.

ISSUE	DATE	AMENDMENT
PRELIM	14.09.19	Concept issue
1	22.10.19	Concept Design issue
2	04.11.19	Development Application issue
3	13.12.19	Development Application issue
	1	

		0 0.5 1		J
ADDRESS:	SHEET TITLE:			DATE
37 HEATHER STREET, WHEELER HEIGHTS	WEST ELEVATION		04.09.19	
A + L. FURLONG	scale: 1:100 @ A3	PROJECT No: 1825	DWG No: DA-07	ISSUE 3

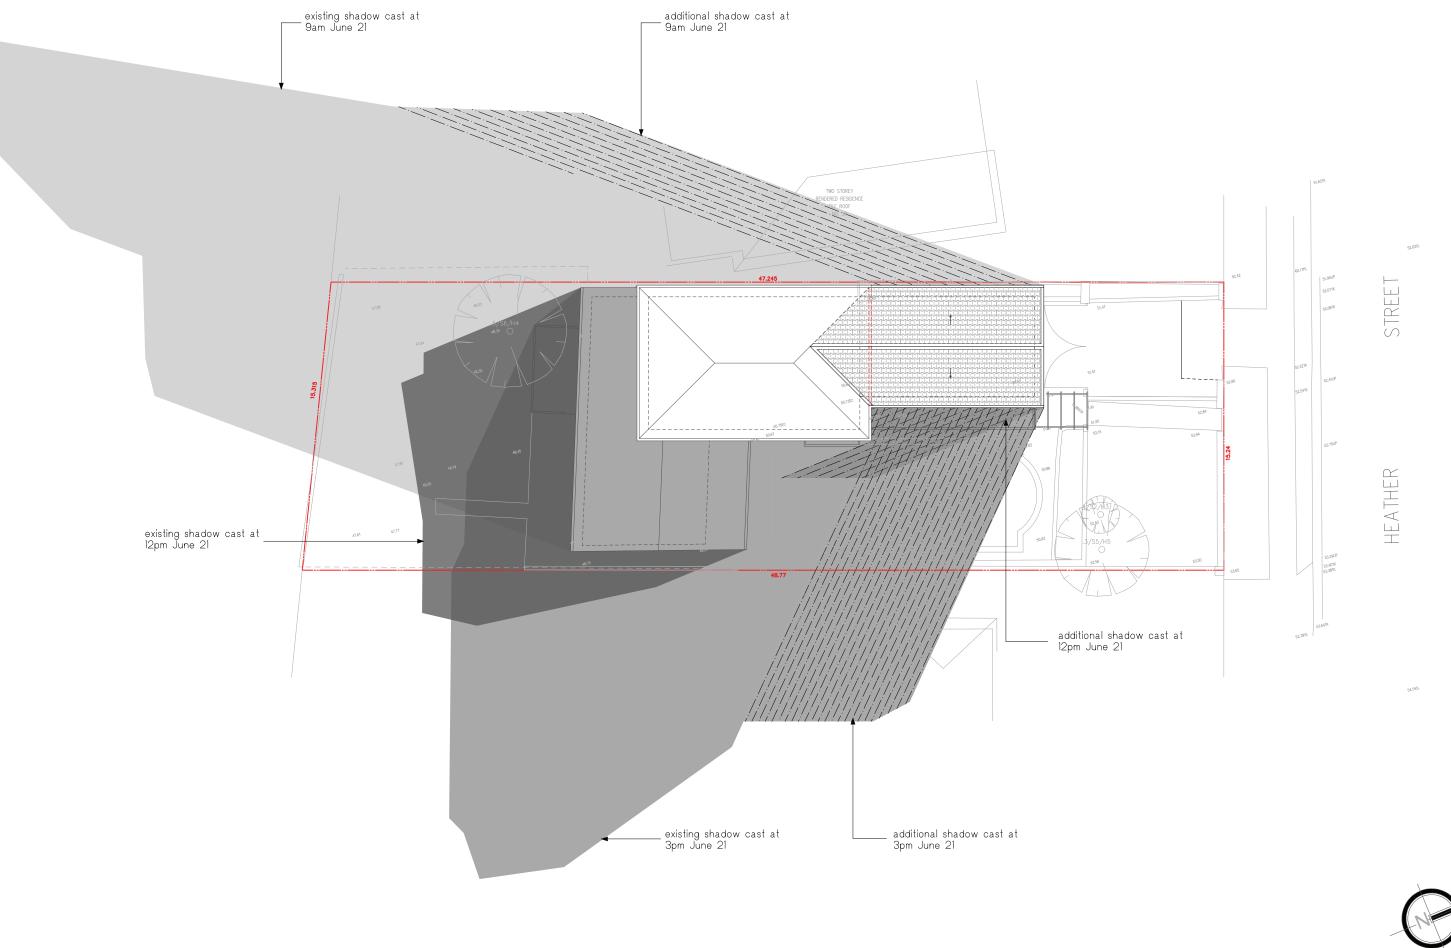






COPYRIGHT- THIS DOCUMENT IS AND SHALL REMAIN THE PROPERT OF PITTWATER DESIGN AND DRAFT.

PITTWATER DESIGN AND DRAFT CONDITIONS OF USE:
THIS DOCUMENT MAY ONLY BE USED FOR THE PURPOSE OF WHICH IT WAS COMMISIONED AND IN ACCORDANCE WITH THE TERMS OF ENGAGEMENT FOR COMMISSION.
ALL WORKS ARE TO BE IN ACCORDANCE WITH AUSTRALIAN STANDARDS, THE BUILDING CODE OF AUSTRALIA, OTHER RELEVANT CODES AND MANUFACTURERS' SECIFICATIONS.
DO NOT SCALE FROM DRAWINGS. BUILDER/CONTRACTORS ARE TO VERIFYALL DIMENSIONS PRIOR TO COMMENCEMENT OF SITE WORK OR OFF-SITE FABRICATION.

RELIM	14.09.19
1	22.10.19
2	04.11.19

AMENDMENT
Concept issue
Concept Design issue
Development Application issue

37 HEATHER STREET, WHEELER HEIGHTS	SHEET TITLE: SHADOW DIAGRAM			04.09.19
CLIENT: A + L. FURLONG	1:200 @ A3	PROJECT No: 1825	DWG No: DA-09	ISSUE 1

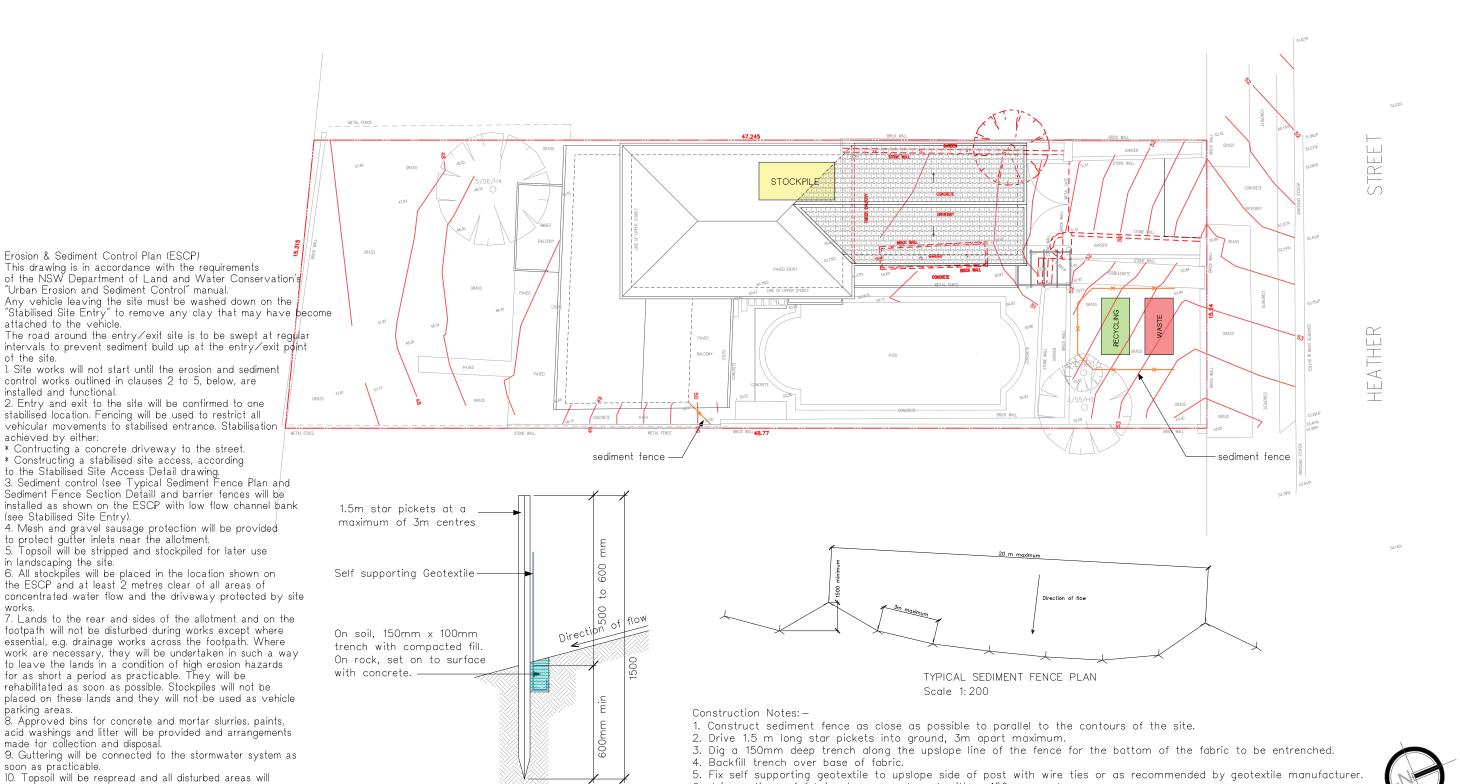

6. Join sections of fabric at a support post with a 150mm overlap.

M. +61 422 050 001 | E. info@pittwaterdd.com.au | www.pittwaterdd.com.au

be rehabilitated within 20 working days of the completion

least weekly and after rain to ensure they are maintained

11. All erosion and sediment controls will be checked at

Erosion & Sediment Control Plan (ESCP)

of the site.

installed and functional.

achieved by either:

(see Stabilised Site Entry).

in landscaping the site.

works.

parking areas.

soon as practicable.

made for collection and disposal.

in a fully functional condition.

COPYRIGHT- THIS DOCUMENT IS AND SHALL REMAIN THE PROPERT OF PITTWATER DESIGN AND DRAFT.

SEDIMENT FENCE SECTION DETAIL


Scale 1:20

PITTWATER DESIGN AND DRAFT CONDITIONS OF USE:
THIS DOCUMENT MAY ONLY BE USED FOR THE PURPOSE OF WHICH IT WAS COMMISIONED AND IN ACCORDANCE WITH THE TERMS OF ENAGRAWENT FOR COMMISSION.
ALL WORKS ARE TO BE IN ACCORDANCE WITH AUSTRALIAN STANDARDS, THE BUILDING CODE OF AUSTRALIA, OTHER RELEVANT CODES AND MANUFACTURERS SPECIFICATIONS.
DO NOT SCALE FROM DRAWINGS. BUILDERY CONTRACTORS ARE TO VERIFYALL DIMENSIONS PRIOR TO COMMENCEMENT OF SITE WORK OR OFF-SITE FABRICATION.

PRELIM 14.09.19

AMENDMENT Concept issue | 22.10.19 | Concept Design issue | 04.11.19 | Development Application issue

DATE 37 HEATHER STREET, WHEELER HEIGHTS SEDIMENT + EROSION PLAN 04.09.19 PROJECT No A + L. FURLONG 1:200 @ A3 | 1825 DA-10 1

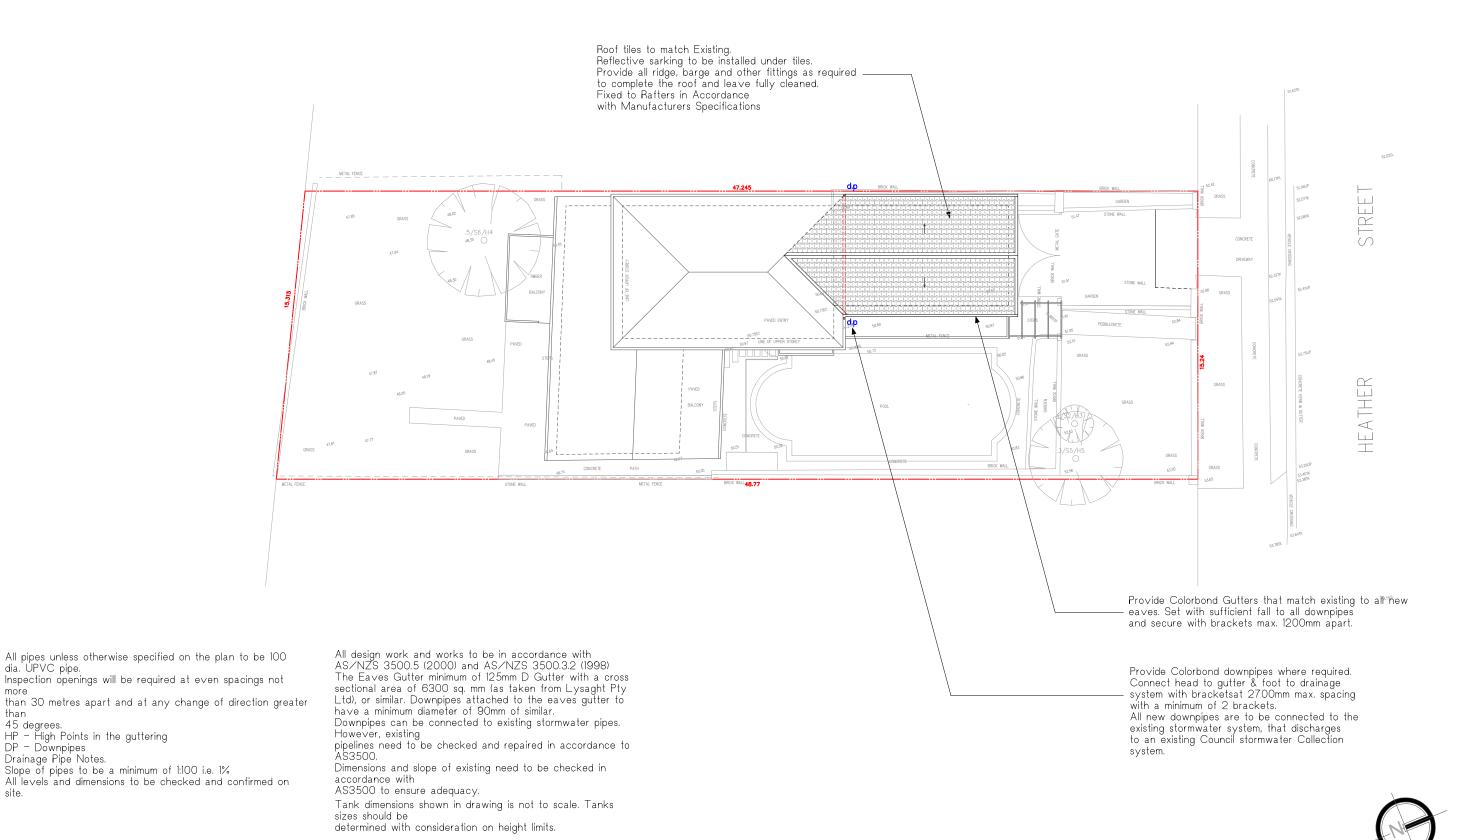



dia. UPVC pipe.

Drainage Pipe Notes.

45 degrees.
HP - High Points in the guttering
DP - Downpipes


COPYRIGHT- THIS DOCUMENT IS AND SHALL REMAIN THE PROPERT OF PITTWATER DESIGN AND DRAFT.

PITTWATER DESIGN AND DRAFT CONDITIONS OF USE:
THIS DOCUMENT MAY ONLY BE USED FOR THE PURPOSE OF WHICH IT WAS COMMISIONED AND IN ACCORDANCE WITH THE TERMS OF ENGAGEMENT FOR COMMISSION.
ALL WORKS ARE TO BE IN ACCORDANCE WITH AUSTRALIAN STANDARDS, THE BUILDING CODE OF AUSTRALIA, OTHER RELEVANT CODES AND MANUFACTURERS' SPECIFICATIONS.
DO NOT SCALLE FROM DRAWINGS. BULDERY/CONTRACTORS ARE TO VERIFYALL DIMENSIONS PRIOR TO COMMENCEMENT OF SITE WORK OR OFF-SITE FABRICATION.

PRELIM 14.09.19 1 22.10.19 2 04.11.19

AMENDMENT Concept issue Concept Design issue Development Application issue

		9 1 2	1	
ADDRESS:	SHEET TITLE: STORMWATER CONCEPT PLAN			DATE
37 HEATHER STREET, WHEELER HEIGHTS				04.09.19
CLIENT: A + L. FURLONG	scale: 1:200 @ A3	PROJECT No: 1825	DWG No: DA-11	ISSUE 1

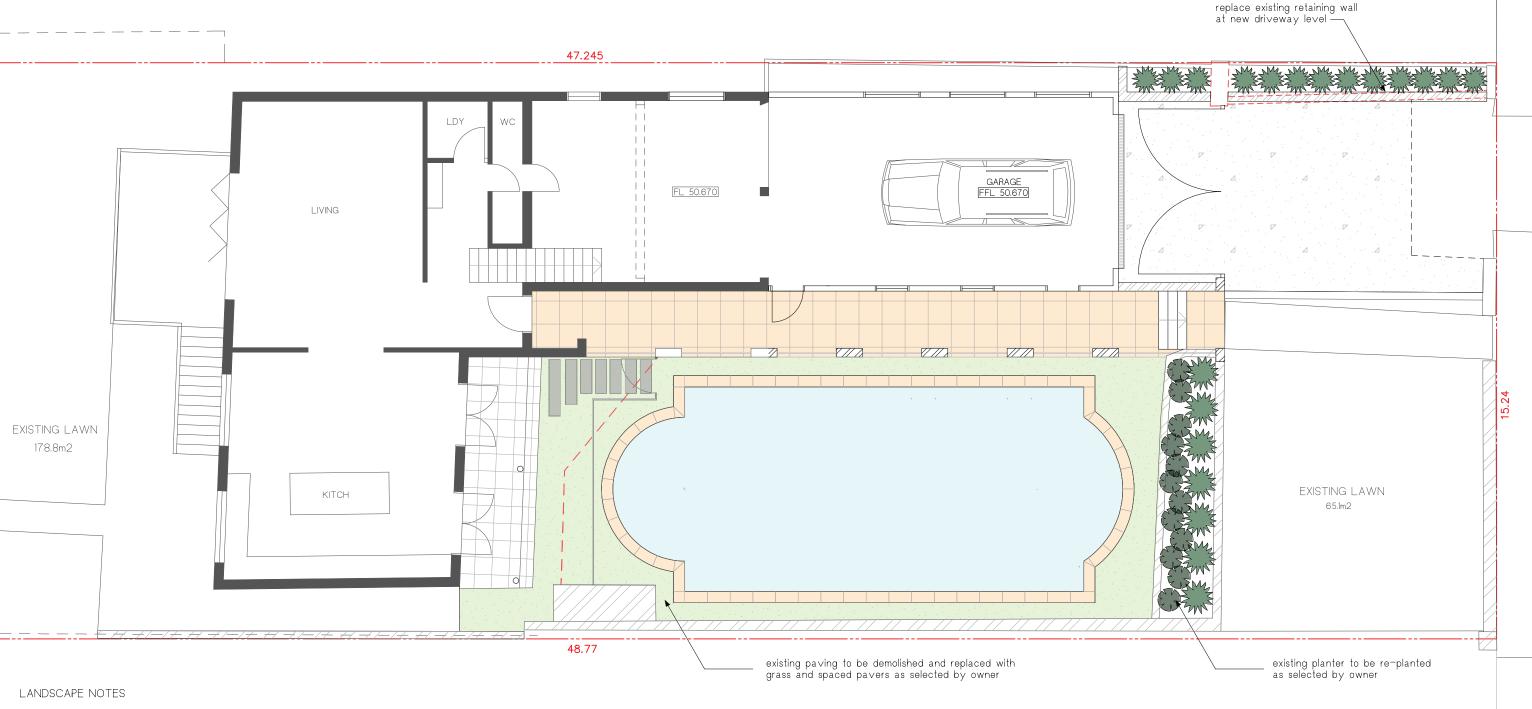

PRESERVATION OF EXISTING TREES

Existing levels to be retained within the critical root zone of all trees remaining as per the Landscape plan. In any excavation, refer to arborist report for direction

PREPERATION OF GARDEN BEDS

Cultivate garden beds for new plants to a depth of 300mm. Incorporate imported 'greenlife' soil conditioner from Australian native landscapes (or equivalent) with existing soil when planting. Do not cultivate soil beneath existing trees to be retained, Mulch to be 'horticultural grade' pine bark by Australian native landscapes (or equivalent) and installed to a depth of 75mm to all garden beds, covering mulch down around plant stems and finish flush with adjacent surfaces.

Purchase plants from an approved nursery. Plants to be healthy and true to type and species. Set out plants to positions indicated on plan. Following approval, plant holes shall be dug twice the width and to be 100mm deeper than plant rootballs that they are to receive. Base and sides of hole shall be further loosened. Fertilise, followed by 100mm depth of topsoil mix placed into base of hole and lightly consolidated. Base of hole shall then be watered.

Remove plant container and install into hole. Rootball shall be backfilled with surrounding topsoil and topsoil firmed into place. An approved shallow dish shall be firmed to contain water around the base of stem. Base of stem of plant shall finish flush with finished soil level. Once installed, plant shall be thoroughly watered and maintained for the duration of the contract.

All trees and large shrubs shall be staked using 2 x 38mm x 38mm x 200mm long hardwood stakes per plant and secured with hessian webbing ties installed to contractor's on site instructions.

Where earthworks have occured, the contractor is to ensure any stockpiled topsoil is free of unwanted matter such as rocks, clay lumps, tree roots, builder's rubbish and any material toxic to plants.

MAINTENANCE

Carry out the following tasks for a twelve month period from the date of practical completion:

- -weeding of all garden beds
- -rubbish removal
- -fertilising to achieve optimal growth
- -pest and disease control
- -adjustment of ties and stakes -replace failed planting

-pruning and hedge clipping of plants -reinstatement of mulch to specified depth




M. +61 422 050 001 I E. info@pittwaterdd.com.au I www.pittwaterdd.com.au

COPYRIGHT- THIS DOCUMENT IS AND SHALL REMAIN THE PROPERT OF PITTWATER DESIGN AND DRAFT.

PITTWATER DESIGN AND DRAFT CONDITIONS OF USE:
THIS DOCUMENT MAY ONLY BE USED FOR THE PURPOSE OF WHICH IT WAS COMMISIONED AND IN ACCORDANCE WITH THE TERMS OF ENGAGEMENT FOR COMMISSION.
ALL WORKS ARE TO BE IN ACCORDANCE WITH AUSTRALIAN STANDARDS, THE BUILDING CODE OF AUSTRALIA, OTHER RELEVANT CODES AND MANUFACTURERS' SPECIFICATIONS.
DO NOT SCALE FROM DRAWINGS, BUILDER/CONTRACTORS ARE TO VERIFYALL DIMENSIONS PRIOR TO COMMENCEMENT OF SITE WORK OR OFF-SITE FABRICATION.

PRELIM 14.09.19 AMENDMENT Concept issue 22.10.19 04.11.19 13.12.19 Concept Design issue Development Application issue Development Application issue

1 1				
ADDRESS:	SHEET TITLE:			DATE
37 HEATHER STREET, WHEELER HEIGHTS	LANDSCAPE PLAN		04.09.19	
CLIENT: A + L. FURLONG	scale: 1:100 @ A3	PROJECT No:	DWG No: DA-12	ISSUE 3

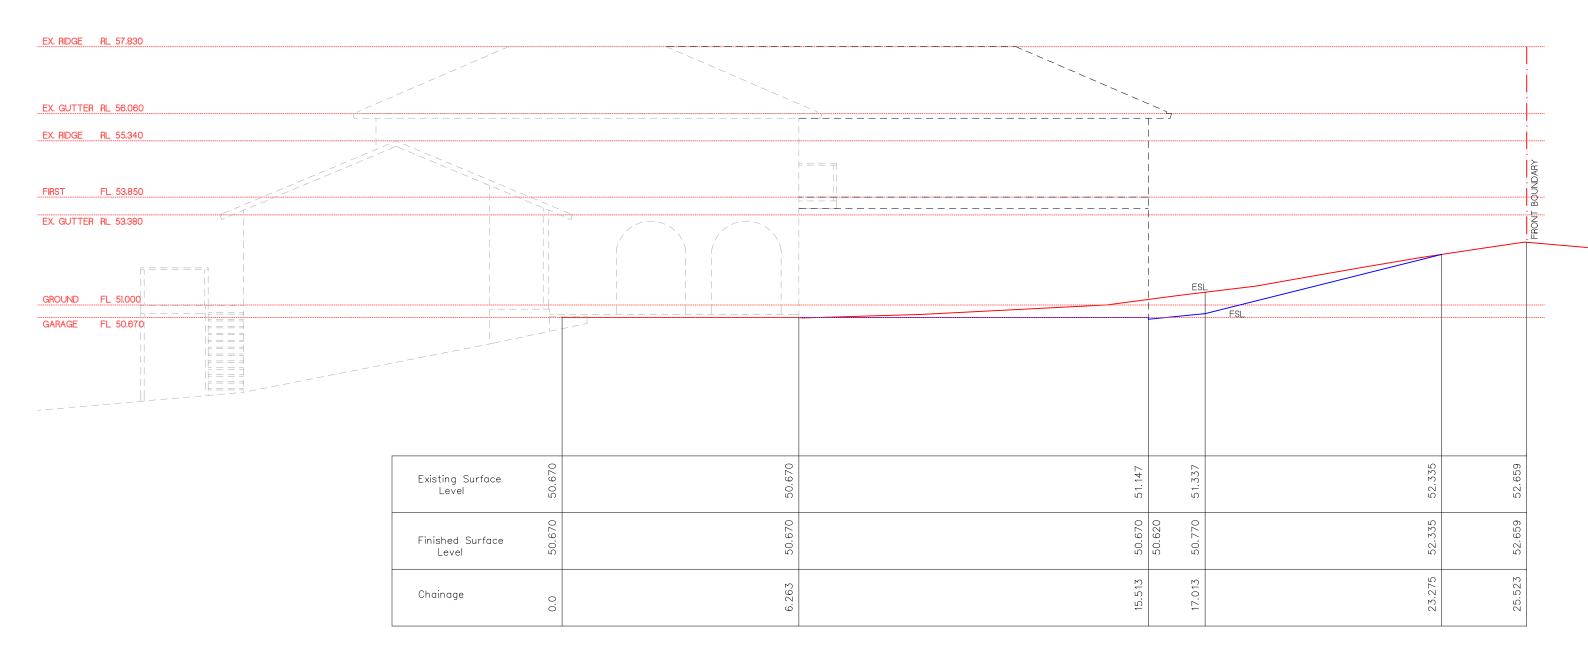

	PITTWATER design + draft
M. +61 422 050 001 I	E. info@pittwaterdd.com.au I www.pittwaterdd.com.au

COPYRIGHT- THIS DOCUMENT IS AND SHALL REMAIN THE PROPERT OF PITTWATER DESIGN AND DRAFT. PITTWATER DESIGN AND DRAFT CONDITIONS OF USE:
THIS DOCUMENT MAY ONLY BE USED FOR THE PURPOSE OF WHICH IT WAS COMMISIONED AND IN
ACCORDANCE WITH THE TERMS OF ENGAGEMENT FOR COMMISSION.
ALL WORKS ARE TO BE IN ACCORDANCE WITH A LOTRALIAN STANDARDS, THE BUILDING CODE OF
AUSTRALIA, OTHER RELEVANT CODES AND MANUFACTURERS'S SECIFICATIONS.
DO NOT SCALE FROM DRAWINGS. BULLDER/CONTRACTORS ARE TO VERIFYALL DIMENSIONS PRIOR
TO COMMENCEMENT OF SITE WORK OR OFF-SITE FABRICATION.

PRELIM 14.09.19 Concept issue
1 22.10.19 Concept Design issue
2 04.11.19 Development Application issue

		0 0.0 1	-	
ADDRESS: 37 HEATHER STREET, WHEELER HEIGHTS	SHEET TITLE: DRIVEWAY LONGSECTION		04.09.19	
CLIENT: A + L. FURLONG	scale: 1:100 @ A3	PROJECT No: 1825	DWG No: DA-13	ISSUE 1

